

CAMPUS SITE PLAN
SCALE: 1" = 40'-0"

PARKING TABULATIONS

PARKING LOT	TOTAL PARKING SPACES	ACCESSIBLE SPACES REQUIRED PER TABLE 11B-6	REGULAR ACCESSIBLE SPACES PROVIDED	VAN ACCESSIBLE SPACES PROVIDED	STANDARD SPACES PROVIDED
PARKING LOT 1	190	6	6	1	183
PARKING LOT 2	50	2	1	1	48
PARKING LOT 3	34	2	1	1	32
TOTAL PARKING SPACES	274	10	8	3	263

RE: 2015 CBC SECTION 1129B, TABLE 11B-6 FOR REQUIRED NUMBER OF ACCESSIBLE PARKING SPACES

CERTIFICATION STATUS

APPLICATION NO.	CERTIFICATION STATUS	DATE
27211	CERTIFIED	JULY 1966
03-100633	#1 CERTIFICATION	02/09/2000
03-104035	#1 CERTIFICATION	06/21/2001
03-107347	#1 CERTIFICATION	06/17/2009
03-107519	#1 CERTIFICATION	05/17/2012
03-109755	#1 CERTIFICATION	05/18/2008
03-110374	#2 CERTIFICATION	03/12/2014
03-112089	#1 CERTIFICATION	05/15/2012
03-118173	UNDER CONSTRUCTION	-
03-115613	#1 CERTIFICATION	12/10/2015
03-117968	#1 CERTIFICATION	02/03/2020
03-114356	#1 CERTIFICATION	11/27/2016
03-115100	#1 CERTIFICATION	05/05/2014
03-118726	UNDER CONSTRUCTION	-

LEGEND

--- PATH OF TRAVEL A# 03-118726


DESIGN PROFESSIONAL IN GENERAL RESPONSIBLE CHARGE STATEMENT: THE POT IDENTIFIED IN THESE CONSTRUCTION DOCUMENTS MEETS THE REQUIREMENTS OF THE CURRENT APPLICABLE CALIFORNIA BUILDING CODE (CBC) ACCESSIBILITY PROVISIONS FOR PATH OF TRAVEL REQUIREMENTS FOR ALTERATIONS, ADDITIONS AND STRUCTURAL REPAIRS AS PART OF THE DESIGN OF THIS PROJECT. THE POT WAS EXAMINED AND ANY ELEMENTS, COMPONENTS OR PORTIONS OF THE POT THAT WERE DETERMINED TO BE NONCOMPLIANT WITH THE CBC HAVE BEEN IDENTIFIED AND THE CORRECTIVE WORK NECESSARY TO BRING THEM INTO COMPLIANCE HAS BEEN INCLUDED WITHIN THE SCOPE OF THIS PROJECT'S WORK THROUGH DETAILS, DRAWINGS AND SPECIFICATIONS INCORPORATED INTO THESE CONSTRUCTION DOCUMENTS. ANY NONCOMPLIANT ELEMENTS, COMPONENTS OR PORTIONS OF THE POT THAT WILL NOT BE CORRECTED BY THIS PROJECT BASED ON VALUATION THRESHOLD LIMITATIONS OR A FINDING OF UNREASONABLE HARDSHIP ARE INDICATED IN THESE CONSTRUCTION DOCUMENTS.

DURING CONSTRUCTION, IF POT ITEMS WITHIN THE SCOPE OF THE PROJECT REPRESENTED AS CBC COMPLIANT ARE FOUND TO BE NONCOMPLYING BEYOND REASONABLE CONSTRUCTION TOLERANCES, THE ITEMS SHALL BE BROUGHT INTO COMPLIANCE WITH THE CBC AS PART OF THIS PROJECT BY MEANS OF A CONSTRUCTION CHANGE DOCUMENT.


PATH OF TRAVEL (P.O.T.) AS VERIFIED BY ARCHITECT IS:

- A COMMON BARRIER FREE ACCESSIBLE ROUTE AT LEAST 48" WIDE WITHOUT ANY ABRUPT VERTICAL CHANGES EXCEEDING 1/2" BEVELED AT 1:2 MAXIMUM SLOPE, EXCEPT THAT LEVEL CHANGES DO NOT EXCEED 1/4" VERTICAL.
- THE PATH SURFACE IS SLIP RESISTANT, STABLE, FIRM AND SMOOTH.
- PASSING SPACES AT LEAST 60"x80" ARE LOCATED NOT MORE THAN 200' APART.
- CONTINUOUS GRADIENTS HAVE 80" LEVEL AREAS NOT MORE THAN 400' APART.
- CROSS-SLOPE DOES NOT EXCEED 2%.
- SLOPE IN THE DIRECTION OF TRAVEL IS LESS THAN 5%, UNLESS OTHERWISE INDICATED AS A RAMP.
- MAINTAIN POT FREE OF OVERHANGING OBSTRUCTIONS TO 80" MINIMUM. PROTRUDING OBJECTS GREATER THAN 4" PROJECTION FROM WALL OR EDGE AND 27" ABOVE FINISH GRADE.

ACCESSIBLE RESTROOMS A#03-118726

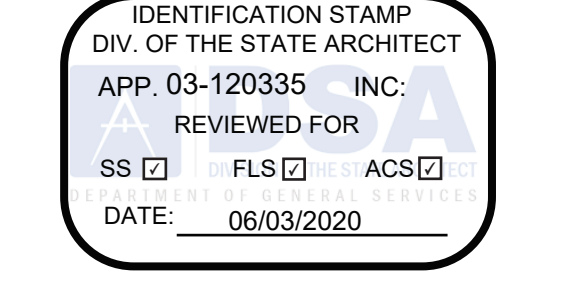

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**GLENDALE HIGH SCHOOL
TENNIS COURT RENOVATION PROJECT**

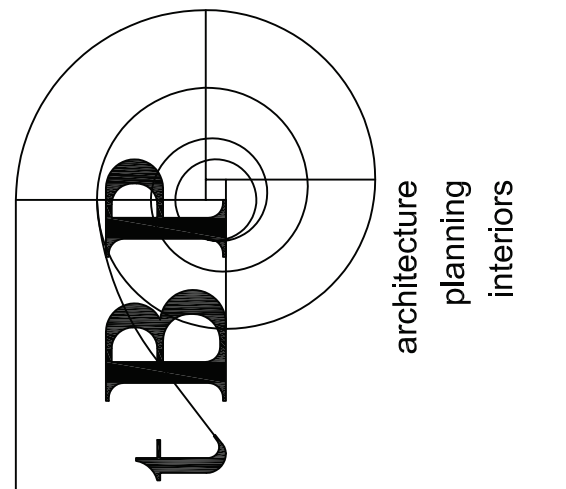
GLENDALE UNIFIED SCHOOL DISTRICT
1440 E. BROADWAY
GLENDALE, CALIFORNIA 91205

owner


tbp project number : 20916.03
file name: 0AS-1_SITE.DWG
drawn by: checked by:
date: 3/5/2020
Rev. date: description:

drawing title:
**OVERALL CAMPUS
SITE PLAN**

drawing no.:
AS-1
drawing of

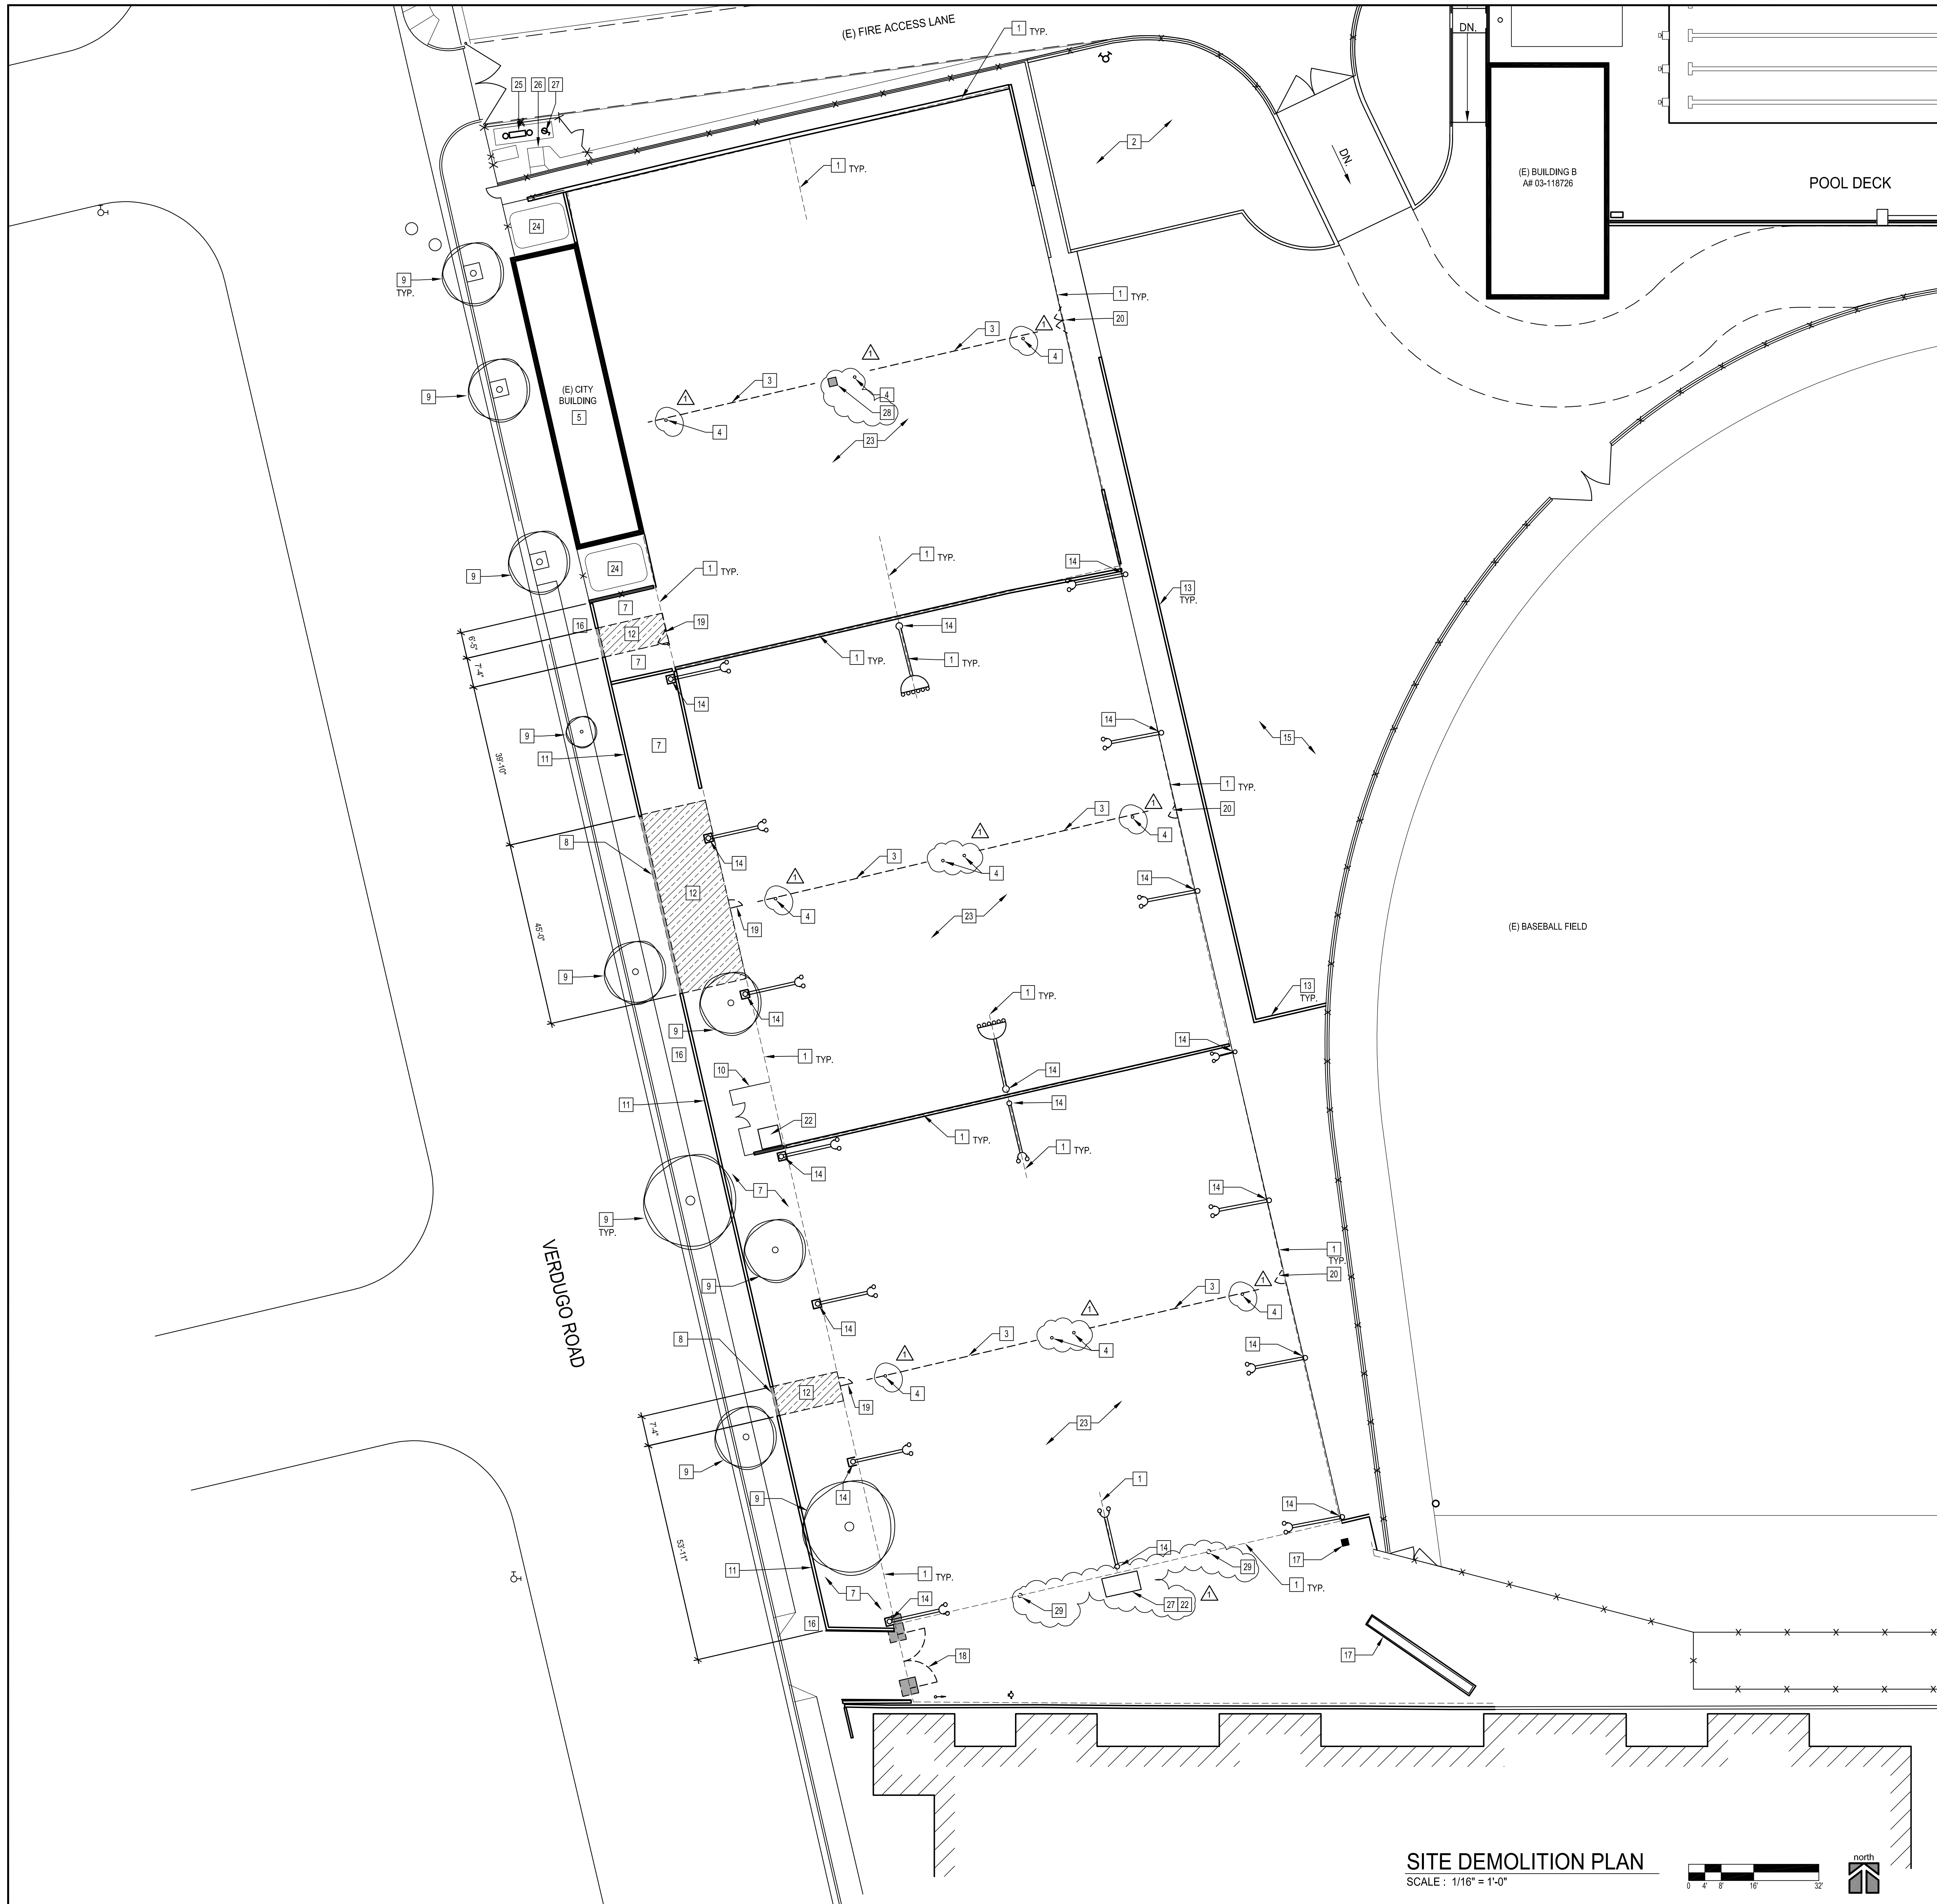

SITE DEMOLITION PLAN
SCALE: 1/16" = 1'-0"

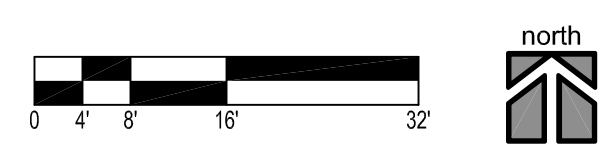

GENERAL NOTES

- LOCATIONS OF ALL UTILITIES SHOWN ARE APPROXIMATE. CONTRACTOR SHALL EXERCISE EXTREME CAUTION IN EXCAVATING AND TRENCHING TO AVOID INTERCEPTING EXISTING PIPING OR CONDUITS. THE ARCHITECT IS NOT RESPONSIBLE FOR THE LOCATION OF UNDERGROUND UTILITIES OR STRUCTURES WHETHER OR NOT SHOWN OR DETAILED AND INSTALLED BY OTHER CONTRACTS. THE CONTRACTOR SHALL IMMEDIATELY NOTIFY THE OWNER SHOULD SUCH UNIDENTIFIED CONDITIONS BE DISCOVERED. THESE DRAWINGS AND SPECIFICATIONS DO NOT INCLUDE NECESSARY COMPONENTS FOR CONSTRUCTION SAFETY.
- WHERE DEMOLITION OR REMOVAL WORK OCCURS, TAKE ALL NECESSARY PRECAUTIONS TO PROTECT ELEMENTS TO REMAIN. FINISHED WORK DAMAGED BY OPERATIONS UNDER DEMOLITION CONTRACT SHALL BE REPAIRED OR REPLACED TO THE SATISFACTION OF OWNER AND ARCHITECT AT NO ADDITIONAL COST TO THE OWNER.
- DISPOSITION OF MATERIALS: PROMPTLY REMOVE FROM THE SITE ALL MATERIALS RESULTING FROM DEMOLITION WHICH ARE NOT TO BE REUSED.
- COORDINATE REMOVAL OF ALL ELECTRICAL FIXTURES, CONDUIT, AND JUNCTION BOXES WITH ELECTRICAL CONTRACTOR.
- REFER TO CIVIL AND UTILITY PLANS FOR ADDITIONAL DEMOLITION WORK AND COORDINATION FOR TERMINATION POINTS OF UTILITIES.
- ALL DEMOLITION SHALL COMPLY WITH CH. 34 OF THE CBC AND ARTICLE 87 CFC.
- WHERE AN EXISTING REQUIRED FIRE PROTECTION SYSTEM WILL BE TEMPORARILY OUT OF SERVICE DUE TO CONSTRUCTION ACTIVITIES, COMPLY WITH CFC SECTIONS 1408 AND 901.
- REFER TO ELECTRICAL PLANS FOR ADDITIONAL DEMOLITION.

LEGEND

- DESIGNATED LIMITS OF DEMOLITION AND CLEAR AND GRUB. ANY REMOVED SITE AMENITIES IF REQUESTED SHALL BE TURNED OVER TO THE SCHOOL DISTRICT.
- DESIGNATED LIMITS OF CONCRETE PAVING DEMOLITION. SAWCUT AND REMOVE TO THE SATISFACTION OF THE ENGINEER. DISPOSE OF ALL CONCRETE PAVING PER SPECIFICATIONS. ALL SAWCUTS TO BE STRAIGHT AND TRUE.

DEMOLITION KEY NOTES

- REMOVE (E) CHAIN LINK FENCE FABRIC - POSTS TO REMAIN - PROTECT IN PLACE
- (E) LANDSCAPE AREA TO REMAIN
- REMOVE AND REPLACE ALL (E) TENNIS COURT NETS
- (E) NET POSTS TO REMAIN
- (E) CITY BUILDING TO REMAIN - PROTECT IN PLACE
- NOT USED
- PREPARE AREA FOR (N) LANDSCAPE - SEE LANDSCAPE DRAWINGS
- REMOVE PORTION OF (E) CONCRETE RETAINING WALL TO CREATE OPENING FOR WALKSTAIRS
- (E) TREE - PROTECT IN PLACE, TYP. ALL TREES
- (E) ELECTRICAL ENCLOSURE - PROTECT IN PLACE
- (E) RETAINING WALL - PROTECT IN PLACE, EXCEPT WHERE NOTED
- CLEAR AND GRUB - GRADE PER CIVIL
- (E) WALK AND WALL # 03-118726 - PROTECT IN PLACE
- (E) LIGHT POLE TO REMAIN
- (E) AC PAVING
- (E) SIDEWALK TO REMAIN - PROTECT IN PLACE
- (E) STORM DRAIN - PROTECT IN PLACE AND MAINTAIN DURING CONSTRUCTION
- GATE, FENCE, POSTS, AND FOOTINGS TO BE REMOVED
- REMOVE (E) GATE - INFILL WITH CHAIN LINK FENCE AS REQUIRED
- REMOVE AND REPLACE (E) GATES - INFILL WITH CHAIN LINK FENCE AS REQUIRED
- NOT USED
- (E) ELECTRICAL EQUIPMENT TO REMAIN
- (E) CONC. TENNIS COURT TO REMAIN - PROTECT IN PLACE
- (E) CITY TANKS TO REMAIN - PROTECT IN PLACE
- (E) BACK FLOW PREVENTOR TO REMAIN - PROTECT IN PLACE
- (E) FDC TO REMAIN - PROTECT IN PLACE
- (E) CATCH BASIN TO REMAIN - PROTECT IN PLACE
- (E) ELECTRICAL ENCLOSURE - REMOVE AND REPLACE T-11 SIDING, ROOFING, DOOR AND FRAME
- SAWCUT TO ALLOW FOR (1) NEW NET POST AND FOOTING
- REMOVE AND REPLACE (E) BENT CHAIN LINK POSTS


DEMOLITION NOTES

- NOT USED
- THE CONTRACTOR SHALL REMOVE (E) CHAIN LINK FENCE FABRIC AND WINDSCREEN.
- ALL TREES TO BE PROTECTED IN PLACE.

DSA NOTE

NO DEMOLITION SHALL BEGIN UNTIL ALL PLANS INCLUDING THE DEMOLITION WORK HAS BEEN APPROVED BY DSA.

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**GLENDALE HIGH SCHOOL
TENNIS COURT RENOVATION PROJECT**

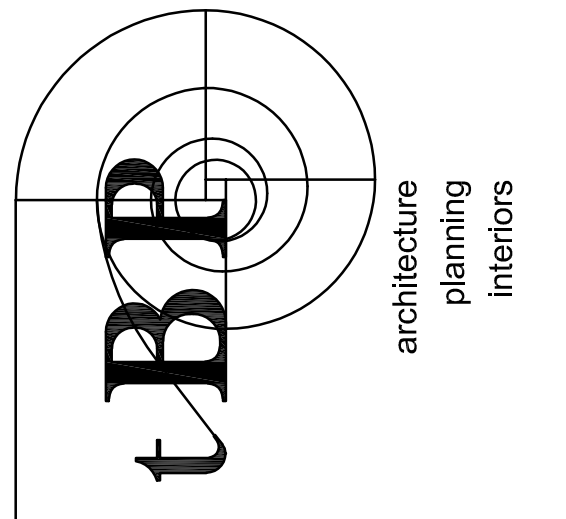GLENDALE UNIFIED SCHOOL DISTRICT
1440 E. BROADWAY
GLENDALE, CALIFORNIA 91205

owner

tBP project number : 20916.03

file name:

drawn by: checked by:

date: 3/5/2020

Rev. date: description:


6/25/2020 ADDENDUM 1

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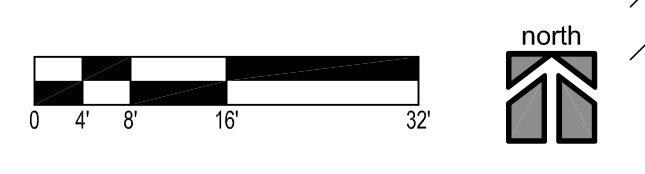
drawing title:
**ENLARGED DEMOLITION
SITE PLAN**

drawing no.:

AS-2
drawing of

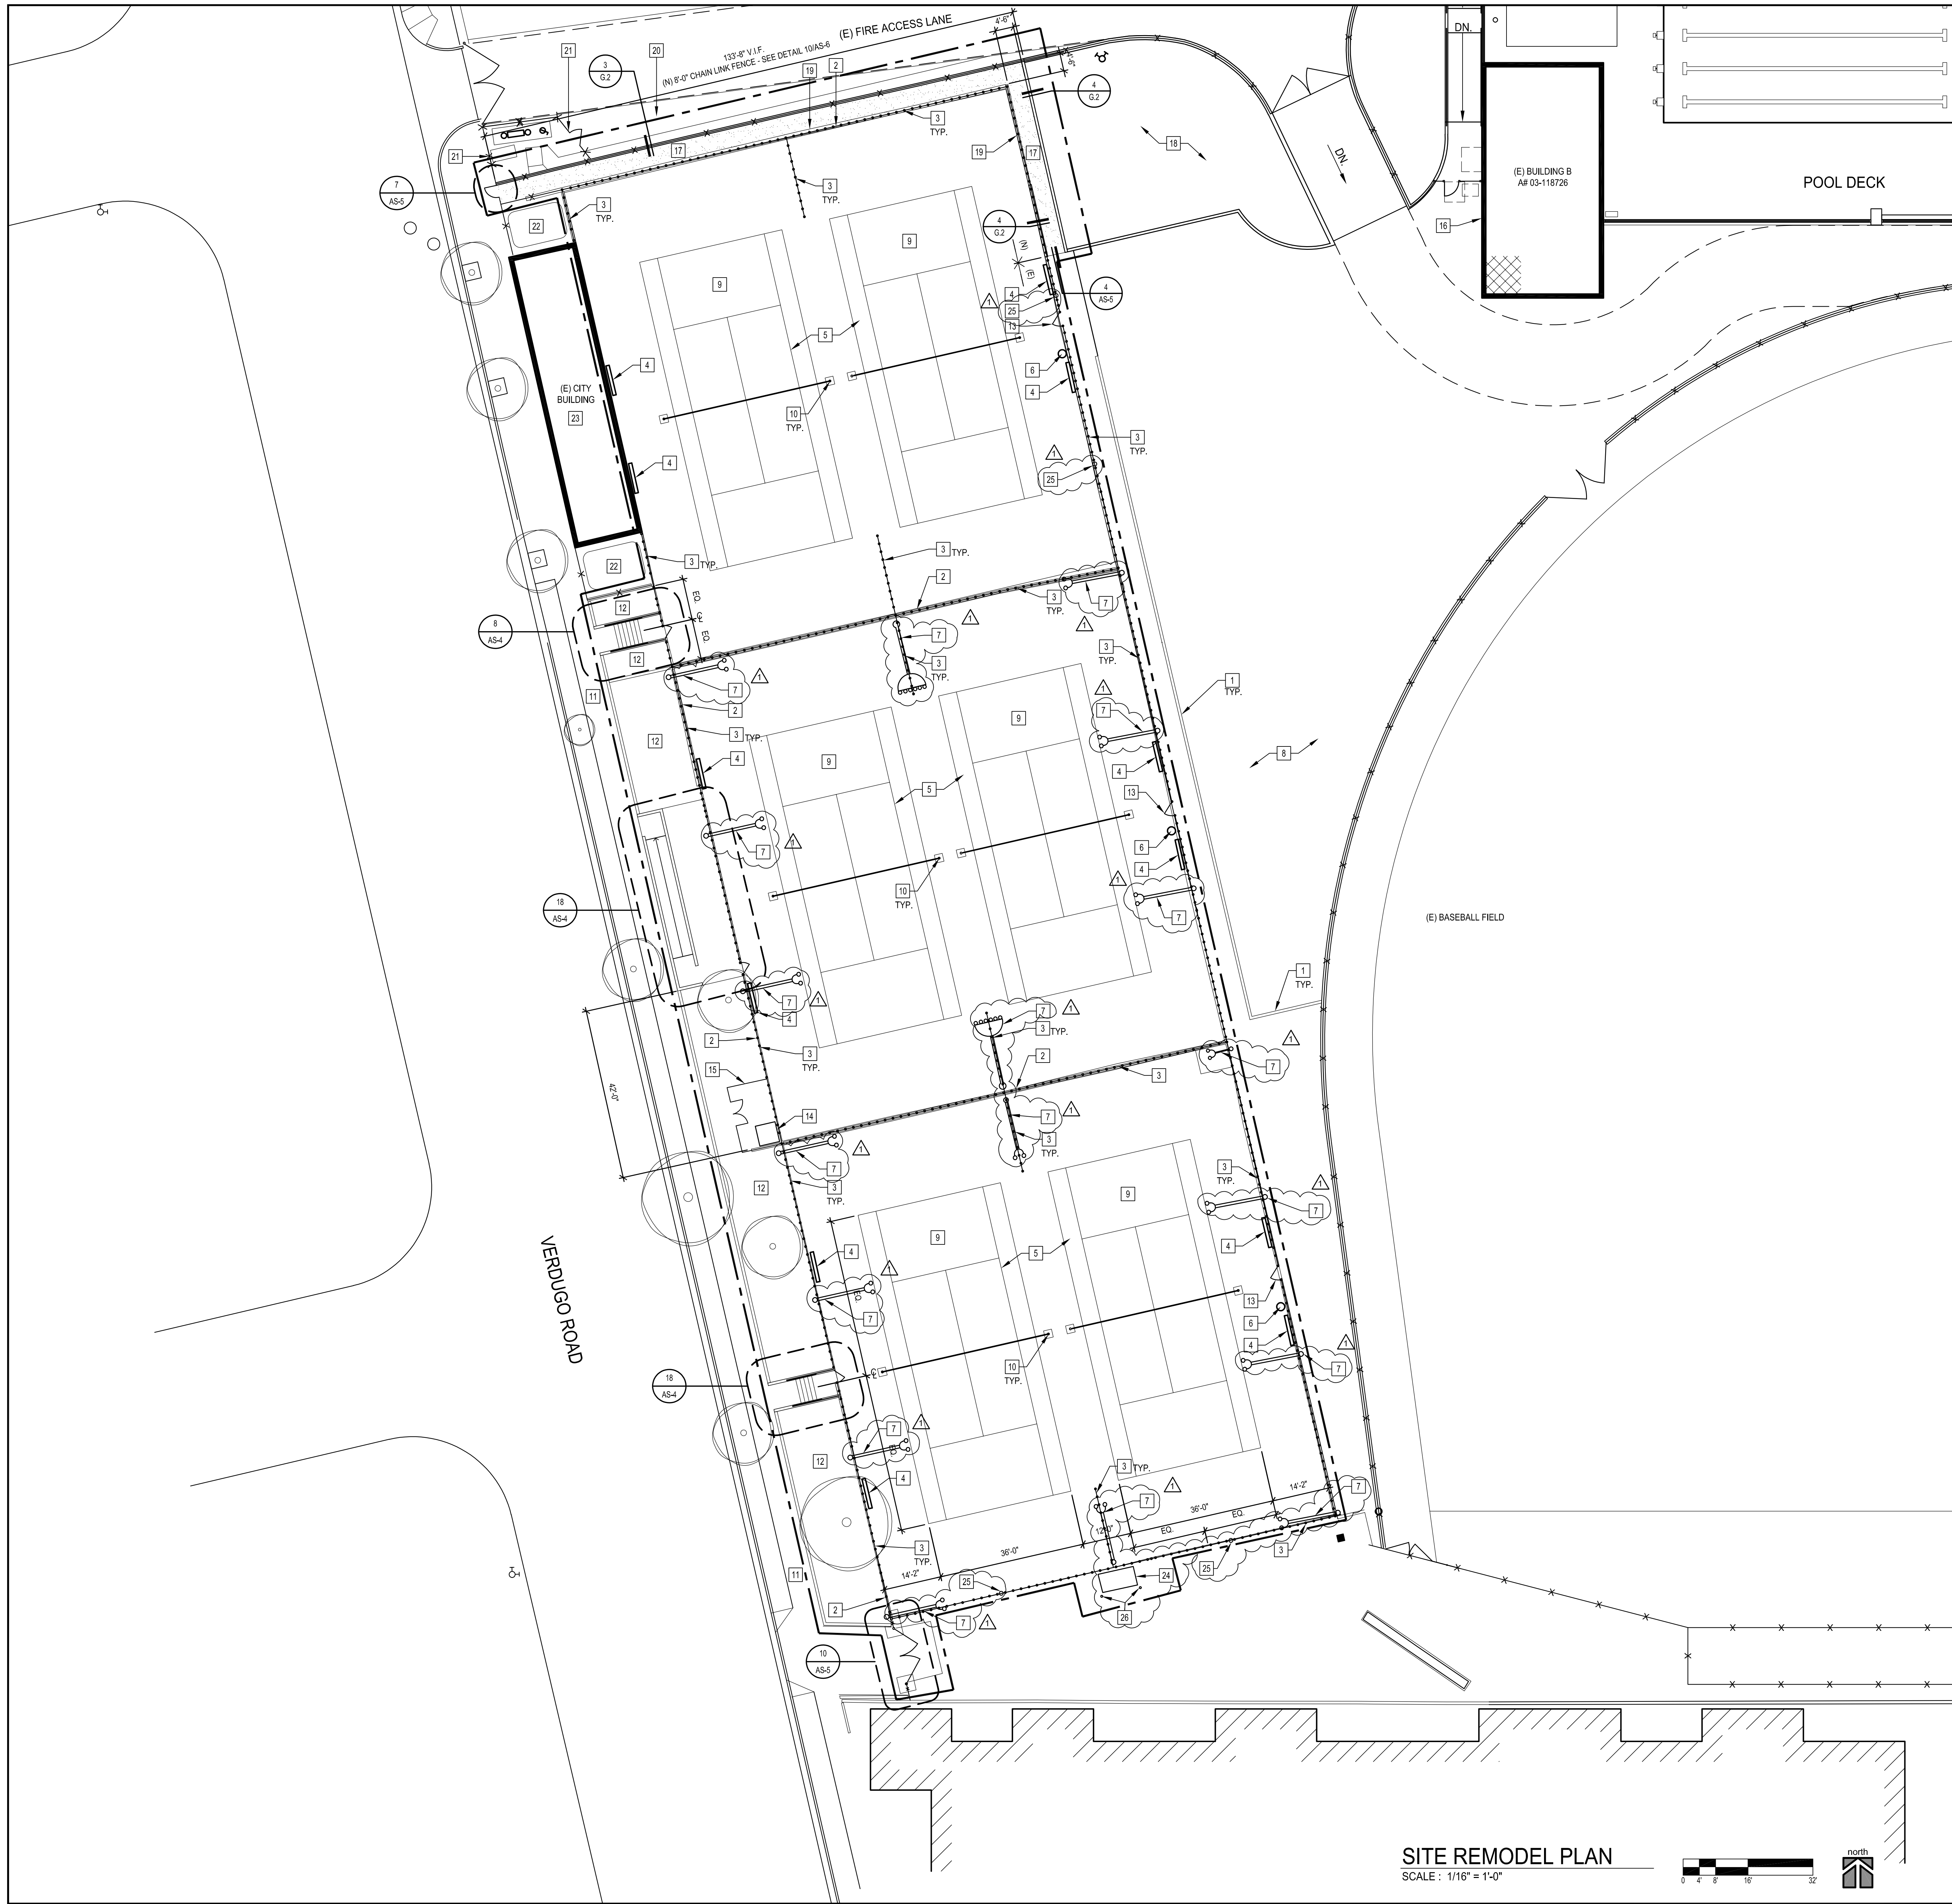

SITE REMODEL PLAN
SCALE: 1/16" = 1'-0"



GENERAL NOTES

- VERIFY ALL (E) FINISH GRADES, DIMENSIONS, AND SITE CONDITIONS BEFORE COMMENCING WORK AND REPORT ANY DISCREPANCIES TO THE ARCHITECT.
- ALL GRADING WORK SHALL CONFORM TO APPLICABLE PROVISIONS OF THE UNIFORM BUILDING CODE, CALIFORNIA BUILDING CODE, TITLE 24, AND LOCAL ORDINANCES OR ORDINANCES. IN THE EVENT OF CONFLICTING PROVISIONS, ALWAYS CONFORM TO THE STRICTER REQUIREMENTS.
- DETERMINE NECESSARY SUBGRADE ELEVATIONS AND CONSTRUCT SMOOTH TRANSITIONS BETWEEN FINISHED GRADES. FINISHED GRADE ELEVATIONS ADJACENT TO BUILDING PERIMETERS TO BE 6" BELOW FINISHED FLOOR ELEVATIONS, U.N.O.
- ALL CONCRETE PAVING TO BE MED. BROOM FINISH, U.N.O.
- SITE IMPROVEMENTS IN THE ACCESSIBLE PATH OF TRAVEL SHALL PROVIDE A BARRIER-FREE ACCESS WITHOUT ANY ABRUPT VERTICAL CHANGES EXCEEDING 1/4" OR 1/2" WHEN BEVELED 1:2. WALKWAYS SHALL A MAXIMUM SLOPE OF 1:21. MAXIMUM CROSS SLOPE IS 2% TYPICAL. THE CONTRACTOR SHALL VERIFY THAT ALL BARRIERS ON THE INDICATED PATH OF TRAVEL HAVE BEEN REMOVED.
- CONTRACTOR TO VERIFY THAT ALL BARRIERS IN THE PATH OF TRAVEL HAVE BEEN REMOVED OR WILL BE REMOVED UNDER THIS PROJECT, AND PATH OF TRAVEL COMPLIES WITH CBC 11338.
- LOCATIONS OF ALL UTILITIES SHOWN ARE APPROXIMATE. CONTRACTOR SHALL EXERCISE EXTREME CAUTION IN EXCAVATING AND TRENCHING TO AVOID INTERCEPTING EXISTING PIPING OR CONDUIT. THE ARCHITECT IS NOT RESPONSIBLE FOR THE LOCATION OF UNDERGROUND UTILITIES OR STRUCTURES WHETHER OR NOT SHOWN OR DETAILED AND INSTALLED BY OTHER CONTRACTS. THE CONTRACTOR SHALL IMMEDIATELY NOTIFY THE OWNER SHOULD SUCH UNIDENTIFIED CONDITIONS BE DISCOVERED. THESE DRAWINGS AND SPECIFICATIONS DO NOT INCLUDE NECESSARY COMPONENTS FOR CONSTRUCTION SAFETY.
- PATCH ALL HOLES IN COURT SURFACE AND GRIND FLUSH WITH ADJACENT SURFACE.
- ATTACH ALL ADDED POSTS AND ALL EXISTING POSTS TO EXISTING FENCE FRAME TO PERMANENTLY SECURE. SECURE PERPENDICULAR FENCING TO EACH OTHER WHERE THEY MEET.
- ALL FINISHES SHALL BE NON-FERROUS METAL OR HAVE 2 COATS OF ZINC RICH FINISH.


LEGEND

- (E) ALL GENDER ACCESSIBLE RESTROOM
AF 03-118726
- SCOPE OF WORK

REMODEL KEY NOTES

- (E) WALK AND WALL AF 03-118726 - PATCH ALL DAMAGED AREAS AND SLURRY SEAL ENTIRE EXPOSED WALL INCLUDING SIDES AND TOP
- PRIME AND PAINT (E) WALLS AND CURBS - INCLUDING SIDES AND TOPS OF WALLS - (E) DETAIL 10/AS-6
- REFURBISH (E) CHAIN LINK FENCE - UTILIZE (E) POSTS AND REGALVANIZE. PROVIDE BOTTOM RAILS, TENNIS BANDS, TRUSS RODS, TURNBUCKLES, AND CHAIN LINK FENCE FABRIC (11 GA. 1 1/2 GALV. FABRIC). HEIGHT TO MATCH (E). STRAIGHTEN AND REPAIR ANY POSTS THAT ARE NOT PROPERLY ALIGNED, PLUMB, OR OTHERWISE IN NEED OF REPAIR. PROVIDE 2 COATS OF ZINC RICH COATING.
- (N) 7'-0" STEEL BENCH - OFCI
- COAT, PATCH, AND STRIPE (E) TENNIS COURTS. PATCH HOLES WHERE (E) FENCE POLES HAVE BEEN REMOVED. TYP.
- (N) LITTER RECEPTACLE - OFCI
- (E) TENNIS COURT LIGHTING - REGALVANIZE LIGHT POSTS UP TO THE LIGHT FIXTURES WITH 2 COATS OF ZINC RICH COATING.
- (E) AC PAVING TO REMAIN
- TENNIS COURT STRIPING - SEE DETAIL 20/AS-6
- TENNIS COURT NET AND POSTS - SEE DETAIL 18/AS-6
- (E) SIDE WALK TO REMAIN - PROTECT IN PLACE
- (N) LANDSCAPED AREA - SEE LANDSCAPE DRAWINGS
- (N) 4'-0" WIDE CHAIN LINK GATE - SEE DETAIL 16/AS-6
- (E) TRANSFORMER TO REMAIN
- (E) CHAIN LINK ENCLOSURE TO REMAIN
- (E) DRINKING FOUNTAIN AF 03-118726
- (N) CONC. WALK - SEE DETAIL 1/3.1 AND CIVIL DRAWINGS
- (E) LANDSCAPE AREA TO REMAIN
- (E) TENNIS COURT WALL TO REMAIN
- (E) SYNTHETIC TURF
- (E) CHAIN LINK FENCE
- (E) CITY TANKS TO REMAIN - PROTECT IN PLACE
- (E) CITY BLDG. - PROTECT IN PLACE
- (E) ELECTRICAL ENCLOSURE - PROVIDE (N) T11 SIDING, ROOFING, DOOR AND FRAME
- PROVIDE (N) CHAIN LINK POST PER DETAIL 10/AS-6 - MATCH (E) HEIGHT
- PROVIDE (N) BOLLARDS PER DETAIL 1/AS-4

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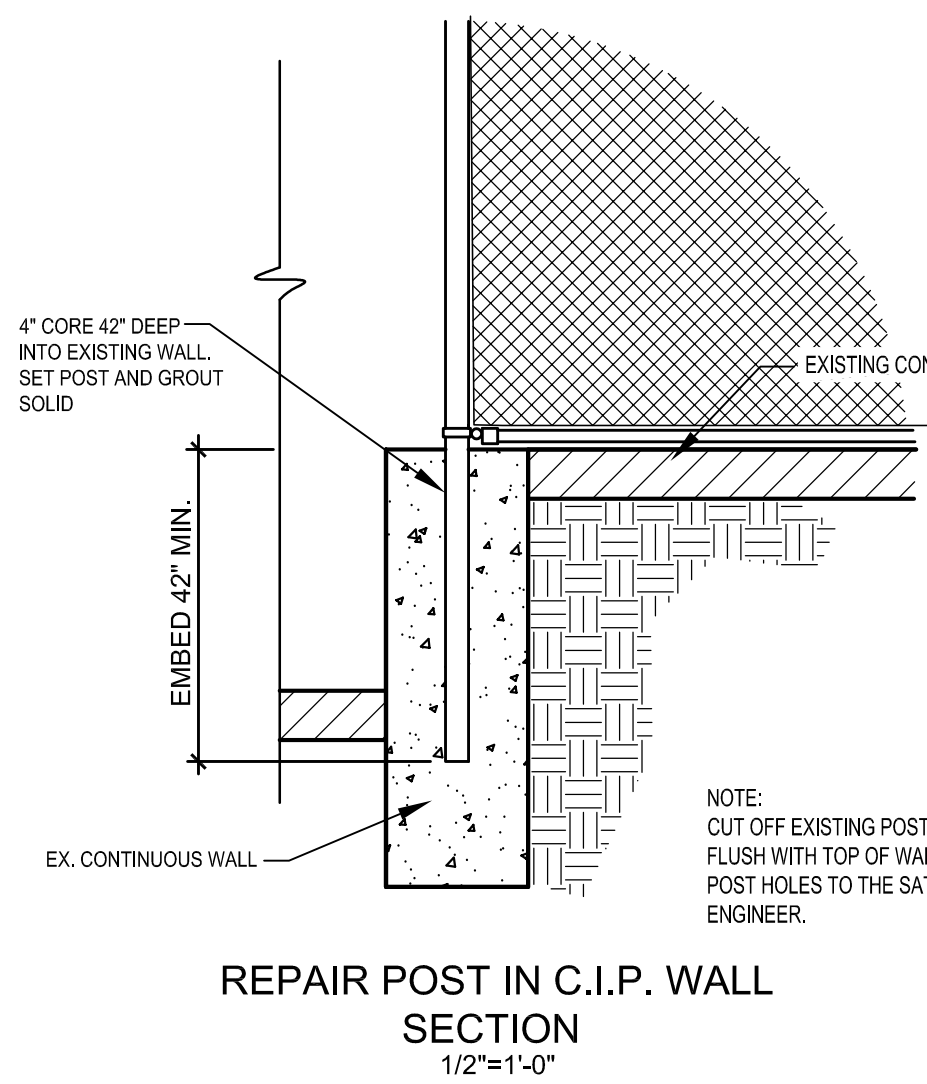
owner

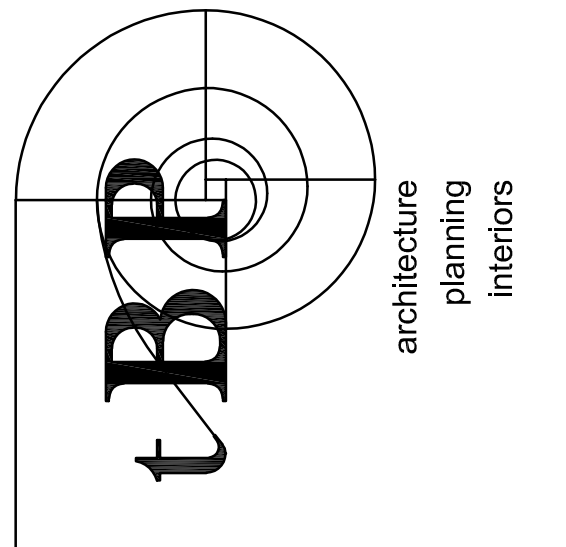tBP project number :	20916.03
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date:	3/5/2020
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6/25/2020	ADDENDUM 1


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drawing title:
**ENLARGED REMODEL
SITE PLAN**


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AS-3
drawing of



REPAIR POST IN C.I.P. WALL SECTION 1/2"=1'-0"

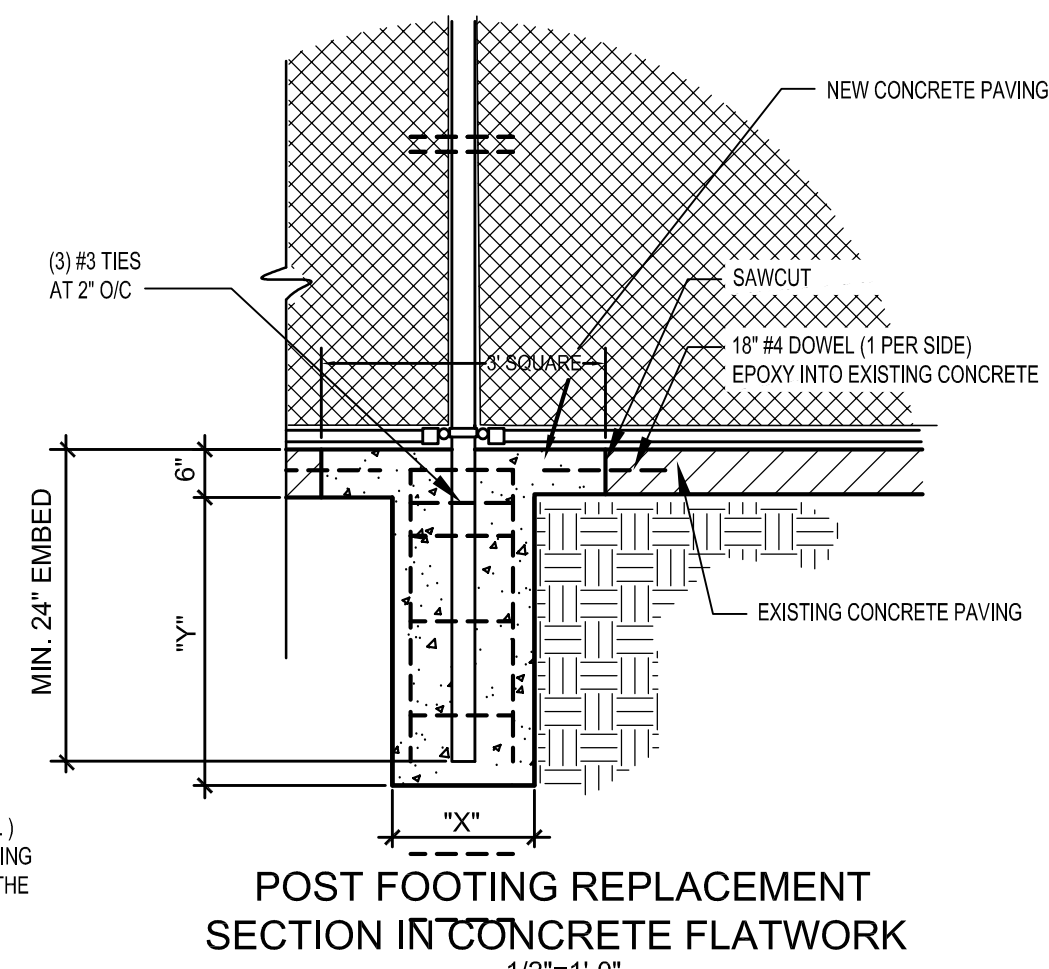


POST FOOTING REPLACEMENT SECTION IN CONCRETE FLATWORK 1/2"=1'-0"

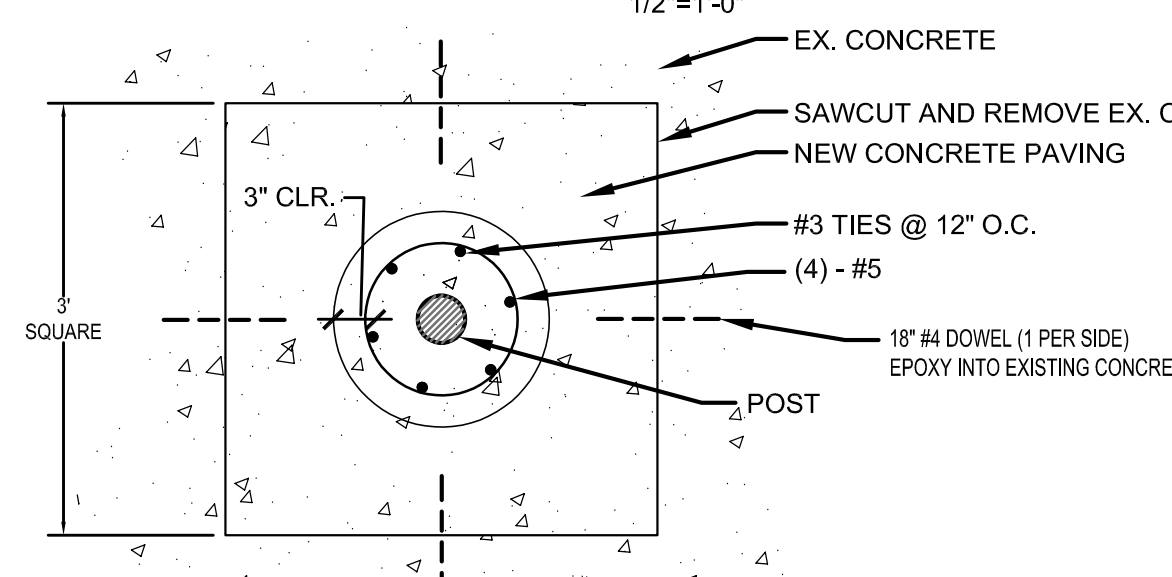


POST FOOTING REPLACEMENT PLAN VIEW (REINFORCEMENT REQUIRED) 3/4"=1'-0"

TABLE - CHAIN LINK FENCING

	POST	DIAMETER	FOOTING DEPTH "Y"	FOOTING DIA. "X"	MAX. SPACING	FINISH
	TOP & BOTTOM & HORIZ. RAILS	1 5/8"				GALVANIZED OR HOT DIPPED GALVANIZED
HEIGHT OF FENCING	10'-12' HT.	3"	4'-9"	18"	10' O.C.	GALVANIZED OR HOT DIPPED GALVANIZED
	8' HT.	2 1/2"	3'-9"	18"	10' O.C.	GALVANIZED OR HOT DIPPED GALVANIZED

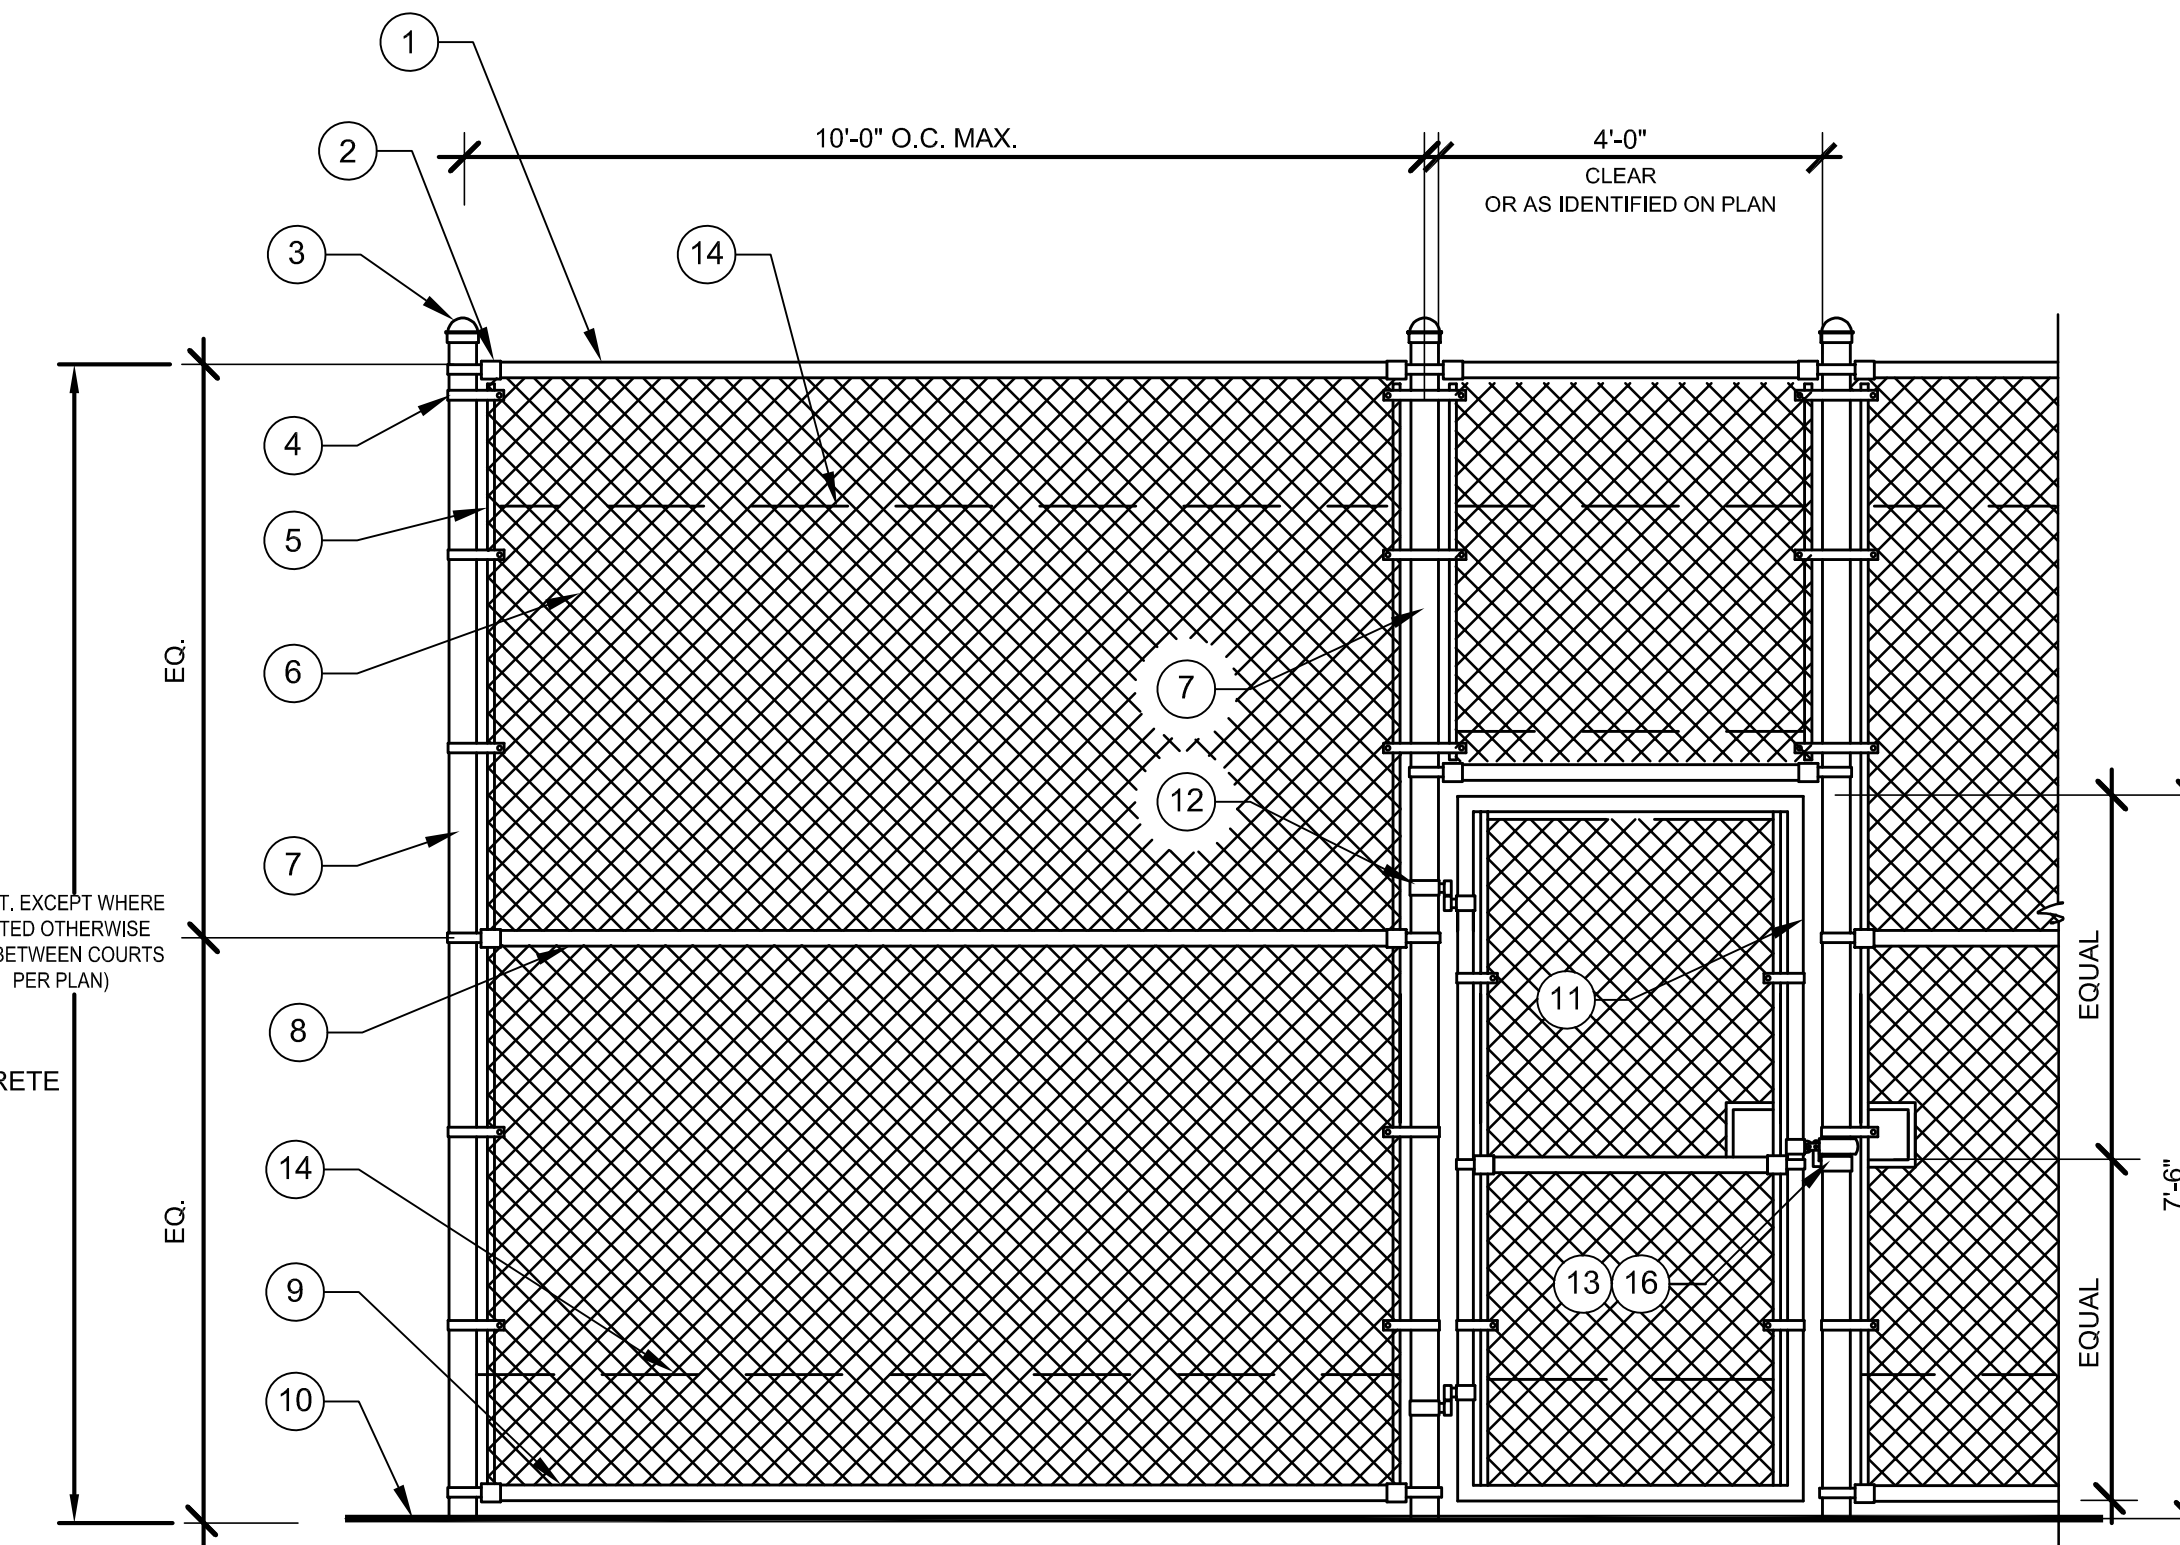

SINGLE GATE

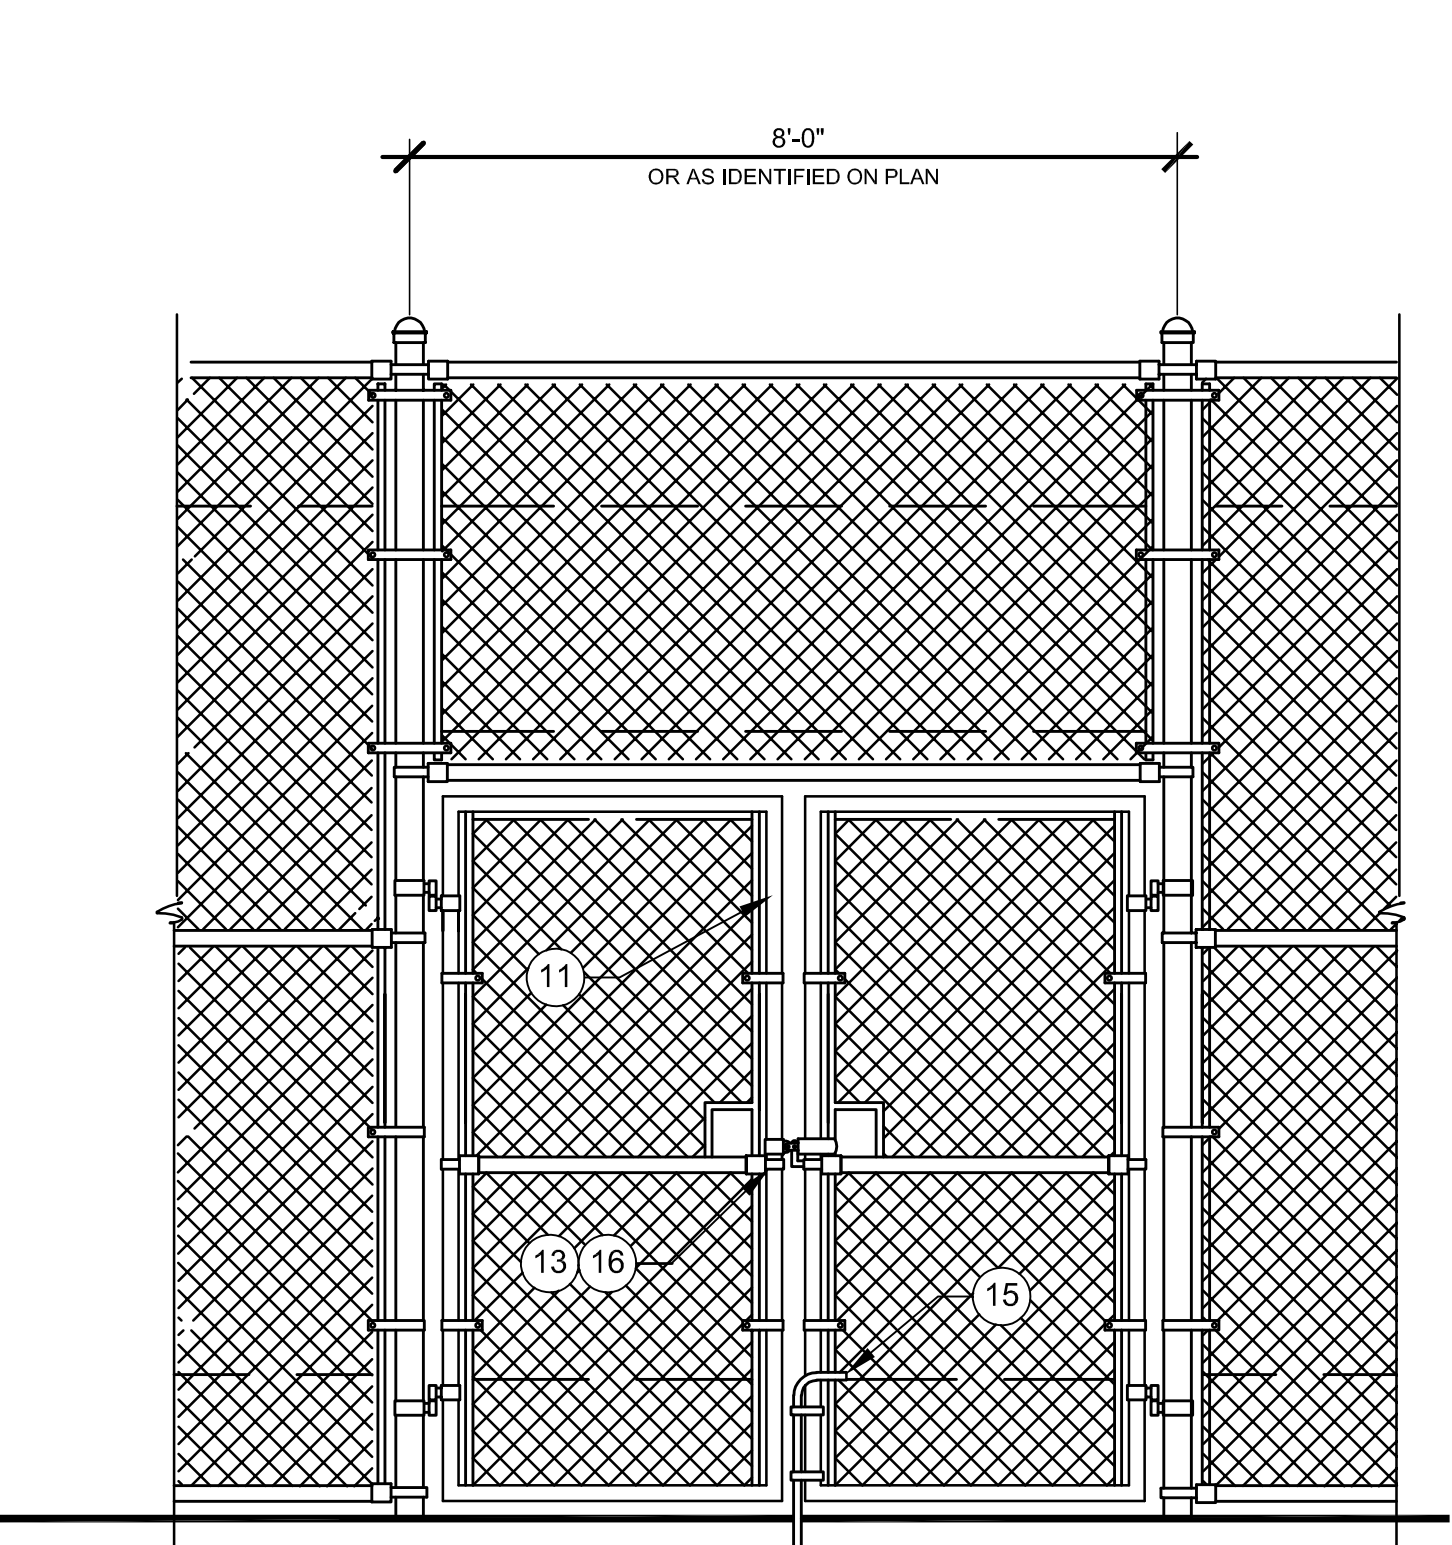

DOUBLE GATE


NOTE

- A. CONTRACTOR SHALL PROVIDE SHOP DRAWINGS FOR FENCING.
- B. ALL POSTS, RAILS AND CHAIN LINK FABRIC AND FENCE ACCESSORIES SHALL BE GALVANIZED.
- C. CONTRACTOR SHALL PROVIDE FABRIC SAMPLES OF SCREENING MATERIAL.
- D. GROUT TO BE FLUSH WITH TOP OF WALL TO THE SATISFACTION OF THE ENGINEER.
- E. DO NOT REUSE EXISTING POST IN CAST-IN-PLACE WALL UNLESS NOTED OTHERWISE ON PLAN.
- F. FIELD WELDS TO BE CLEANED AND SPRAYED WITH GALVANOX COLD GALVANIZING ZINC PAINT BY CARBOLINE (314) 644-4617 OR APPROVED EQUAL.


LEGEND

- 1 TOP RAIL, 1-5/8" O.D. GALVANIZED STEEL PIPE
- 2 RAIL END, TYPICAL
- 3 POST CAP, GALVANIZED
- 4 STRETCHER BAND, TYPICAL
- 5 STRETCHER BAR, TYPICAL
- 6 11 GA 1/3" GALV. CHAIN LINK FABRIC WITH KNUCKLED SELVAGE AT TOP AND BOTTOM
- 7 POST, 3" O.D. GALVANIZED STEEL
- 8 MID-RAIL/HORIZONTAL BRACE, 1-5/8" O.D. GALVANIZED STEEL PIPE
- 9 1-5/8" O.D. GALVANIZED STEEL PIPE BOTTOM RAIL/HORIZONTAL BRACE, TYP., CONTINUOUS 2" ABOVE FINISH GRADE
- 10 FINISHED SURFACE OF TENNIS COURT SLAB
- 11 GATE FRAME, 1-5/8" O.D. WELDED, GALVANIZED STEEL PIPE
- 12 HEAVY-DUTY GATE HINGE, (2) PER GATE
- 13 CHAIN & LOCK PER SPPWC DETAIL 600-2
- 14 WINDSCREEN FABRIC TO 18" FROM TOP AND 18" FROM BOTTOM. FABRIC TO BE OPEN MESH, "GREEN" SEAMLESS POLYPROPYLENE, 8' HEIGHT, AVAILABLE FROM N.J.P. SPORTS, INC., (818) 247-3914, FAX (818) 247-2605. INSTALL PER MANUFACTURER'S SPECIFICATIONS.
- 15 CANE BOLT
- 16 CONSTRUCT CHAIN AND LOCK CUT-OUT PER SPPWC 600-2


CHAIN LINK FENCE AND GATES

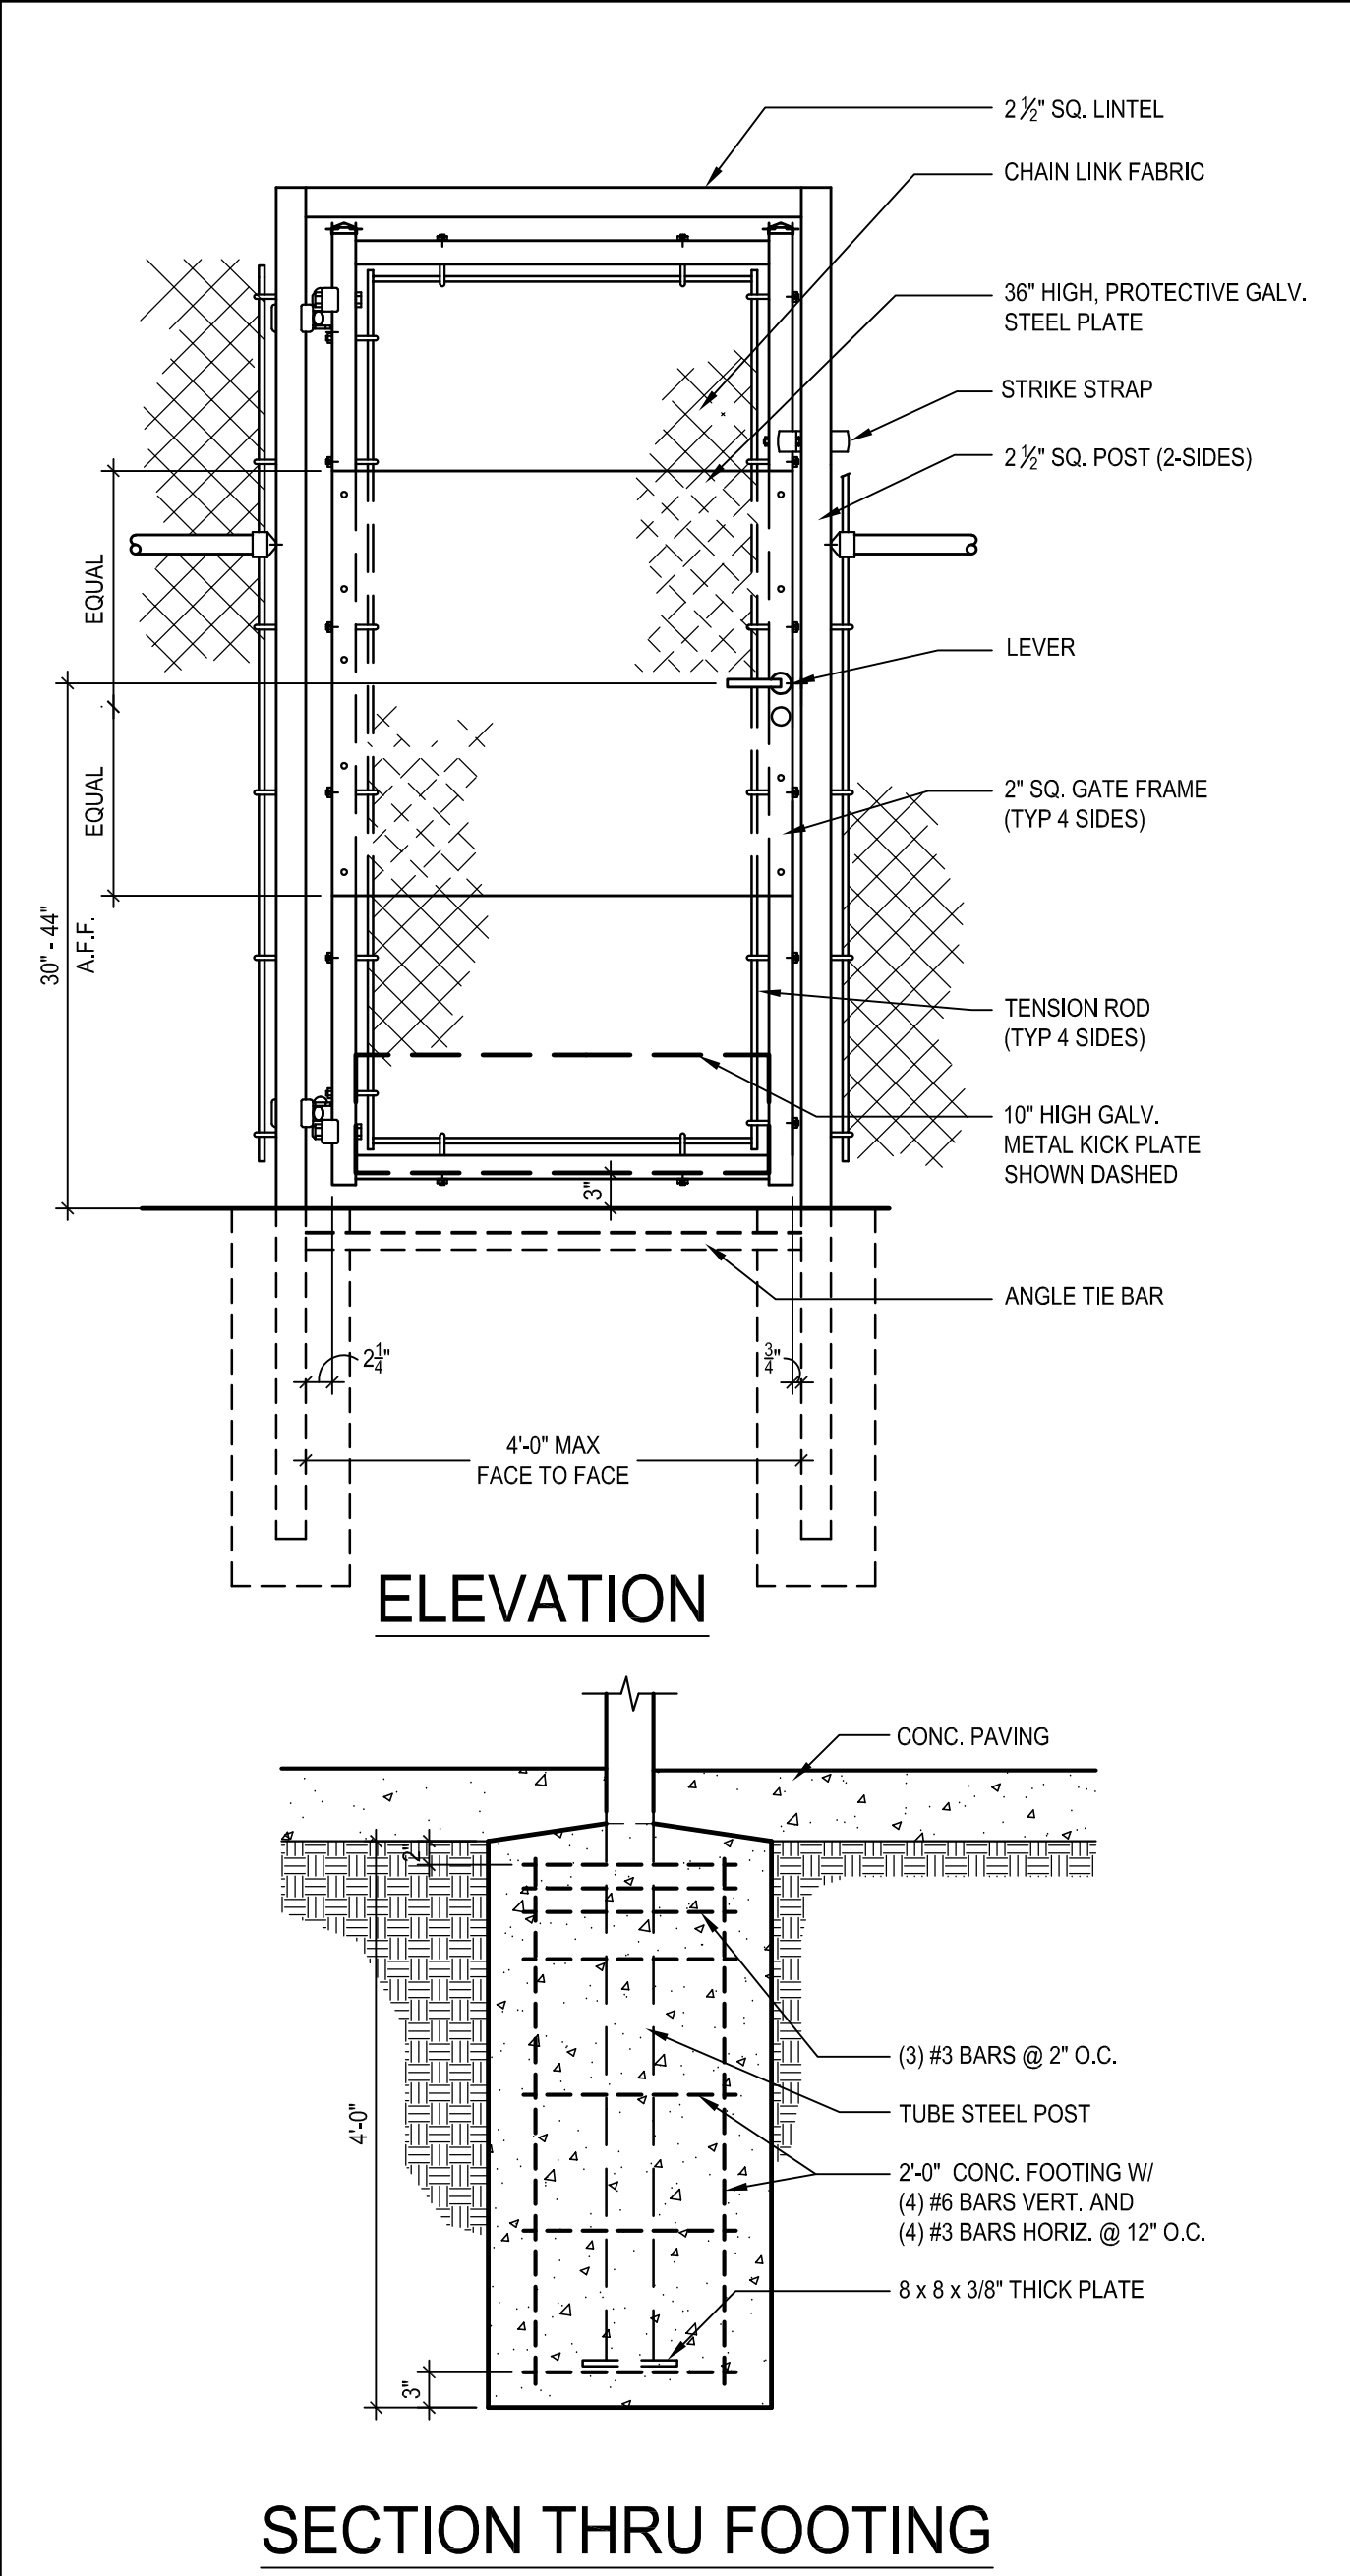


GATE W/ LEVER SCALE: 3/4"=1'-0" 16

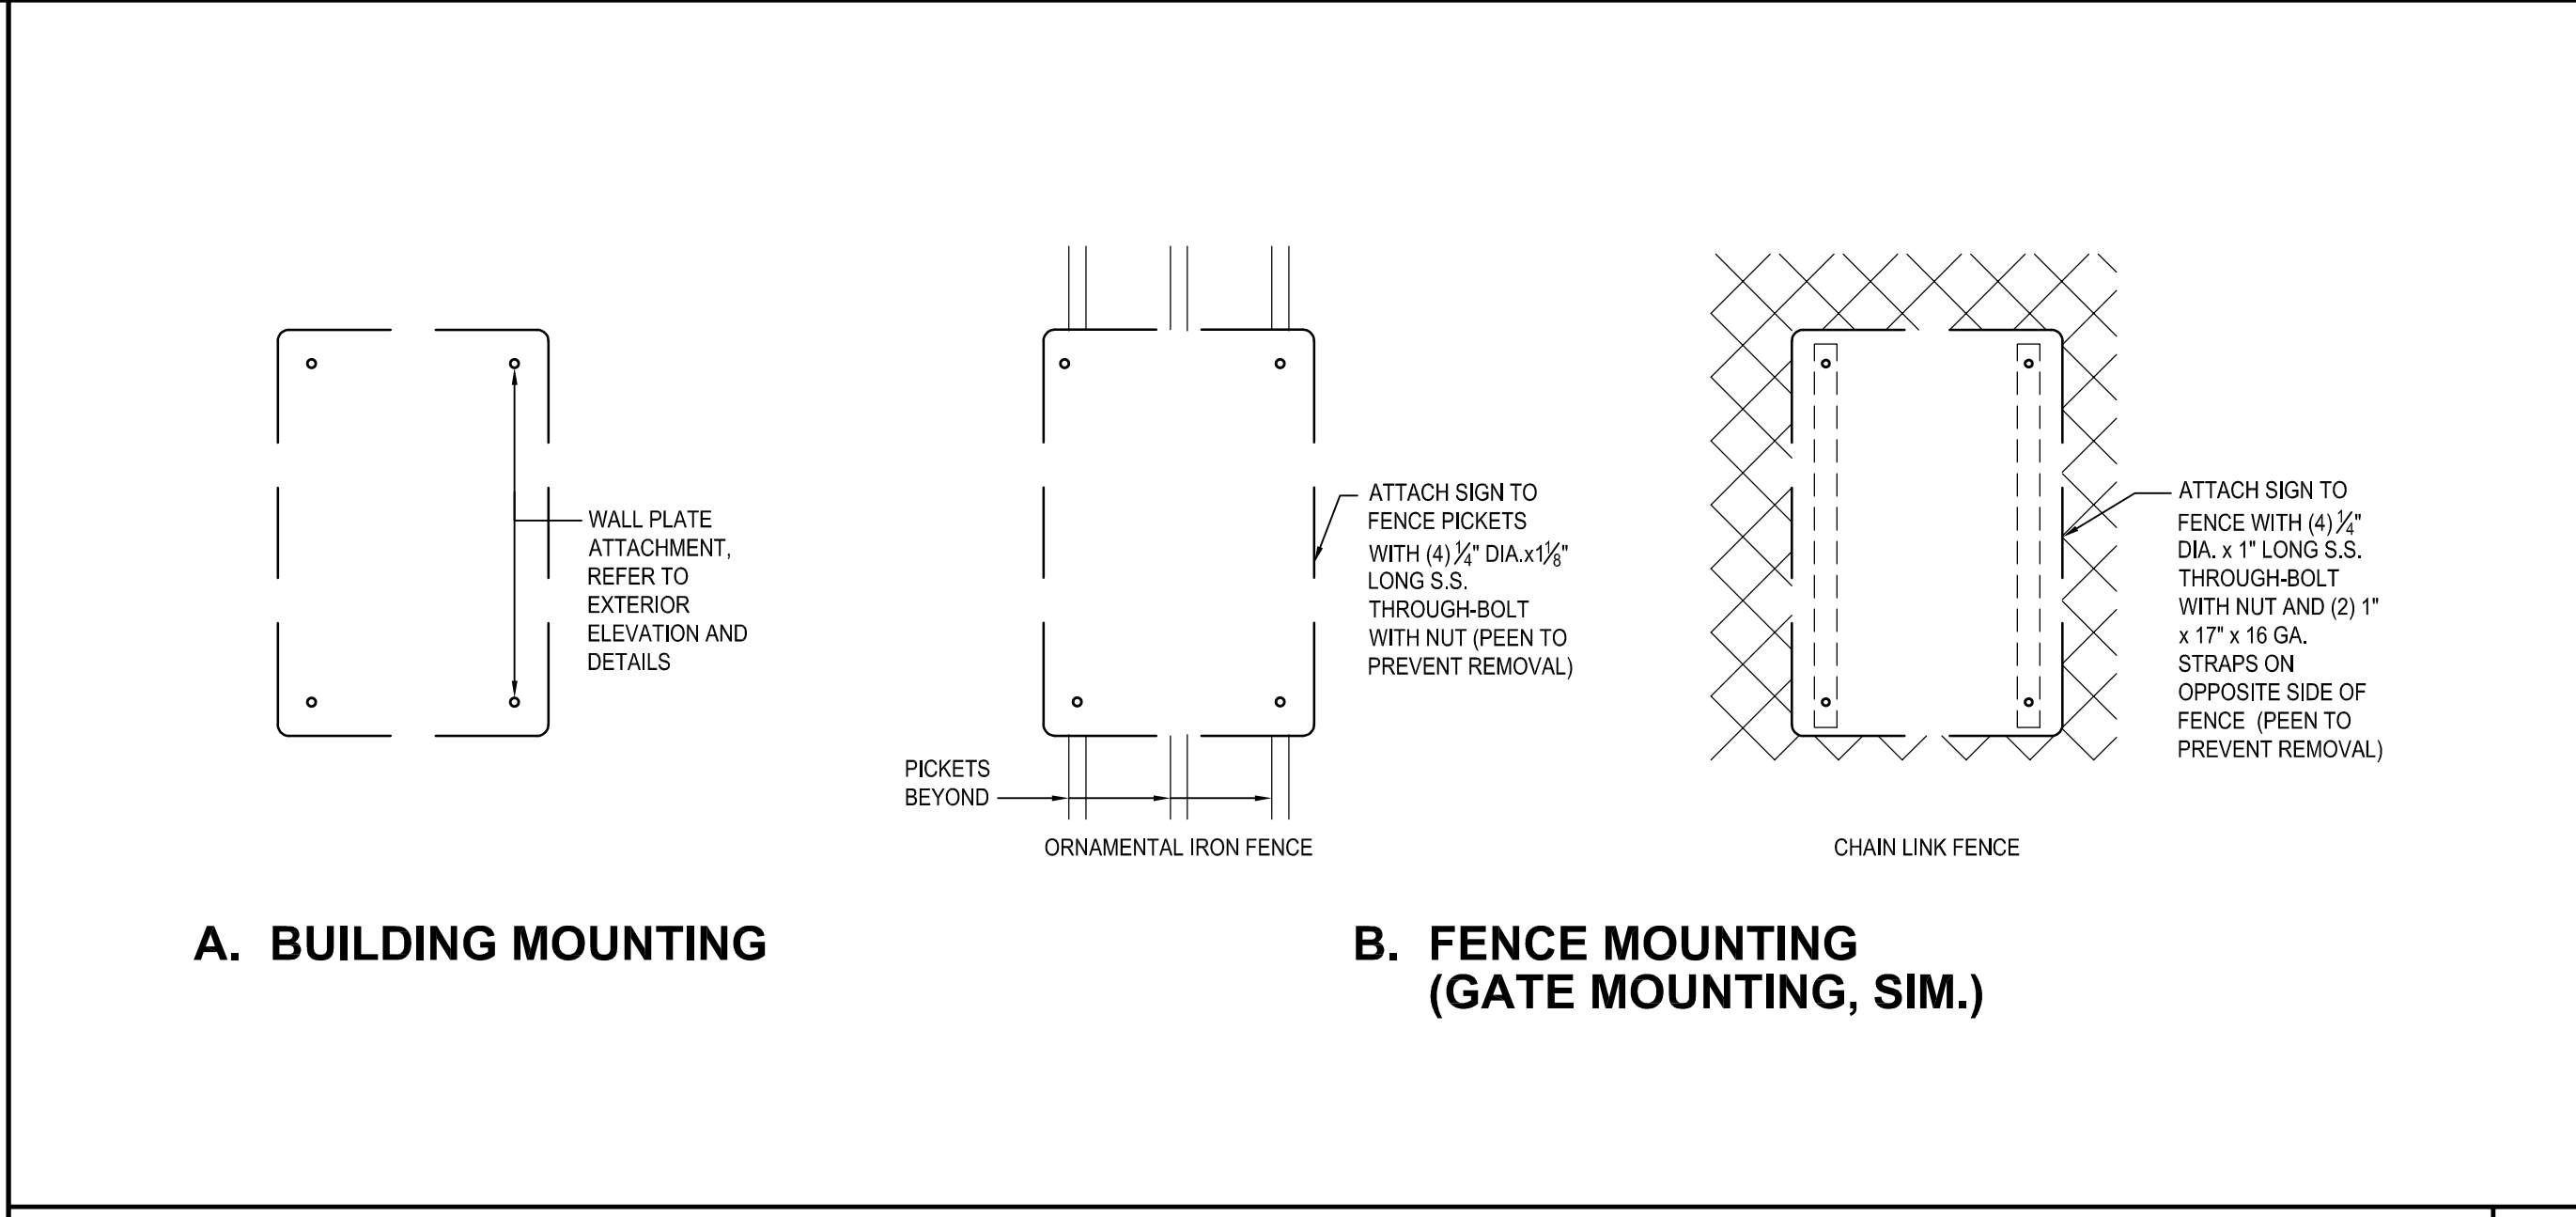

MOUNTING DETAILS SCALE: 1"=1'-0" 13

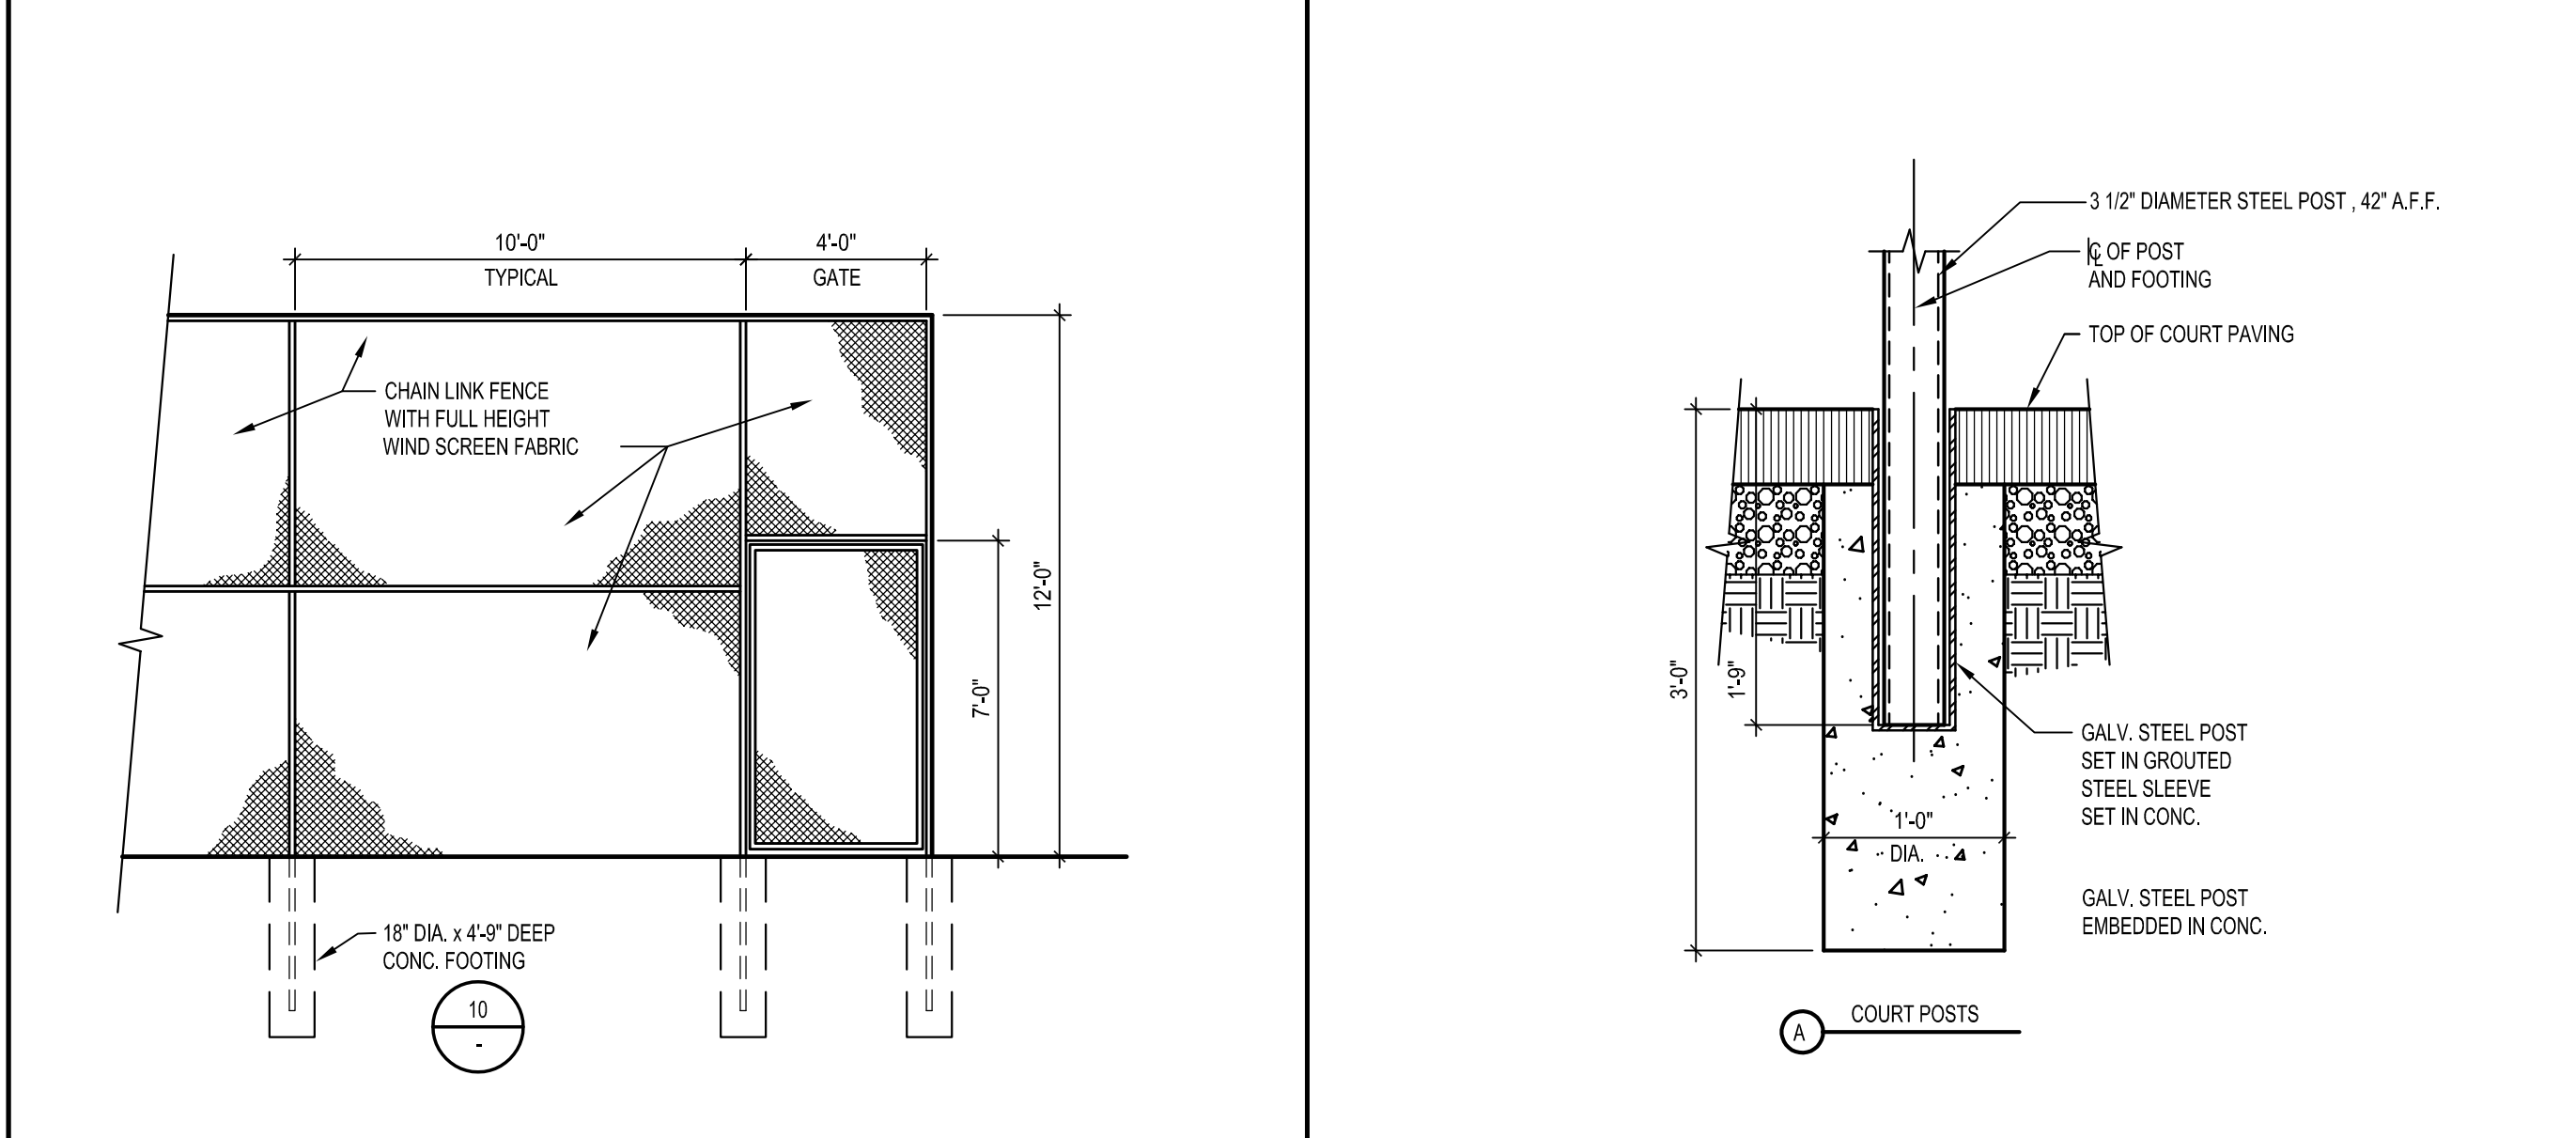


TENNIS COURT FENCE SCALE: 1/4"=1'-0" 17

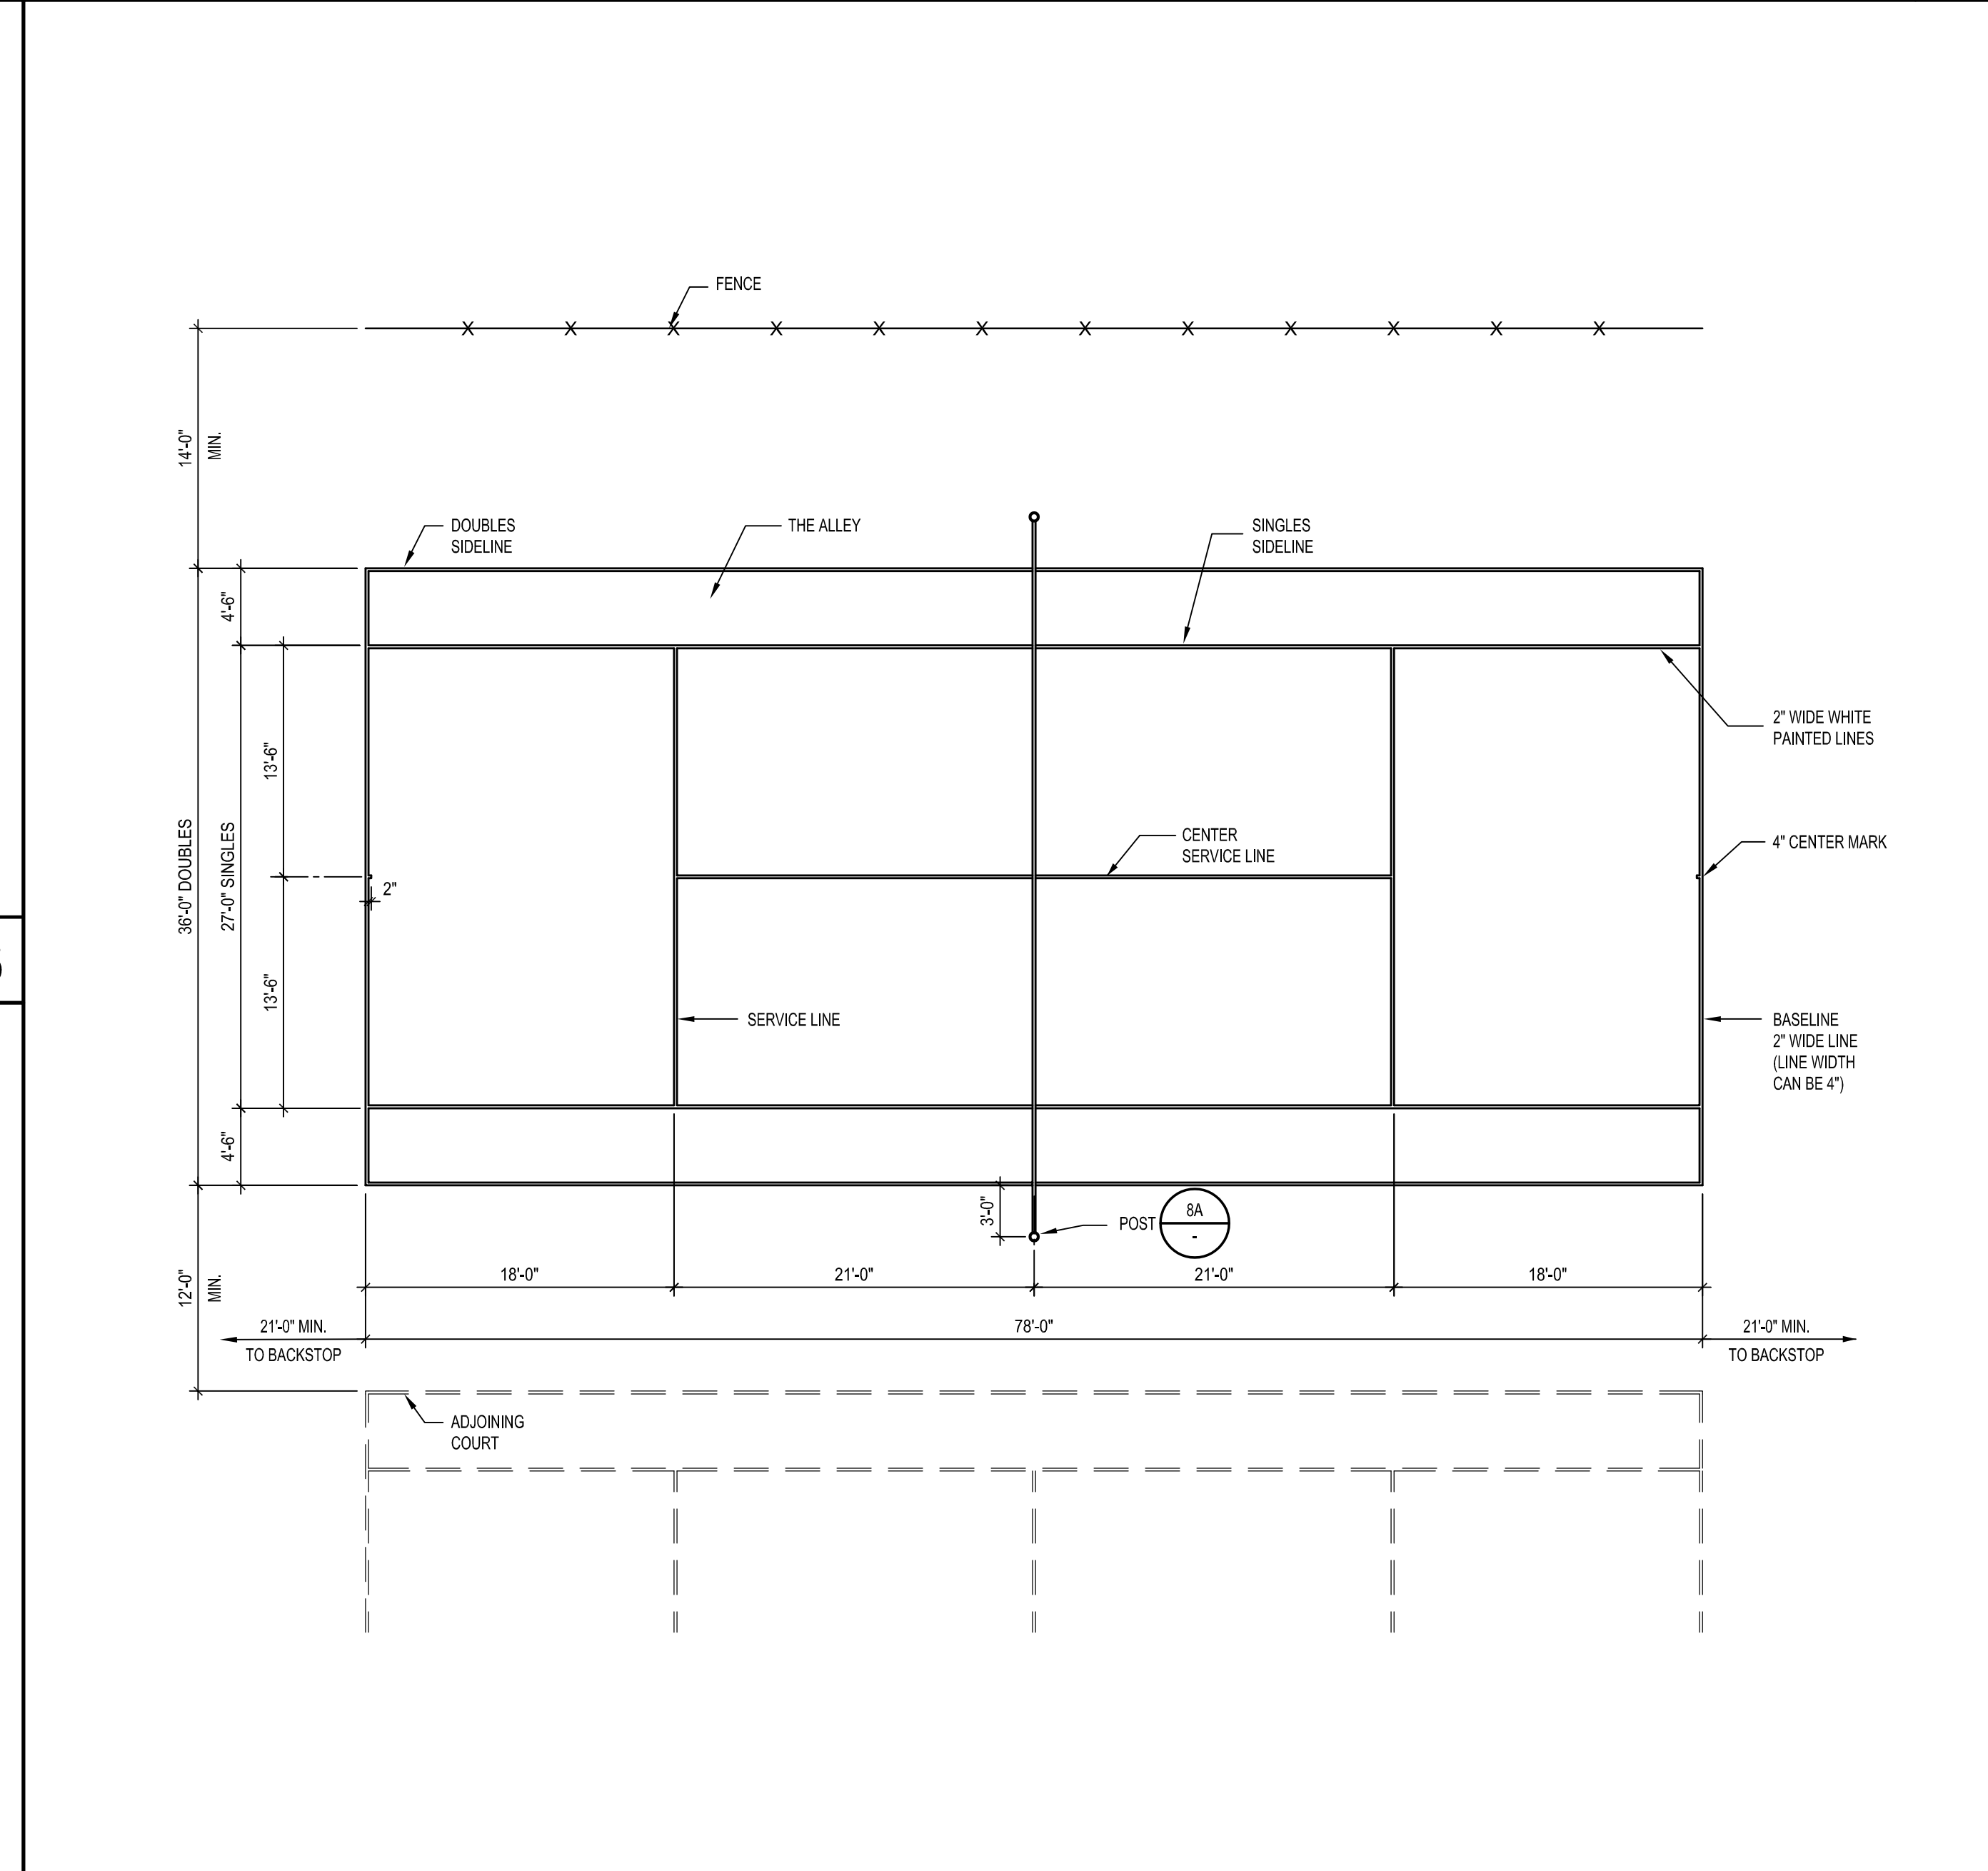

TENNIS COURT PLAN SCALE: 1/8"=1'-0" 20

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owner
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TENNIS COURT RENOVATION PROJECT**
GLENDALE UNIFIED SCHOOL DISTRICT
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GLENDALE, CALIFORNIA 91205

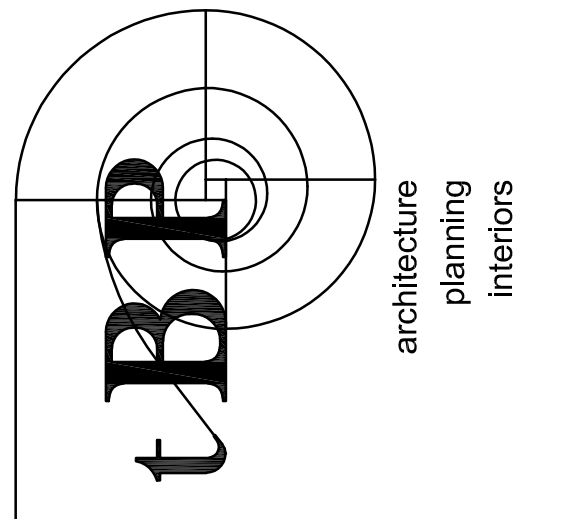tBP project number : 20916.03
file name:
drawn by: checked by:
date: 3/5/2020
Rev. date: description:

drawing title:
**SITE
DETAILS**

drawing no.:
AS-6
drawing of