

Date: October 18, 2021

ADDENDUM NO. 2

To Project Bidding Documents for:

**MONTE VISTA ELEMENTARY SCHOOL
2-STORY MODULAR BUILDING FOUNDATION & SITE
GLENDALE UNIFIED SCHOOL DISTRICT**

DSA Appl. No.03-121419
DSA File No. 19-41

tBP Project No. 21056.01

tBP/ARCHITECTURE
4611 Teller Avenue
Newport Beach, CA 92660
949/673-0300

TO: PROSPECTIVE BIDDERS

This Addendum forms a part of the Contract Documents and modifies the original Bidding Drawings and Specifications dated September 29, 2021. Acknowledge receipt of this Addendum in space provided on the Bid Form. Failure to acknowledge may subject Bidder to disqualification.

CHANGES TO DRAWINGS

1. SHEET 0AS-3 – MODULAR BUILDING SITE PLAN
 - a. Added location for kiln to be located.
 - b. Added keynote No. 37 to the sheet.
 - c. Revised keynote for new chain link fencing on plan.

2. SHEET ES-2 – ENLARGE ELECTRICAL SITE PLAN
 - a. Added feeder conduit, wiring and connection to relocated kiln as shown in the clouded area of the site plan.
 - b. Added keynotes No. 13 and No. 14 to the sheet.

3. RESTROOM ACCESSORIES
 - a. All restroom accessories, not provided by AMS, are Owner Furnished/Contractor Installed.

ATTACHMENTS

The following attachments are a part of Addendum No. 2:

1. **Full Size Documents (30" x 42") Drawings: (Total 2)**

AS-3	Modular Building Site plan
ES-2	Enlarged Site Electrical Plan




Hung Cheng
tBP/Architecture




Stephen R. Zajicek
FBA Engineering

Division of State Architect Date
Office of Regulation Services


End of Addendum

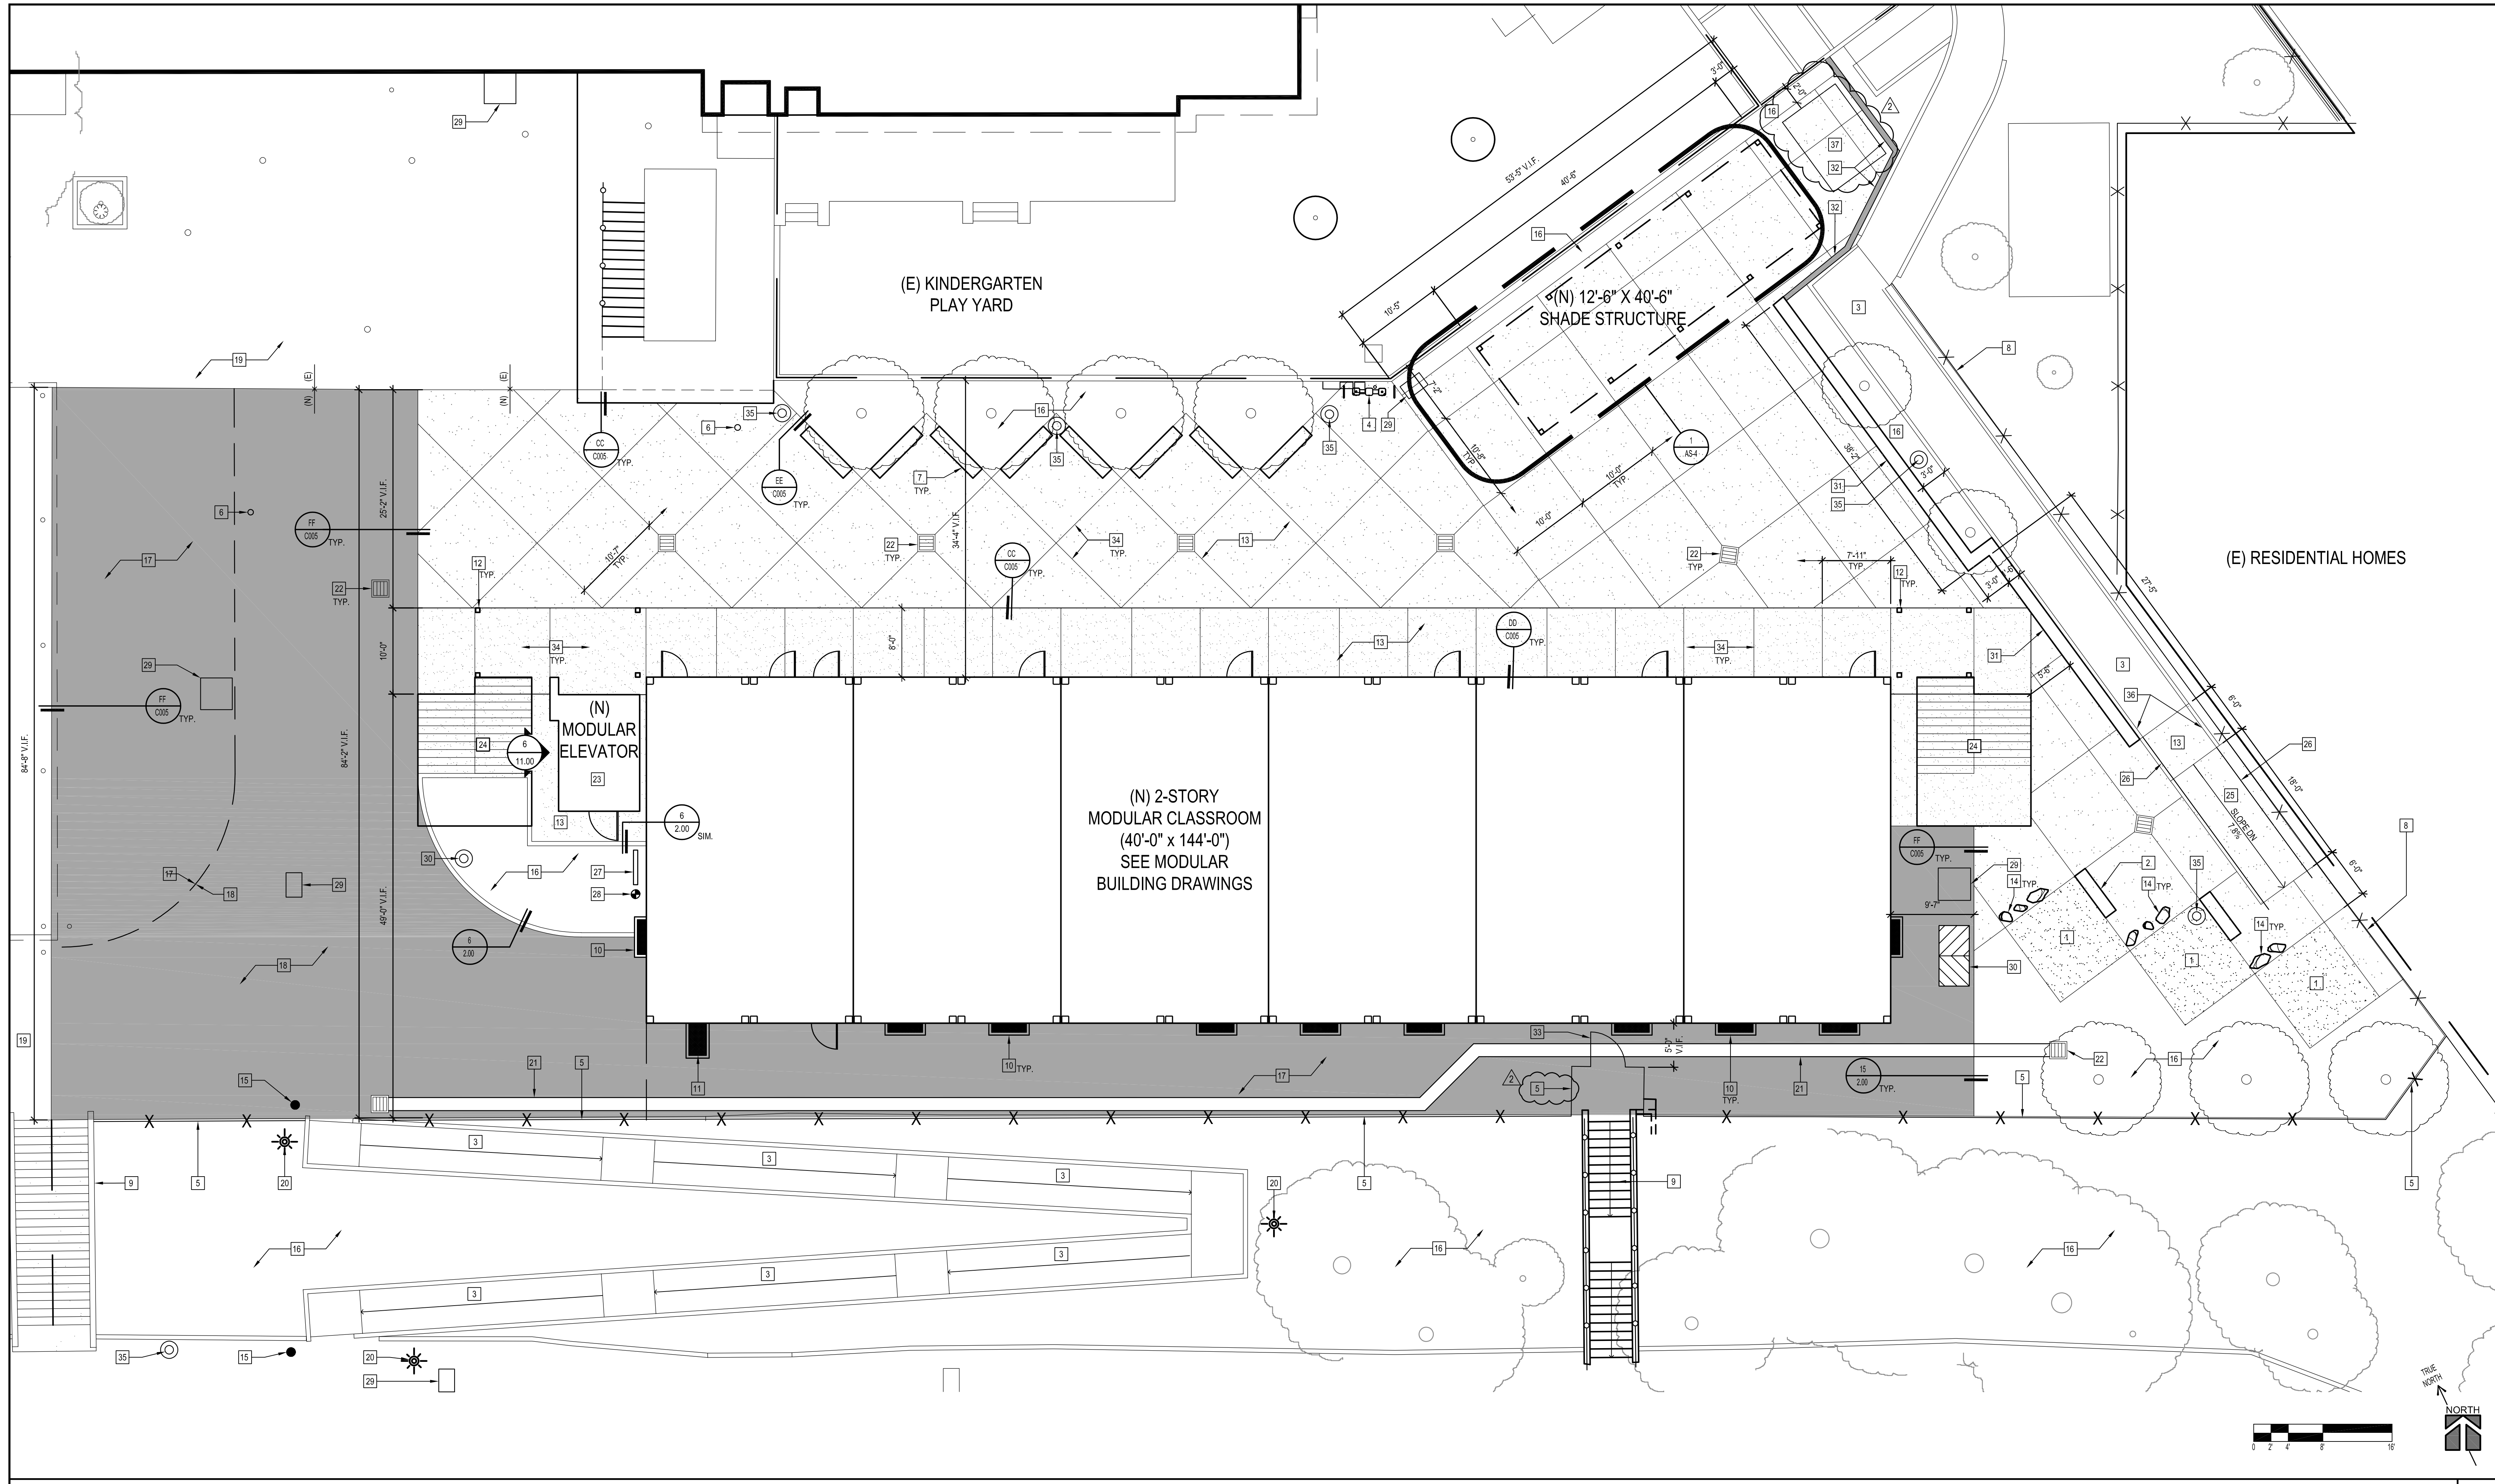


SITE PLAN
SCALE: 1/8" = 1'-0"

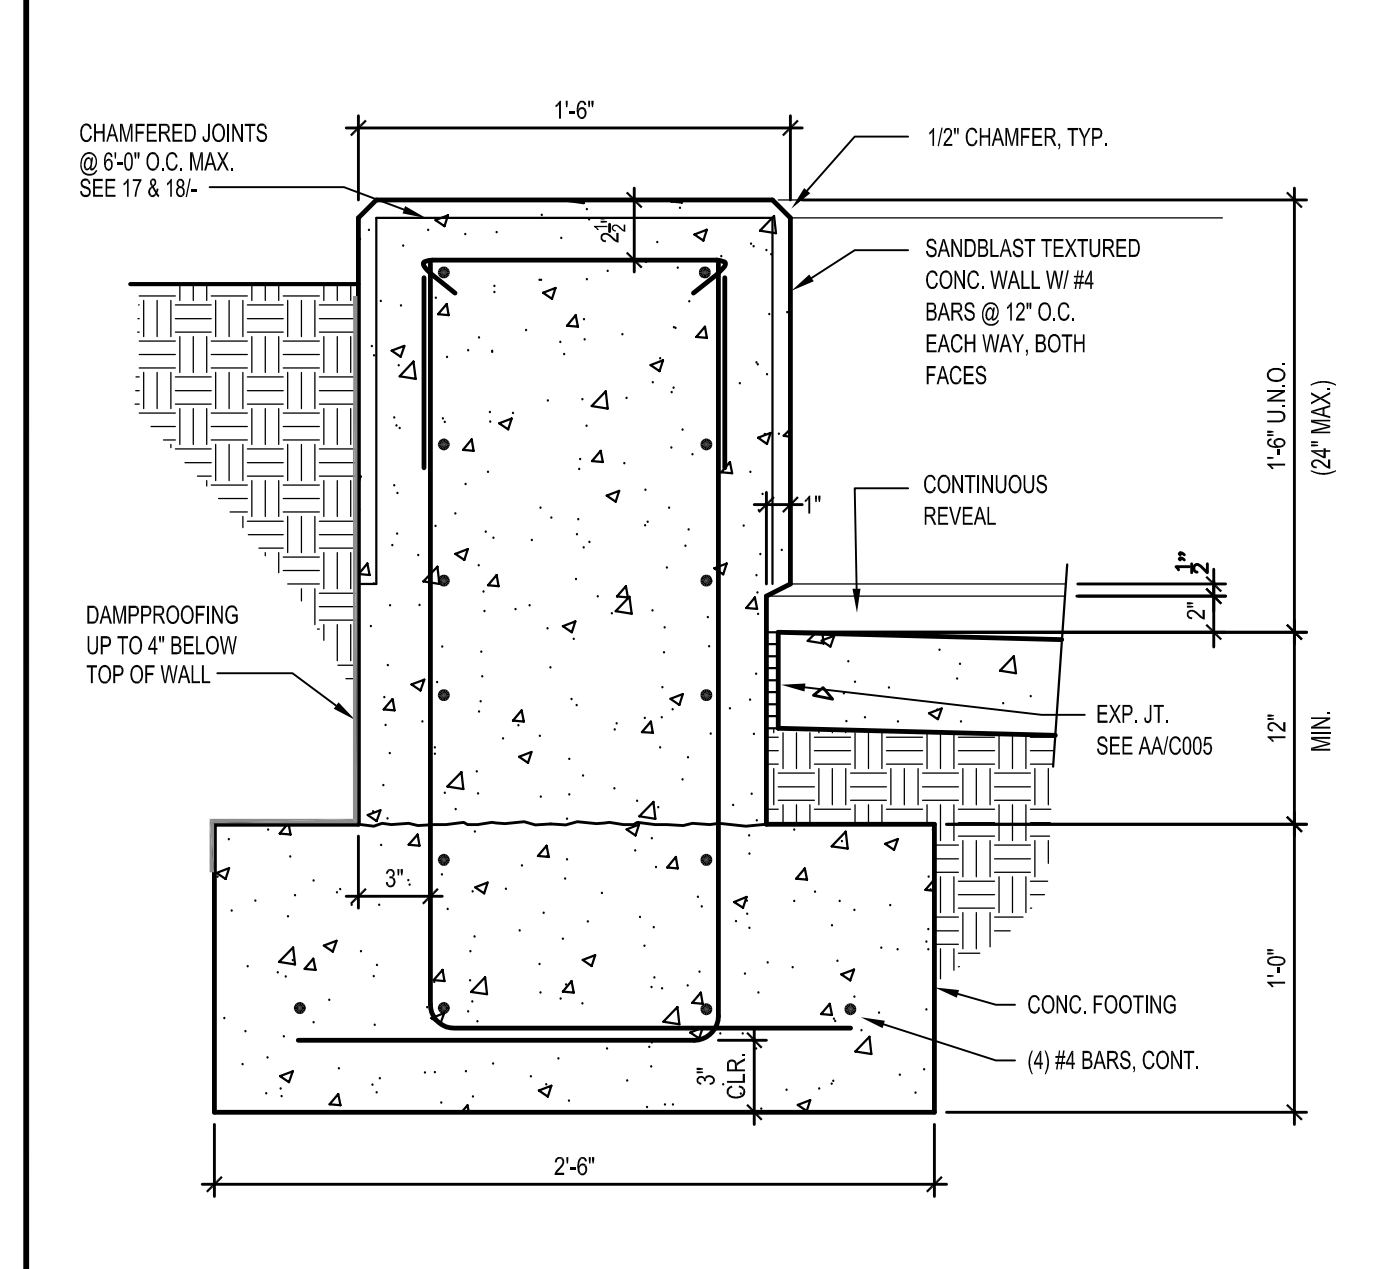

SEAT WALL SECTION
SCALE: 1/4" = 1'-0"

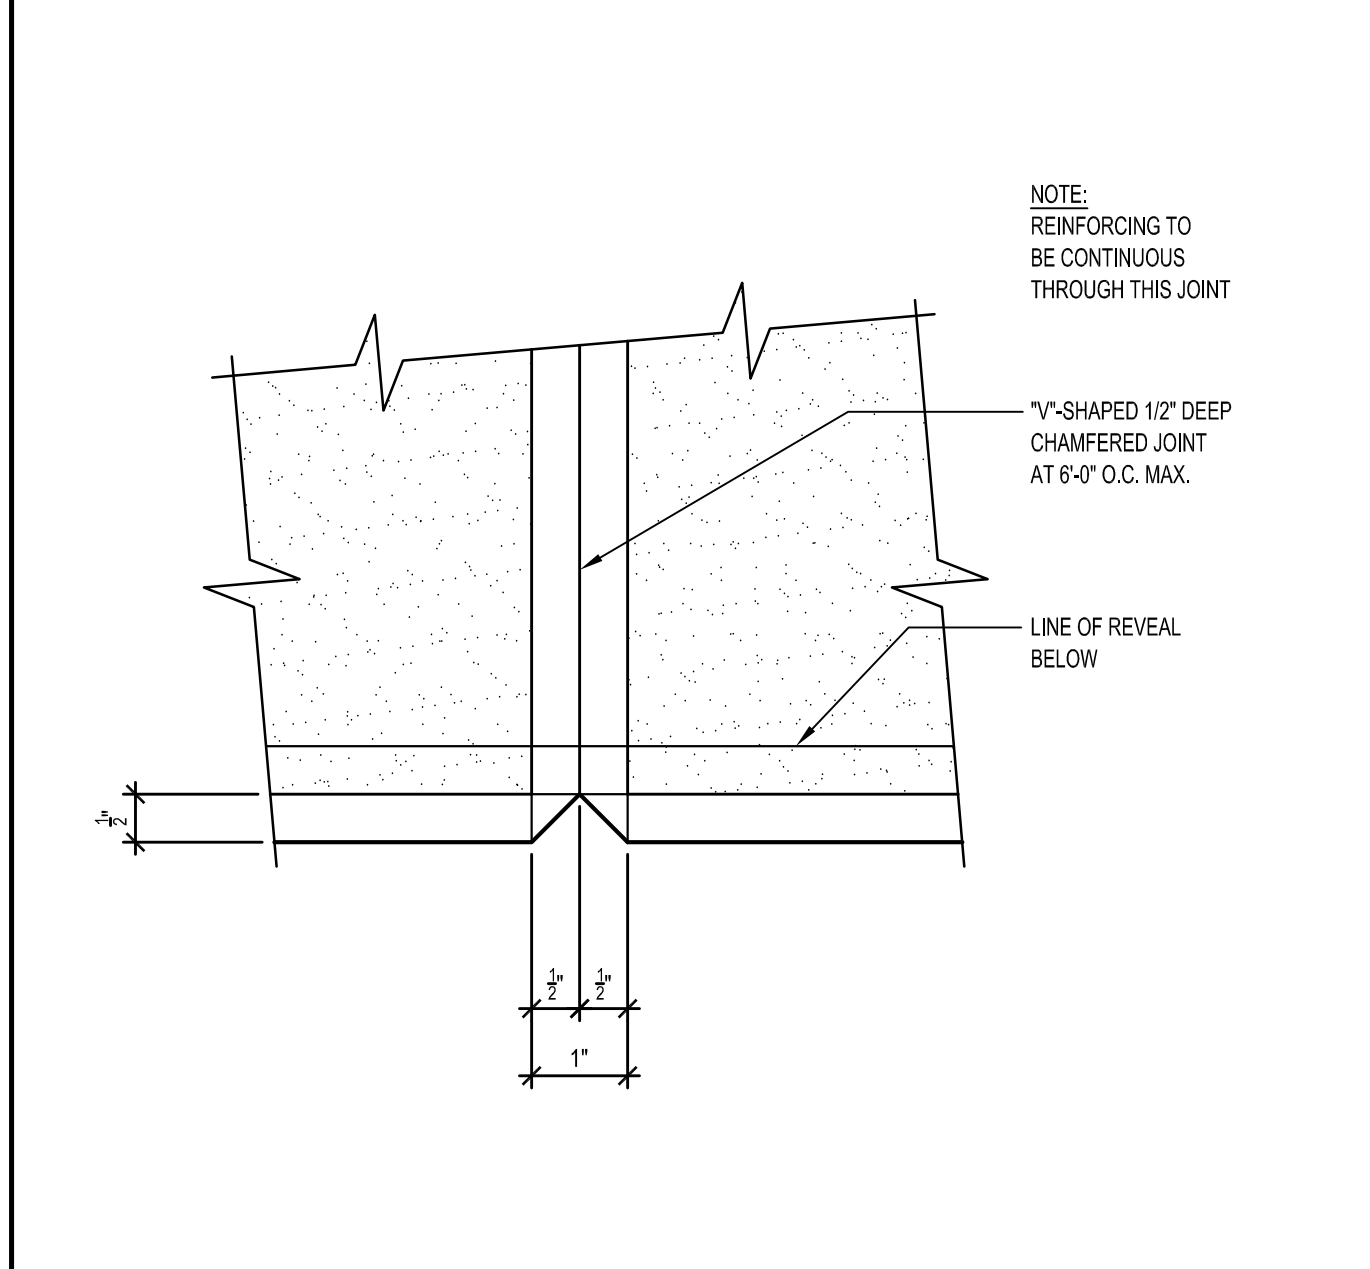


WALL JOINT - PLAN VIEW
SCALE: HALF

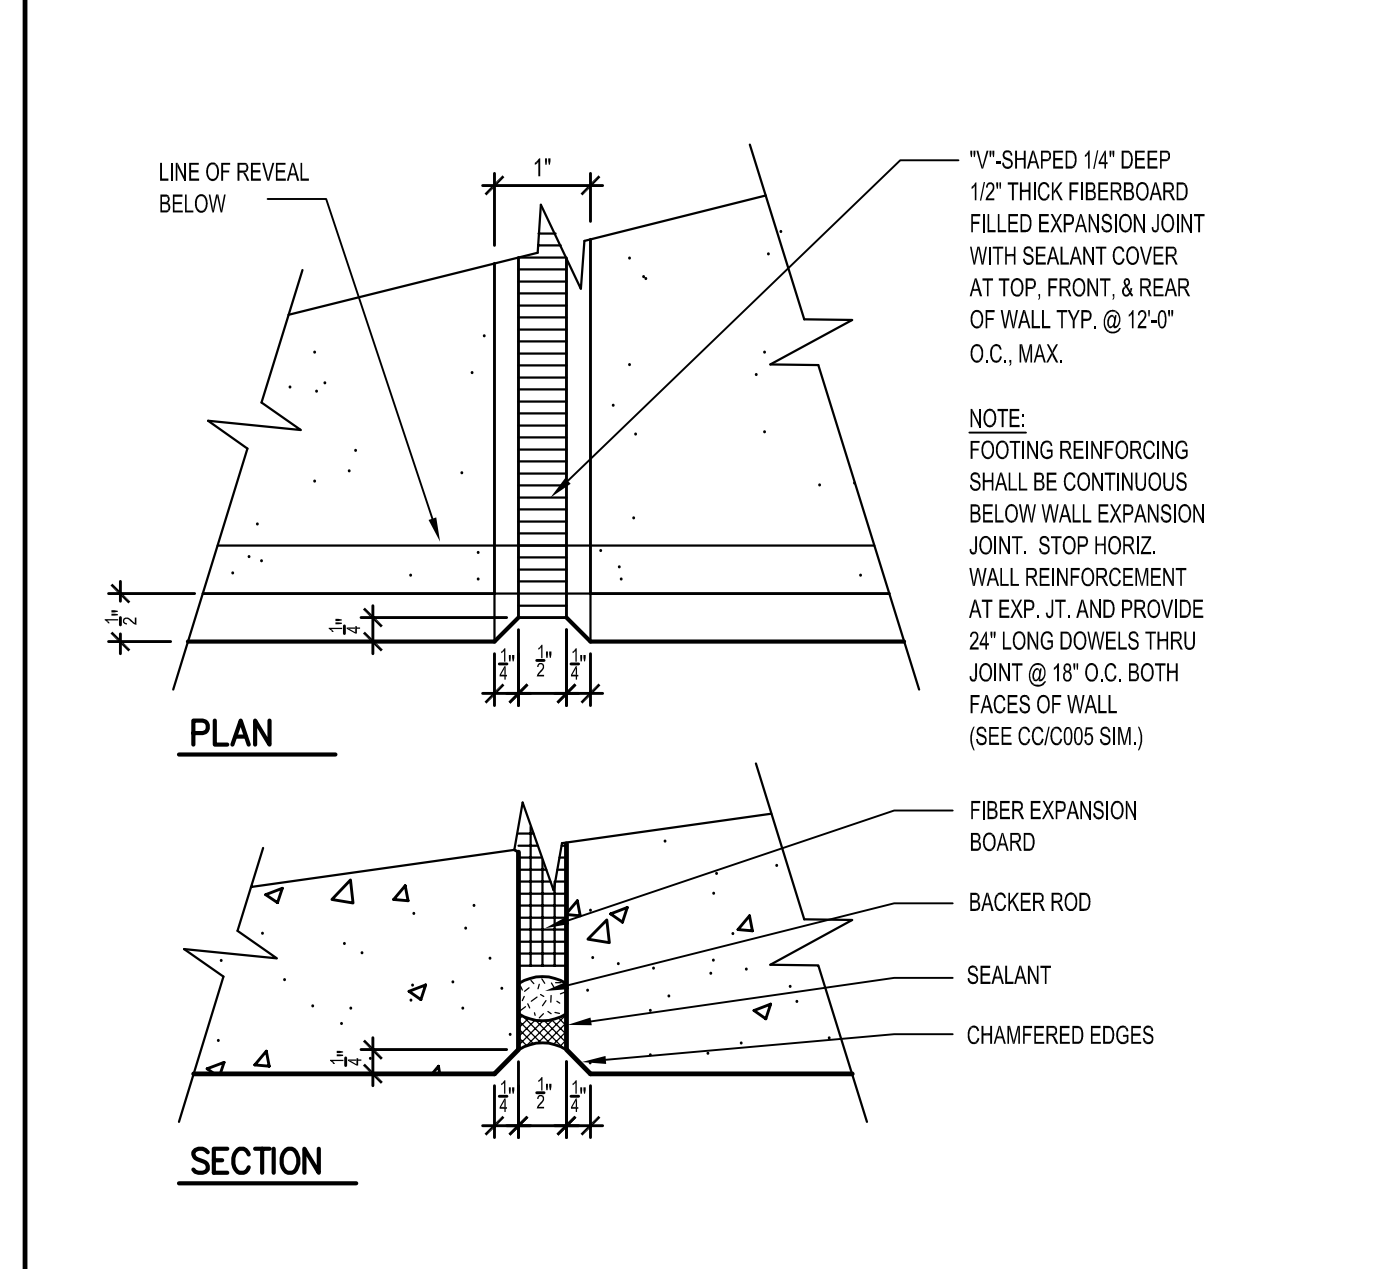

WALL EXPANSION JOINT
SCALE: HALF

- KEYNOTES**
- | | |
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| <p>1 DECOMPOSED GRANITE SURFACE - SEE DETAIL DL2.01</p> <p>2 6'-4" CONCRETE SEATWALL - SEE DETAIL CL2.01</p> <p>3 (E) CONCRETE RAMP TO REMAIN - PROTECT IN PLACE</p> <p>4 DRINKING FOUNTAIN - SEE DETAIL 19/2.00</p> <p>5 6'-4" HIGH CHAIN LINK FENCE - SEE DETAIL 102.00</p> <p>6 (E) CLEAN OUT - PROTECT IN PLACE</p> <p>7 7'-4" CONCRETE SEATWALL - SEE DETAIL CL2.01</p> <p>8 (E) CHAIN LINK FENCE TO REMAIN - PROTECT IN PLACE</p> <p>9 (E) STAIR TO REMAIN - PROTECT IN PLACE</p> <p>10 VENT - SEE SHEET S1.0</p> <p>11 ACCESS VENT - SEE SHEET S1.0</p> <p>12 MODULAR BUILDING COLUMN - SEE SHEET S1.0</p> <p>13 CONCRETE PAVING - SEE DETAIL 1/CO05</p> <p>14 PLACE LARGE ROCKS PER SCHOOLS DIRECTION AND HAUL OFF REMAINING LARGE ROCKS</p> <p>15 (E) DIRECTIONAL ACCESSIBLE ROUTE SIGNAGE AW03-121306 - PROTECT IN PLACE</p> <p>16 LANDSCAPE AREA - SEE SHEET L1.01 & L2.01</p> <p>17 AC PAVING - SEE DETAIL 2A/C002</p> <p>18 HEAVY DUTY AC PAVING FOR FIRE LANE - SEE DETAIL 2B/C002</p> <p>19 (E) AC PAVING - PROTECT IN PLACE - PATCH AND REPAIR AS REQUIRED</p> | <p>20 (E) LIGHT FIXTURE - PROTECT IN PLACE</p> <p>21 CONCRETE SWALE - SEE SHEET CO02</p> <p>22 CATCH BASIN - SEE SHEET CO03</p> <p>23 MODULAR ELEVATOR - SEE PC DRAWINGS 03-118291</p> <p>24 STAIRS - SEE SHEET S11.0</p> <p>25 CONCRETE RAMP - SEE DETAIL 14/2.00</p> <p>26 HANDRAILS - SEE DETAIL 18/2.00, ATTACH TO EXISTING HANDRAILS</p> <p>27 GAS PRESSURE REGULATOR - SEE SHEET P1-1</p> <p>28 FIRE RISER - SEE SHEET FS-2</p> <p>29 ELECTRICAL PULL BOX - SEE SHEET ES-2</p> <p>30 DISTRIBUTION SWITCHBOARD - SEE SHEET ES-2</p> <p>31 18" WIDE CONCRETE SEAT WALL - SEE DETAIL 16/1.00</p> <p>32 8" THK CONCRETE RETAINING WALL - SEE DETAIL 16/11.00</p> <p>33 4'-0" WIDE CHAIN LINK GATE DETAIL - SEE DETAIL 5/11.00</p> <p>34 CONCRETE CONTROL JOINT - SEE DETAIL BB/CO05</p> <p>35 LIGHT FIXTURE - SEE ELECTRICAL DRAWINGS</p> <p>36 (E) CONCRETE RAMP HANDRAILS TO REMAIN - PROTECT IN PLACE</p> <p>37 RELOCATED MILM - G.C. TO MOVE MILM TO THIS LOCATION AFTER CONCRETE WALK IS INSTALLED AND CONNECT POWER PER ELECTRICAL DWGS.</p> |
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**MONTE VISTA ELEMENTARY SCHOOL
2-STORY MODULAR CLASSROOM BUILDING**

GLENDALE UNIFIED SCHOOL DISTRICT
2620 ORANGE AVENUE
LA CRESCENTA, CALIFORNIA 91214

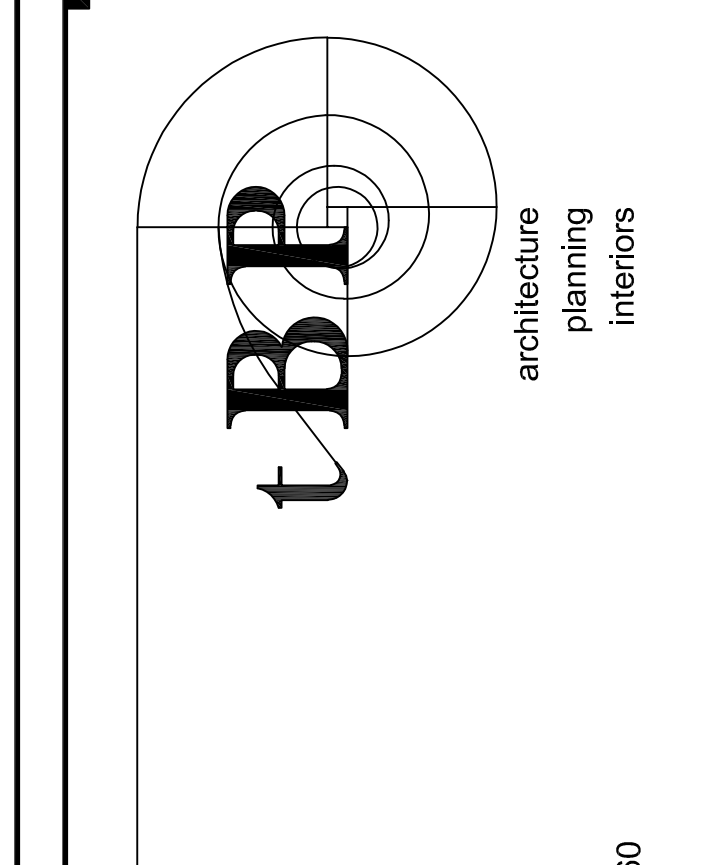
owner

tBP project number : 21056.01
file name:
drawn by: checked by:
date: SEPTEMBER 22, 2021
Rev: date: description:
10-18-2021 ADDENDUM NO. 2


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drawing title:
**MODULAR BUILDING
SITE PLAN**

drawing no.:
AS-3
drawing of

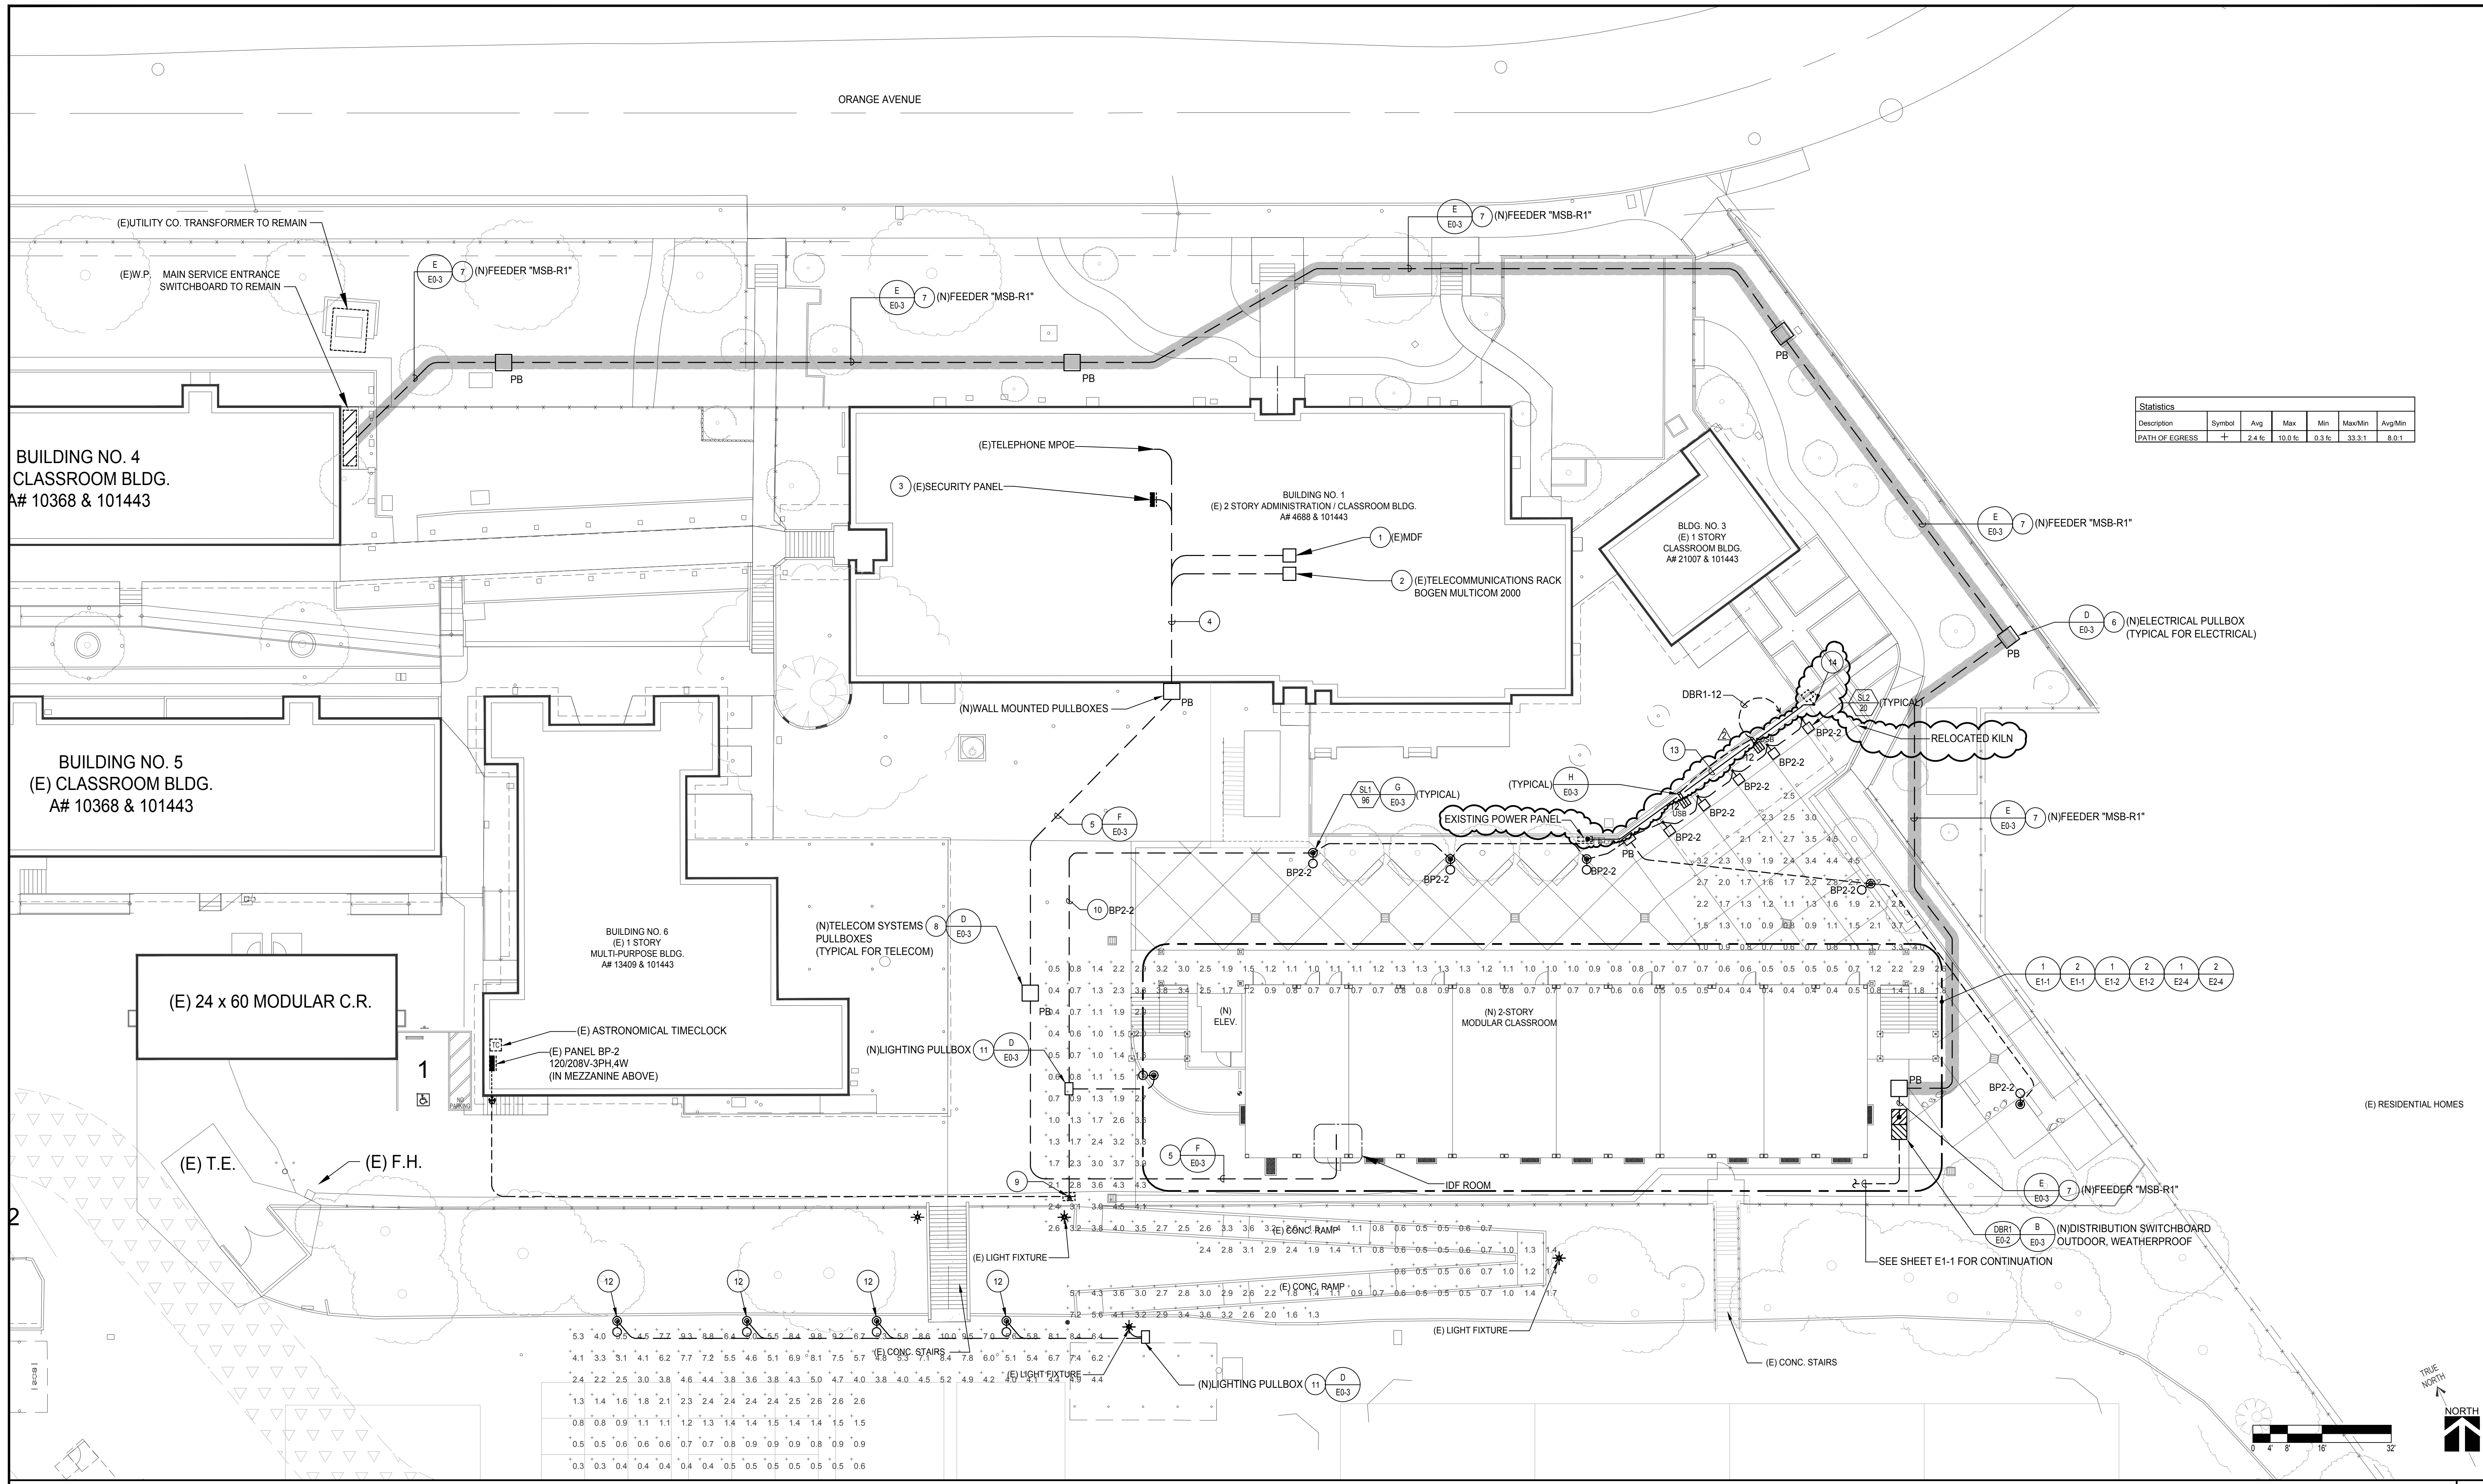

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MONTE VISTA ELEMENTARY SCHOOL
2-STORY MODULAR CLASSROOM BUILDING
GLENDALE UNIFIED SCHOOL DISTRICT
2620 ORANGE AVENUE
LA CRESCENTA - MONTEROSE, CALIFORNIA 91214

tBP project number : 21666.00
file name:
drawn by: checked by:
date: DECEMBER 28, 2020
Rev. date: description:
10-18-2021 ADDENDUM 2

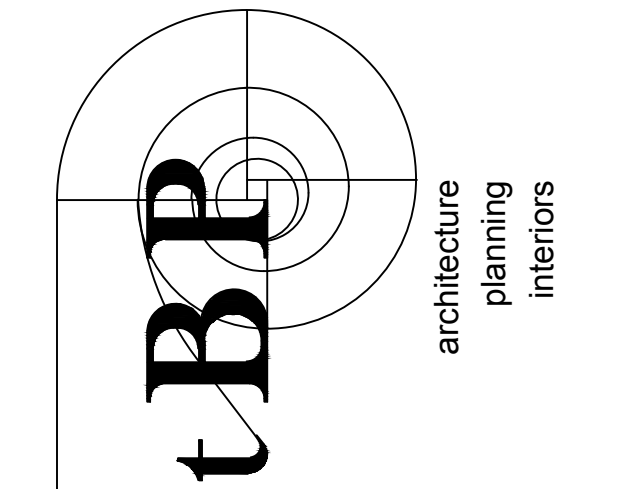drawing title:
ENLARGED SITE ELECTRICAL PLAN
drawing no.:
ES-2
drawing of