



Addendum No. 2

April 24, 2018

Play Area Improvements at Verdugo Woodlands, R.D. White, Muir, and Balboa Elementary Schools

Bid Number 170-17/18


This addendum supercedes, supplements and has precedence over all portions of the bidding documents with which it differs. Acknowledge receipt of this Addendum in the space provided on Bid Form, paragraph 9. Failure to do so may subject the Bidder to disqualification.

Changes to Scope of Work:

Add ball wall at Lincoln Elementary School per attached details and drawing.

End of Addendum No. 2

HAND BALL COURT
4" W WHITE PAINT
STRIPPING, TYP.

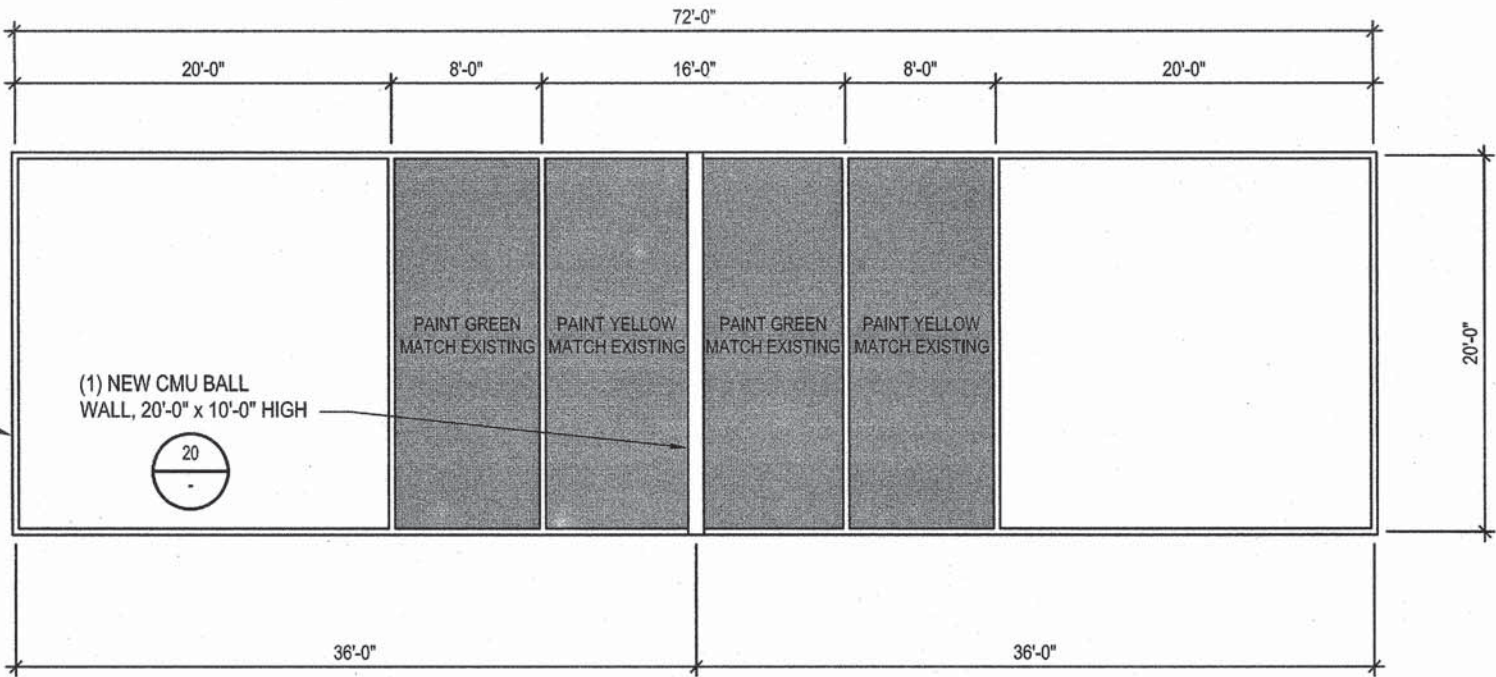

BALL WALL COURT

SCALE: 1/8" = 1'-0"



Balboa Elementary School
1844 Bel Aire Drive, Glendale, CA 91201

DESIGNER



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CONSULTANTS

CIVIL ENGINEER
BRENN ENGINEERING
STRUCTURAL ENGINEER
KPFF CONSULTING ENGINEERS
MECHANICAL / PLUMBING / ELECTRICAL ENGINEER
BRENN ENGINEERING
FIRE PROTECTION ENGINEER
BRENN ENGINEERING

DOOR HARDWARE CONSULTANT
ARCHITECTURAL HARDWARE SERVICES

REGISTRATION



AGENCY APPROVAL

IDENTIFICATION STAMP
DIVISION OF STATE ARCHITECT
OFFICE OF REGULATION SERVICES
FILE NO. 19-41
APPL. NO. 03-116363
AC _____ PLS _____ SS _____
DATE _____

ISSUE

03-21-17 CCDA-005

MARK DATE DESCRIPTION

DESIGNER PROJECT NO: A11047.05

DRAWN BY: Author

CHECKED BY: Checker

SCALE: As indicated


KEY PLAN

SHEET TITLE

SITE PLAN

SHEET NUMBER

A1.11

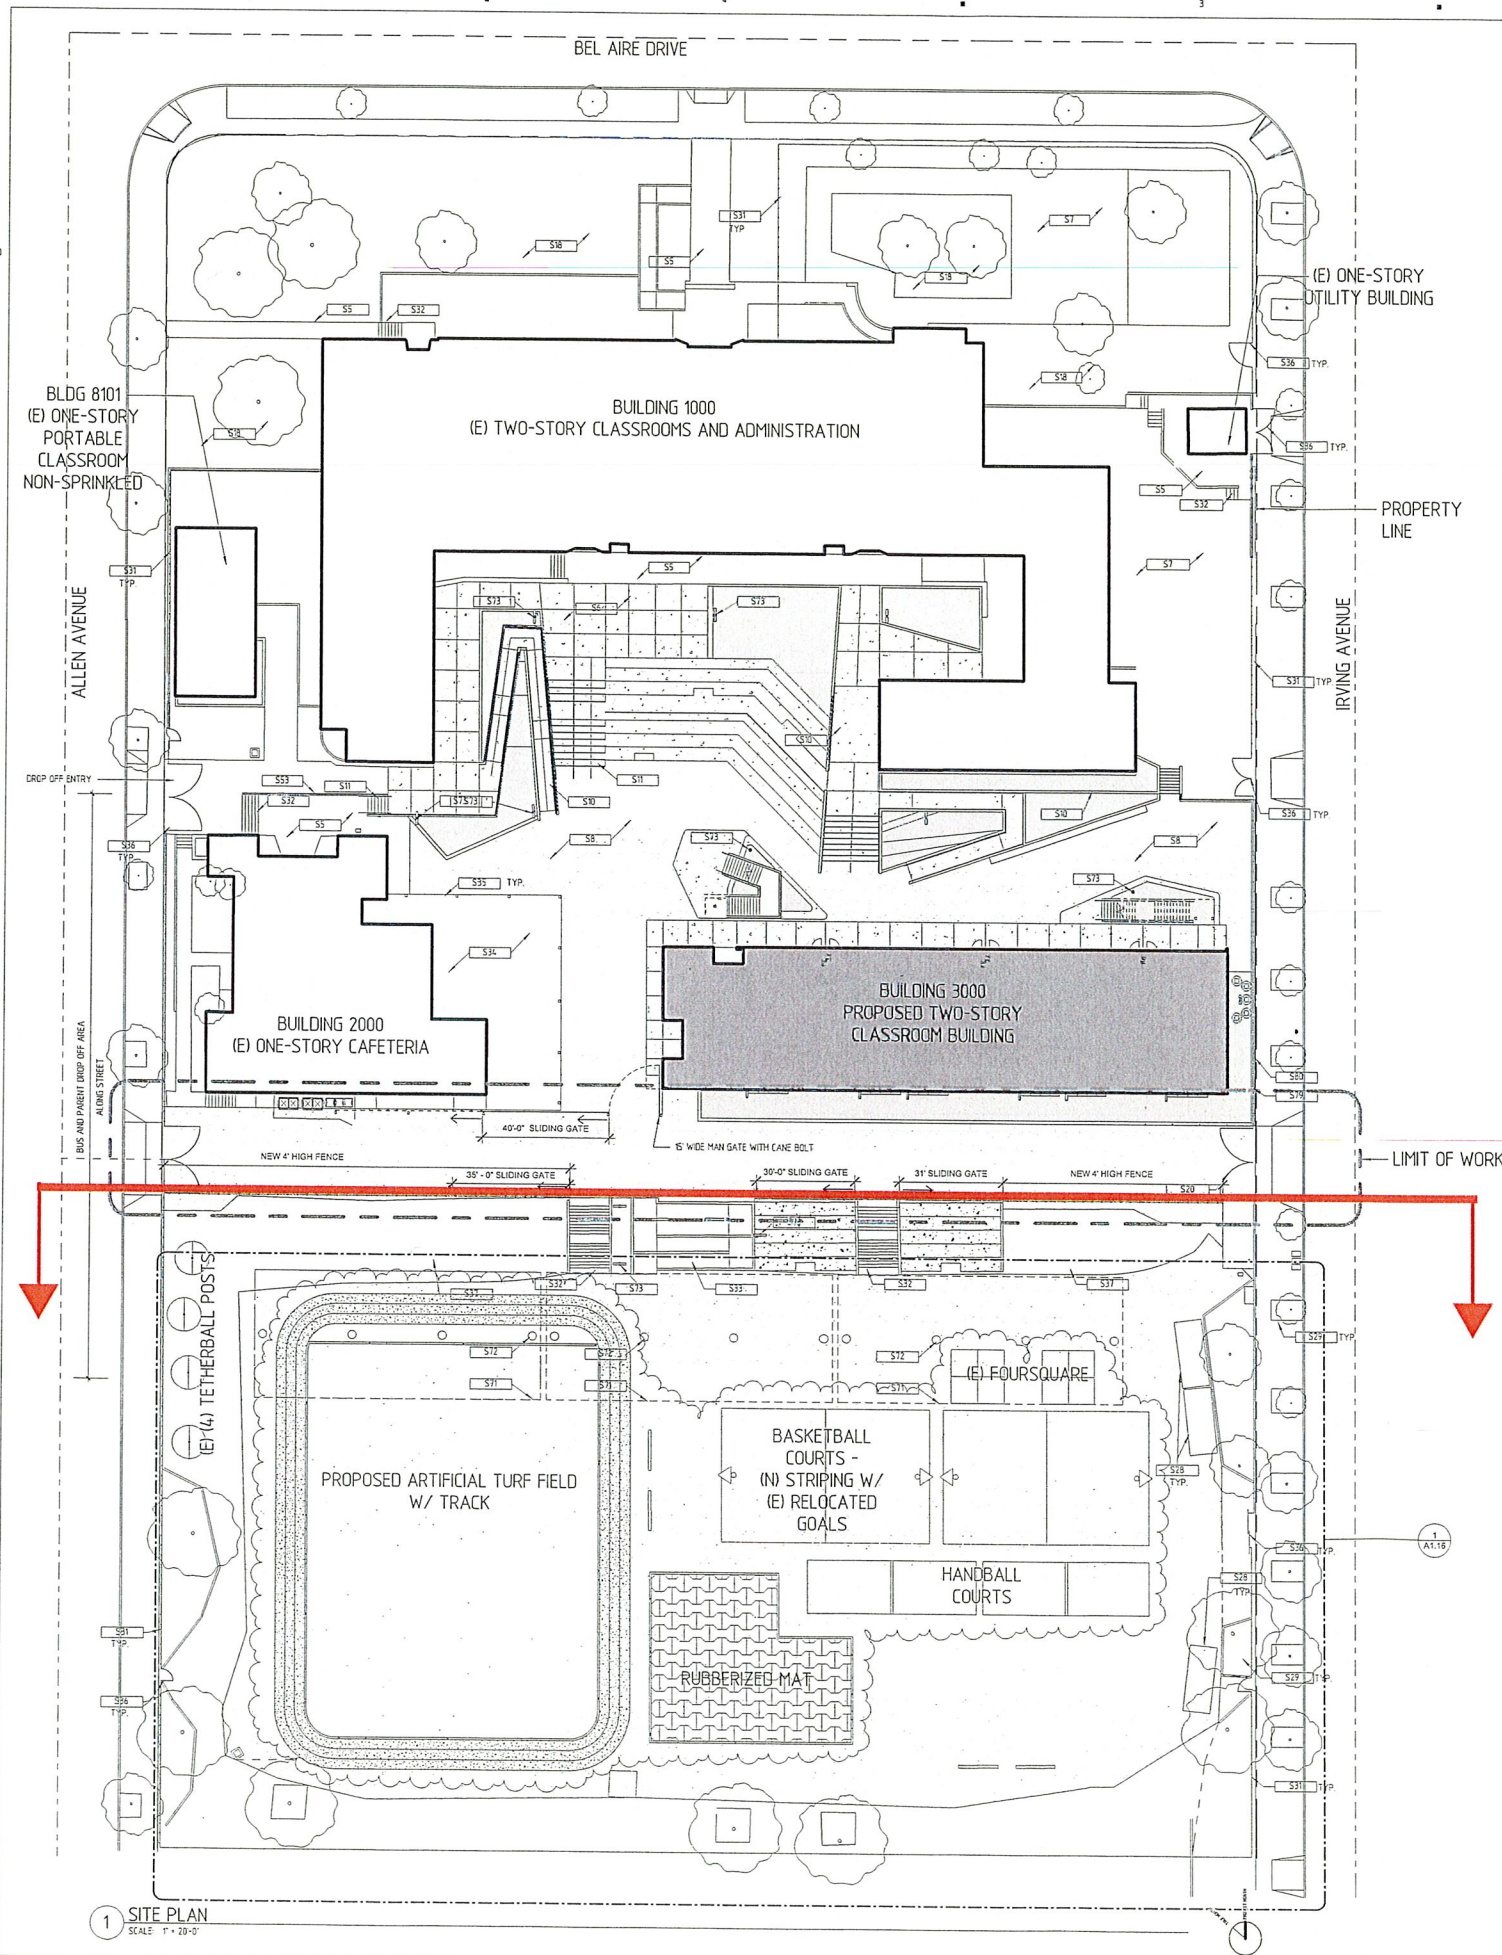

LEGEND

- EXISTING BUILDING
- NEW BUILDING
- CONCRETE PAVING
- EXISTING A/C PAVING
- A/C PAVING
- PLANTING AREA
- ARTIFICIAL TURF
- ATHLETIC SURFACE COATING
- RUBBERIZED TILE SURFACING
- LIMIT OF WORK

KEYNOTE

KEY	TEXT	KEY	TEXT
S5	(E) CONCRETE PAVING	S36	(E) GATE
S6	CONCRETE PAVING	S37	(E) ASPHALT BEEM
S7	(E) ASPHALT PAVING	S38	(E) GUARDRAIL
S8	ASPHALT PAVING	S39	(E) PV CANOPY
S10	CONCRETE RAMP	S72	(E) STEEL COLUMN/CONCRETE BASE
S11	CONCRETE STAIRS SEE 1/S500	S73	(E) POLE-MOUNTED SITE LIGHT, SEE S/A121 AND E-10
S18	(E) PLANTING AREA	S79	CHAINLINK FENCE
S20	(E) 20'-0" WIDE SWINGING GATE, DETAIL 2/A121	S80	CONCRETE RETAINING WALL SEE WALL TYPE RL 4/S500
S28	(E) STORAGE CONTAINER		
S29			
S31	(E) CHAIN LINK FENCE		
S32	(E) CONCRETE STAIRS		
S33	(E) CONCRETE RAMP		
S34	(E) LUNCH SHELTER		
S35	(E) COLUMN		

1 SITE PLAN
SCALE: 1" = 20'-0"



Balboa Elementary School
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OFFICE OF REGULATION SERVICES
FILE NO. 18-41
APPL NO. 03-11-13-3
AC FL SS
DATE

ISSUE

MARK	DATE	DESCRIPTION
03-31-17	CCDA-035	

DESIGNER PROJECT NO.: A11047.05
DRAWN BY: Author
CHECKED BY: Checker
SCALE: As indicated


KEY PLAN

SHEET TITLE

PARTIAL SITE PLAN @ FIELD

SHEET NUMBER

A1.16

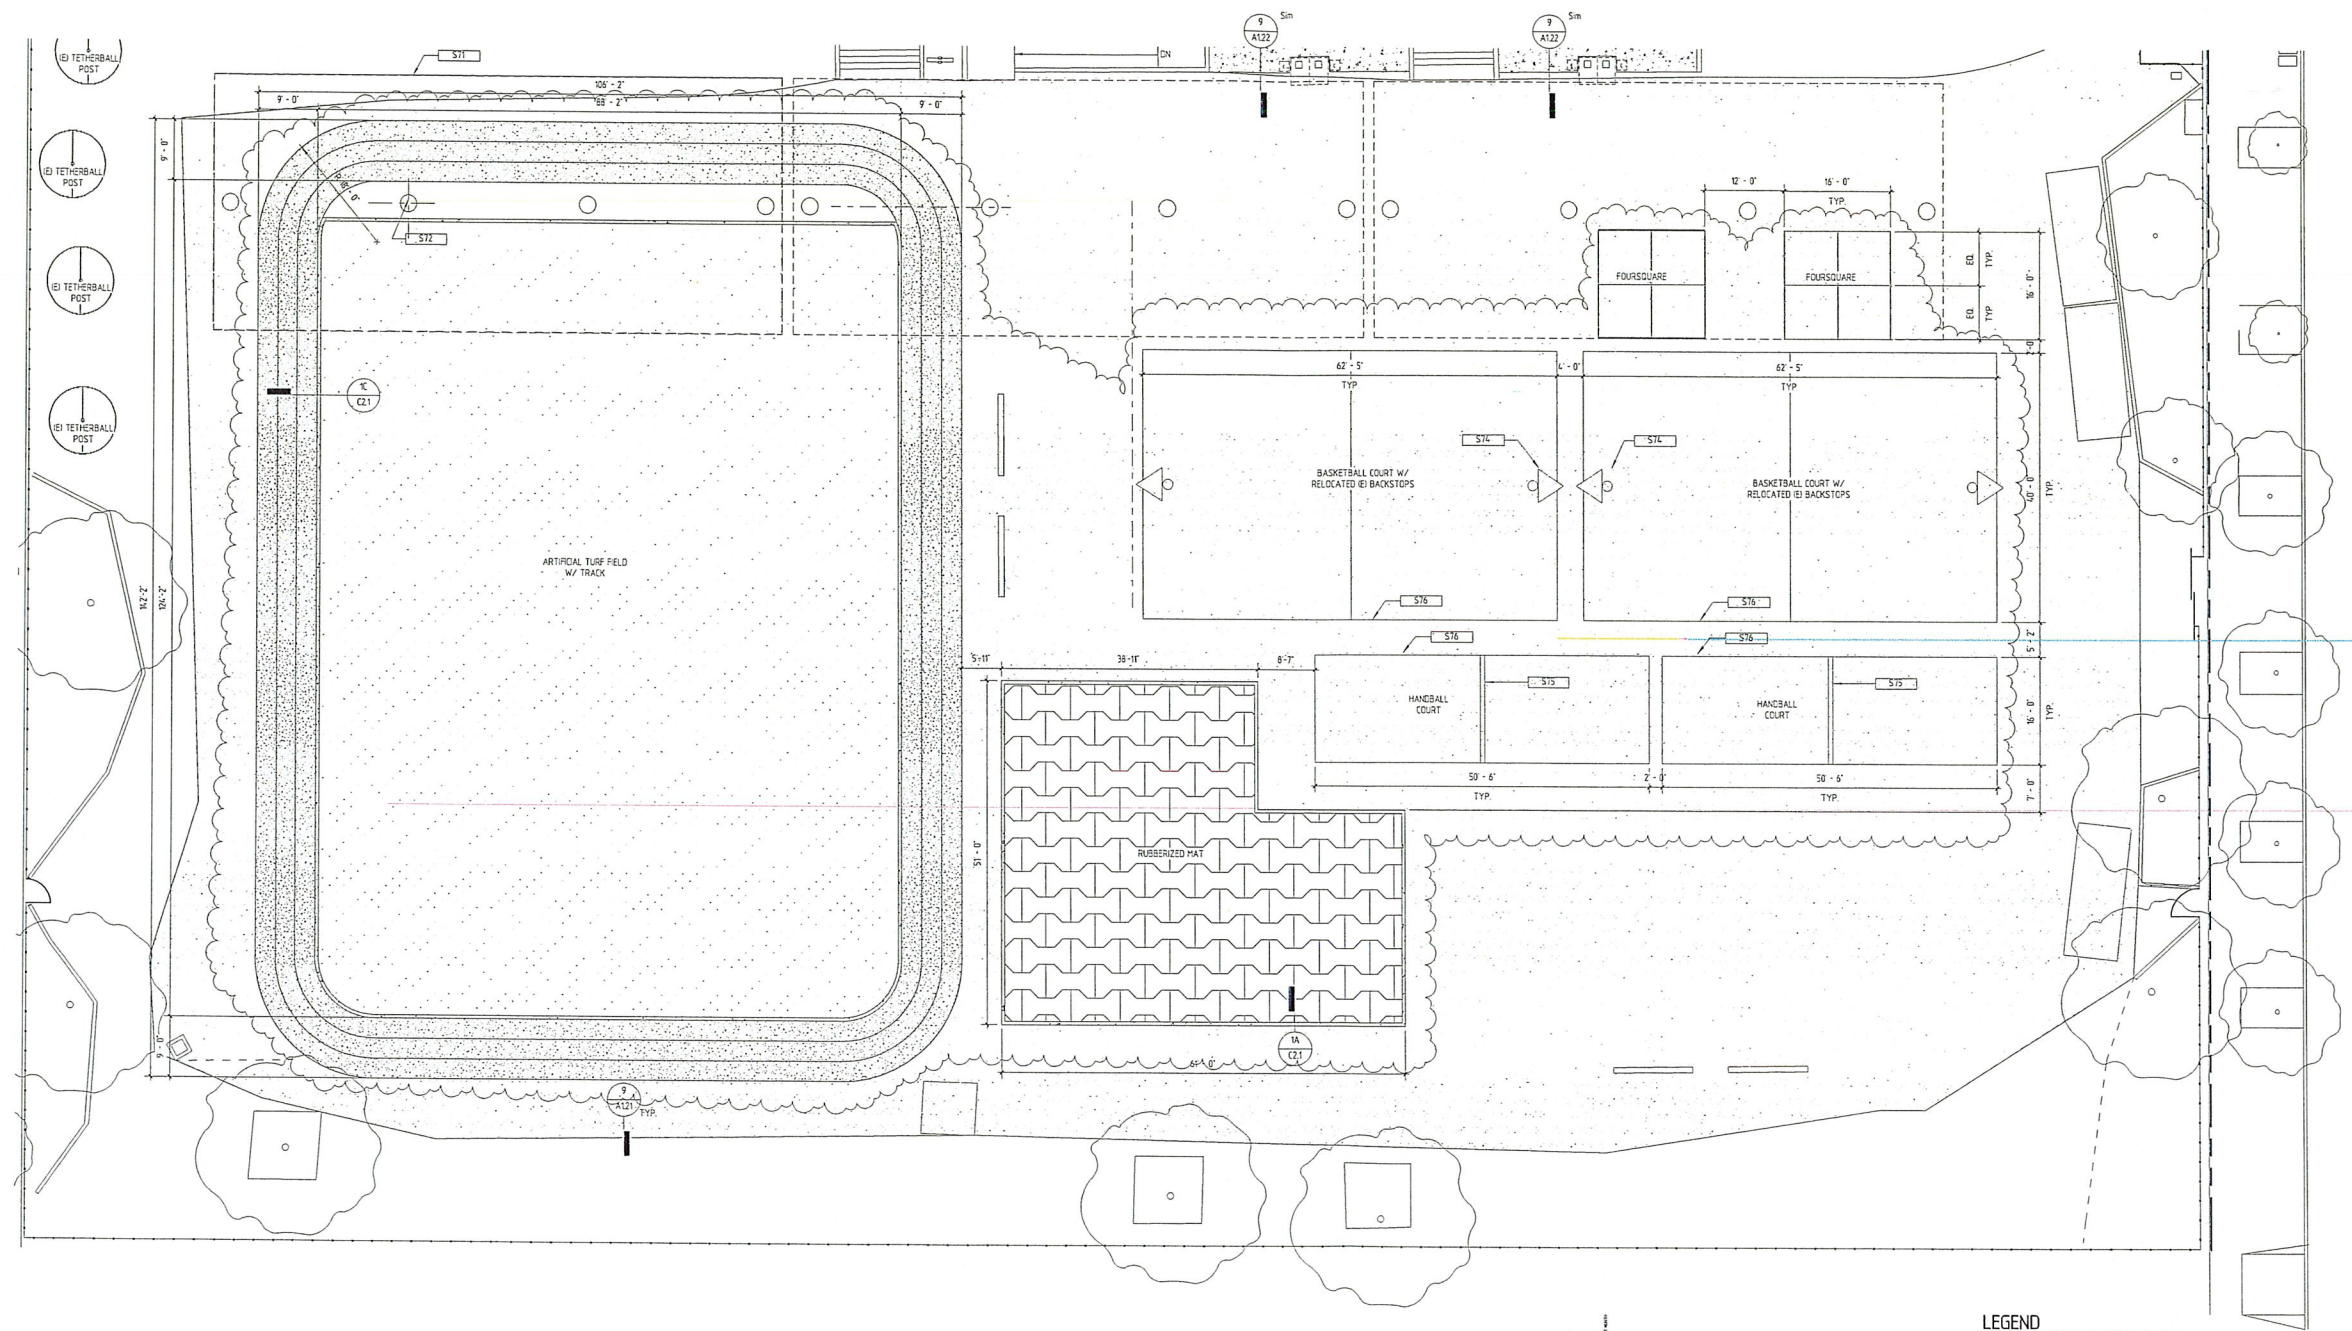

1 ENLARGED SITE PLAN @ FIELD
SCALE: 1" = 10'-0"

KEYNOTES

KEY	TEXT
S11	(E) PV CANOPY
S12	(E) STEEL COLUMN/CONCRETE BASE
S14	RELOCATED (E) BASKETBALL BACKSTOP & GOAL (SEE 6/A121 FOR FOUNDATION DETAIL)
S15	HANDBALL COURT WALL. SEE 7/A121
S16	PAVEMENT STRIPING

LEGEND

- EXISTING BUILDING
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- EXISTING A/C PAVING
- A/C PAVING
- PLANTING AREA
- ARTIFICIAL TURF
- ATHLETIC SURFACE COATING
- RUBBERIZED TILE SURFACES
- LIMIT OF WORK



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IDENTIFICATION STAMP
DIVISION OF STATE ARCHITECT
OFFICE OF REGULATION SERVICES
FILE NO. 19-41
APPL. NO. 09-14363
AC FL 55
DATE

ISSUE

03-31-17 CCD-035

MARK DATE DESCRIPTION

DESIGNER PROJECT NO: A11047.05

DRAWN BY: Author

CHECKED BY: Checker

SCALE: As indicated

KEY PLAN

SHEET TITLE

ACCESSIBILITY SITE PLAN

SHEET NUMBER

A0.30


BLDG 8101
(E) ONE-STORY
PORTABLE
CLASSROOM

POT
INDICATED
REMOVED
BUILDINGS NO
IN SCOPE
OF WORK

ALLEN AVENUE

IRVING AVENUE


BEL AIRE DRIVE

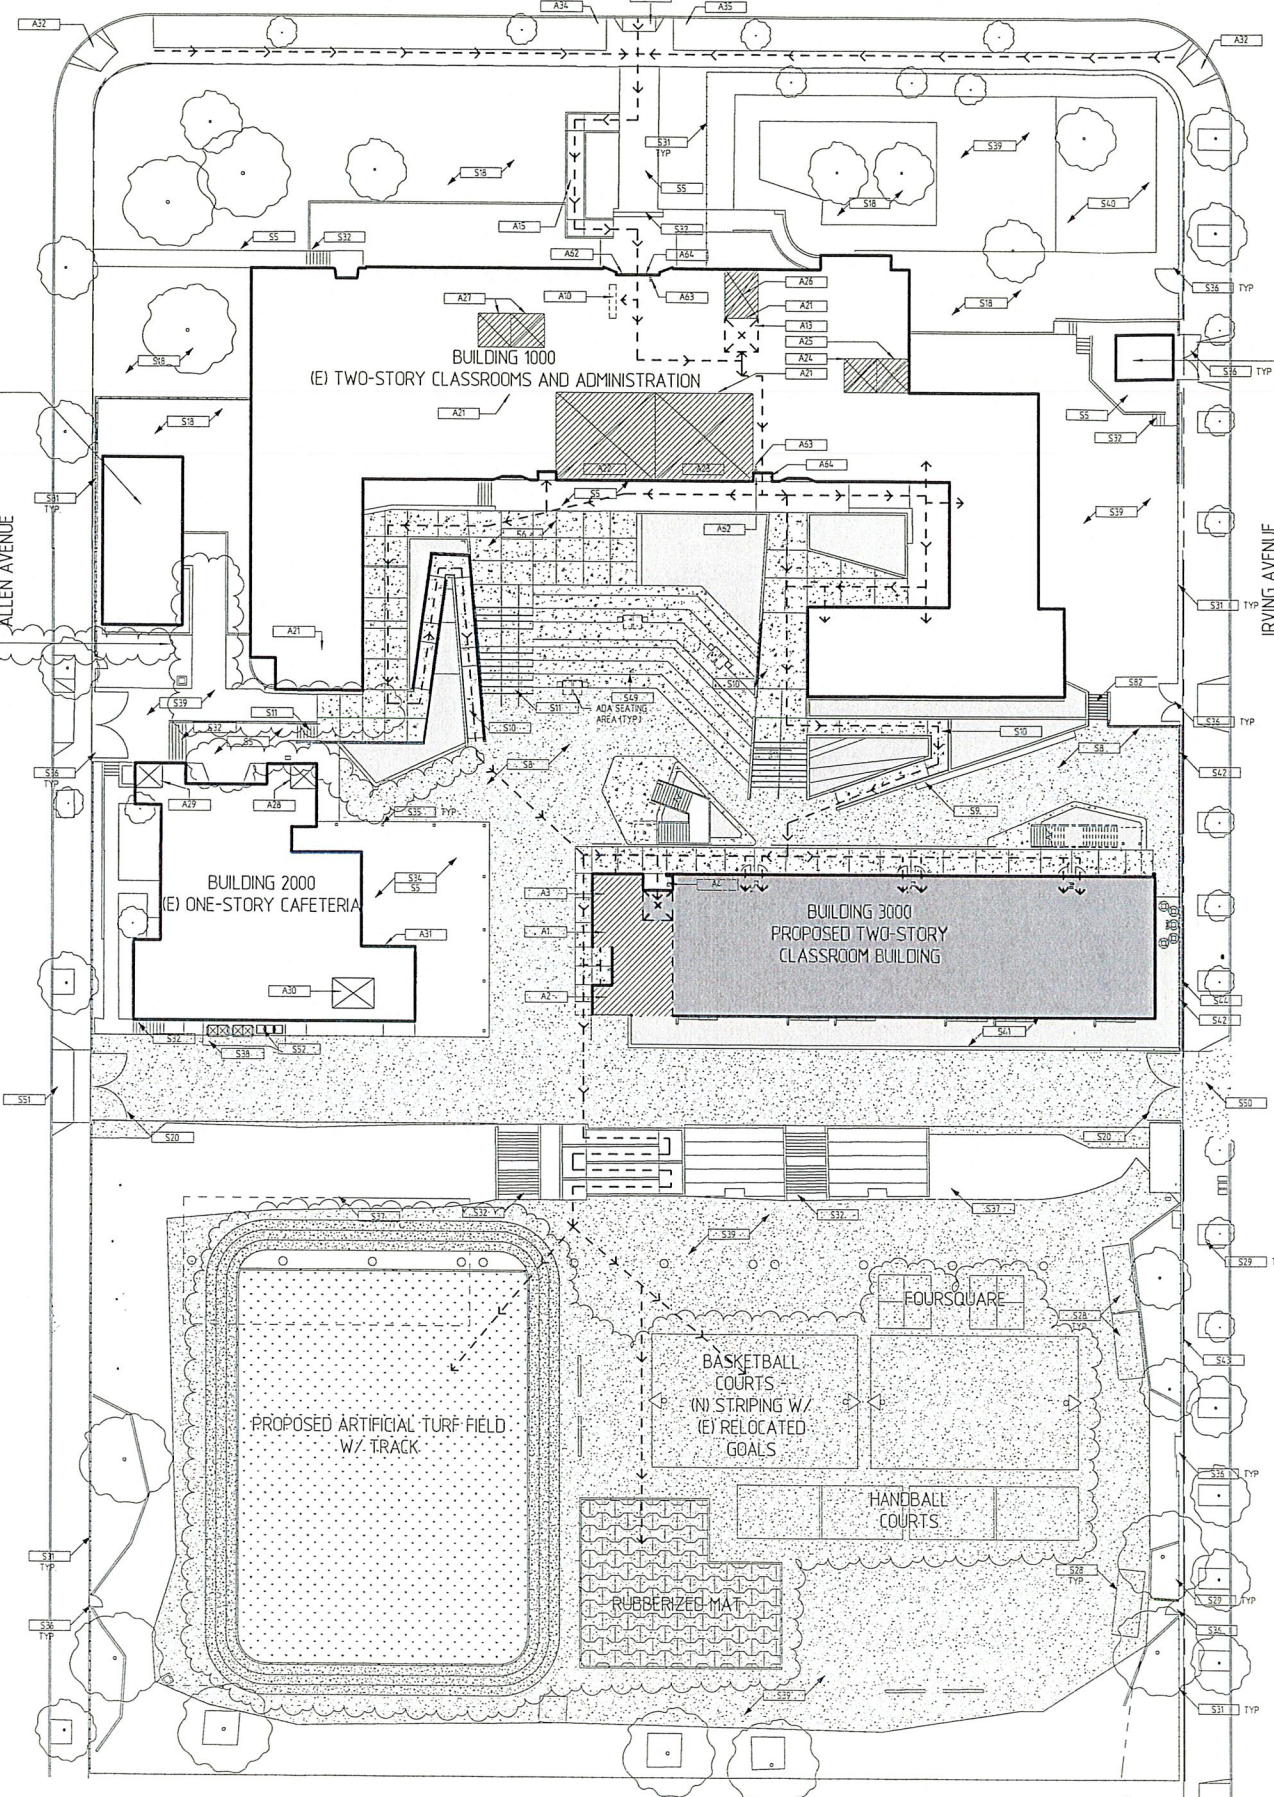

GENERAL NOTES:

- 1. Site walkways shall provide a barrier free path of travel for a person in a wheelchair. The path of travel shall be a hard, stable and slip resistant surface a minimum of 48 inches in width and with a maximum gradient slope of 5% and maximum cross-slope of 2% abrupt changes in level shall not exceed beveled slope of 1:2 with a 1/2" in vertical height and 1/4" maximum in vertical differential levels.
2. Path of travel (P.O.T.) as indicated, is a common barrier free access route without any abrupt vertical changes exceeding 1/2" beveled at 1:2 maximum slope, except that level changes do not exceed 1/4" vertical and is at least 48" wide. The path surface is slip resistant, stable, firm, and smooth. Passing spaces (1193B.7.1) at least 60" x 60" are located not more than 200' apart. Parts of P.O.T. with continuous gradients have 60' level areas (1193B.7.5) not more than 4000' apart. The cross-slope does not exceed 2% and slope in the direction of travel and is less than 5% unless otherwise indicated. P.O.T. shall be maintained free of overhanging obstructions to 60" minimum (1193B.8.2) and protruding objects greater than 4" projection from wall and above 27" and less than 80" (1193B.8.3)
3. Gates in Path of travel shall have lever hardware and kick plates
4. For all site gradients see CIVIL PLANS
5. For accessible signage locations see A201 FLOOR PLANS
6. See A020 for Safe Dispersal Area
7. For ramps and stairs see A112

ACCESSIBILITY LEGEND

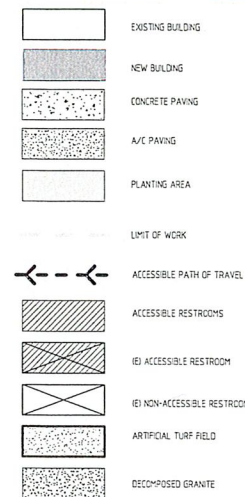

KEYNOTES

Table with 2 columns: KEY and TEXT. Lists annotations A1 through A64 and S1 through S32 with their corresponding descriptions.

1 ACCESSIBILITY SITE PLAN-CCD-B_010
SCALE: 1" = 20'-0"

3/7/2018 14:35 PM