

SCHEMATIC DESIGN DRAWINGS
FULLER MIDDLE SCHOOL
FRAMINGHAM, MA

	LIST OF DRAWINGS
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A001	COVER SHEET
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C-1.1	EXISTING CONDITIONS PLAN
C-1.2	EXISTING CONDITIONS PLAN
C-1.3	EXISTING CONDITIONS PLAN
C-2.0	OVERALL DEMOLITION PLAN
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C-2.2	PHASE 2 - DEMOLITION AND VEHICLE CIRCULATION
C-2.3	PHASE 3 DEMOLITION AND VEHICLE CIRCULATION
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PLUMBI	NG	
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P-1.02	SECOND FLOOR PLAN - PLUMBING	
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M-104	ROOF PLAN - HVAC
M-201	AHU AIRFLOLW DIAGRAM
M-202	CHW FLOW DIAGRAM
M-203	HHW FLOW DIAGRAM



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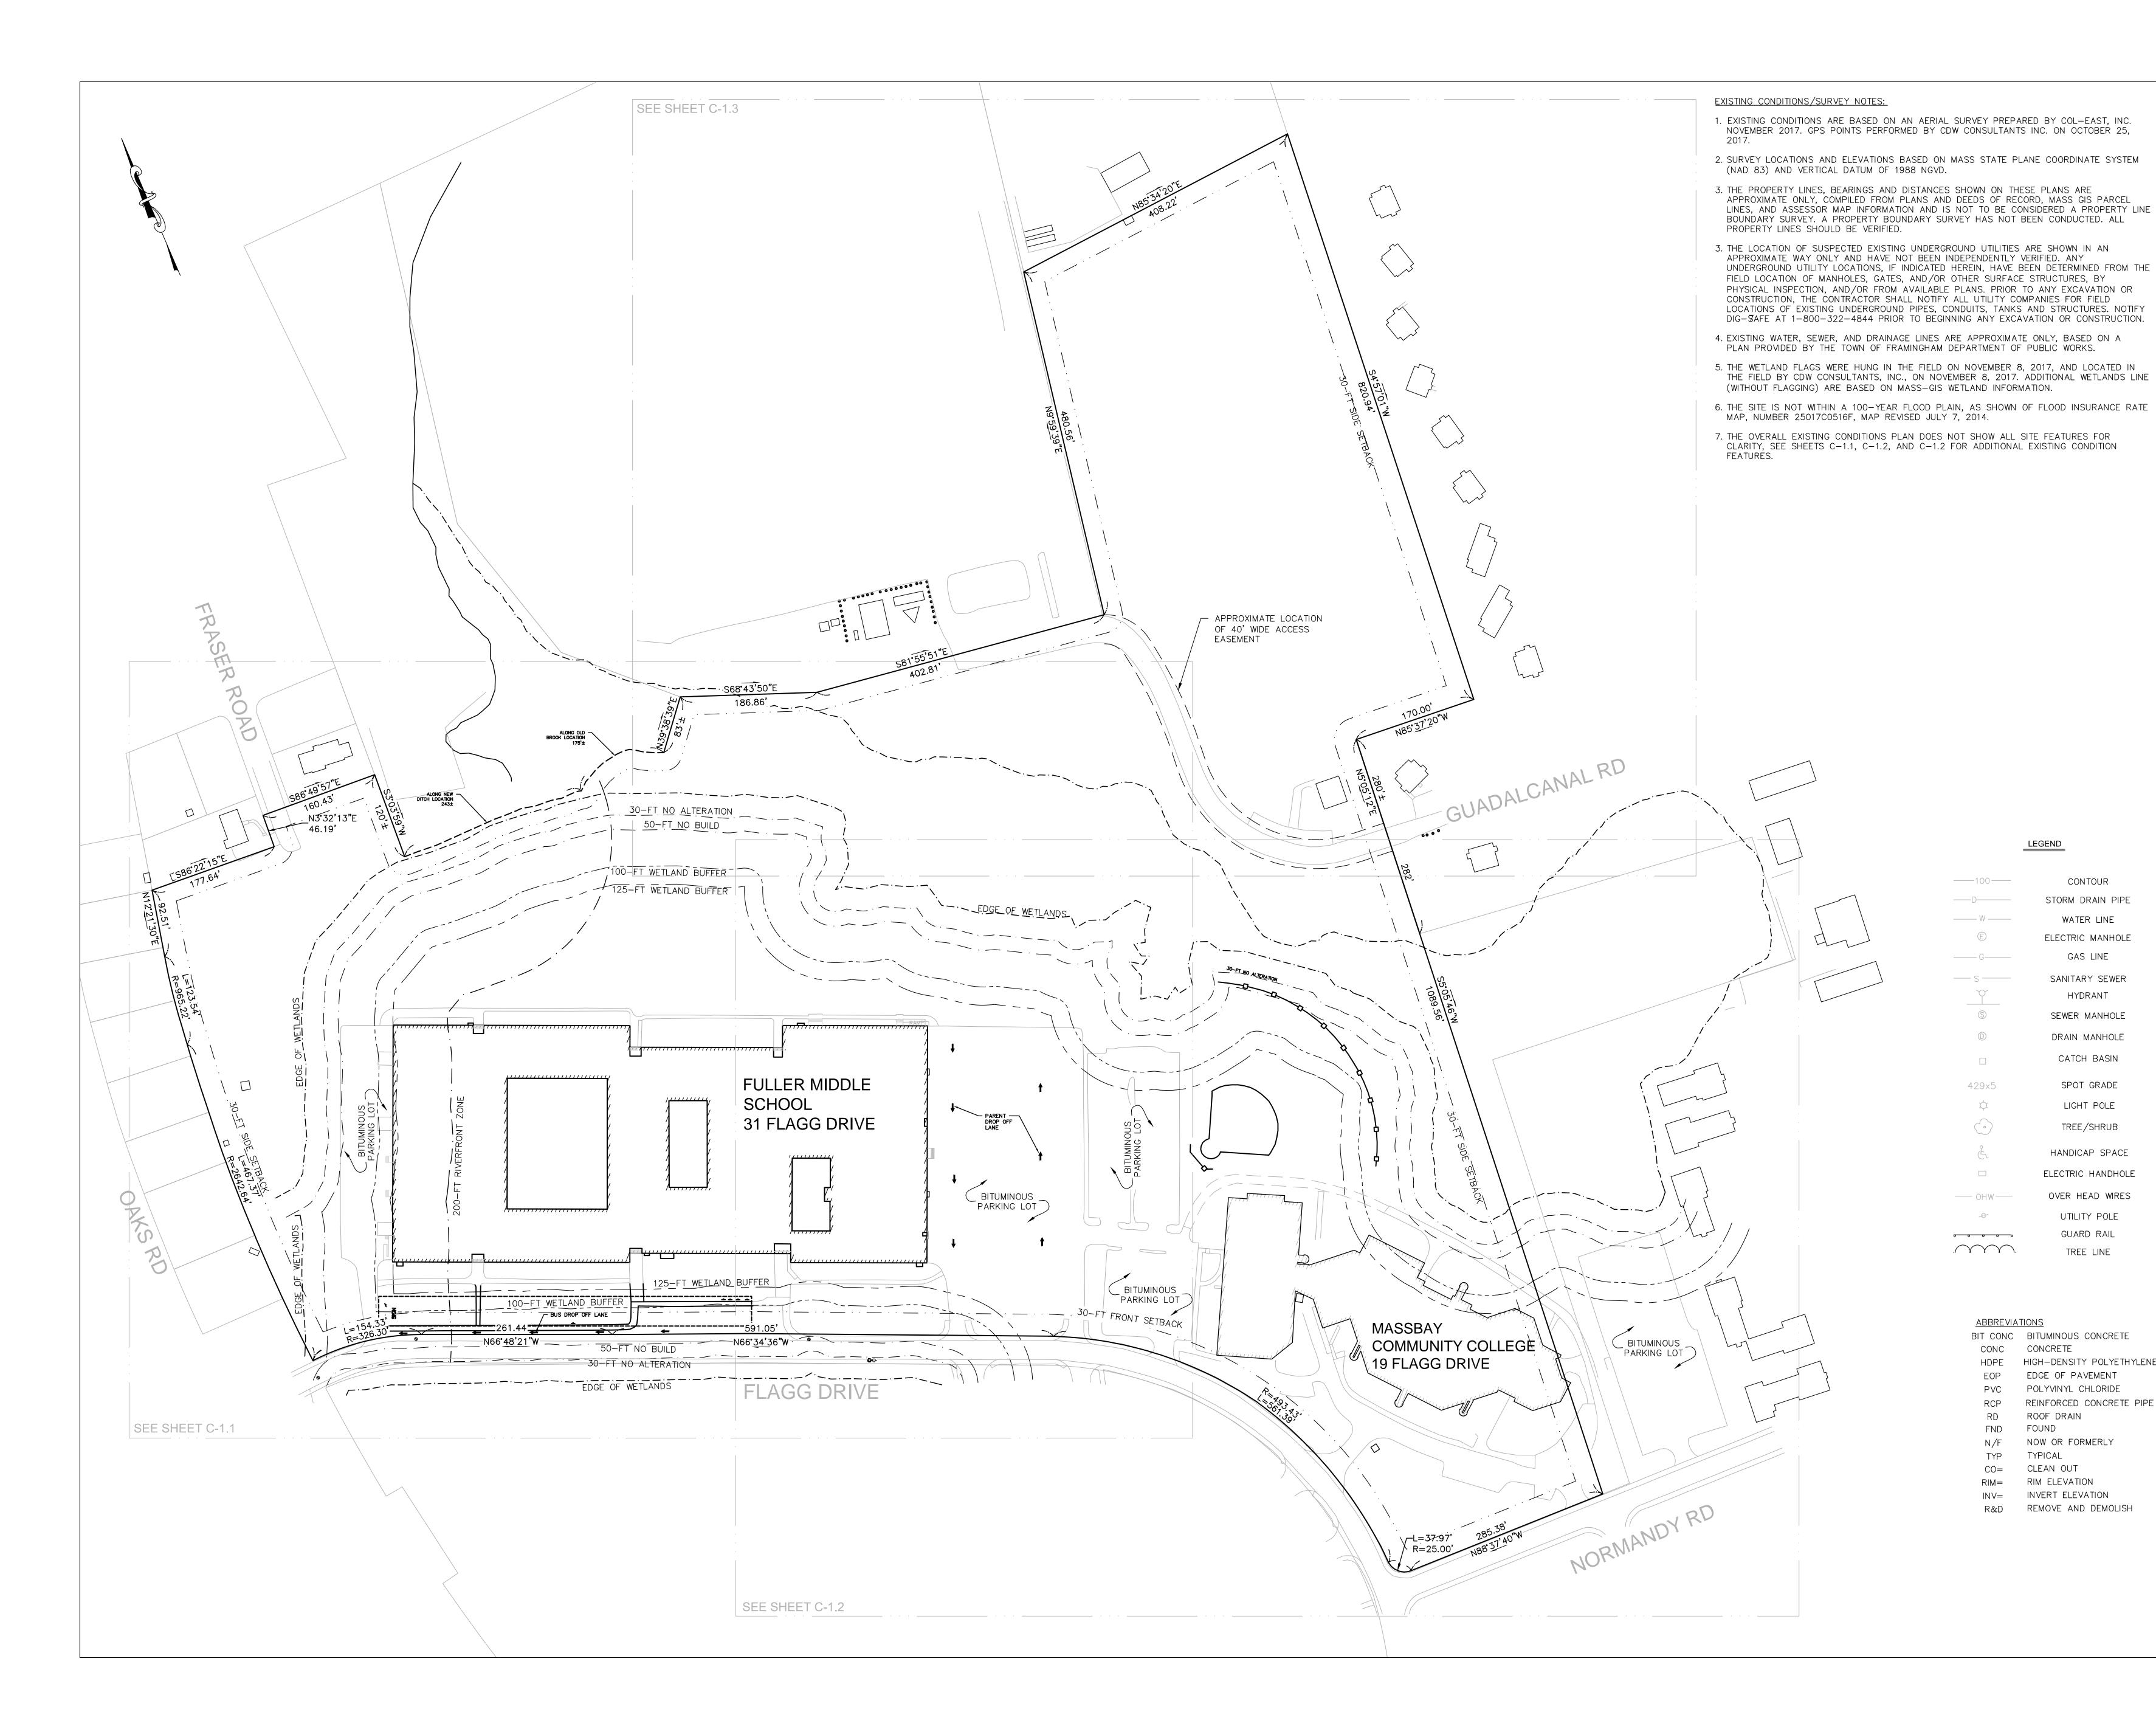
FULLER SCHOOL
31 FLAGG DRIVE, FRAMINGHAM, MA

SCHEMATIC DESIGN 09/12/18

REVISIONS				
No.	Date	Descrip		
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COVER SHEET

PROJECT NO. Project Nun



LEGEND

EXISTING

—— D —— STORM DRAIN

_____ **W** _____ WATER E ELECTRIC MANHOLE

——E — UNDERGROUND ELECTRICAL -----OHW--- OVERHEAD ELECTRICAL

---- S ---- SANITARY SEWER

Y HYDRANT

S SEWER MANHOLE

S DRAIN MANHOLE ☐— D —— CATCH BASIN

x 429.5 SPOT GRADE

🔅 LIGHT POLE

TREE / Y Y Y Y Y \ TREELINE -O- UTILITY POLE

Jonathan Levi Architects

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CDW CONSULTANTS, INC. 6 HURON DRIVE NATICK, MA 01760 TEL. (508) 875-2657 FAX. (508) 875-6617 www.cdwconsultants.com

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SCHEM

CONTOUR

STORM DRAIN PIPE

WATER LINE

ELECTRIC MANHOLE

GAS LINE

SANITARY SEWER

HYDRANT

SEWER MANHOLE

DRAIN MANHOLE

CATCH BASIN

SPOT GRADE

LIGHT POLE

TREE/SHRUB

HANDICAP SPACE

ELECTRIC HANDHOLE

OVER HEAD WIRES

UTILITY POLE

GUARD RAIL

TREE LINE

HIGH-DENSITY POLYETHYLENE

REINFORCED CONCRETE PIPE

EDGE OF PAVEMENT

POLYVINYL CHLORIDE

ROOF DRAIN

N/F NOW OR FORMERLY

RIM ELEVATION

INVERT ELEVATION

FOUND


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SCHEMATIC DESIGN PLANS

REVISIONS No. Date Description


DRAWING NAME OVERALL EXISTING CONDITIONS PLAN


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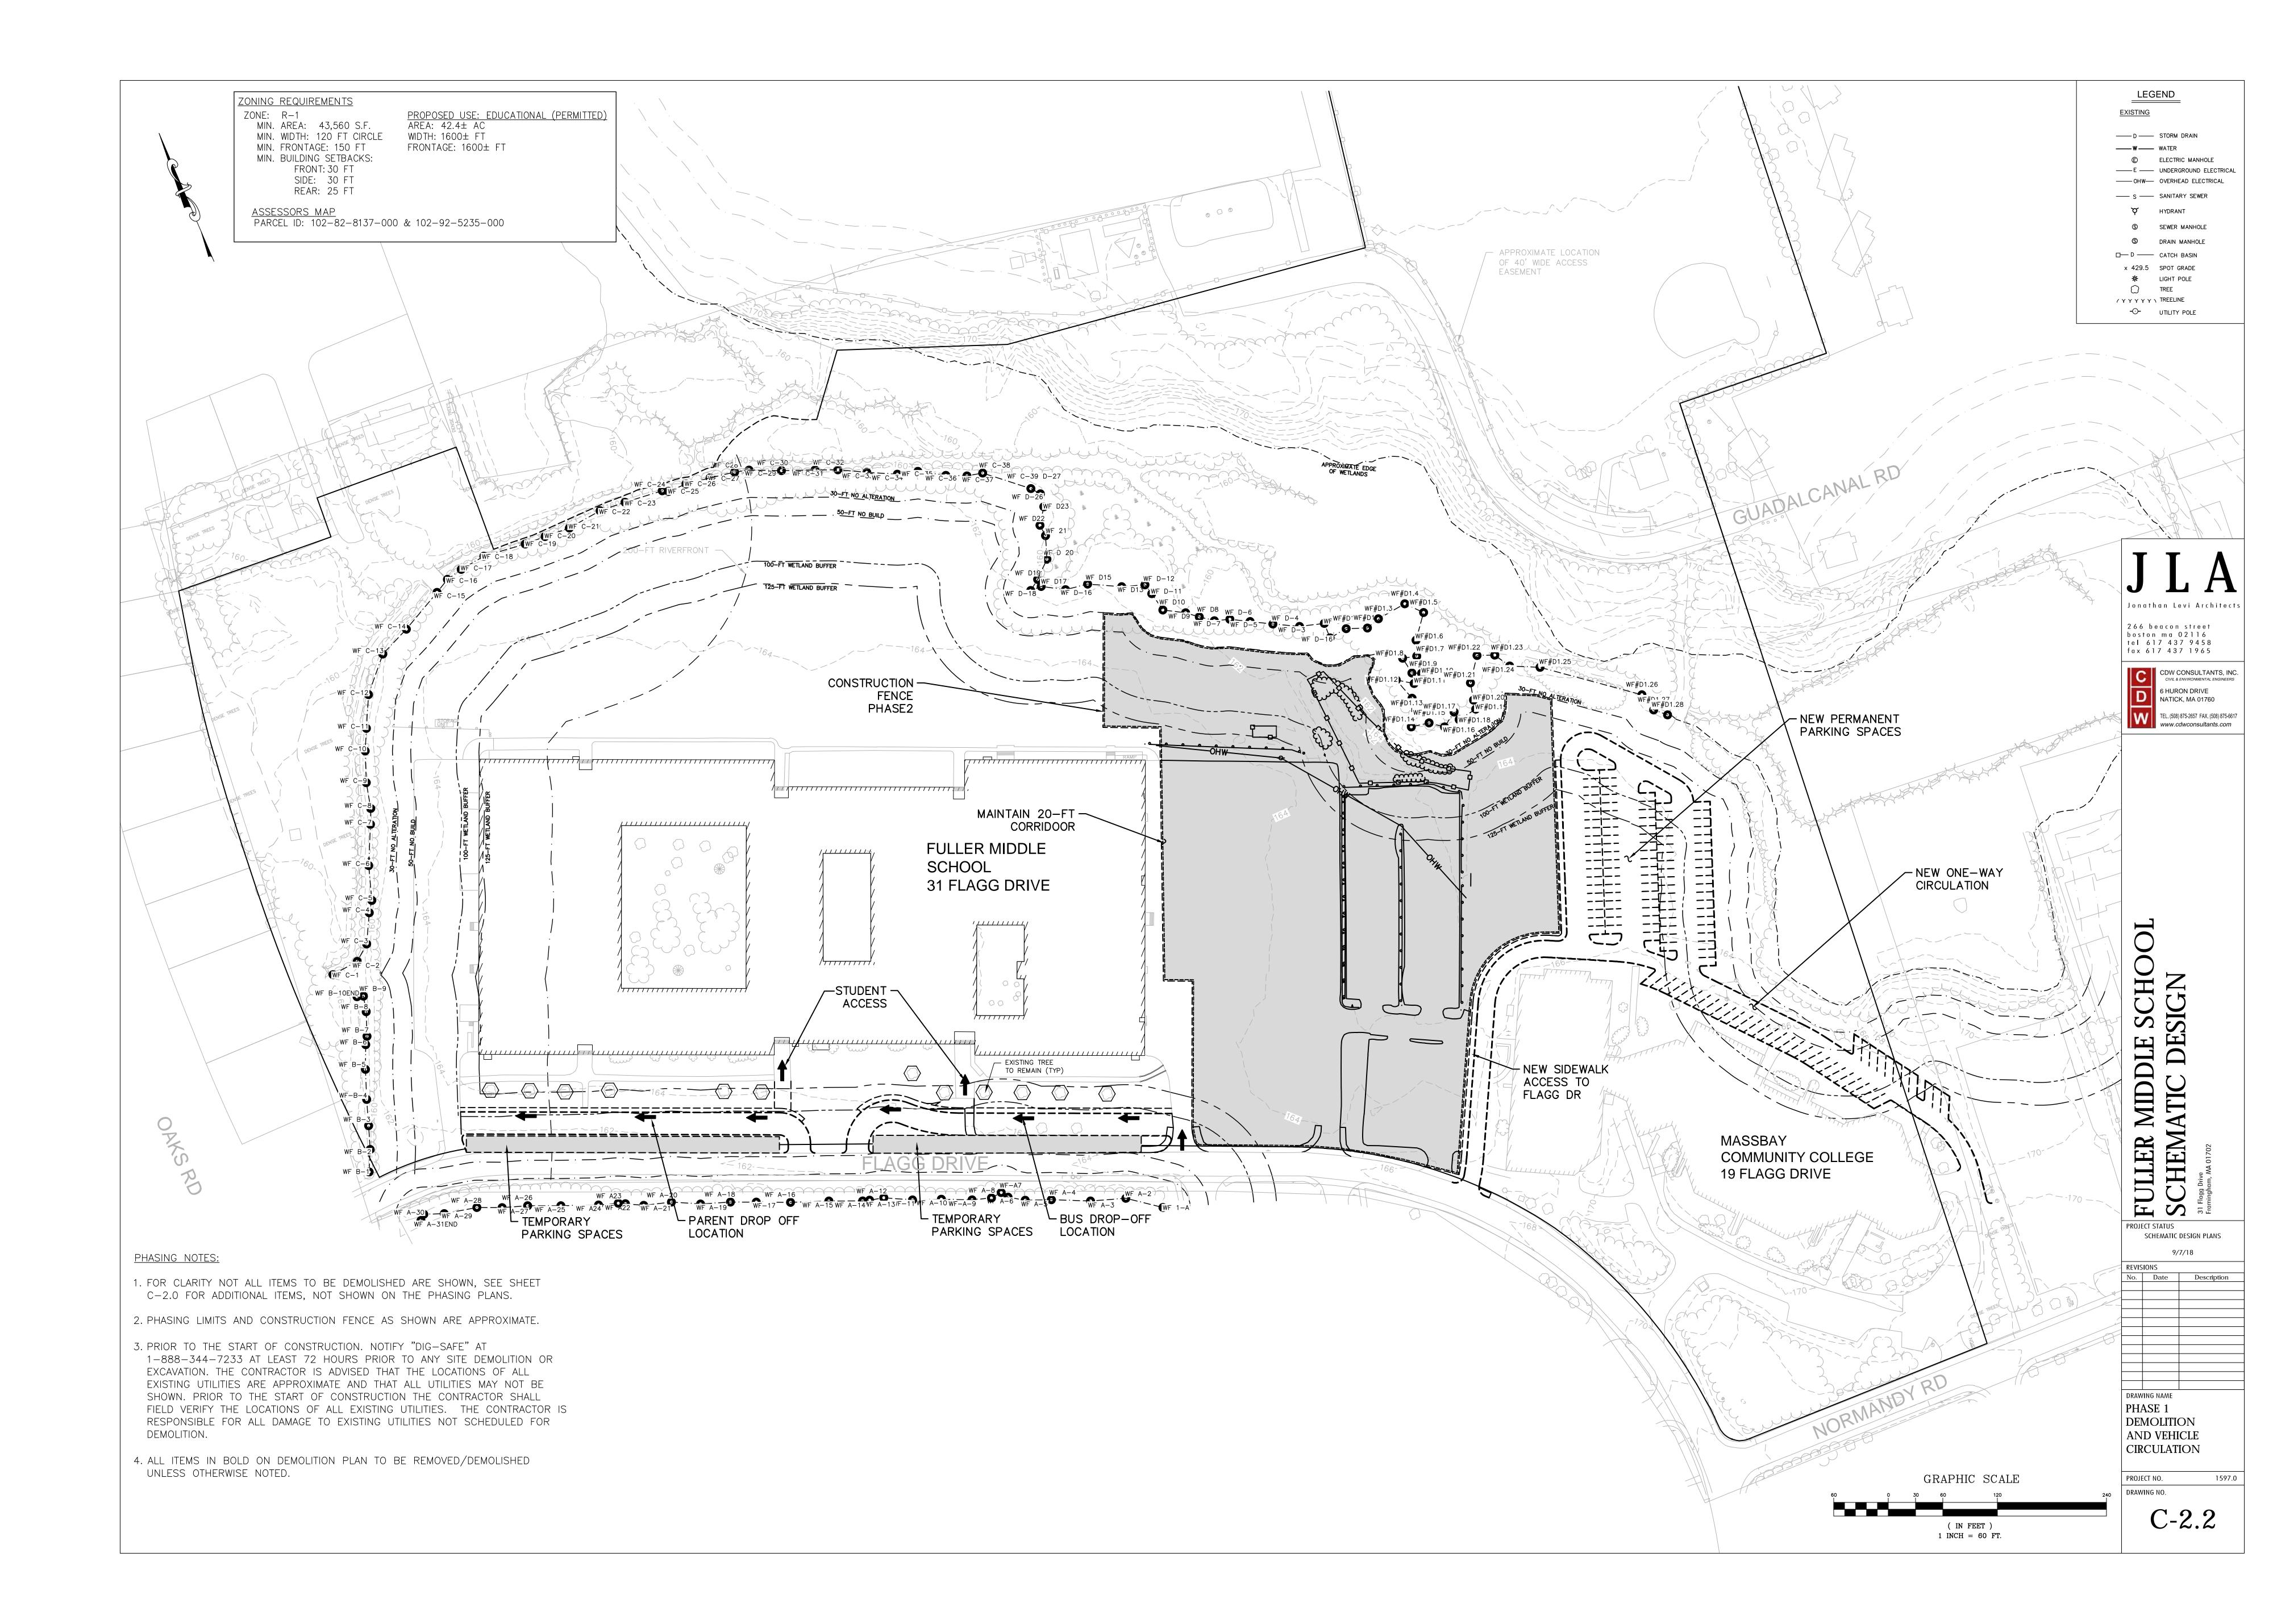





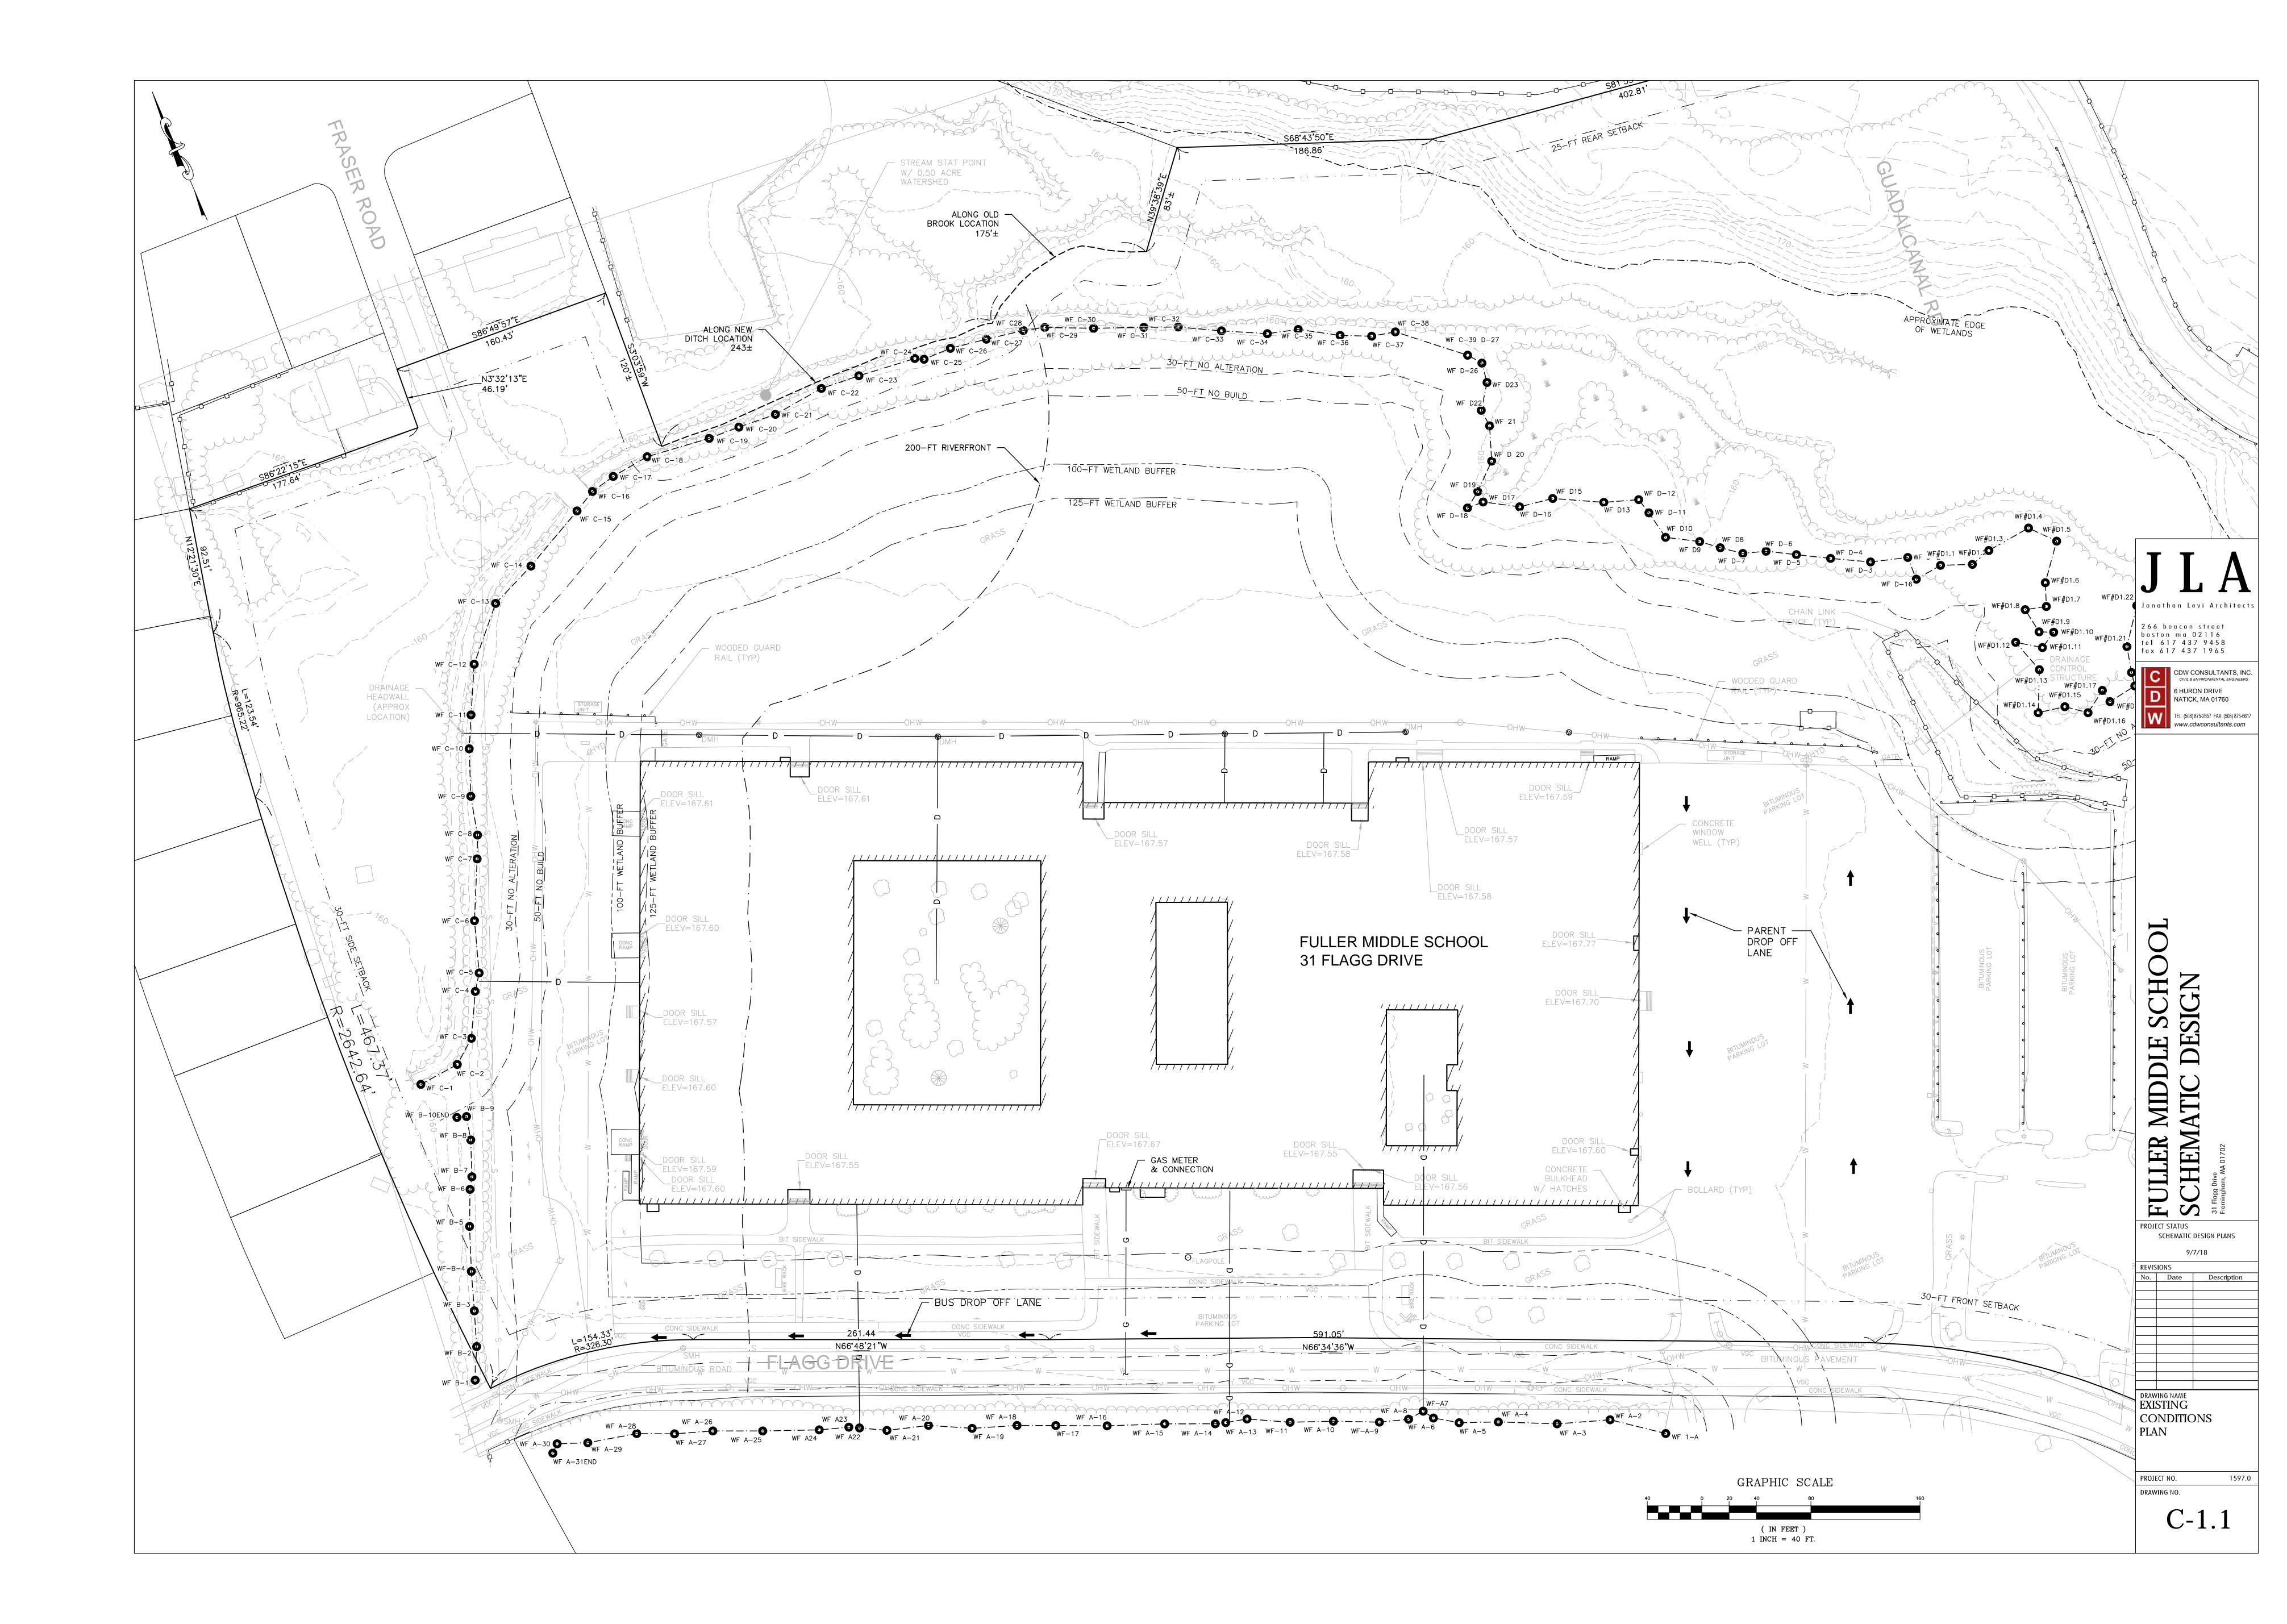





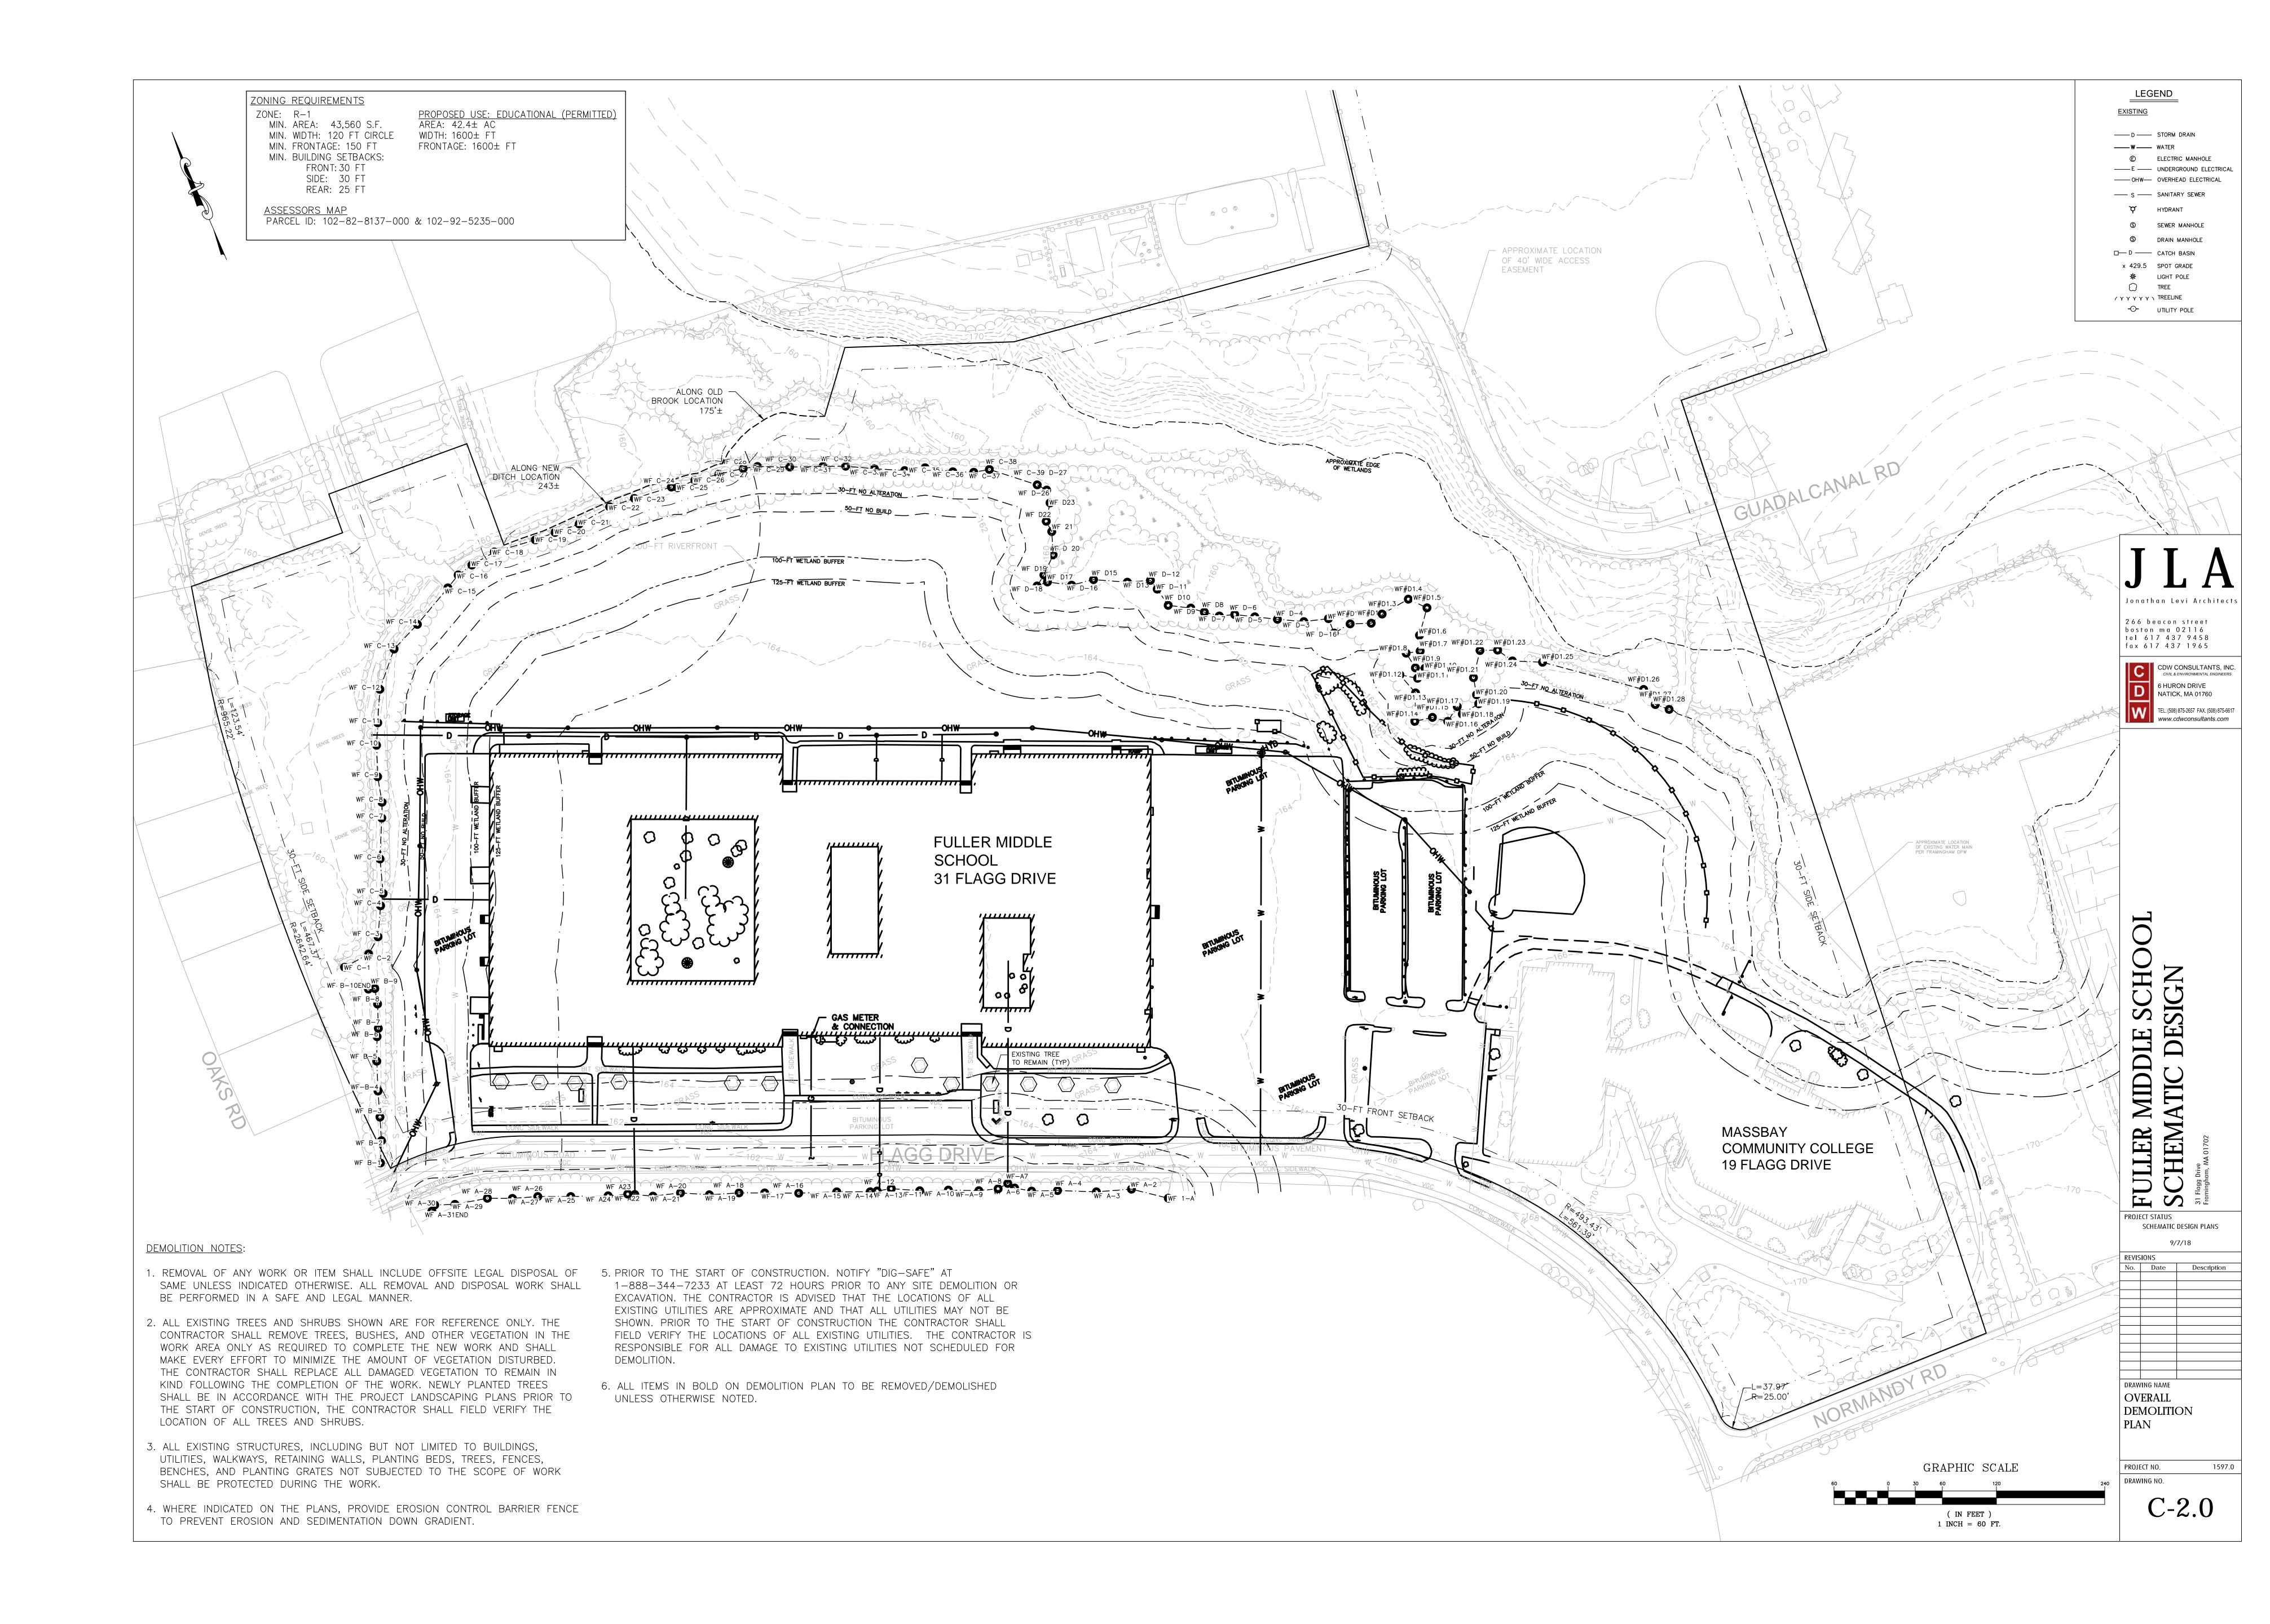


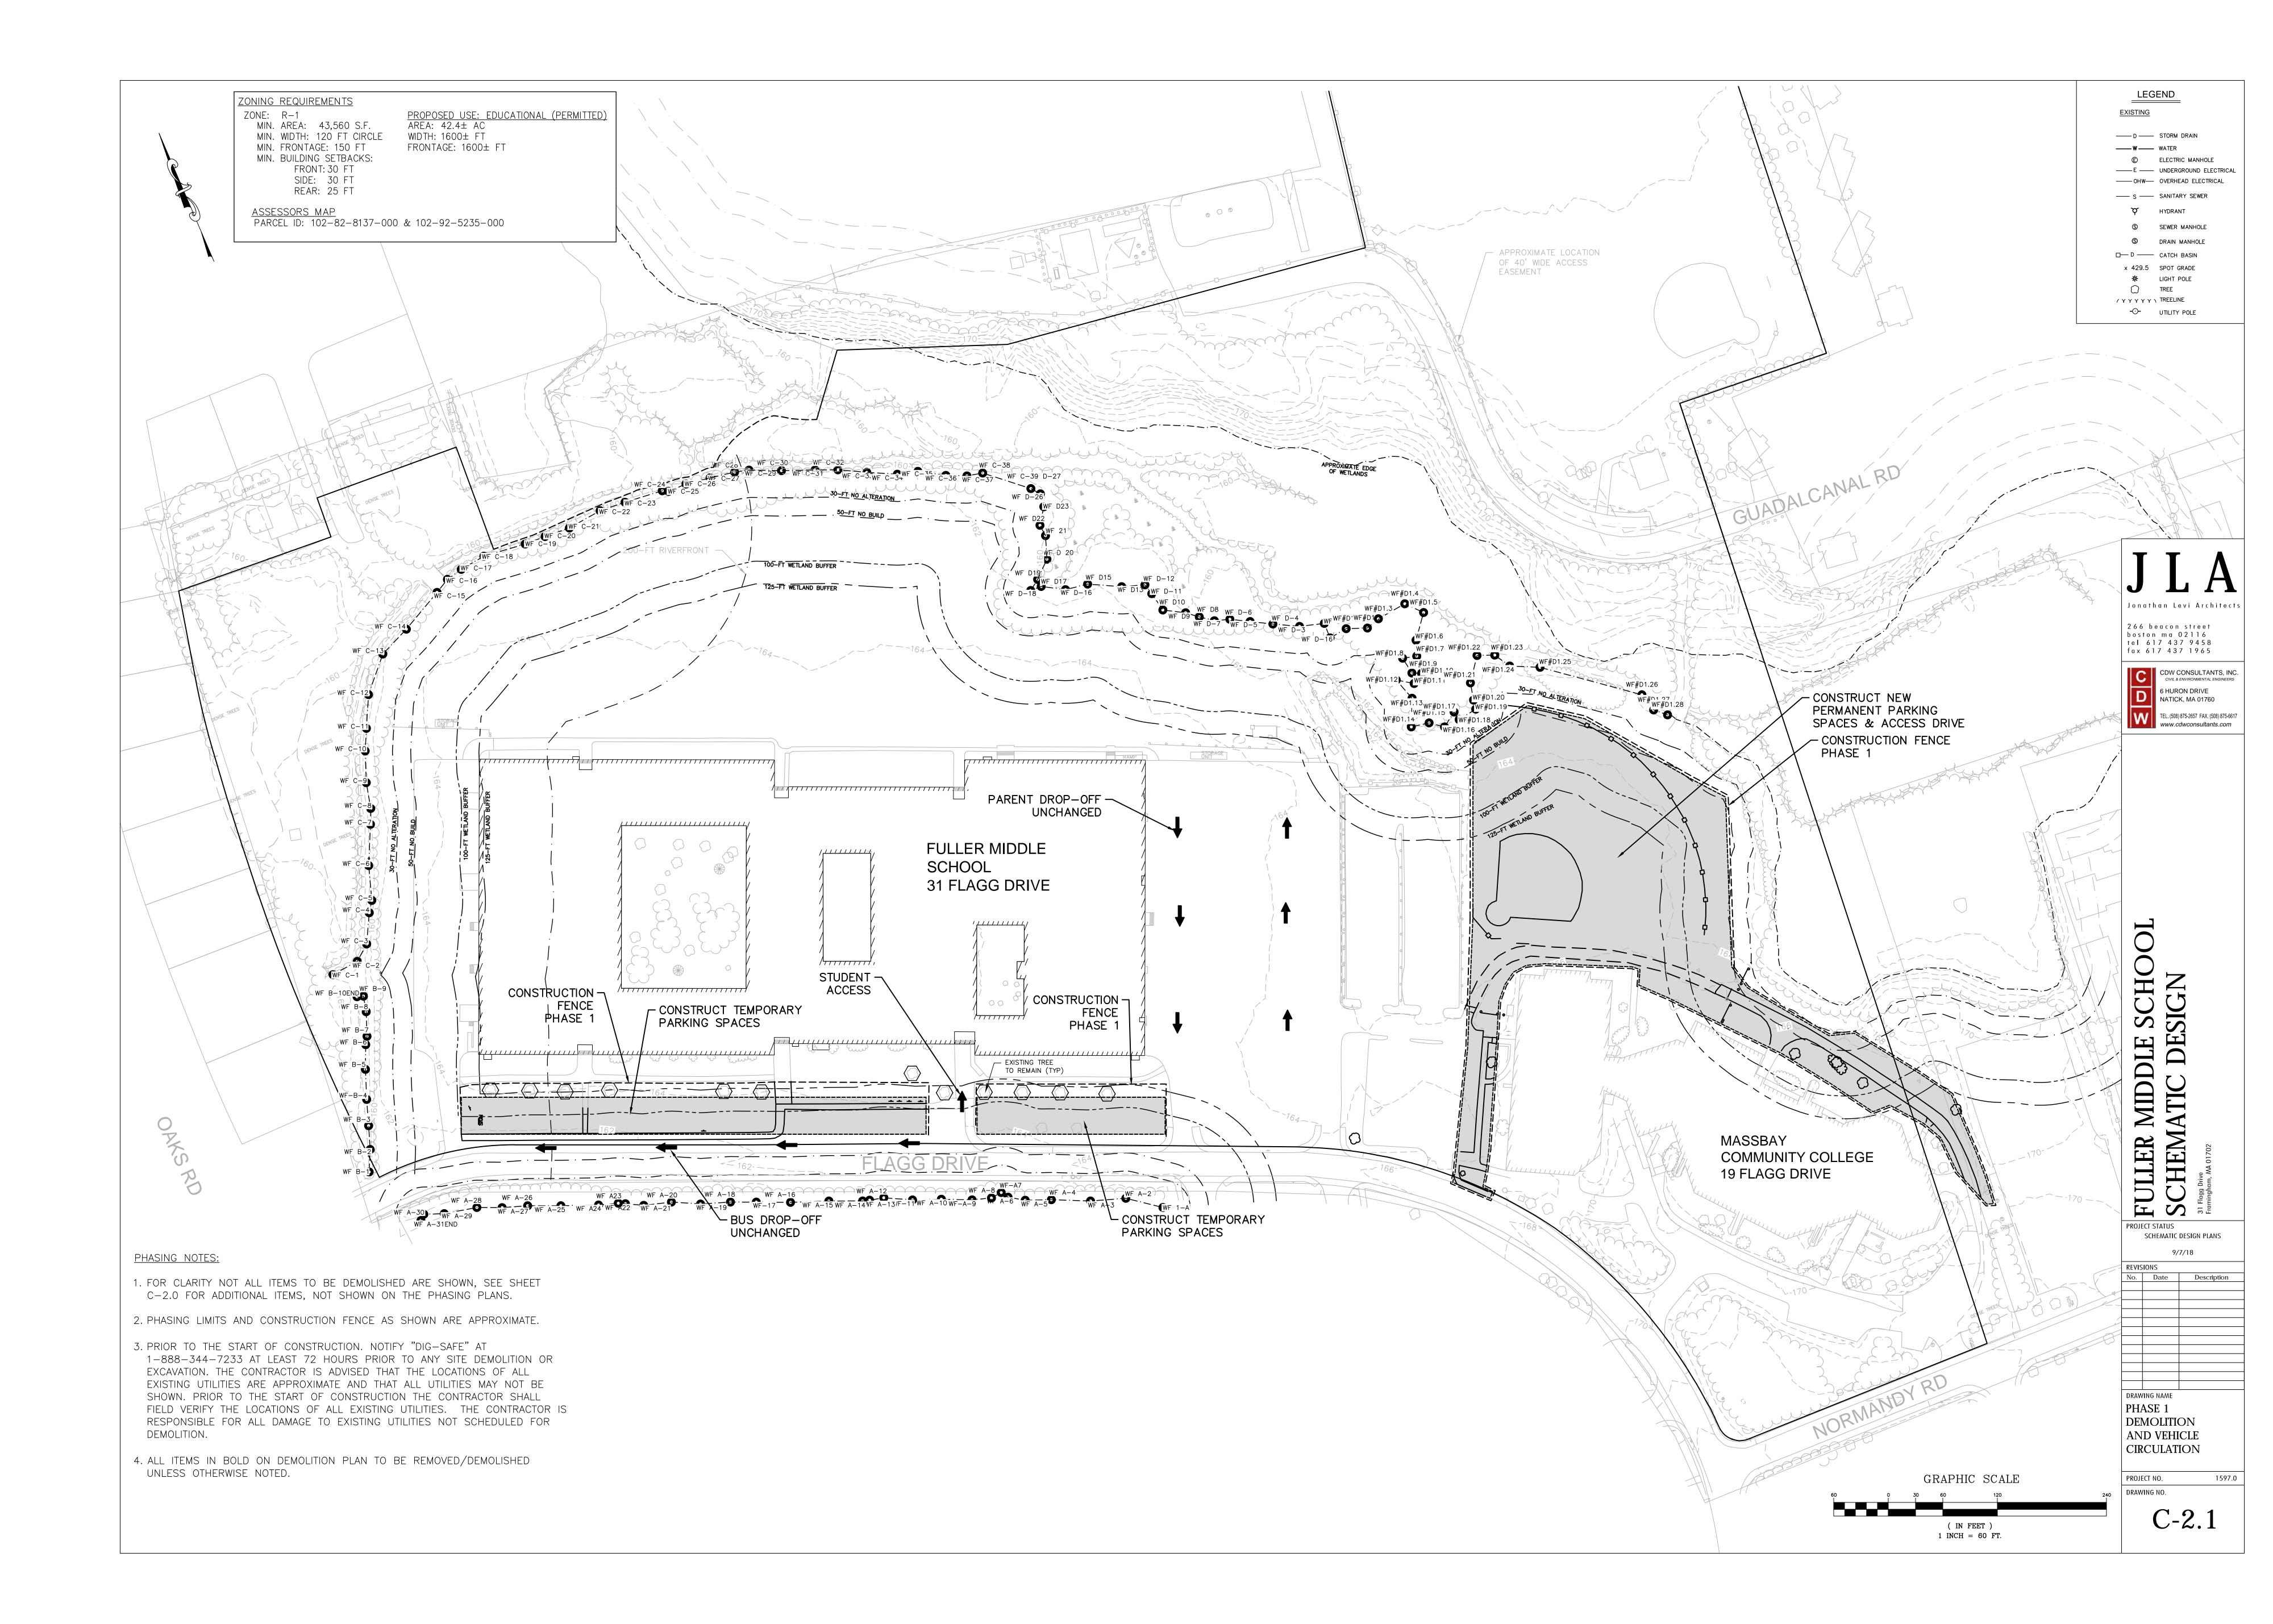


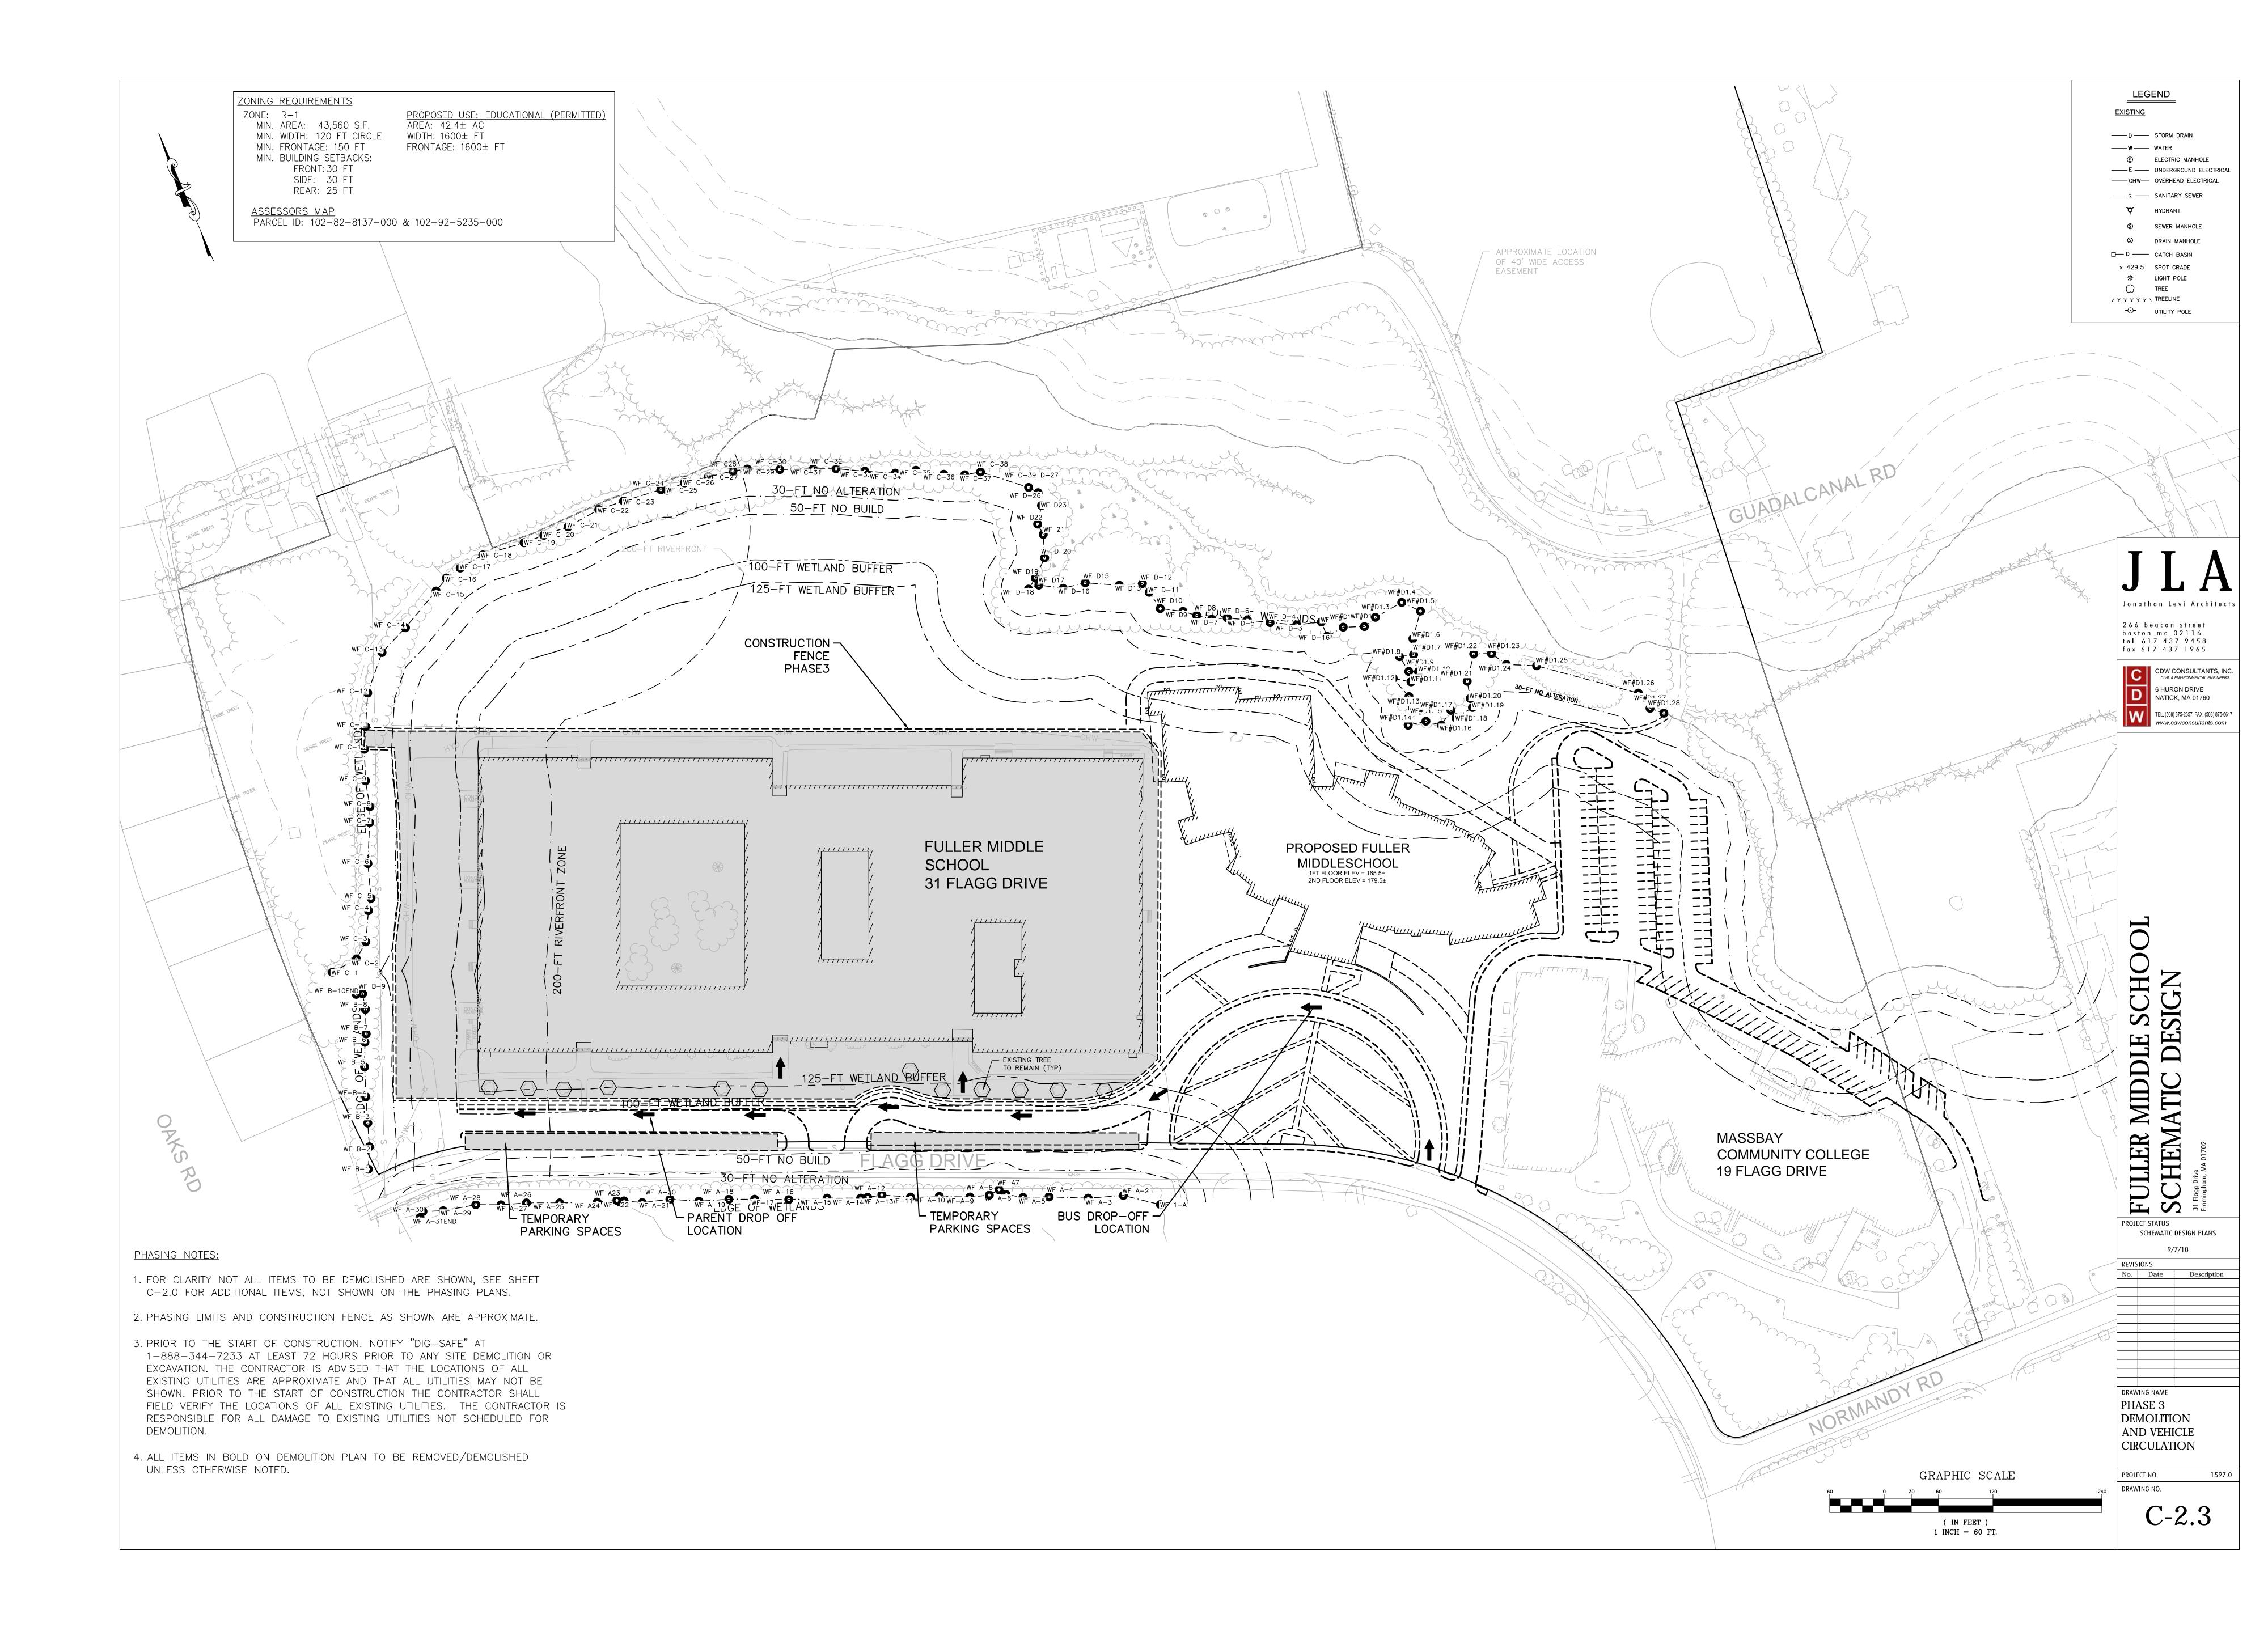


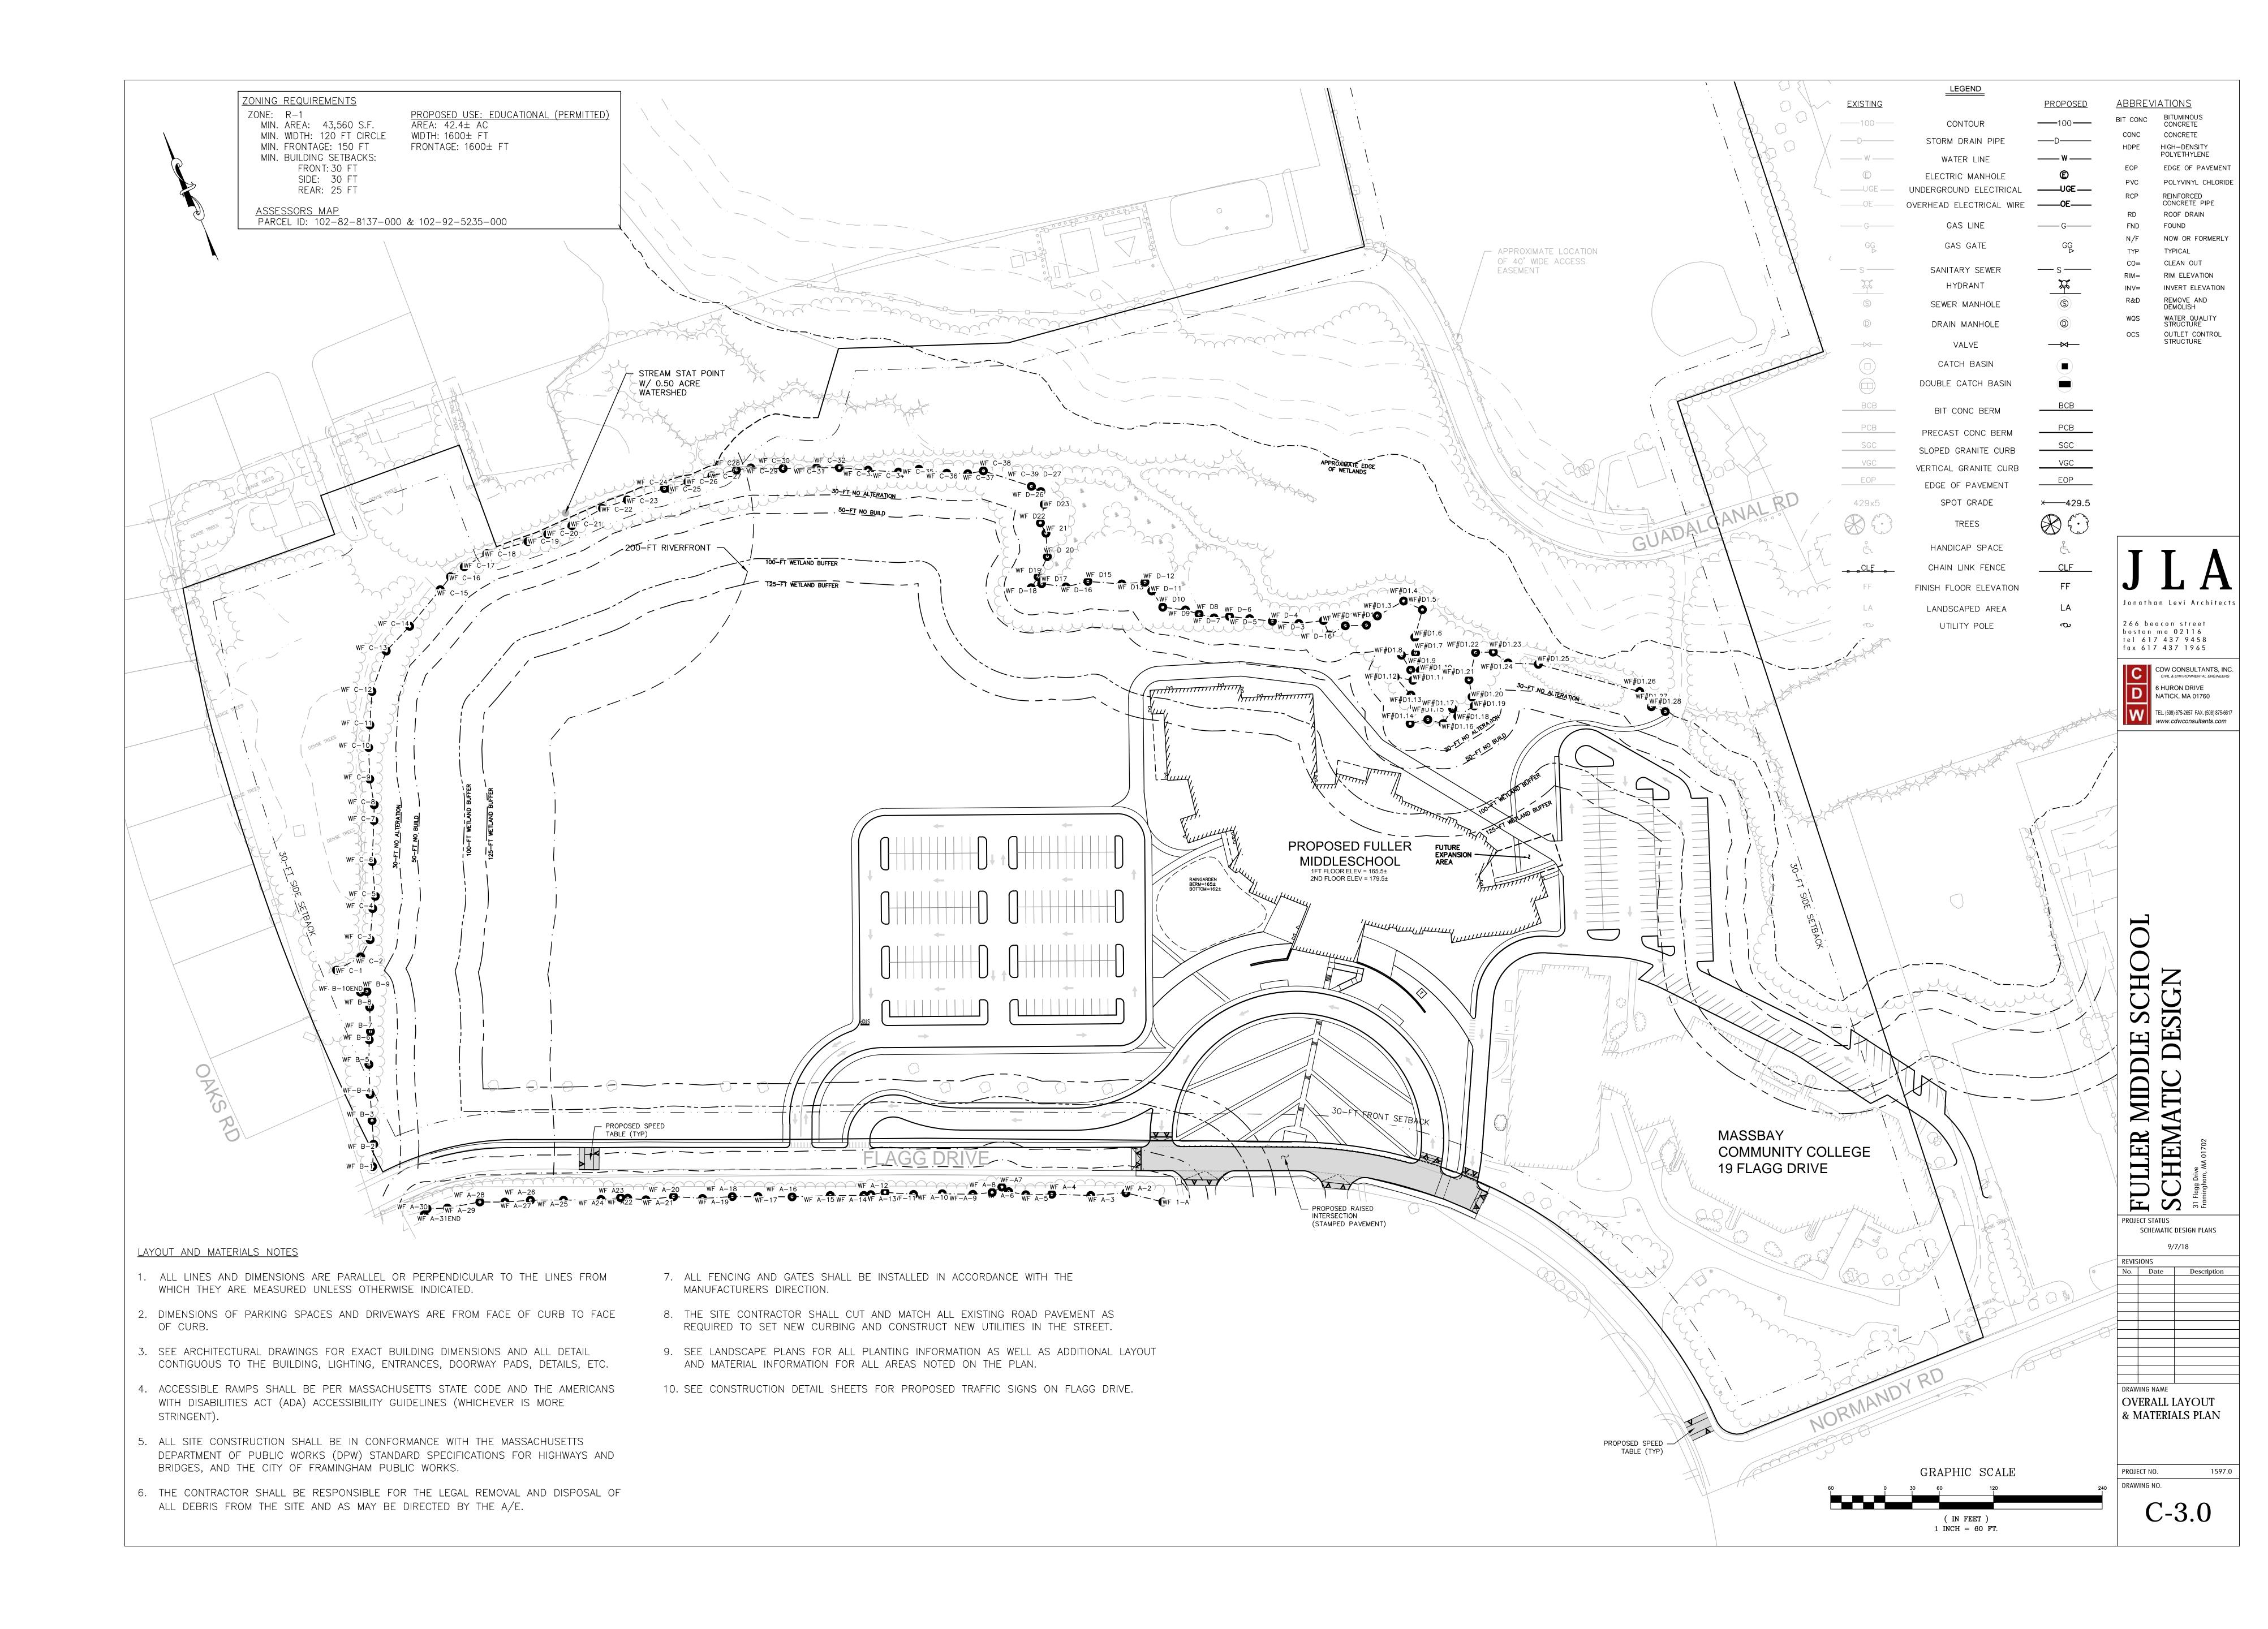


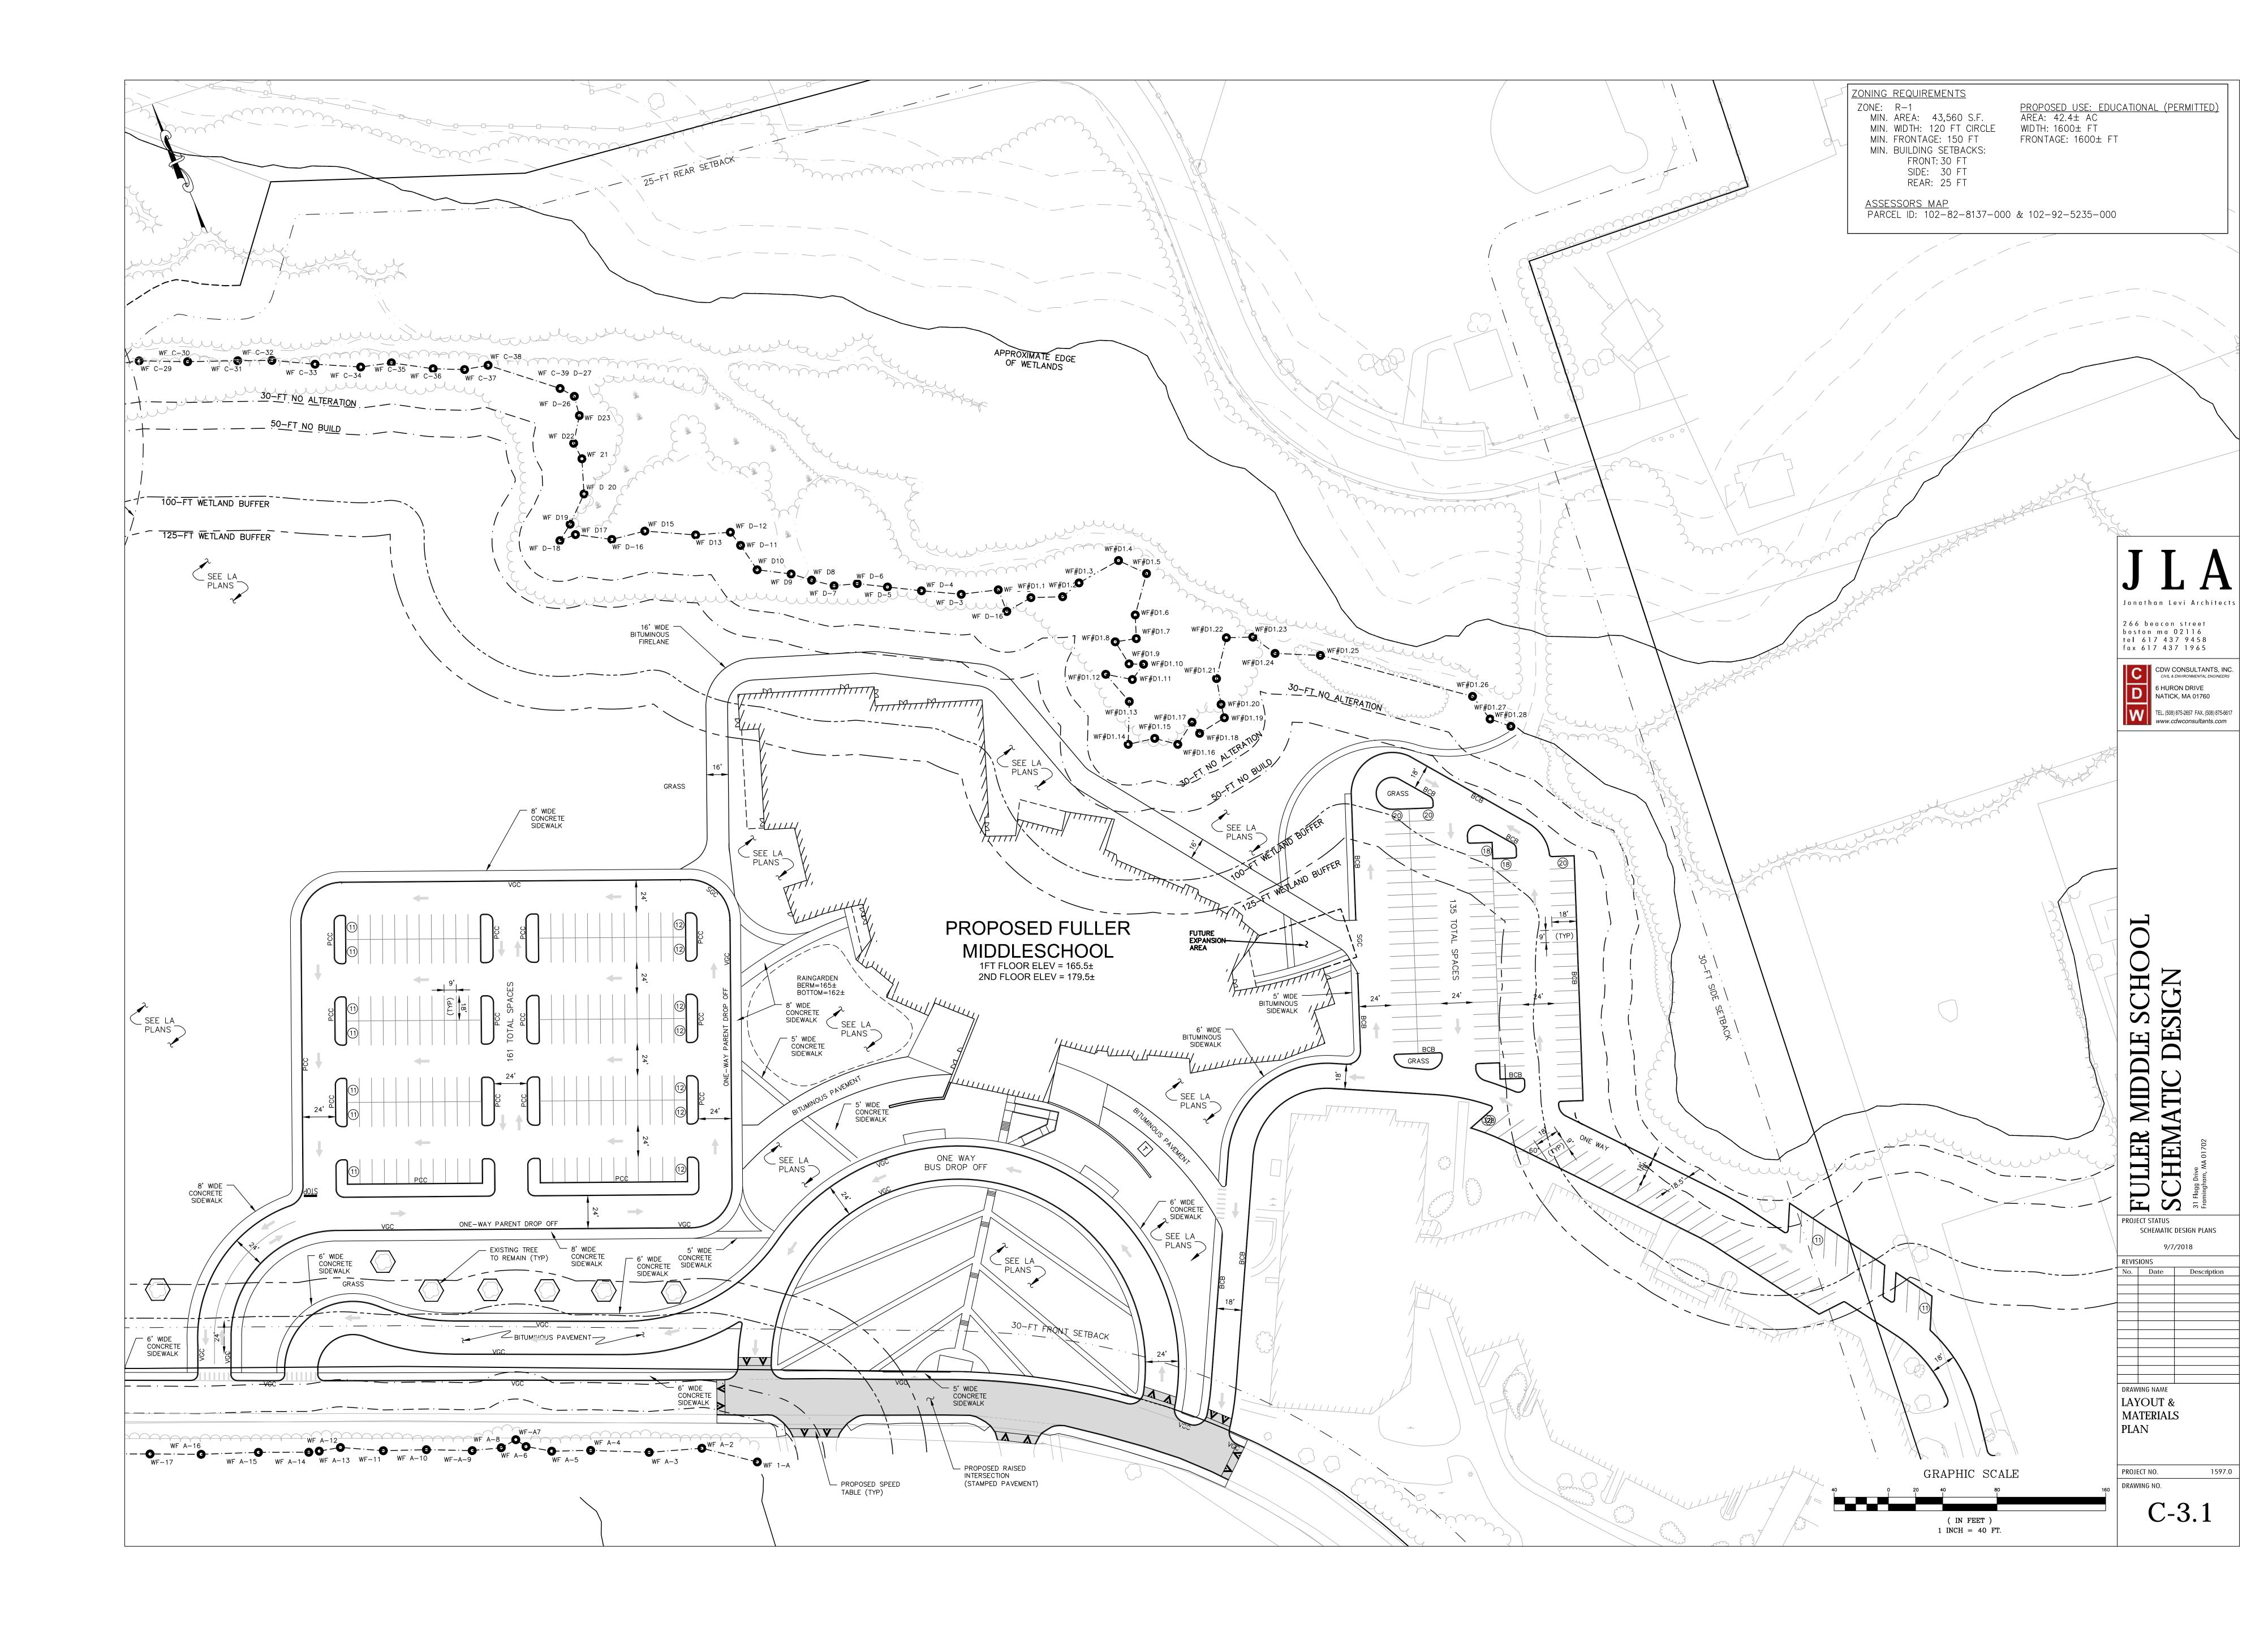


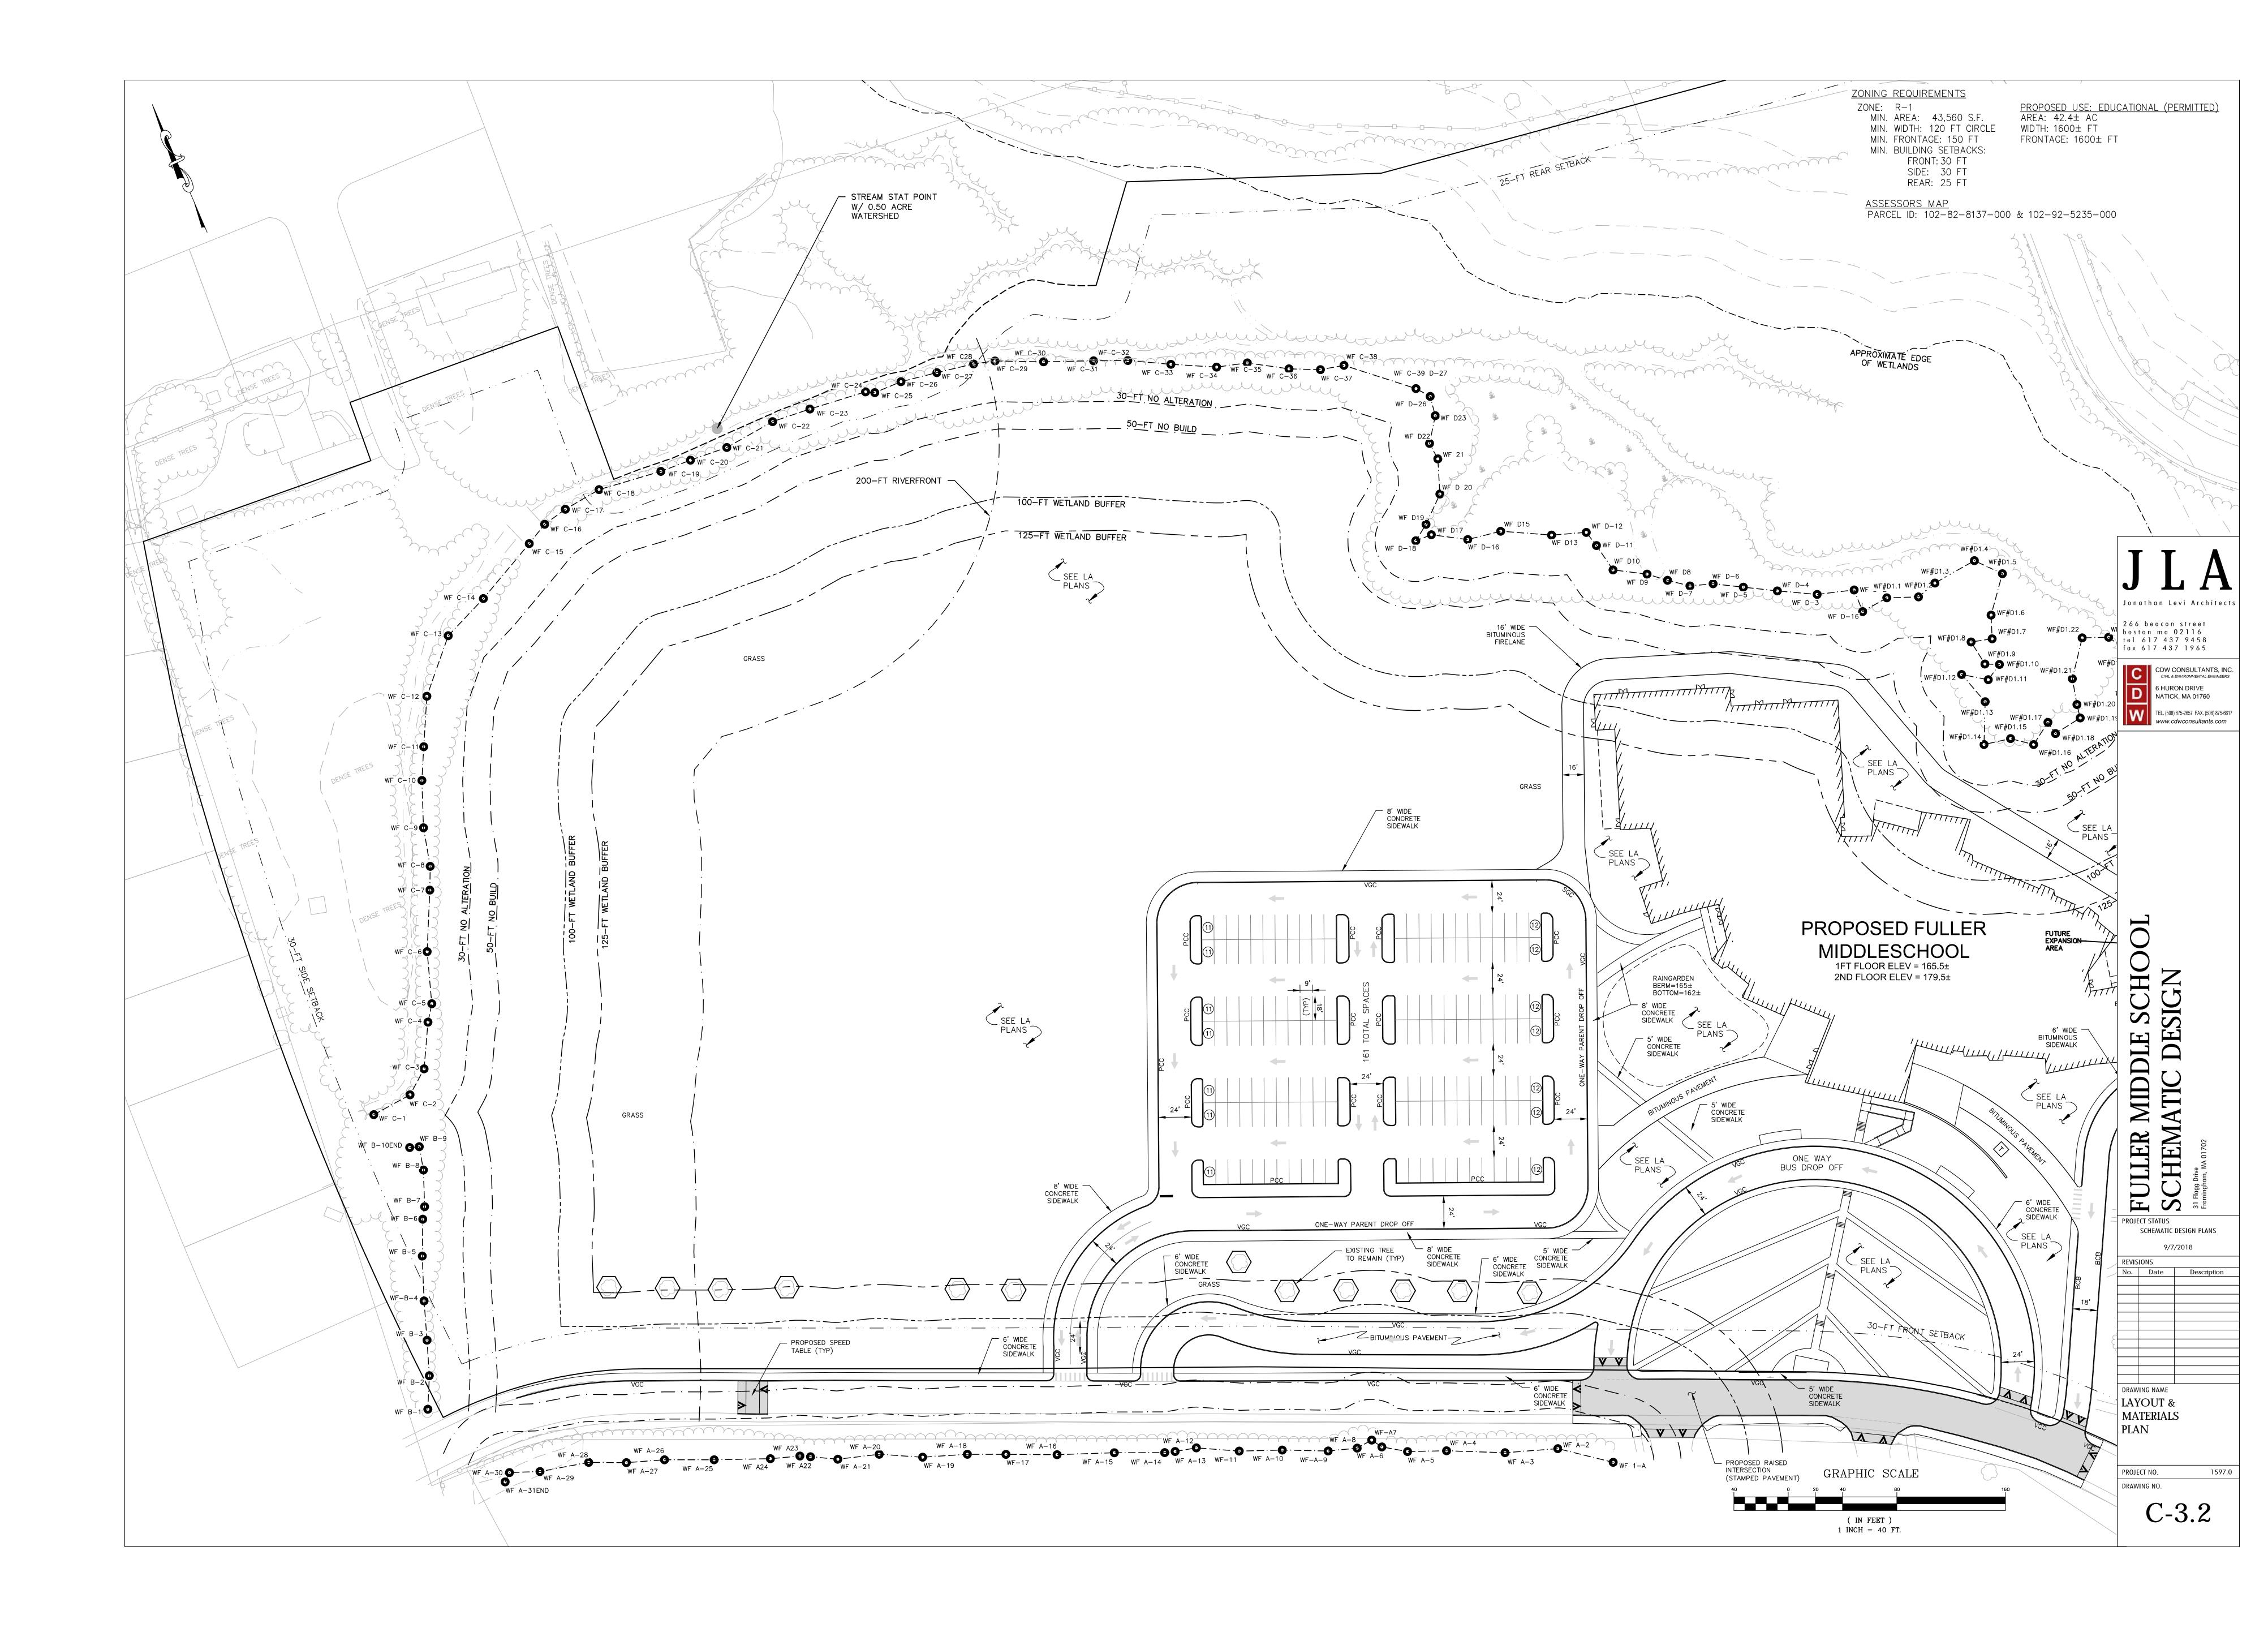


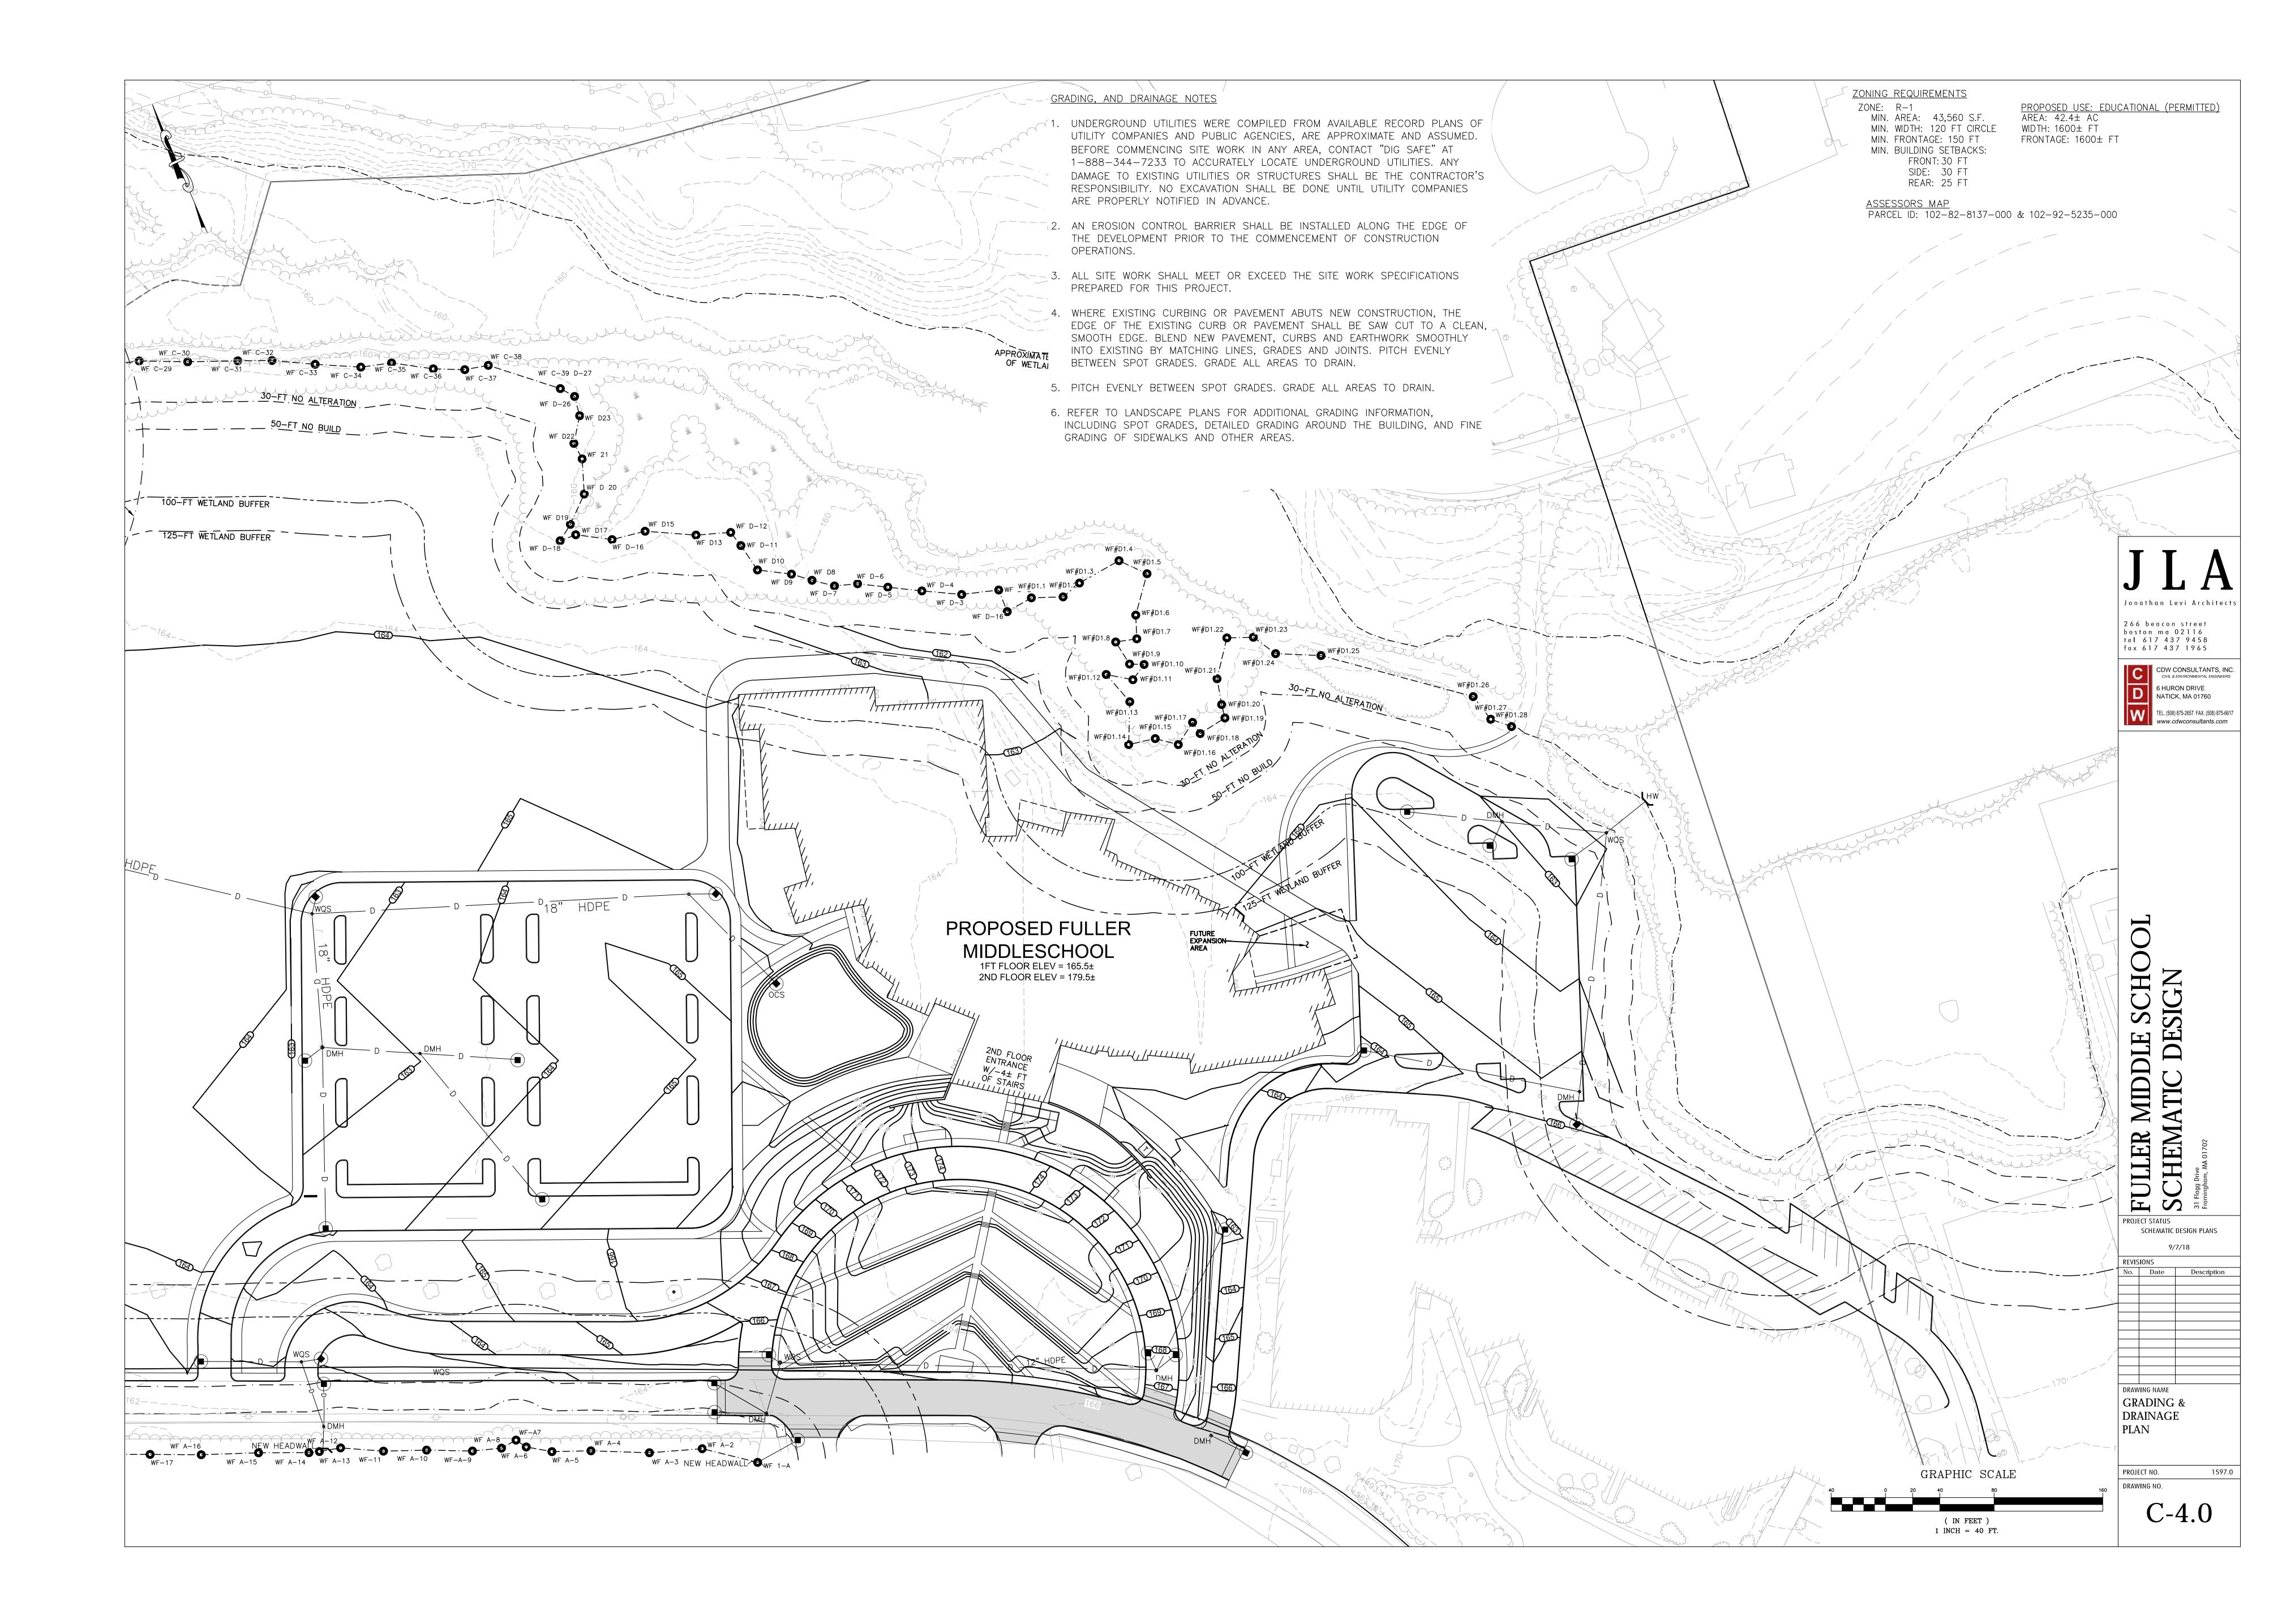


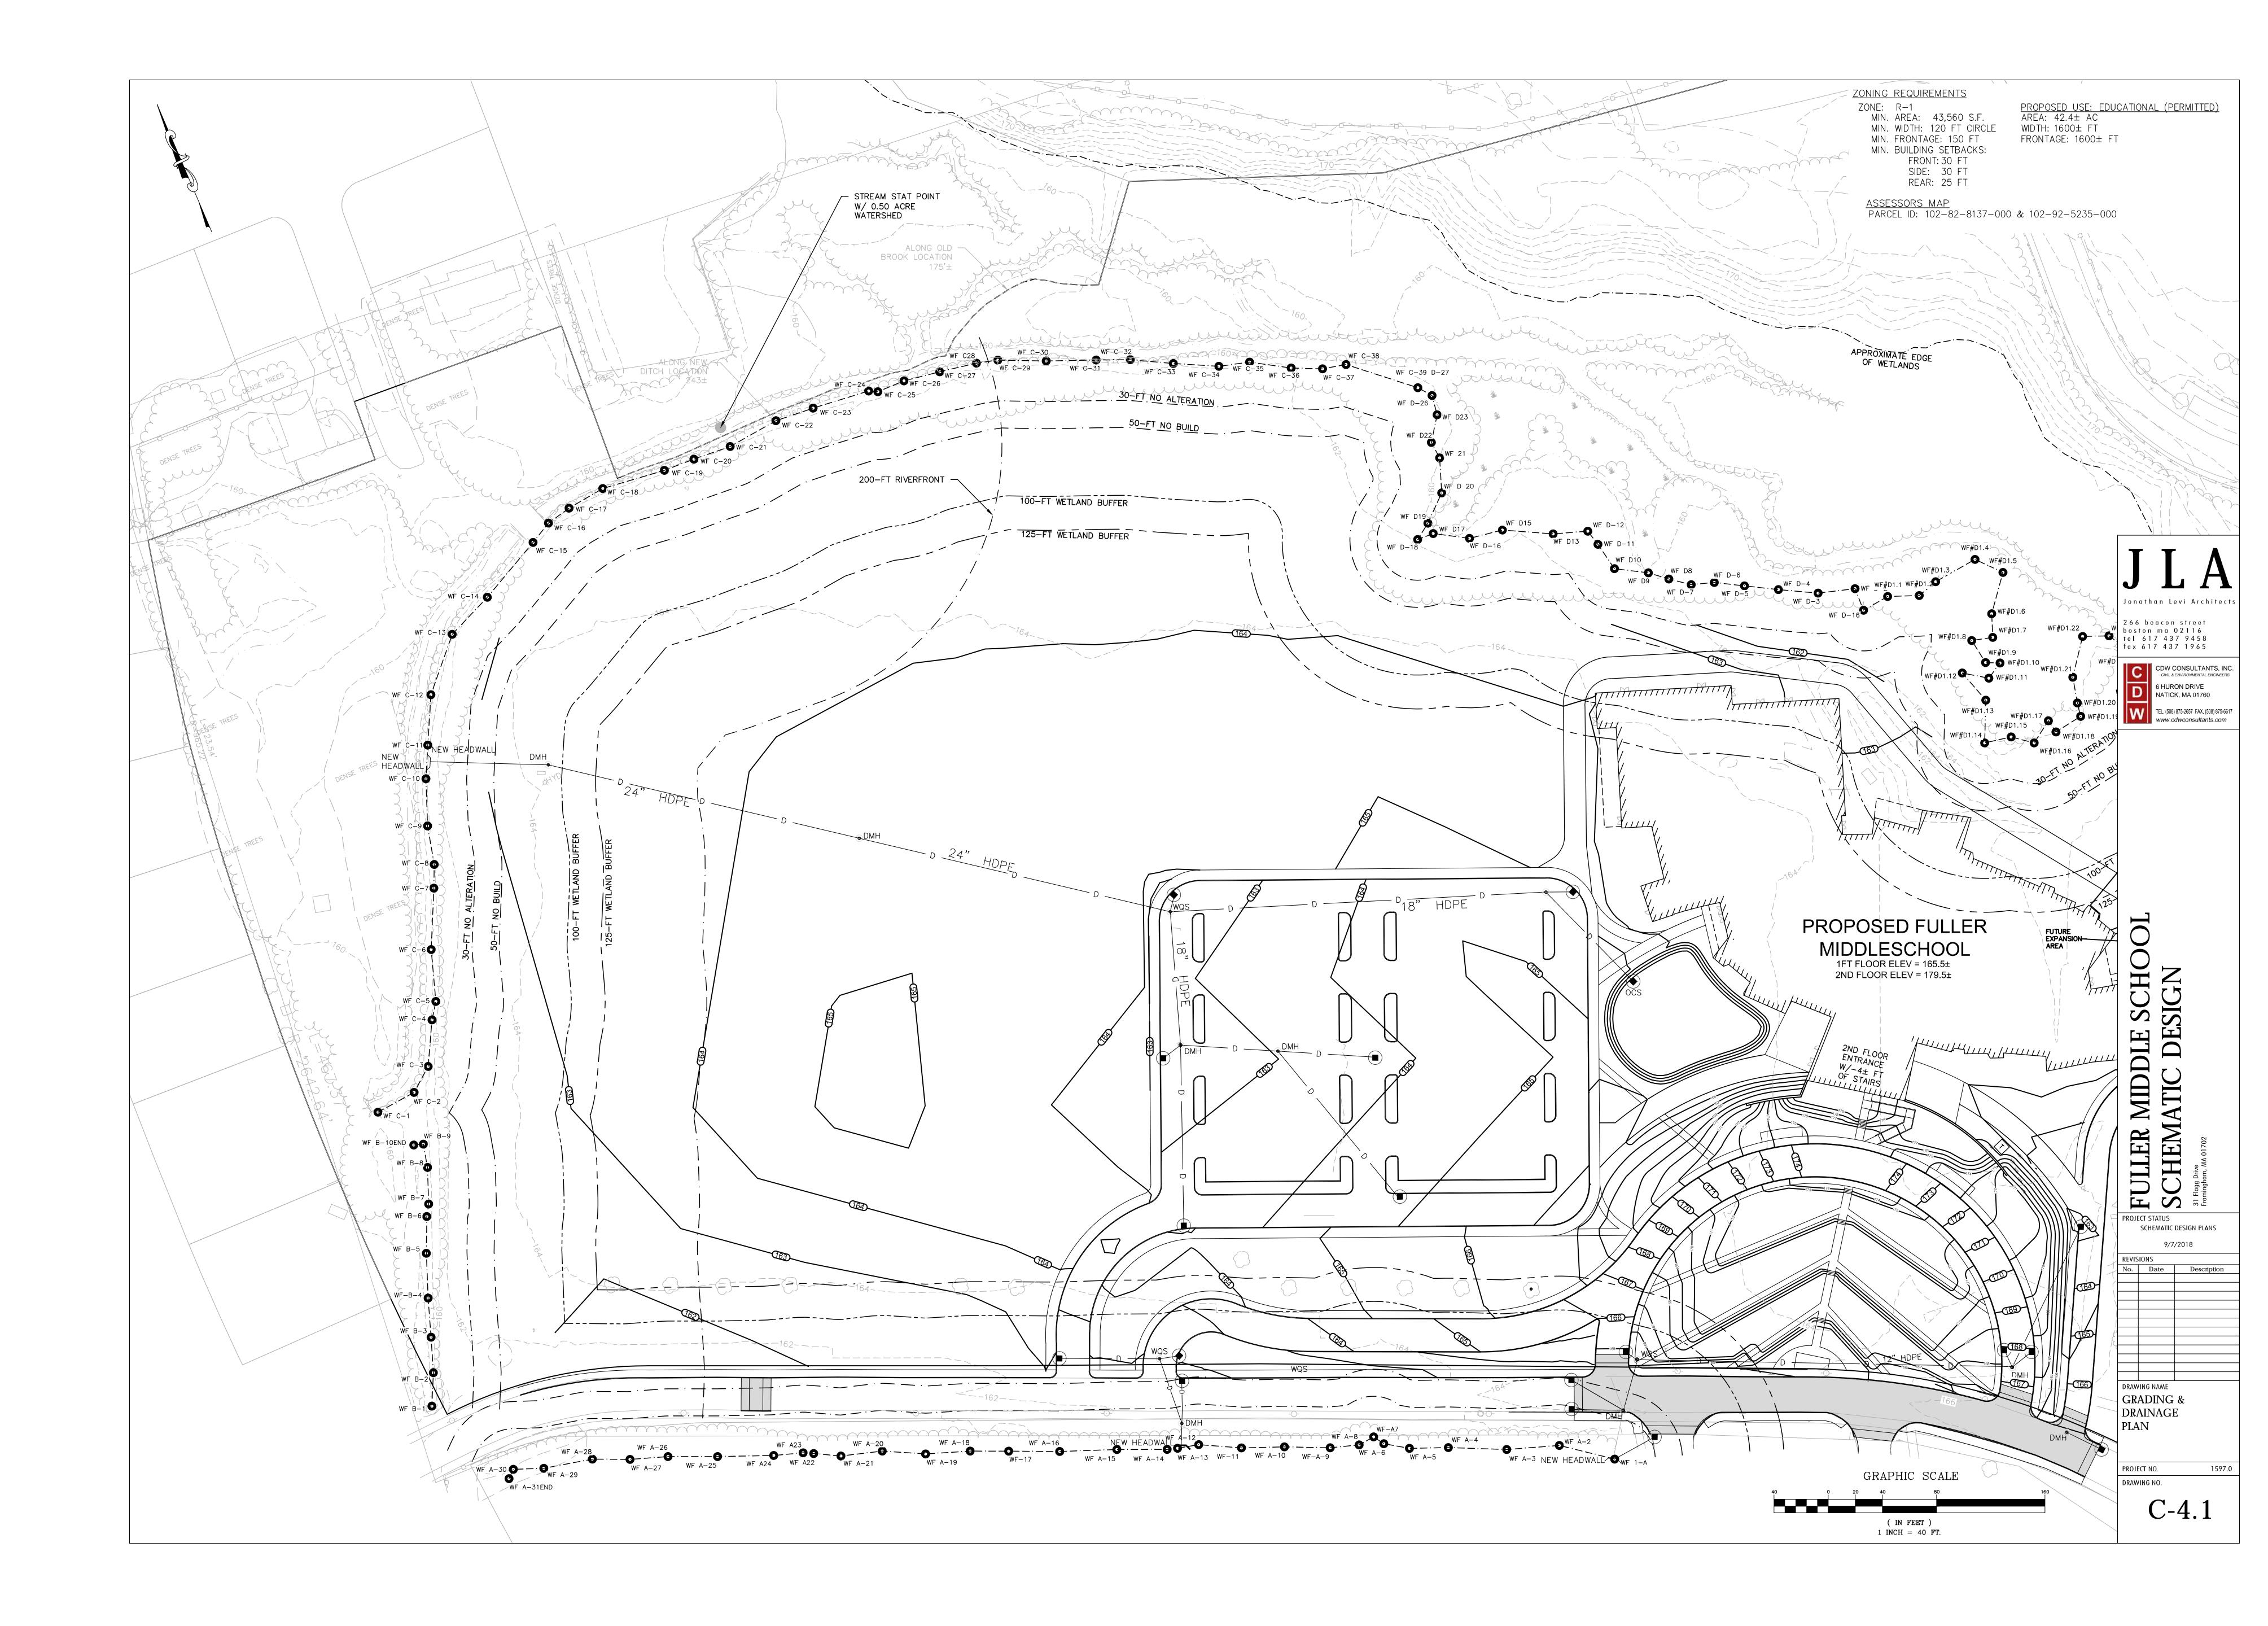

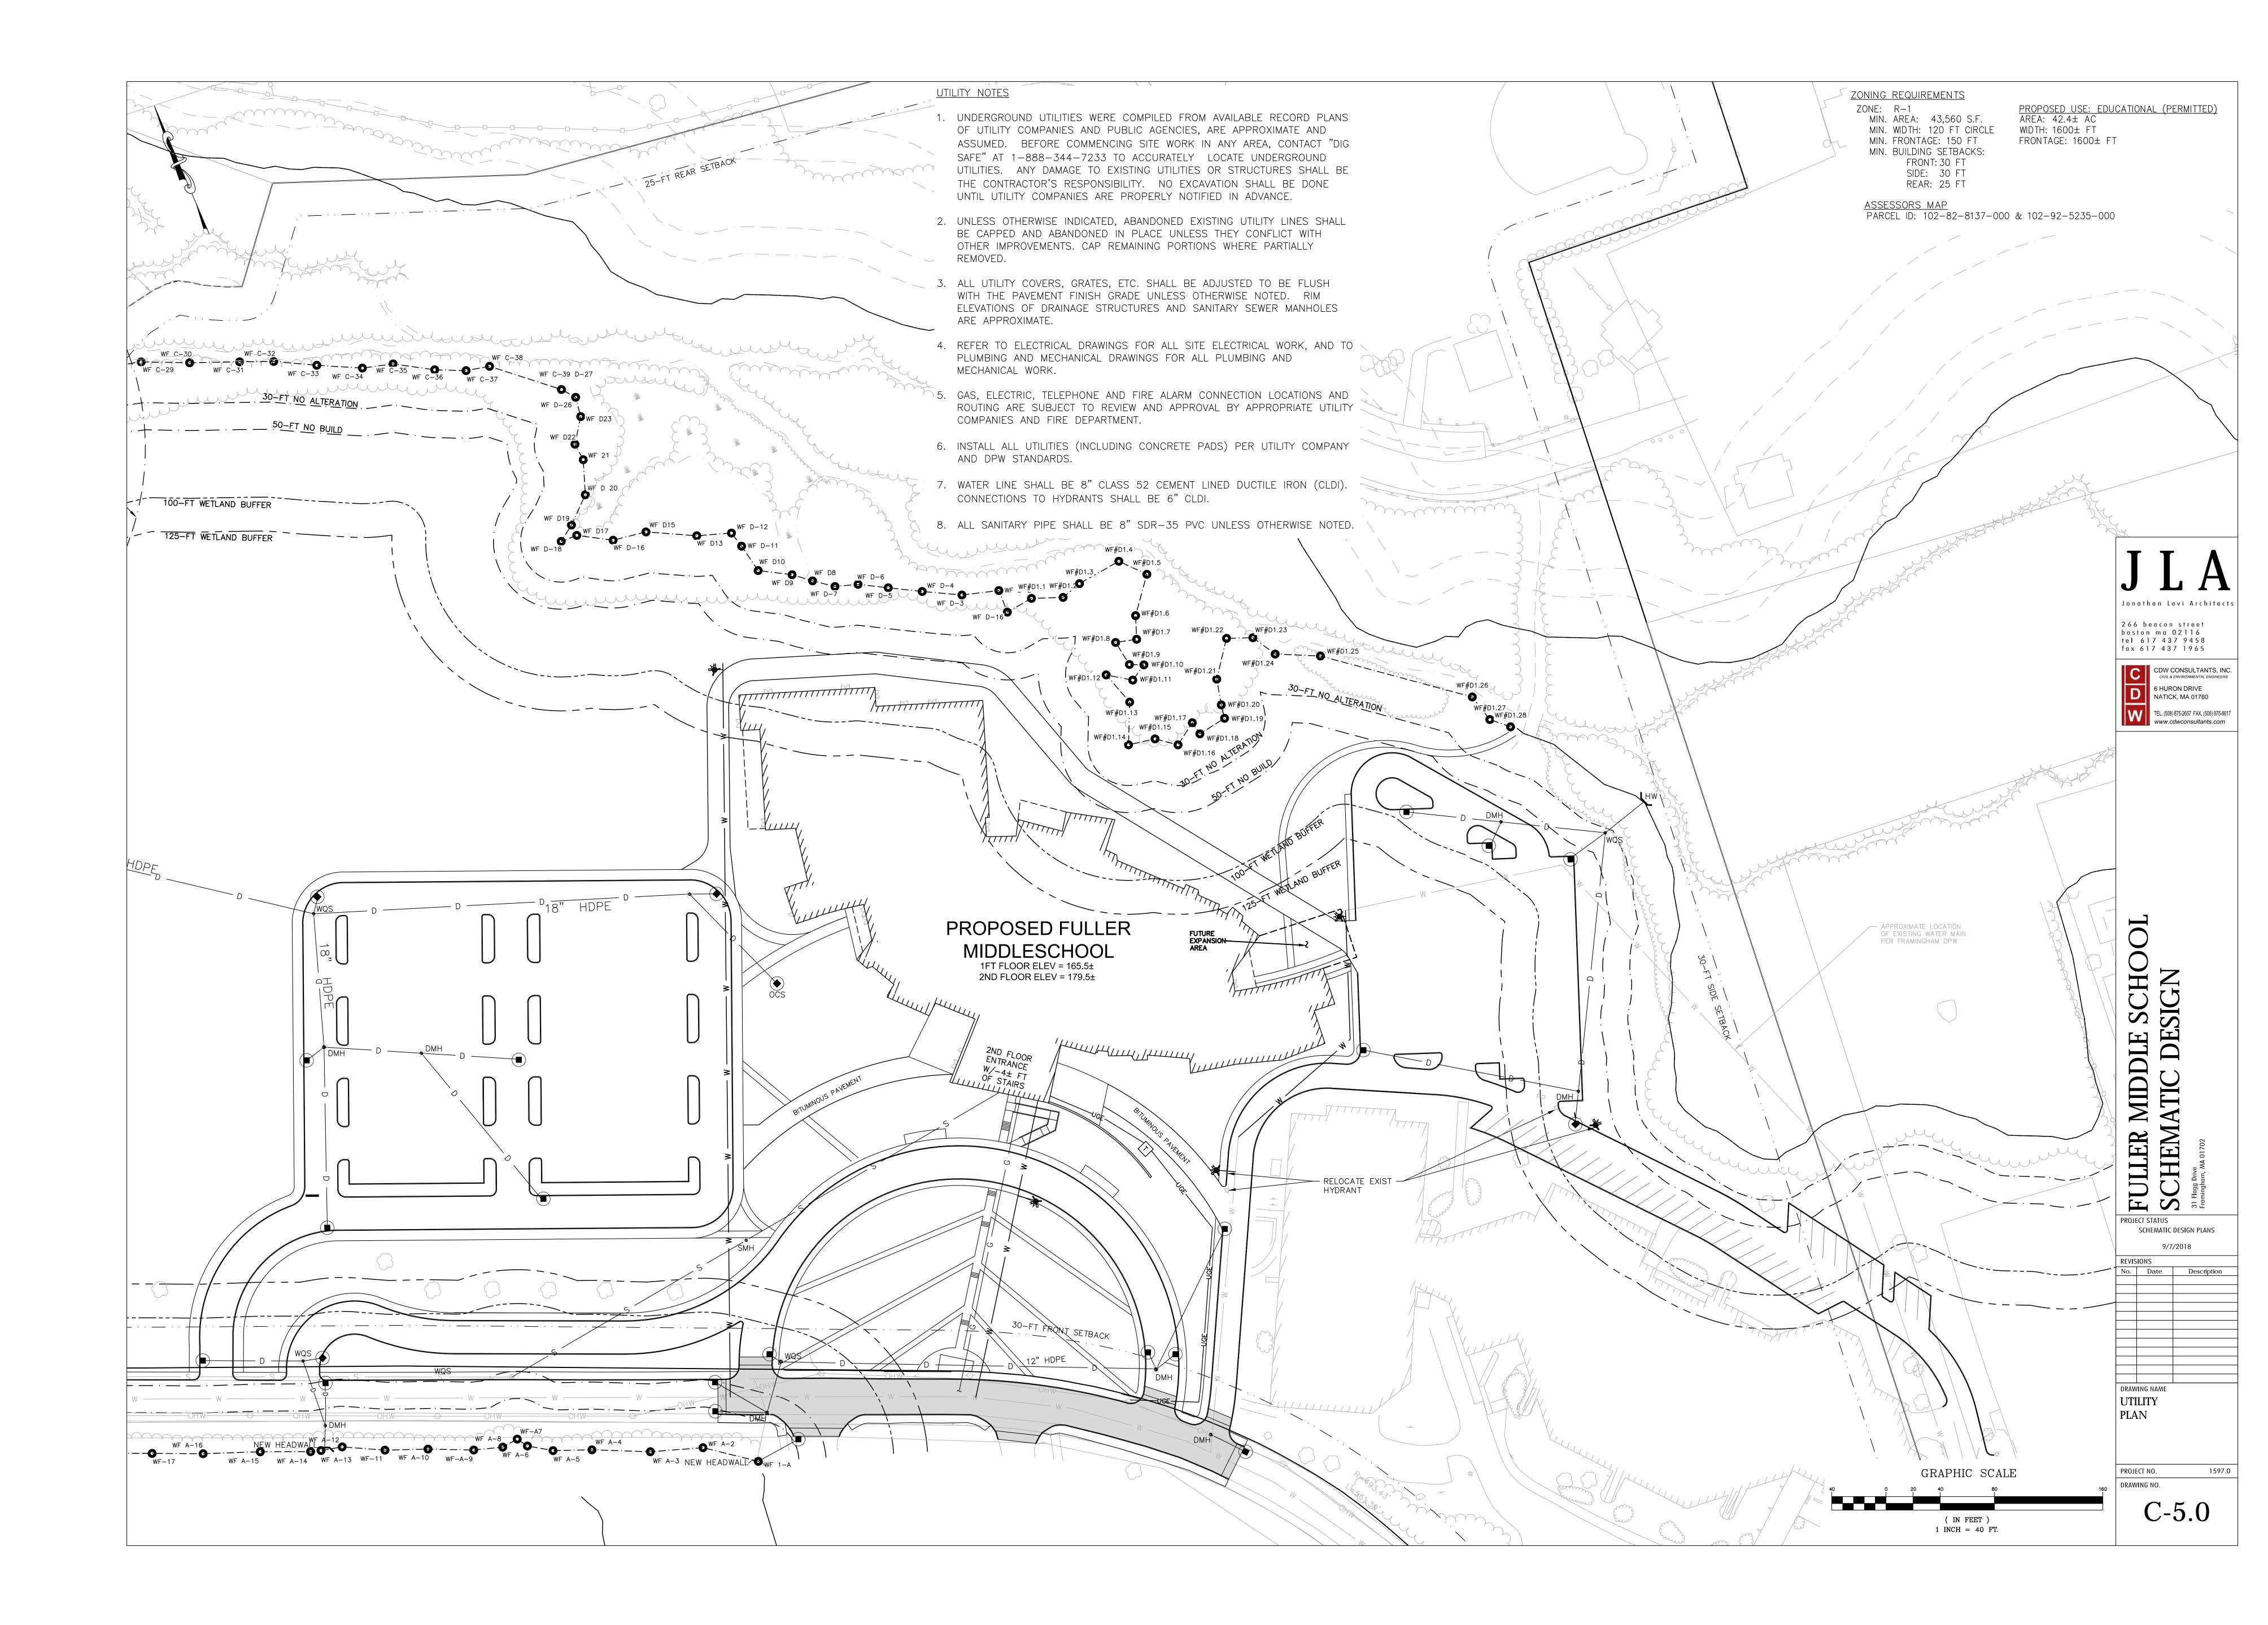

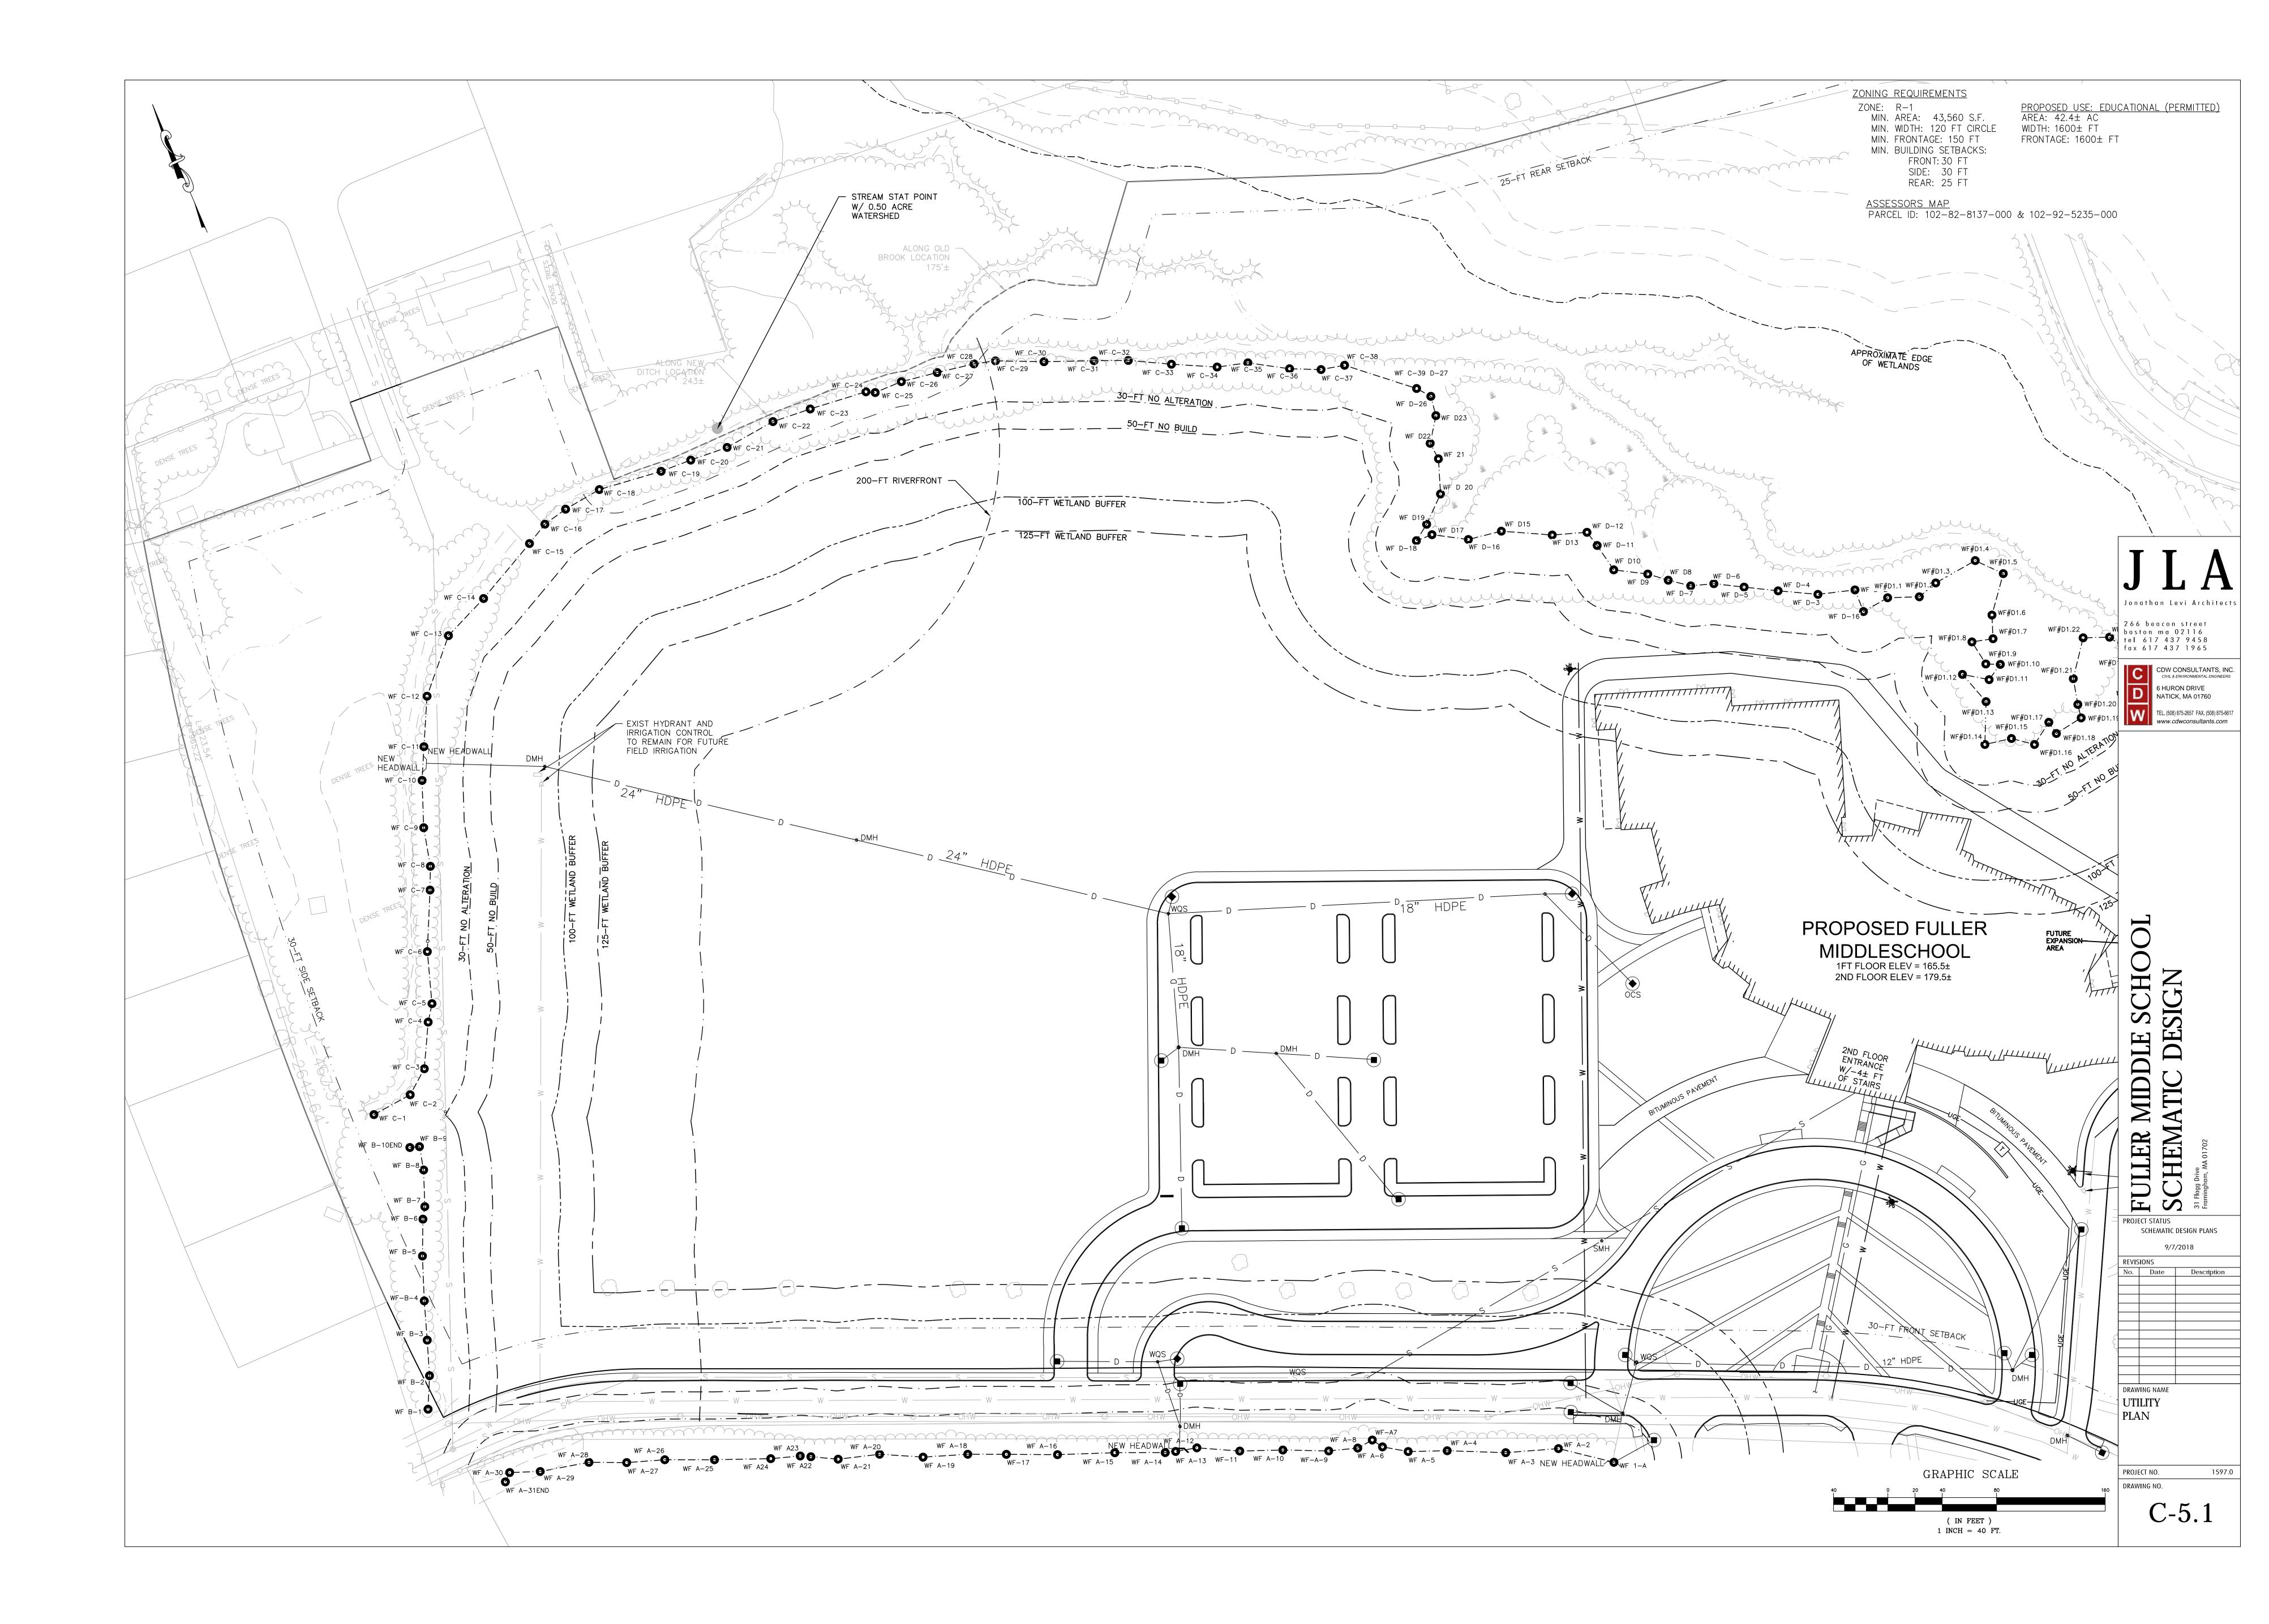

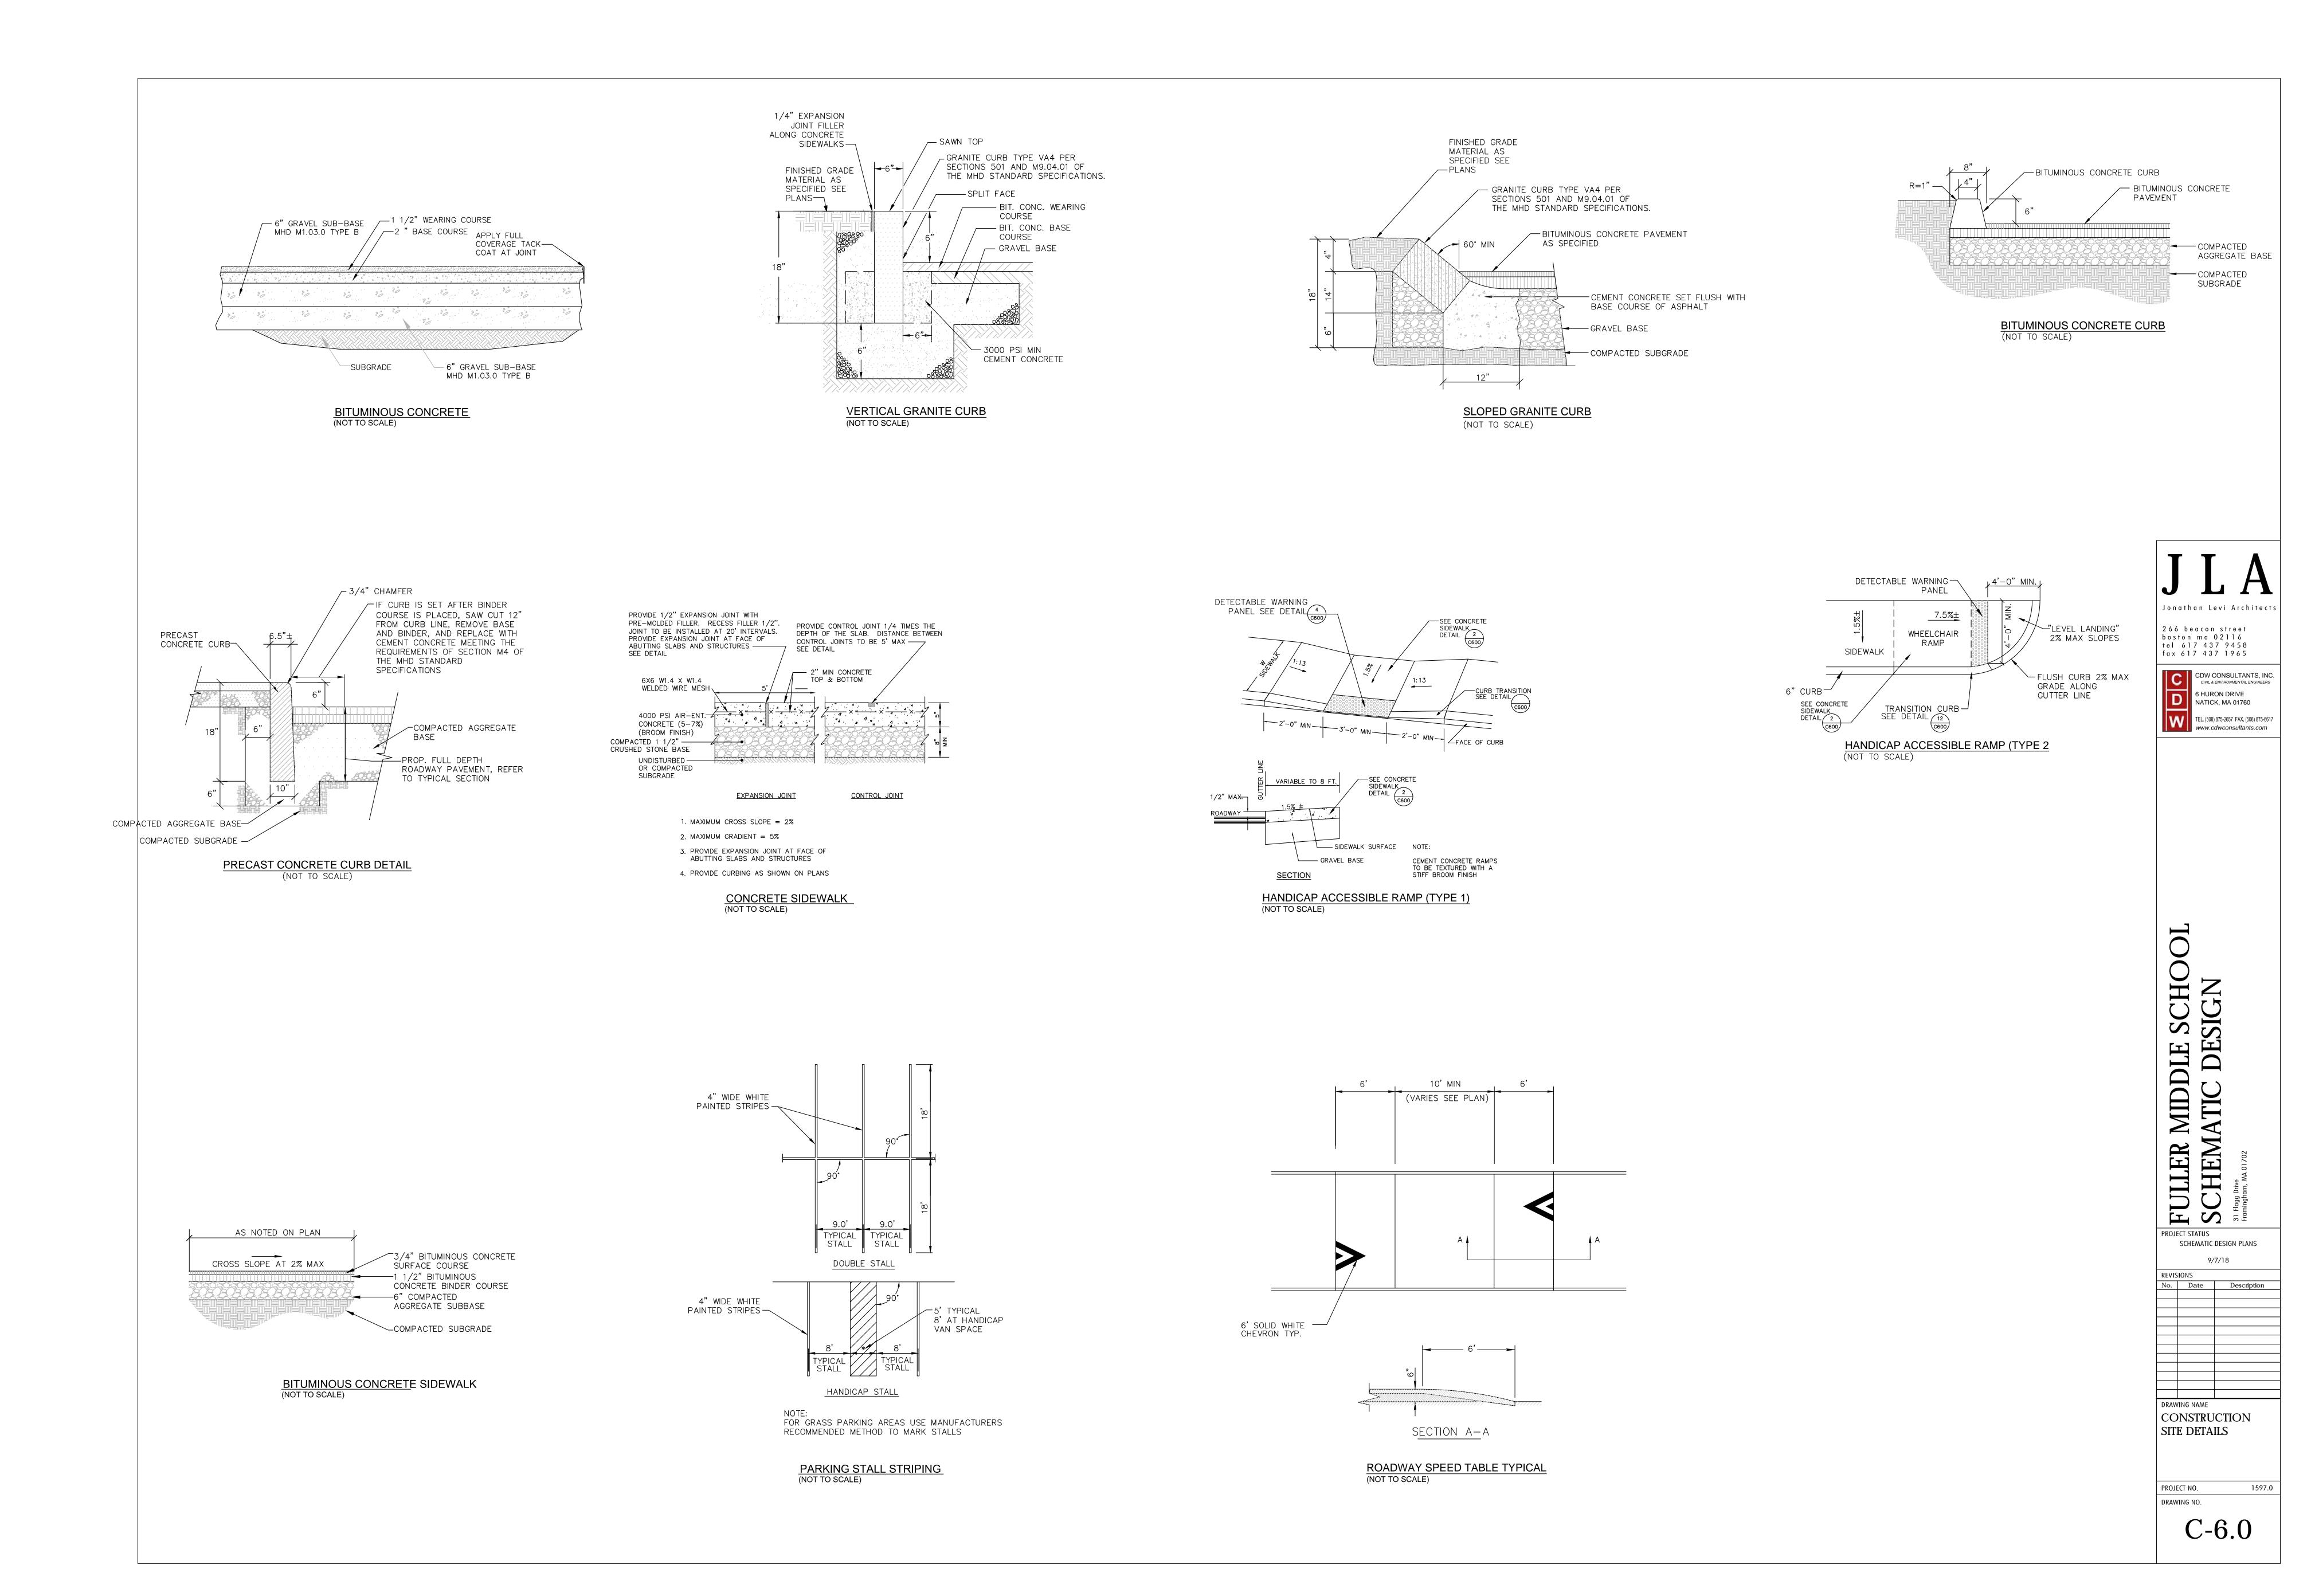

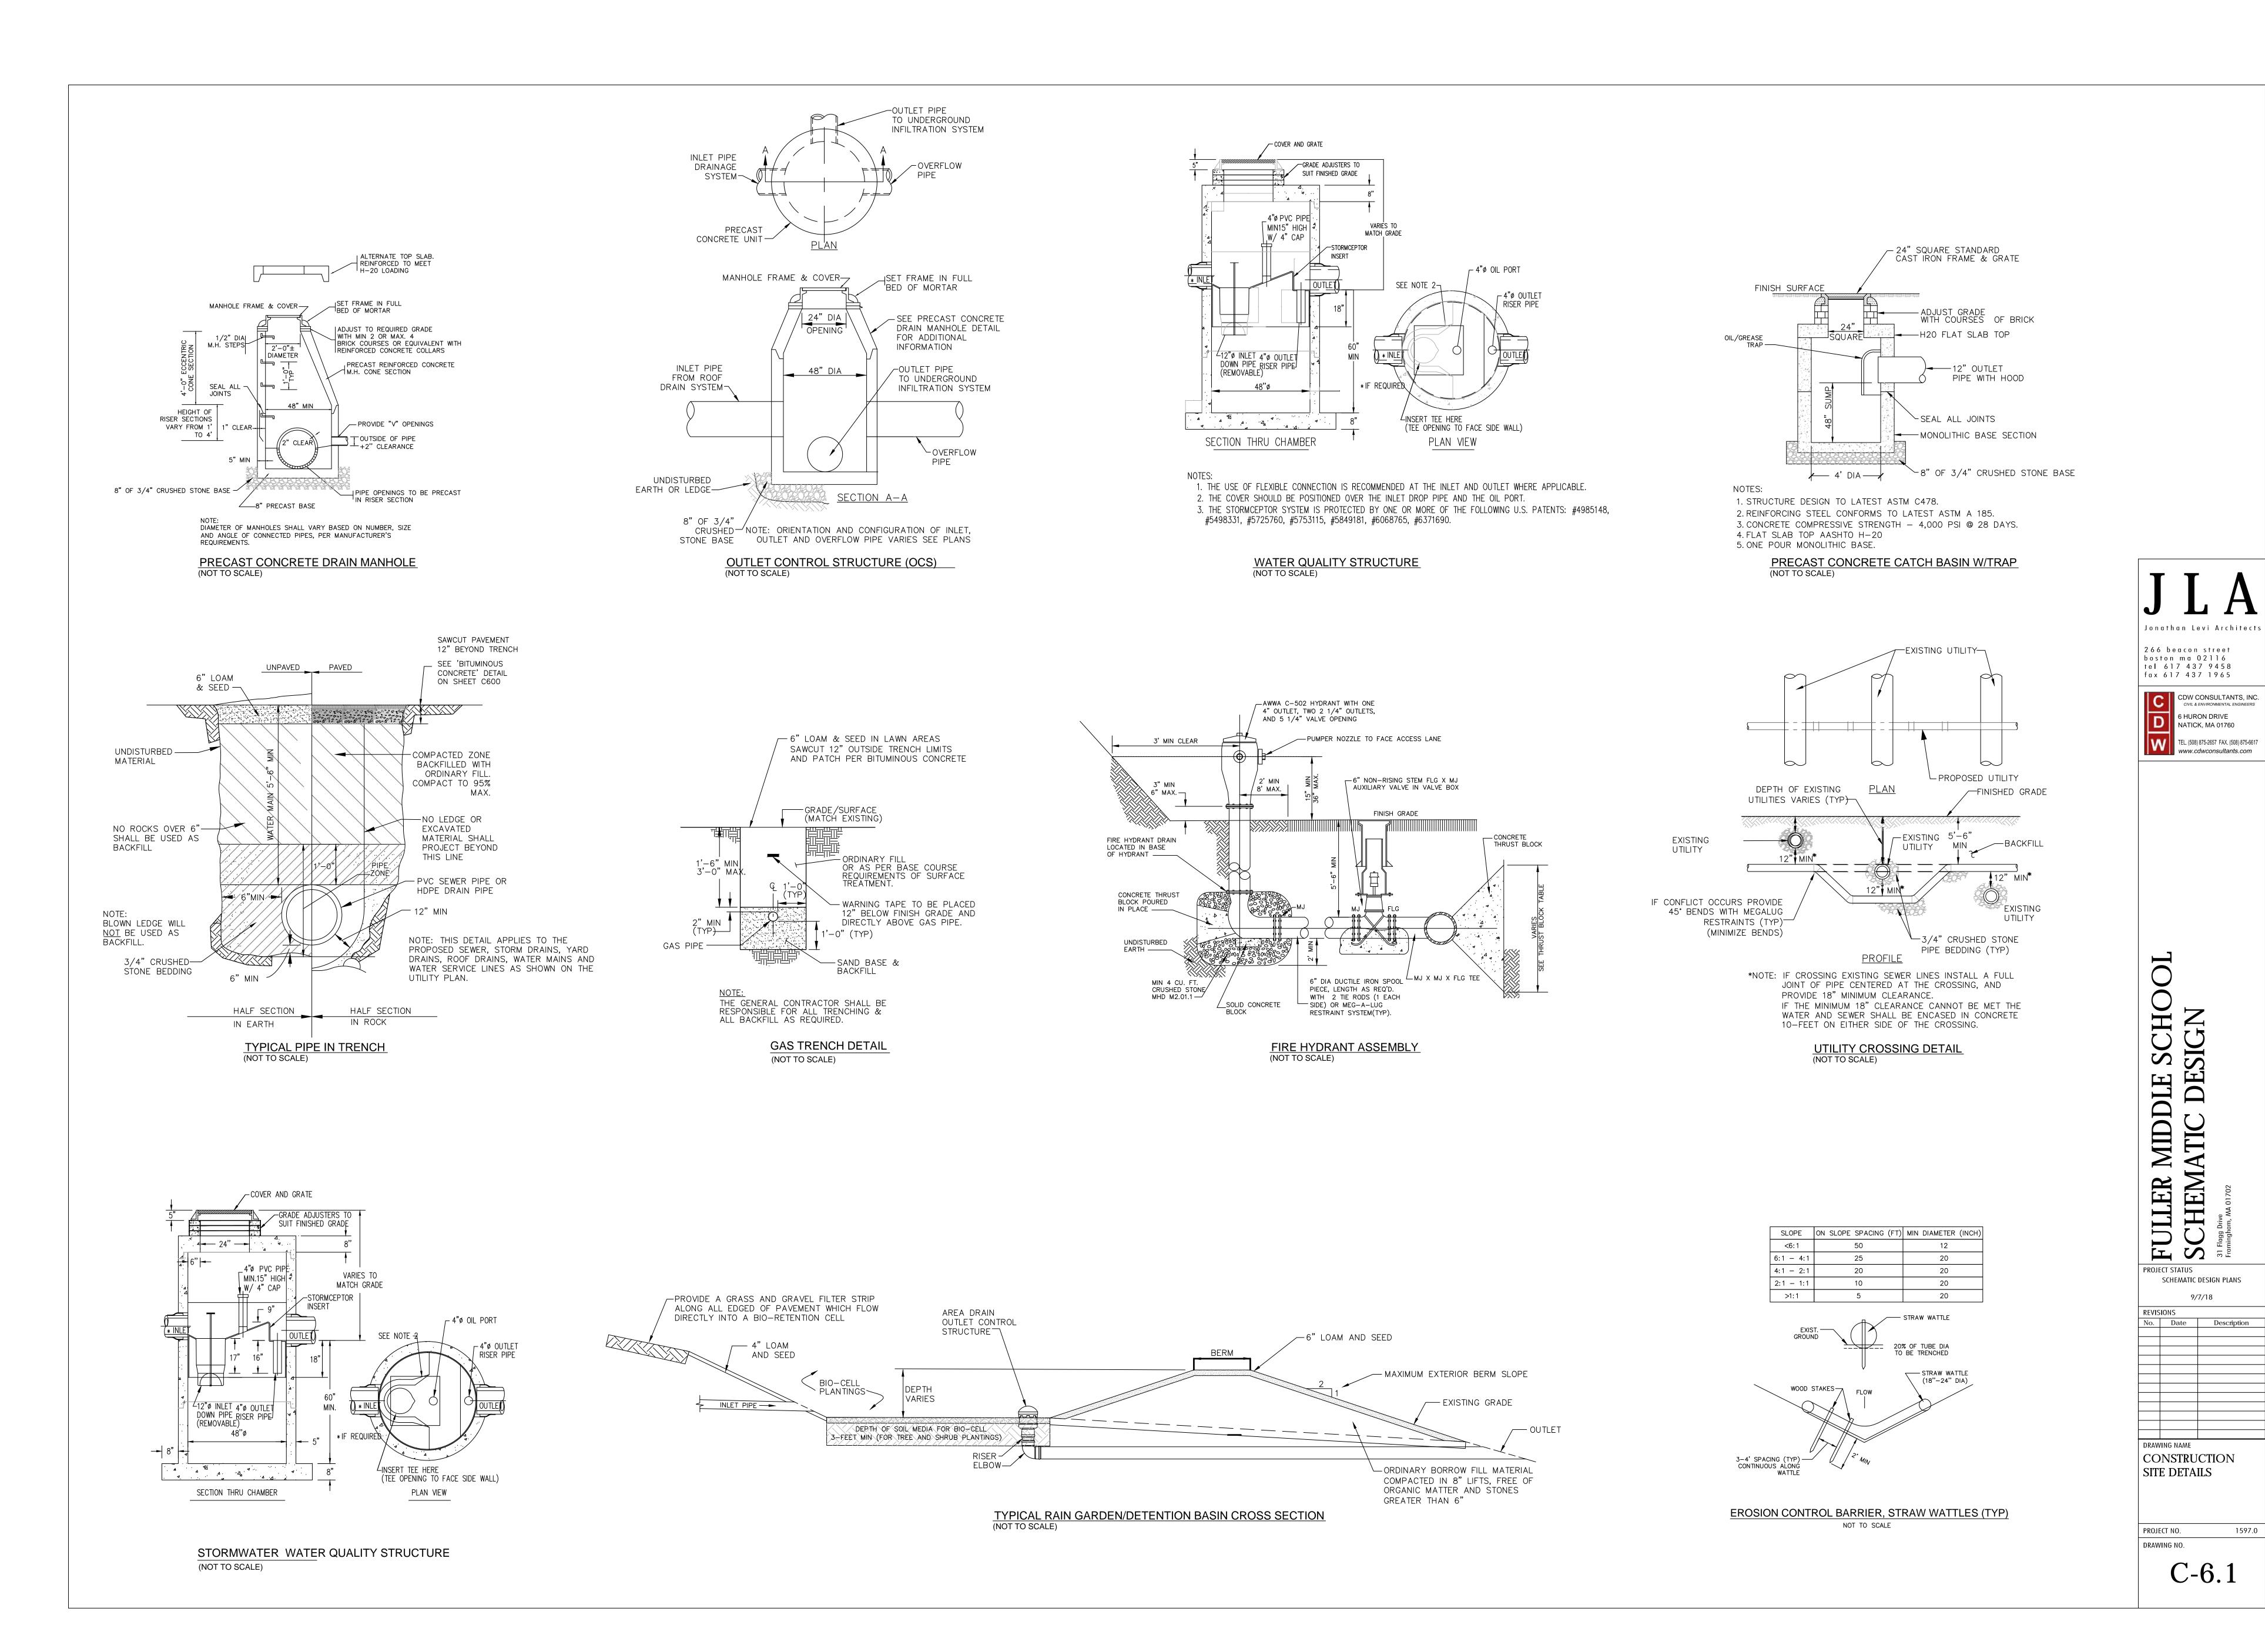


C-6.1

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HEM

9/7/18

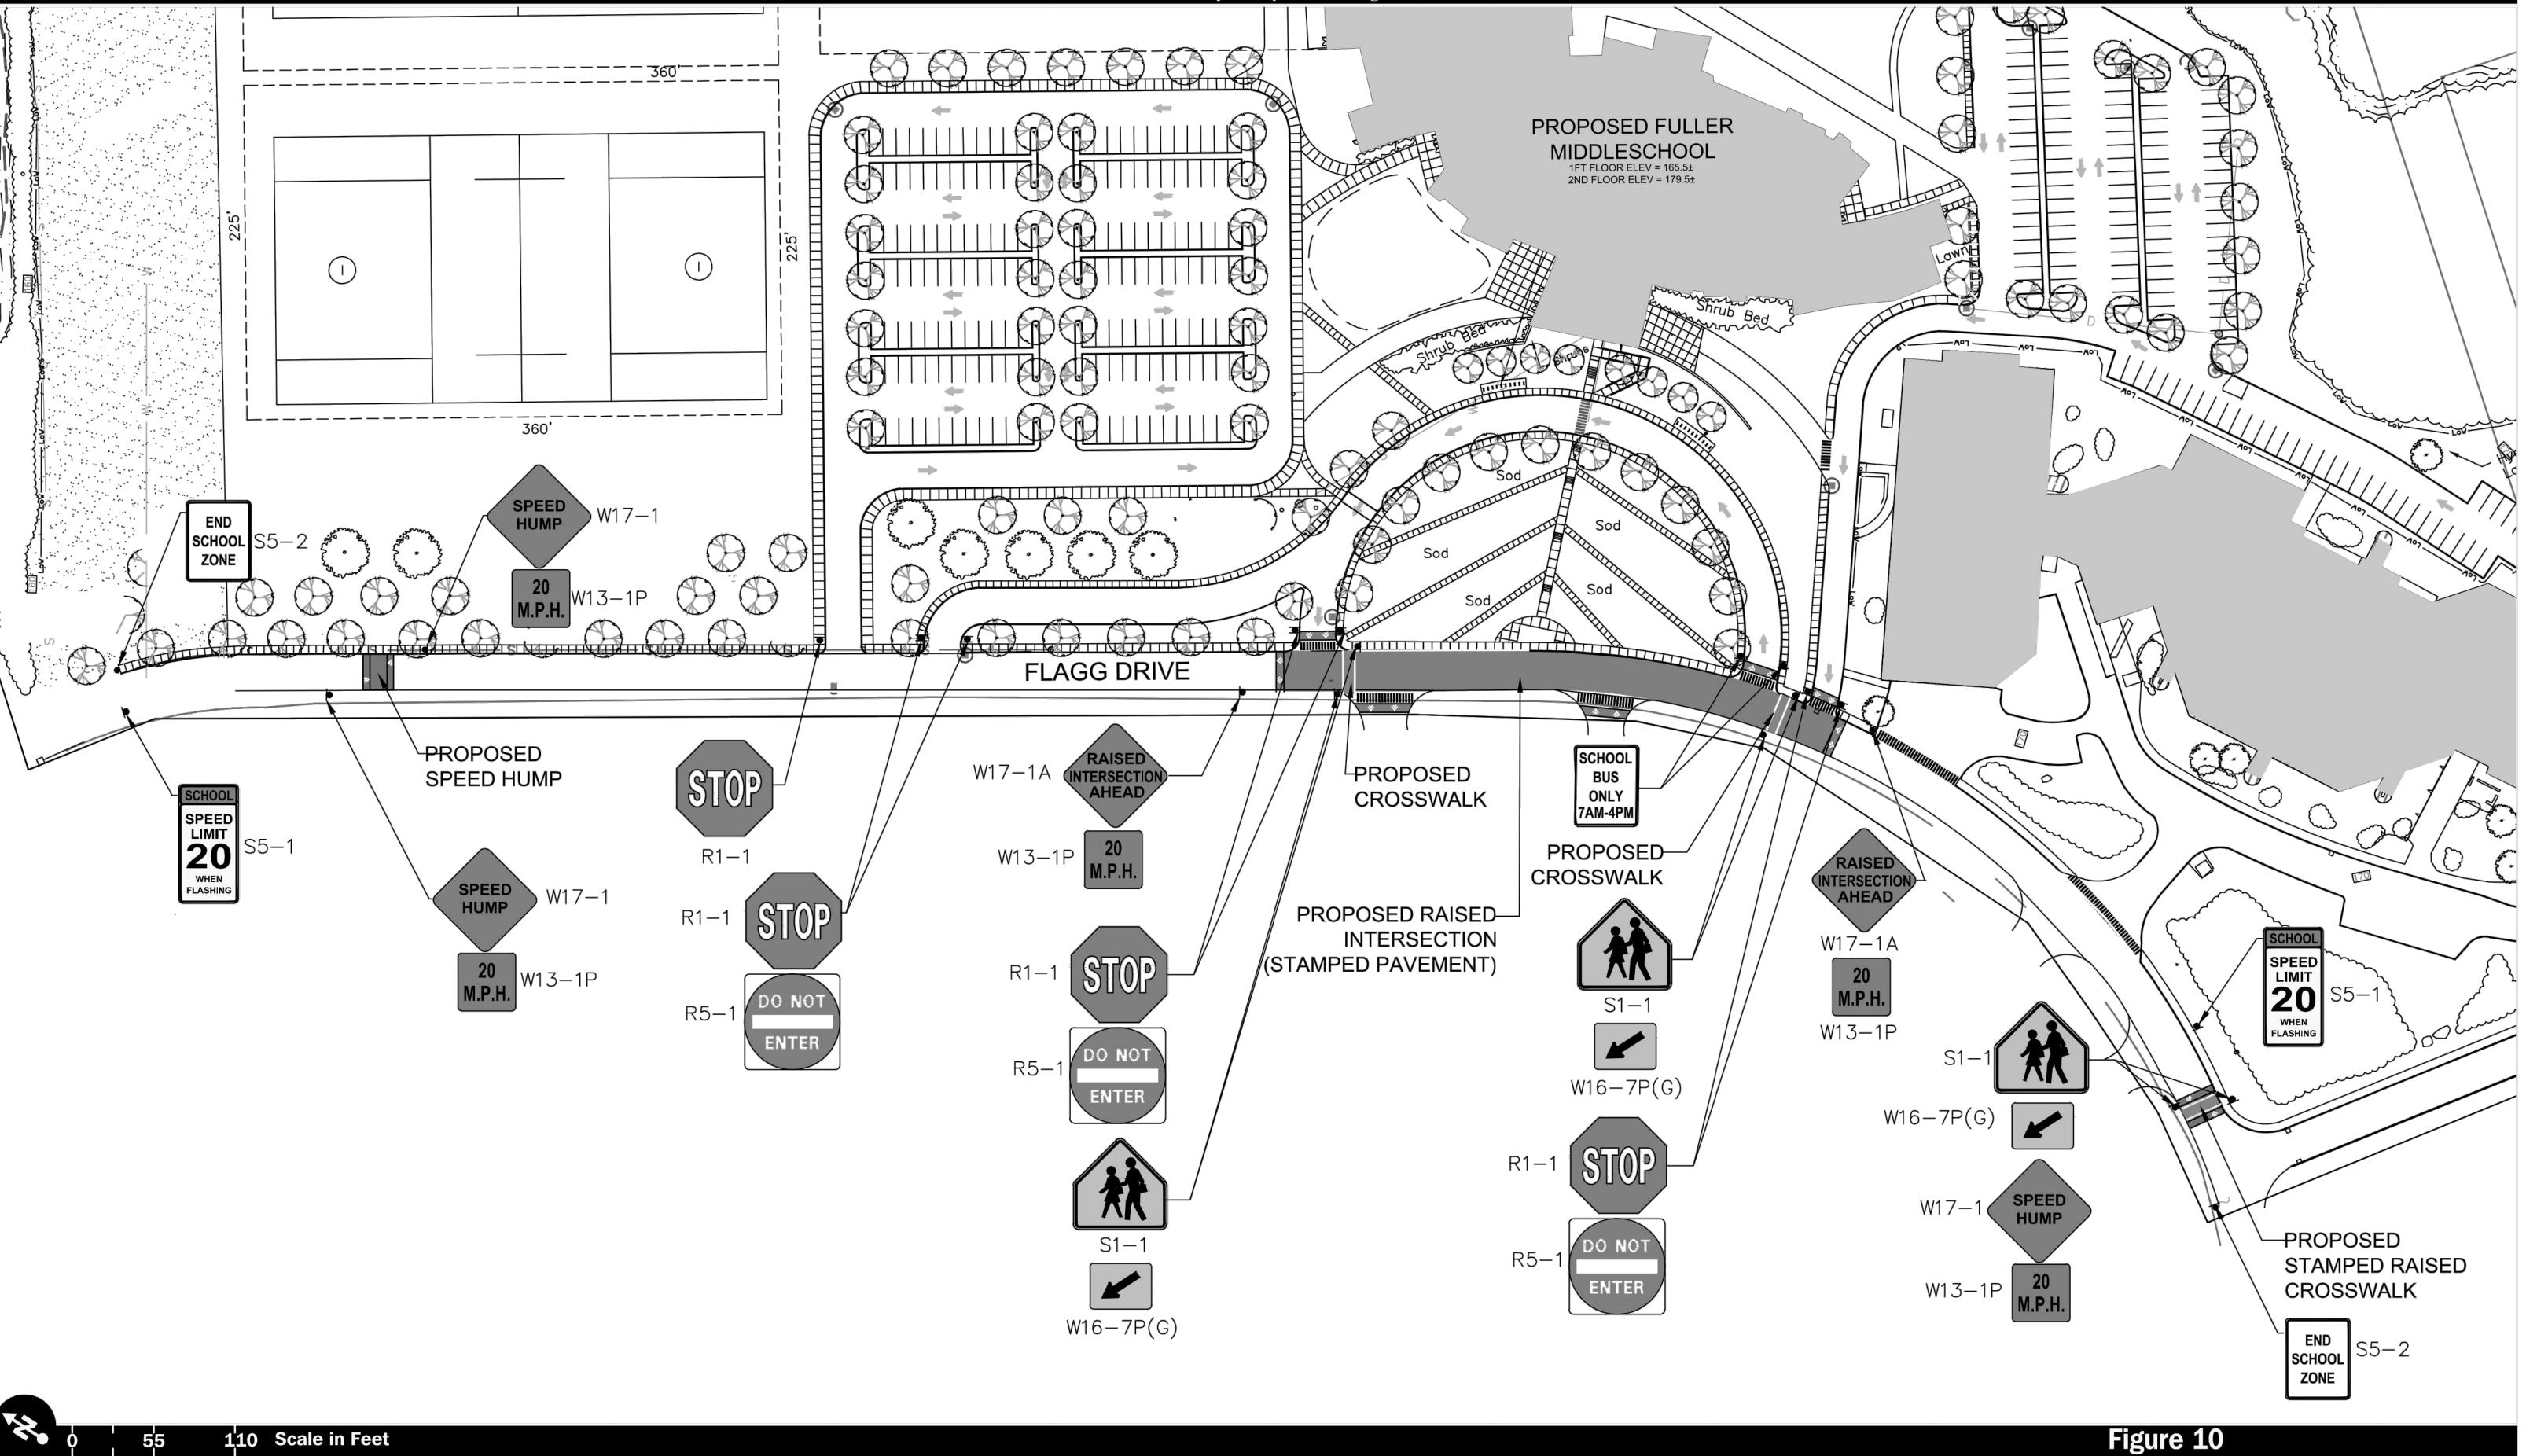

Fuller Middle School Feasibility Study - Framingham, Massachusetts

266 beacon street boston ma 02116 tel 617 437 9458 fax 617 437 1965

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FULLER MIDDLE SCHOOL
SCHEMATIC DESIGN SCHEMATIC DESIGN PLANS


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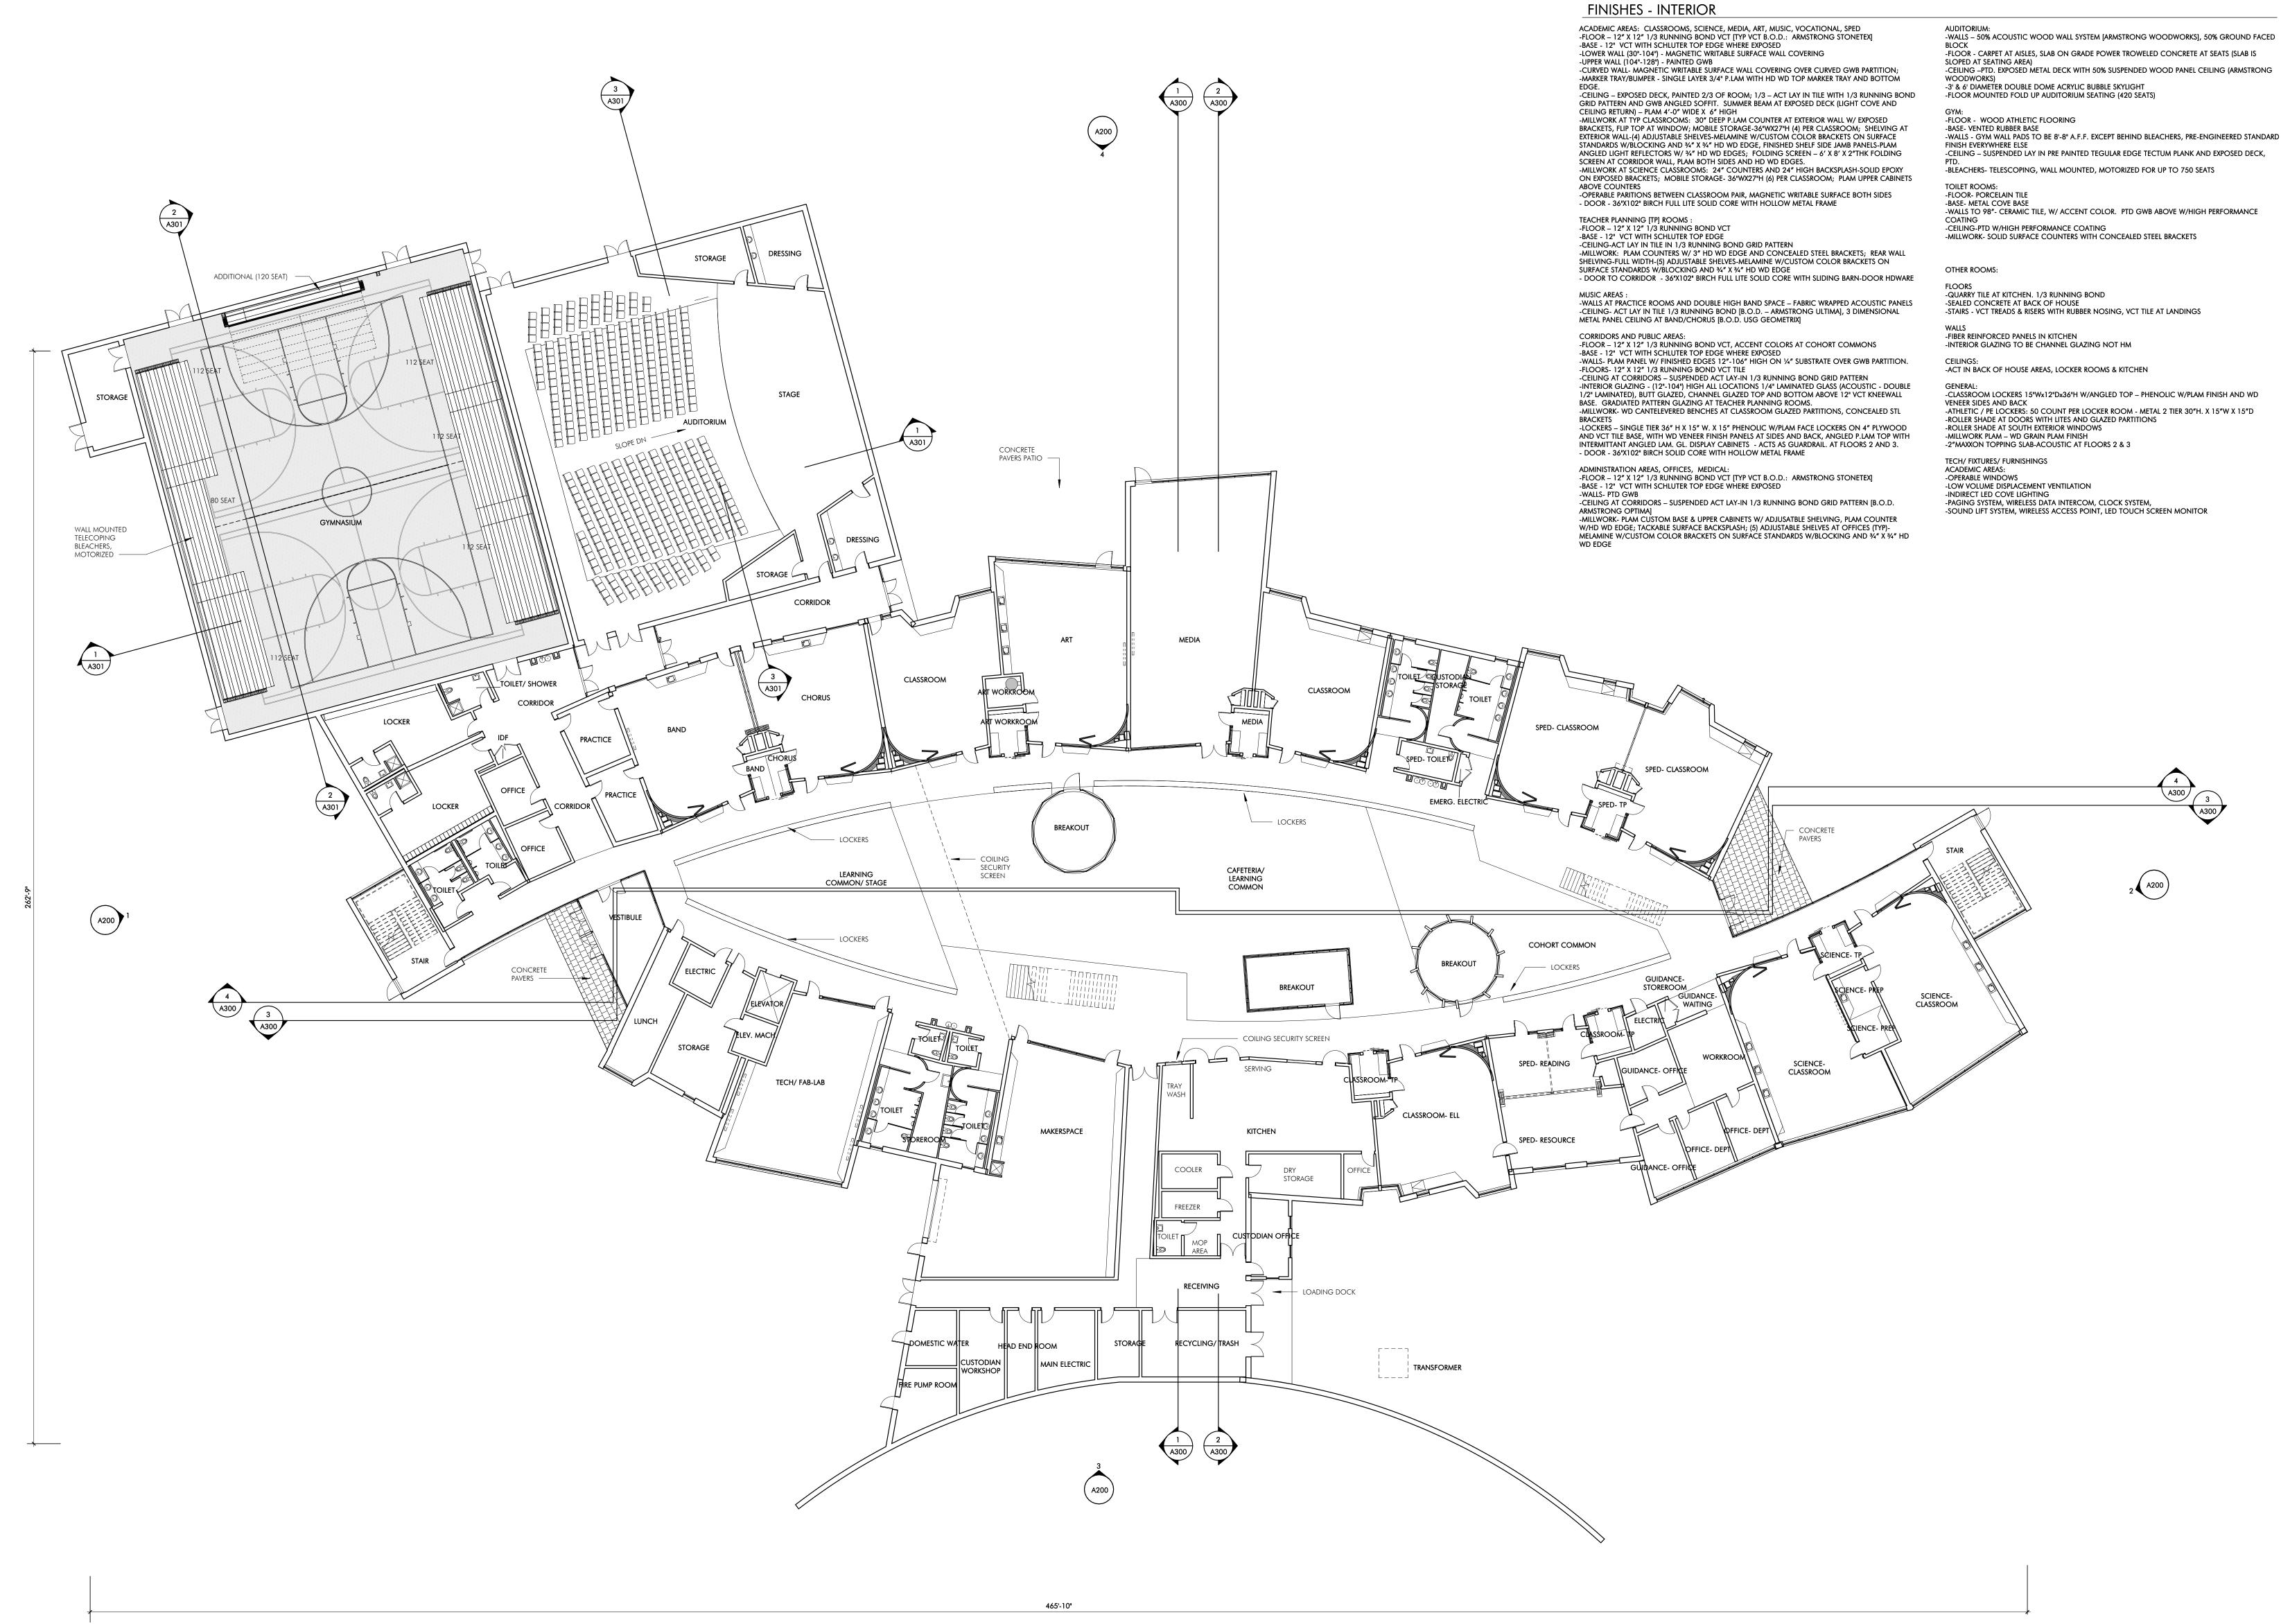
No. Date Description DRAWING NAME CONSTRUCTION SITE DETAILS

Proposed School Signage Plan

PROJECT NO. DRAWING NO.

C-6.2



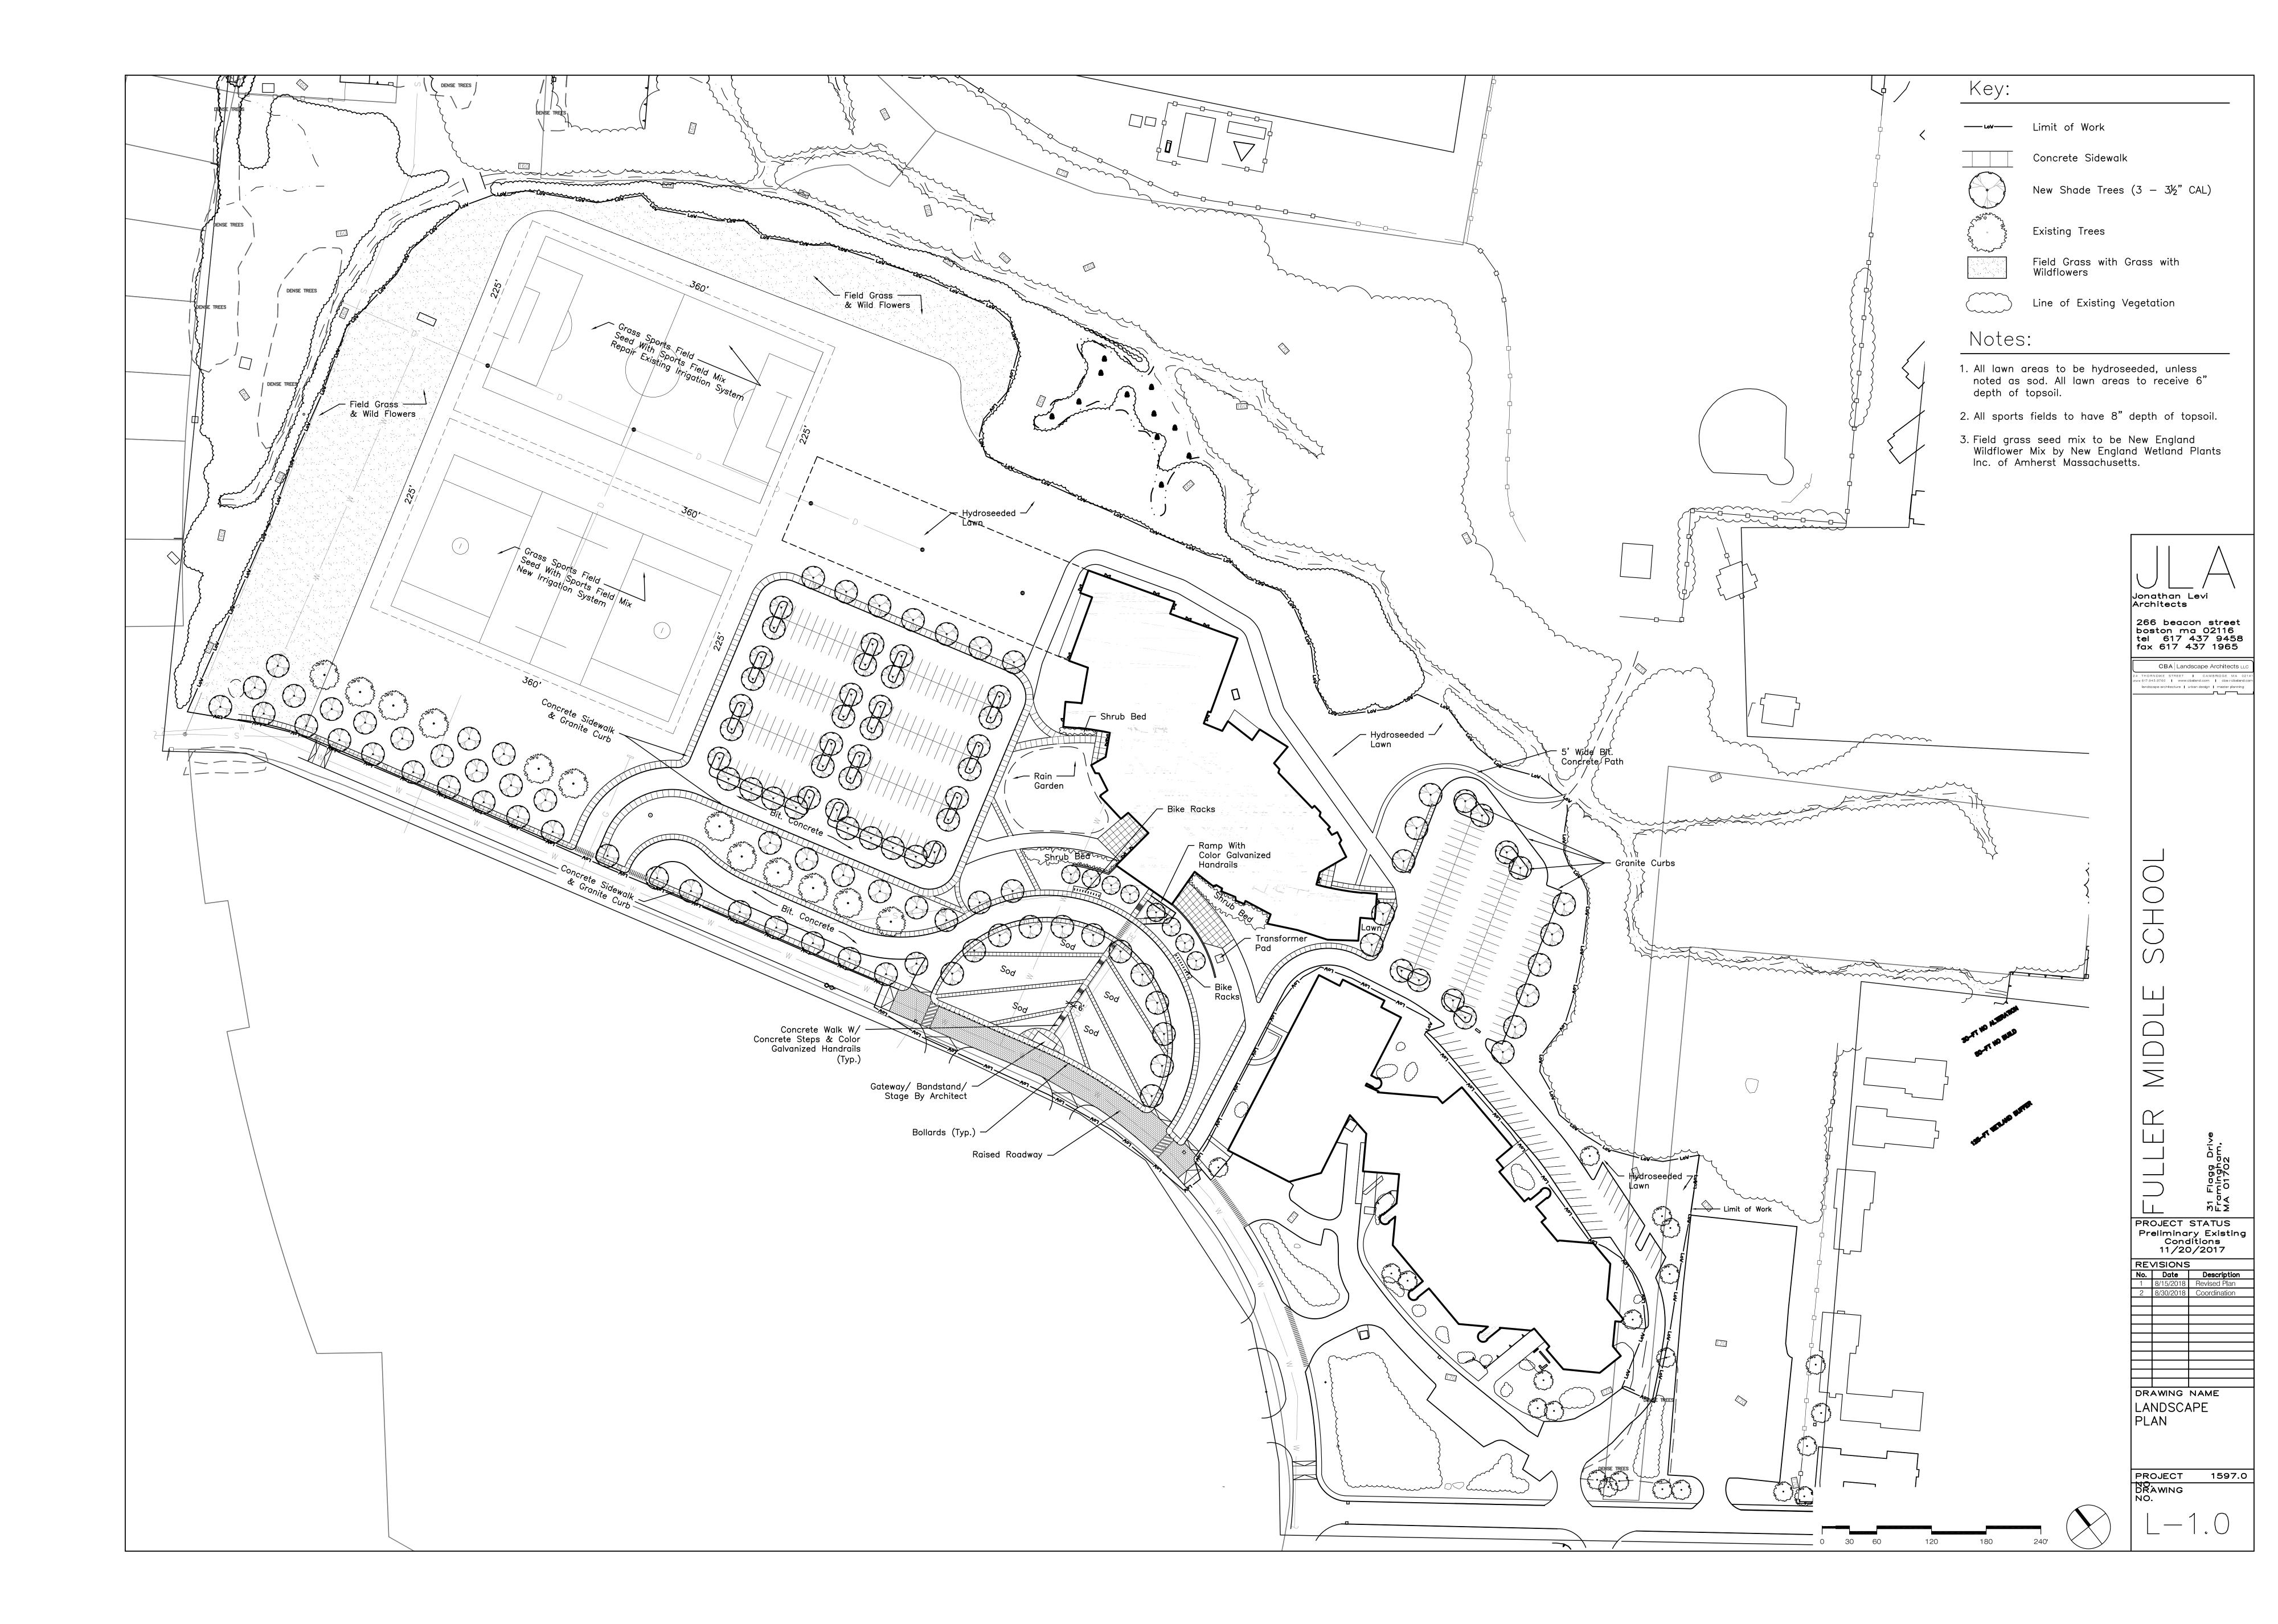

-WALLS - GYM WALL PADS TO BE 8'-8" A.F.F. EXCEPT BEHIND BLEACHERS, PRE-ENGINEERED STANDARD -CEILING – SUSPENDED LAY IN PRE PAINTED TEGULAR EDGE TECTUM PLANK AND EXPOSED DECK,

-CLASSROOM LOCKERS 15"Wx12"Dx36"H W/ANGLED TOP – PHENOLIC W/PLAM FINISH AND WD -ATHLETIC / PE LOCKERS: 50 COUNT PER LOCKER ROOM - METAL 2 TIER 30"H. X 15"W X 15"D -ROLLER SHADE AT DOORS WITH LITES AND GLAZED PARTITIONS -ROLLER SHADE AT SOUTH EXTERIOR WINDOWS

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PROJECT STATUS

REVISIONS

SCHEMATIC DESIGN 8/7/18

DRAWING NAME PLAN - FLOOR 1

PROJECT NO. Project Number



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FULLER SCHOOL
31 FLAGG DRIVE, FRAMINGHAM, MA

PROJECT STATUS

SCHEMATIC DESIGN
09/12/18

REVISIONS


No. Date Description

DRAWING NAME
PLAN - FLOOR 1-A


PROJECT NO. Project Number

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31 FLAGG DRIVE, FRAMINGHAM, MA

PROJECT STATUS

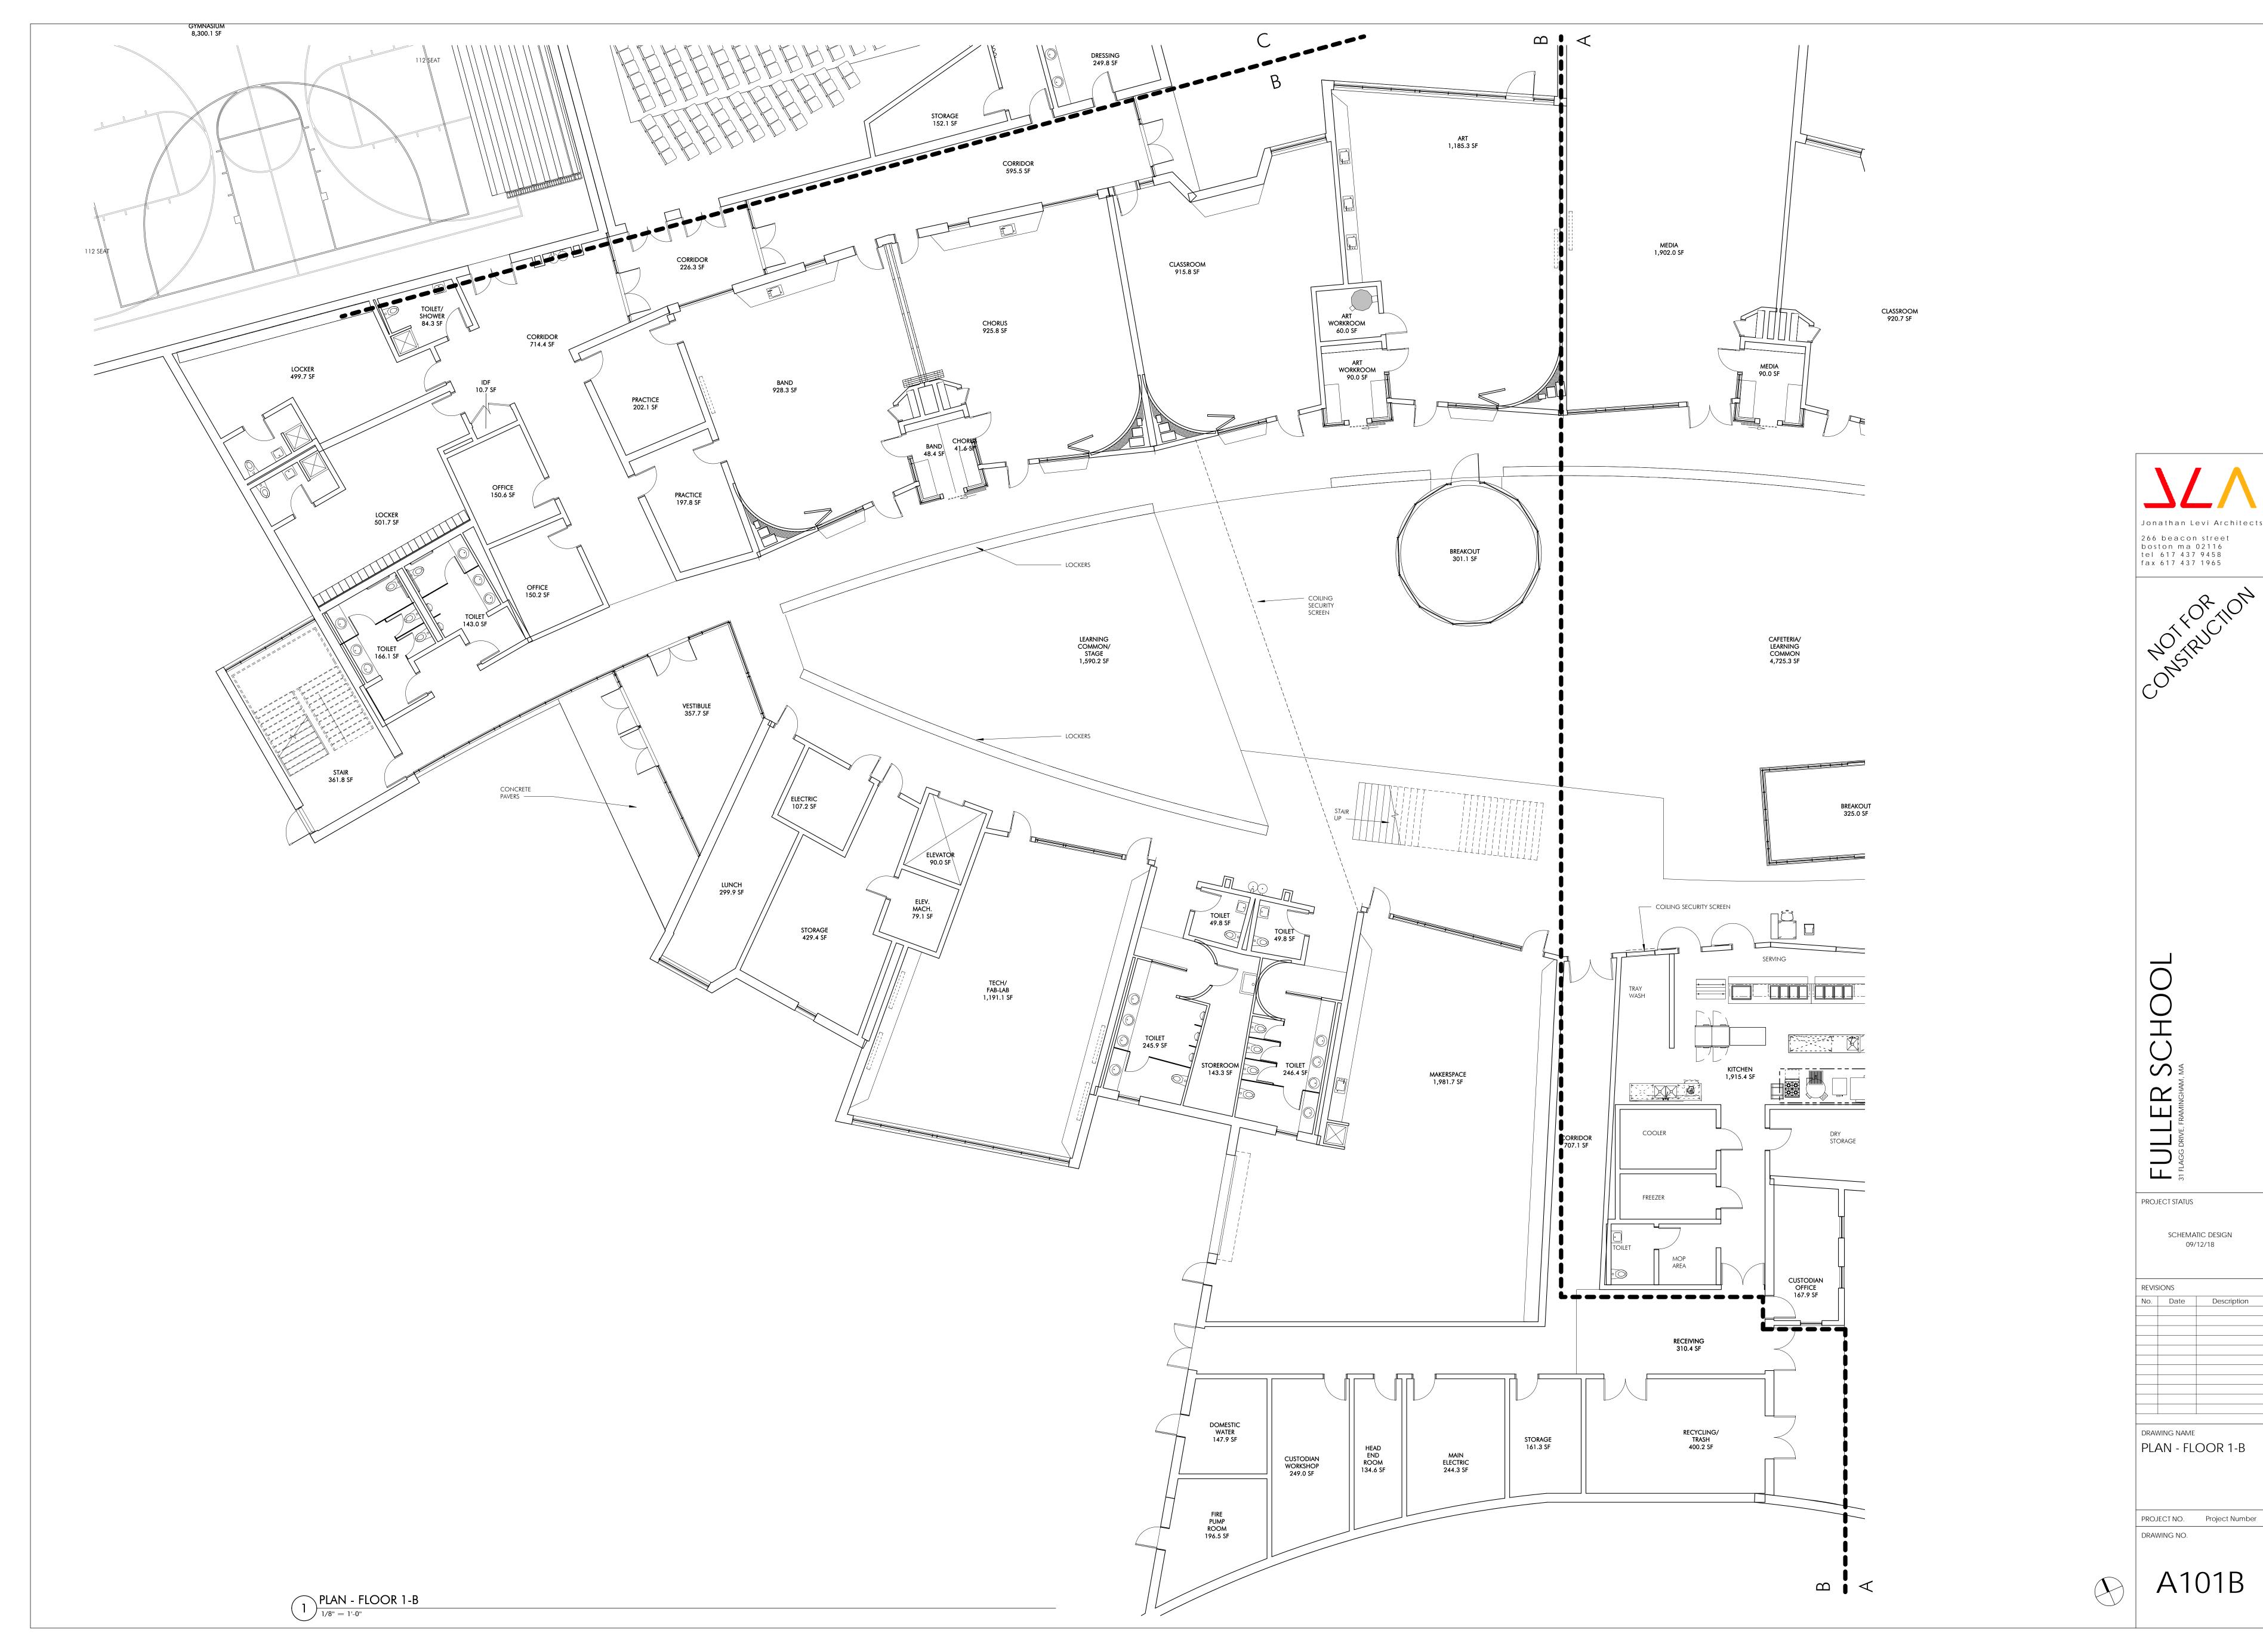SCHEMATIC DESIGN
09/12/18

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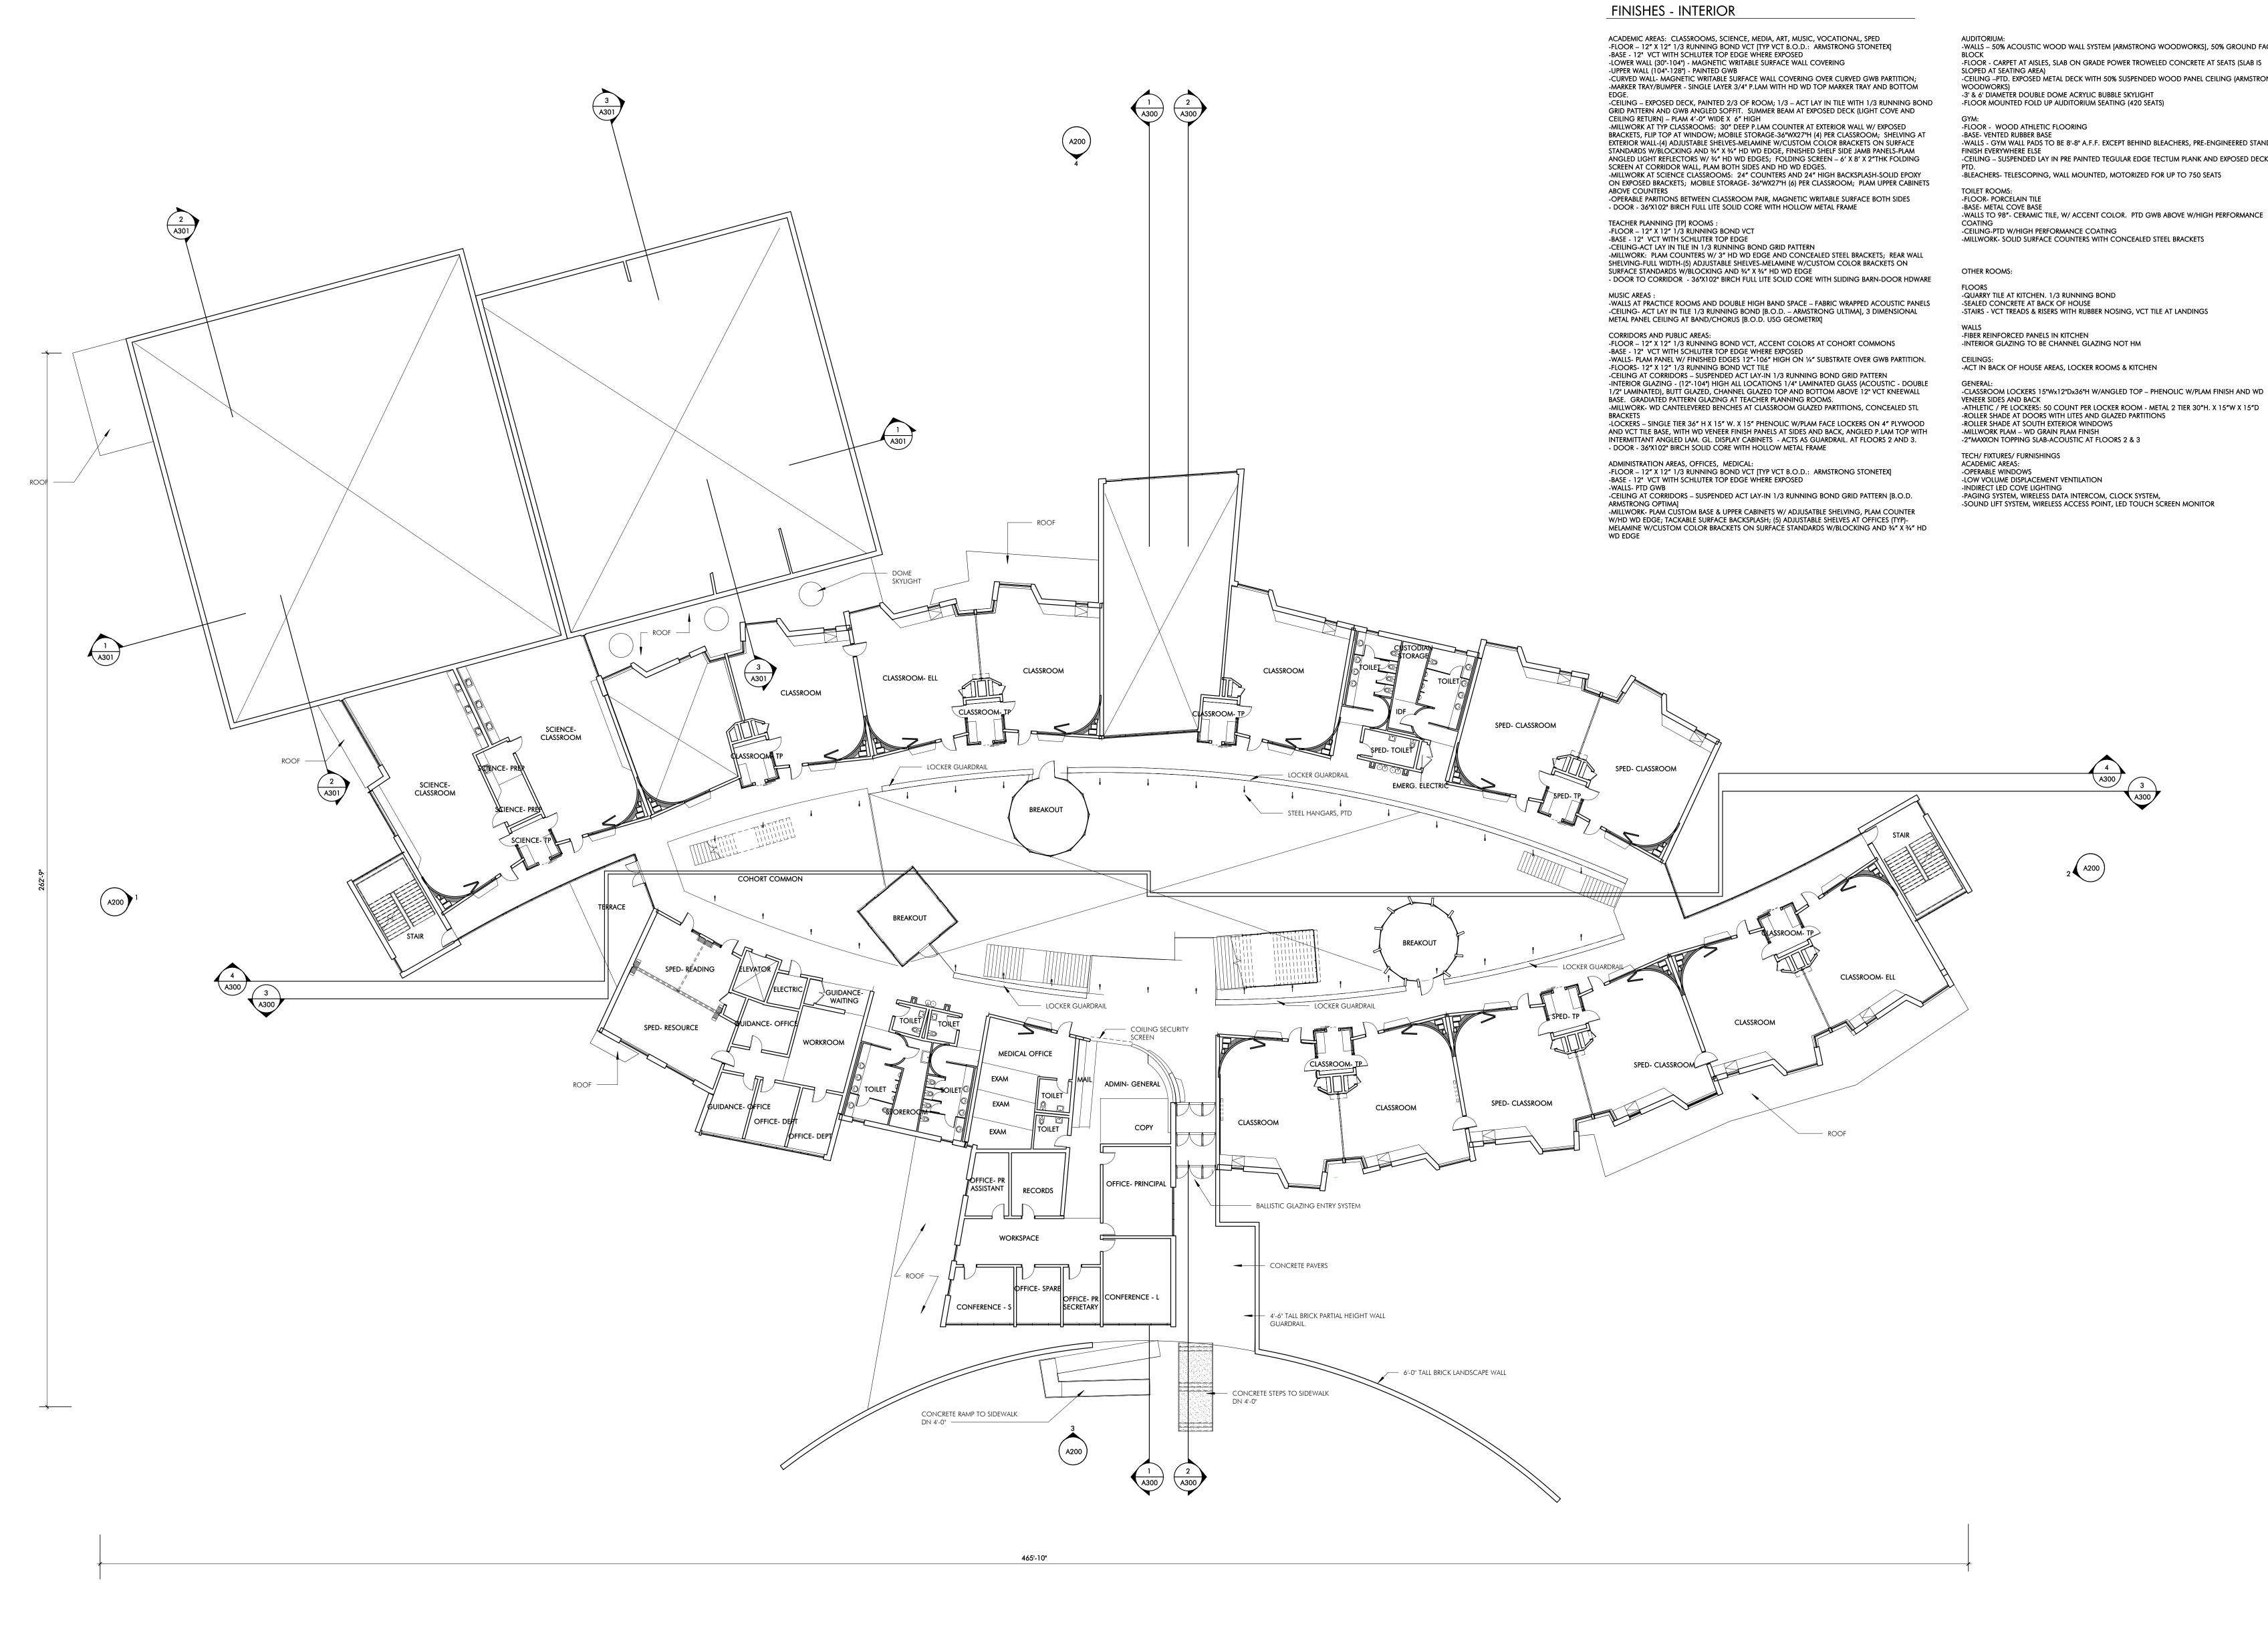
No. Date Description

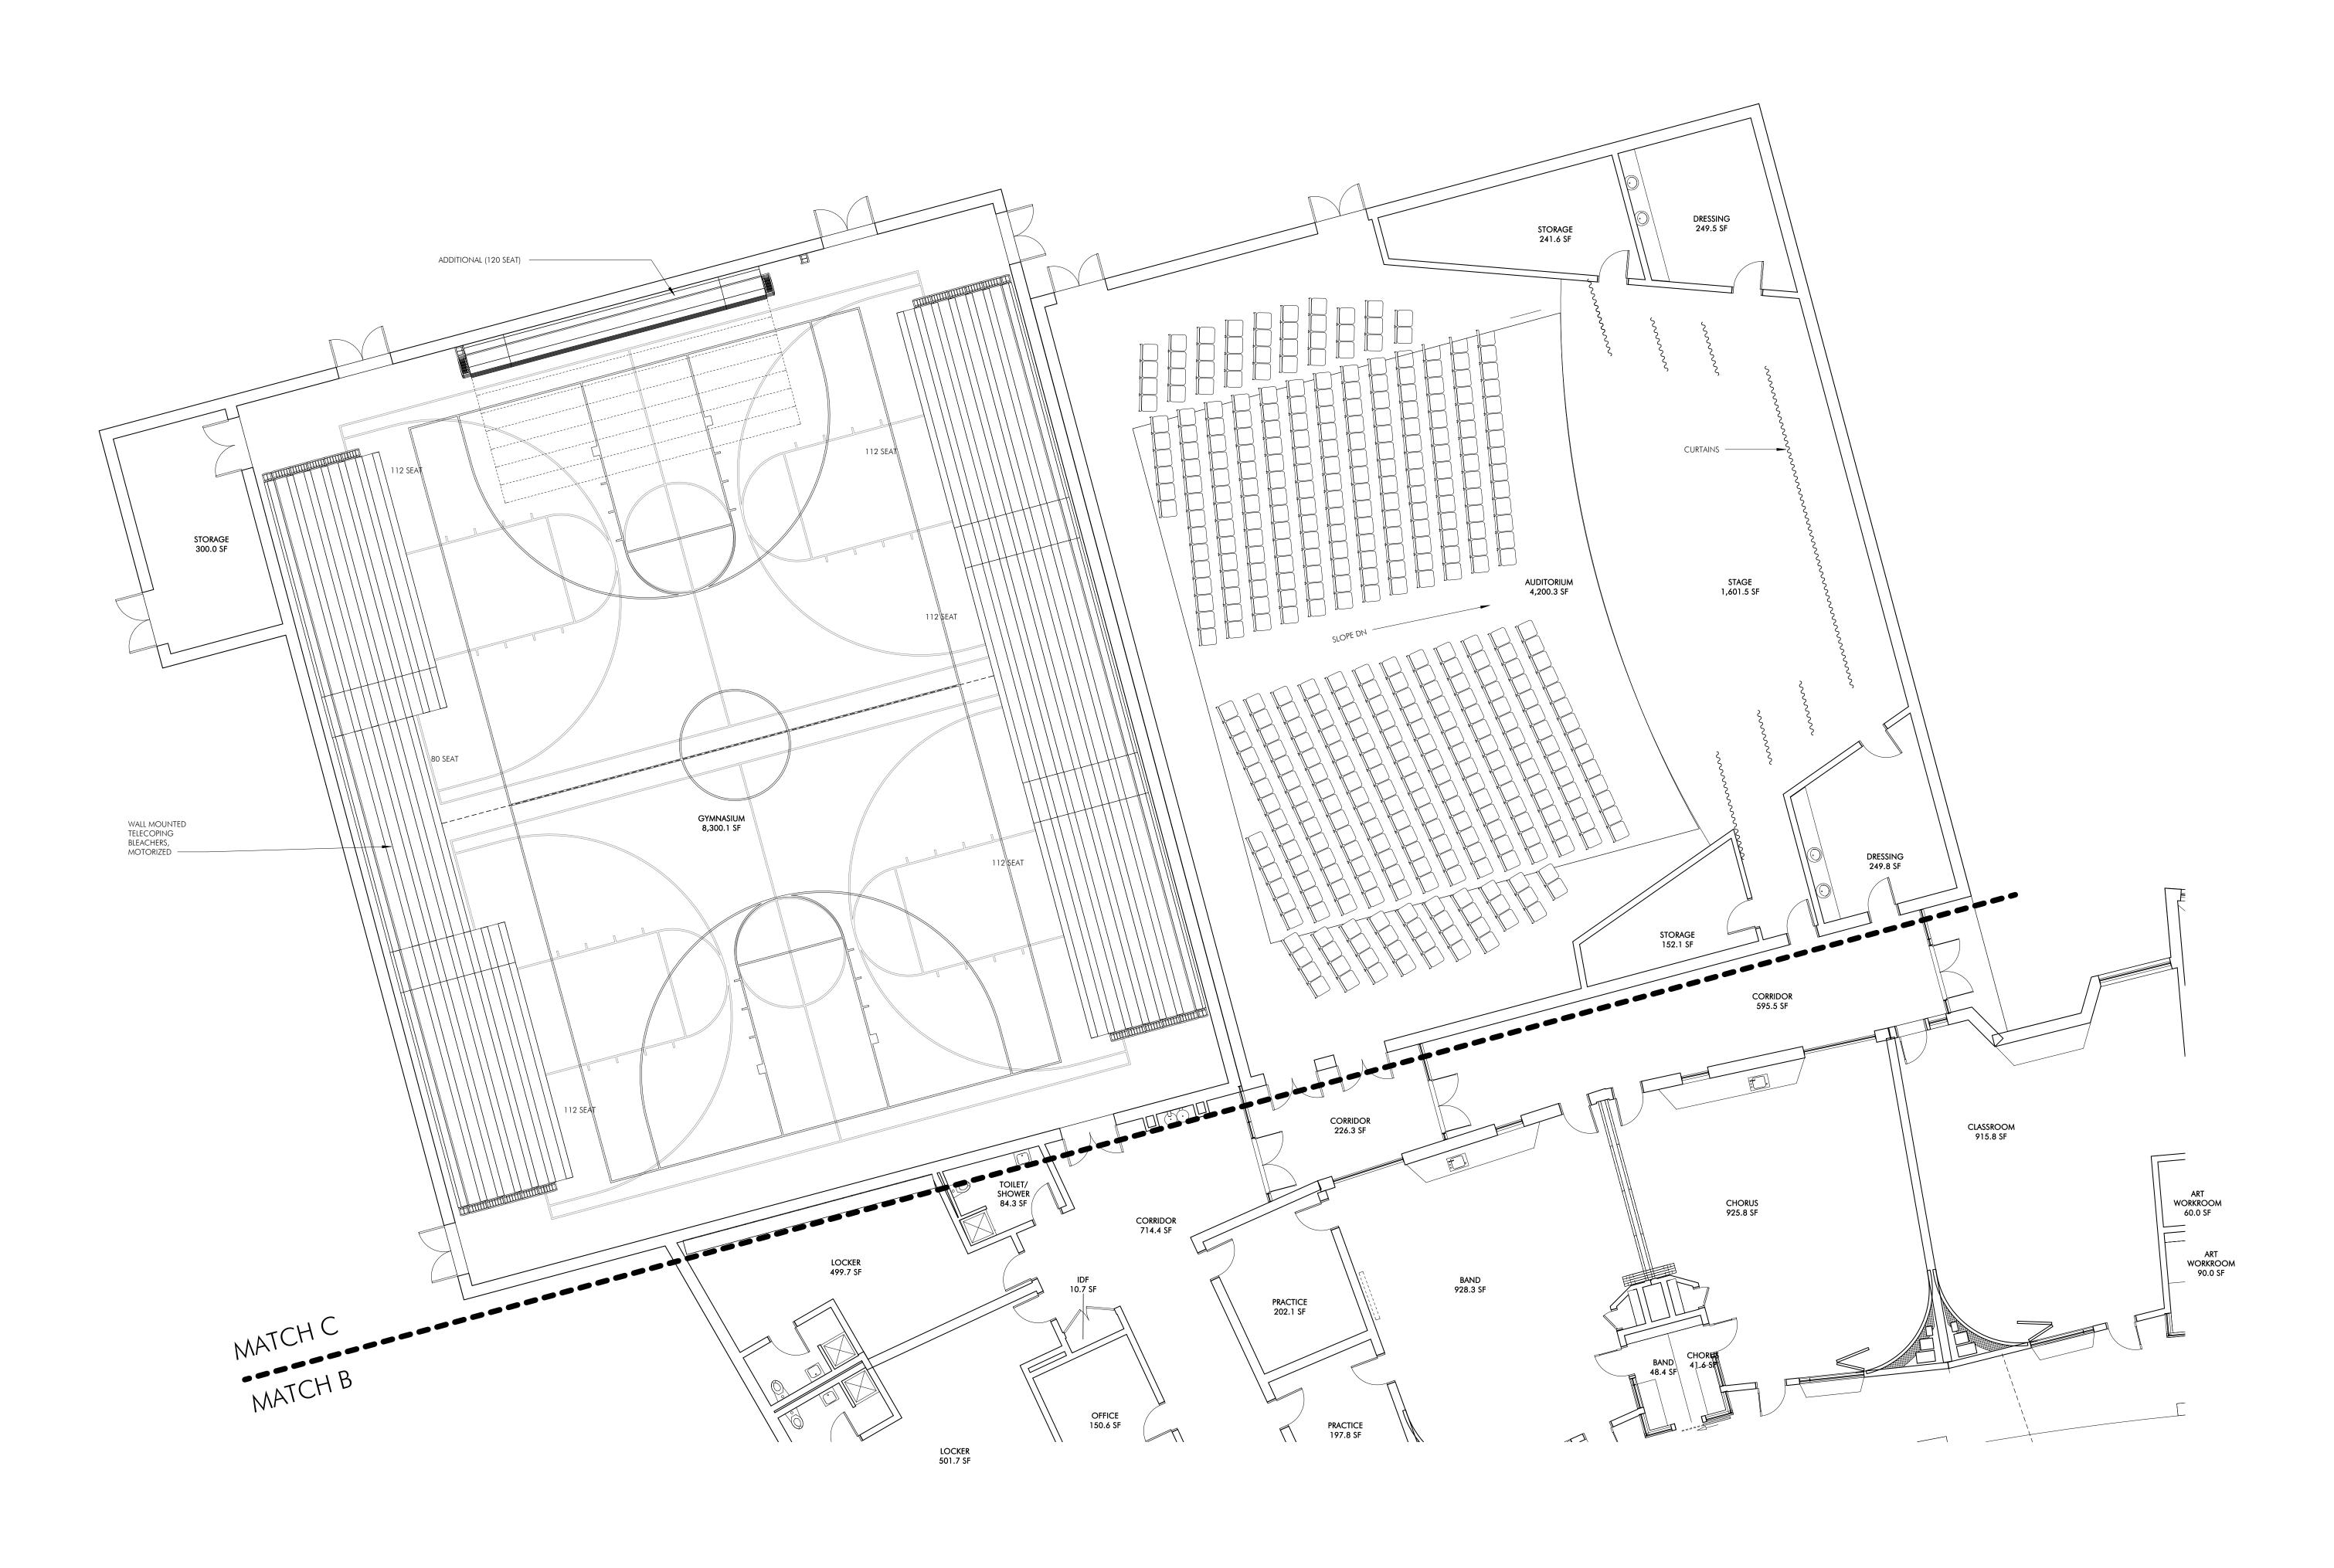DRAWING NAME
PLAN - FLOOR 1-C

PROJECT NO. Project Number

DRAWING NO.

A101C



-WALLS – 50% ACOUSTIC WOOD WALL SYSTEM [ARMSTRONG WOODWORKS], 50% GROUND FACED -FLOOR - CARPET AT AISLES, SLAB ON GRADE POWER TROWELED CONCRETE AT SEATS (SLAB IS SLOPED AT SEATING AREA)
-CEILING –PTD. EXPOSED METAL DECK WITH 50% SUSPENDED WOOD PANEL CEILING (ARMSTRONG

-WALLS - GYM WALL PADS TO BE 8'-8" A.F.F. EXCEPT BEHIND BLEACHERS, PRE-ENGINEERED STANDARD -CEILING - SUSPENDED LAY IN PRE PAINTED TEGULAR EDGE TECTUM PLANK AND EXPOSED DECK,

-CLASSROOM LOCKERS 15"Wx12"Dx36"H W/ANGLED TOP – PHENOLIC W/PLAM FINISH AND WD -ATHLETIC / PE LOCKERS: 50 COUNT PER LOCKER ROOM - METAL 2 TIER 30"H. X 15"W X 15"D

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PROJECT STATUS

8/7/18

SCHEMATIC DESIGN

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DRAWING NAME PLAN - FLOOR 2

> PROJECT NO. Project Number DRAWING NO.



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FULLER SCHOOL
31 FLAGG DRIVE, FRAMINGHAM, MA

PROJECT STATUS

REVISIONS

No. Date Description

SCHEMATIC DESIGN 09/12/18

PLAN - FLOOR 2-A

PROJECT NO. Project Number
DRAWING NO.



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FULLER SCHOOL
31 FLAGG DRIVE, FRAMINGHAM, MA

PROJECT STATUS

SCHEMATIC DESIGN
09/12/18

REVISIONS


No. Date Description

DRAWING NAME
PLAN - FLOOR 2-C

PROJECT NO. Project Number

DRAWING NO.

A102C

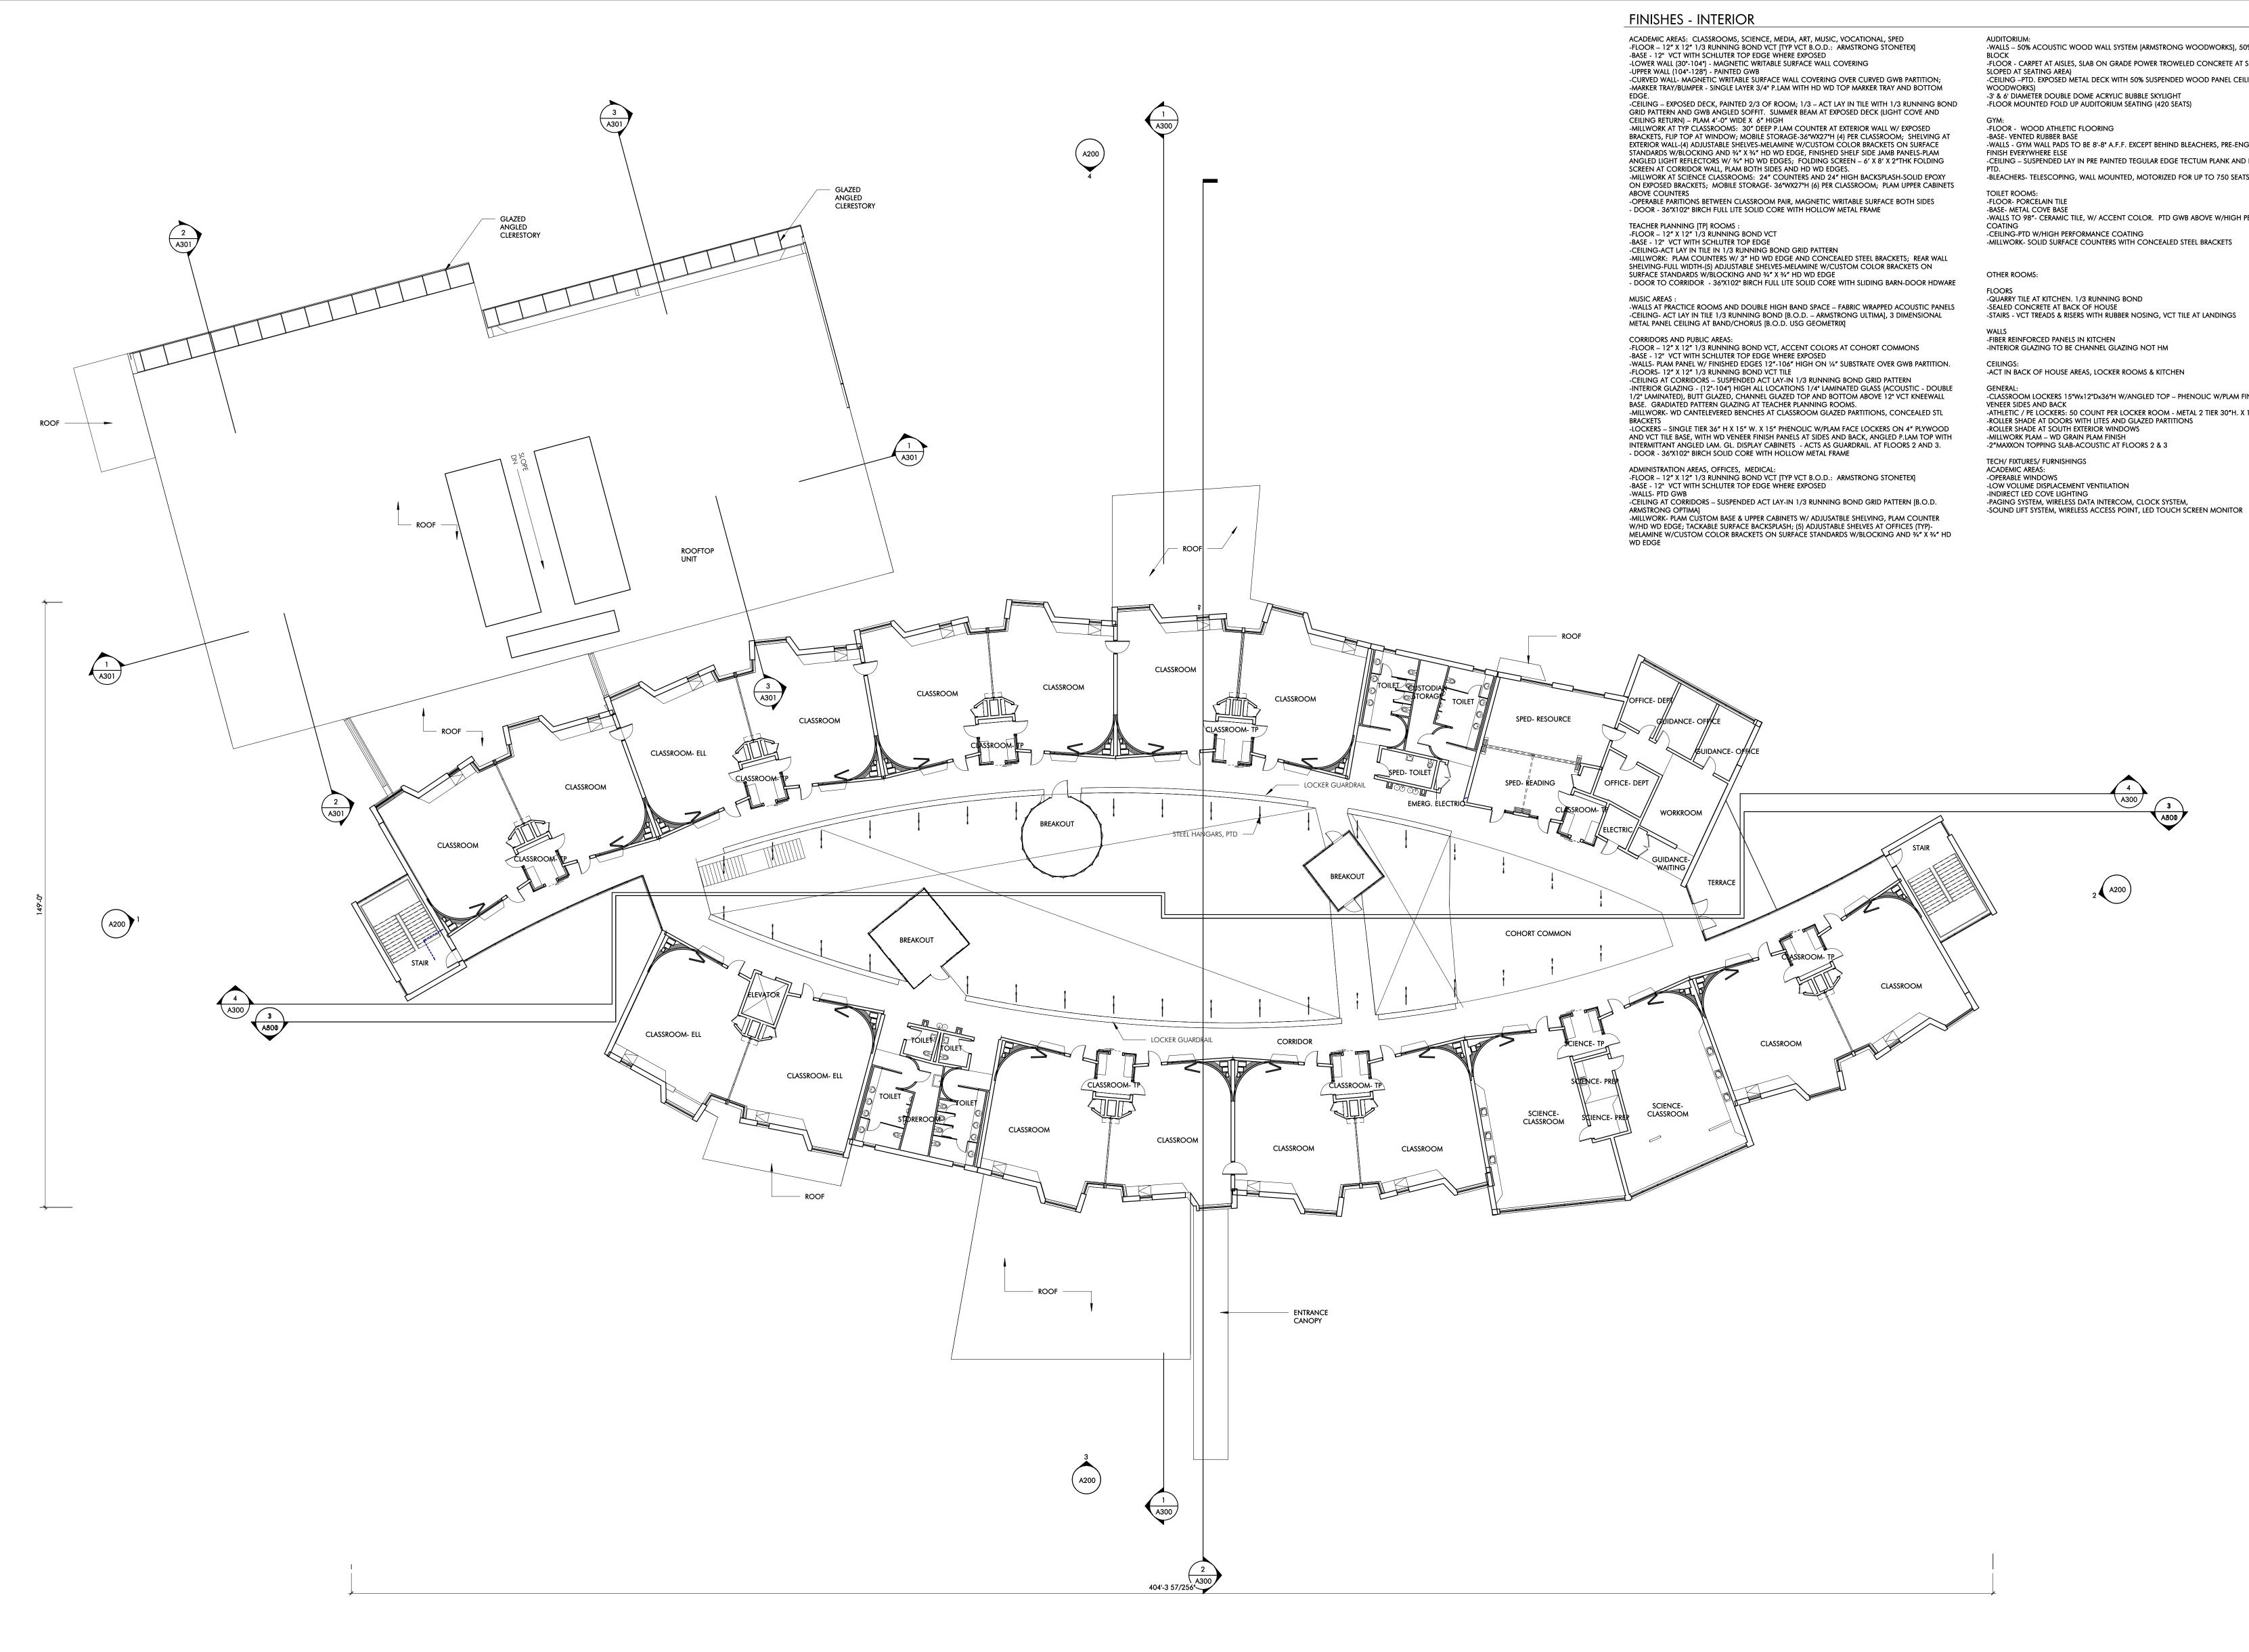

-WALLS – 50% ACOUSTIC WOOD WALL SYSTEM [ARMSTRONG WOODWORKS], 50% GROUND FACED -FLOOR - CARPET AT AISLES, SLAB ON GRADE POWER TROWELED CONCRETE AT SEATS (SLAB IS SLOPED AT SEATING AREA)
-CEILING -PTM. EXPOSED METAL DECK WITH 50% SUSPENDED WOOD PANEL CEILING (ARMSTRONG

-WALLS - GYM WALL PADS TO BE 8'-8" A.F.F. EXCEPT BEHIND BLEACHERS, PRE-ENGINEERED STANDARD -CEILING – SUSPENDED LAY IN PRE PAINTED TEGULAR EDGE TECTUM PLANK AND EXPOSED DECK, -BLEACHERS- TELESCOPING, WALL MOUNTED, MOTORIZED FOR UP TO 750 SEATS

-WALLS TO 98"- CERAMIC TILE, W/ ACCENT COLOR. PTD GWB ABOVE W/HIGH PERFORMANCE

-CLASSROOM LOCKERS 15"Wx12"Dx36"H W/ANGLED TOP – PHENOLIC W/PLAM FINISH AND WD VENEER SIDES AND BACK
-ATHLETIC / PE LOCKERS: 50 COUNT PER LOCKER ROOM - METAL 2 TIER 30"H. X 15"W X 15"D

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PROJECT STATUS

REVISIONS

SCHEMATIC DESIGN

DRAWING NAME PLAN - FLOOR 3

PROJECT NO. Project Number





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FULLER SCHOOL
31 FLAGG DRIVE, FRAMINGHAM, MA

PROJECT STATUS

REVISIONS

No. Date Description

SCHEMATIC DESIGN 09/12/18

PLAN - FLOOR 3-A

PROJECT NO. Project Number

DRAWING NO.



A103A





MOTFORTION

FULLER SCHOOL
31 FLAGG DRIVE, FRAMINGHAM, MA

PROJECT STATUS

REVISIONS

No. Date Description

SCHEMATIC DESIGN 09/12/18

PLAN - FLOOR 3-B

PROJECT NO. Project Number

DRAWING NO.

A103B

PLAN - FLOOR 3-C

1/8" = 1'-0"



MOTRUCTION

FULLER SCHOOL
31 FLAGG DRIVE, FRAMINGHAM, MA

SCHEMATIC DESIGN 09/12/18


REVISIONS

No. Date Description

PLAN - FLOOR 3-C

PROJECT NO. Project Number

DRAWING NO.

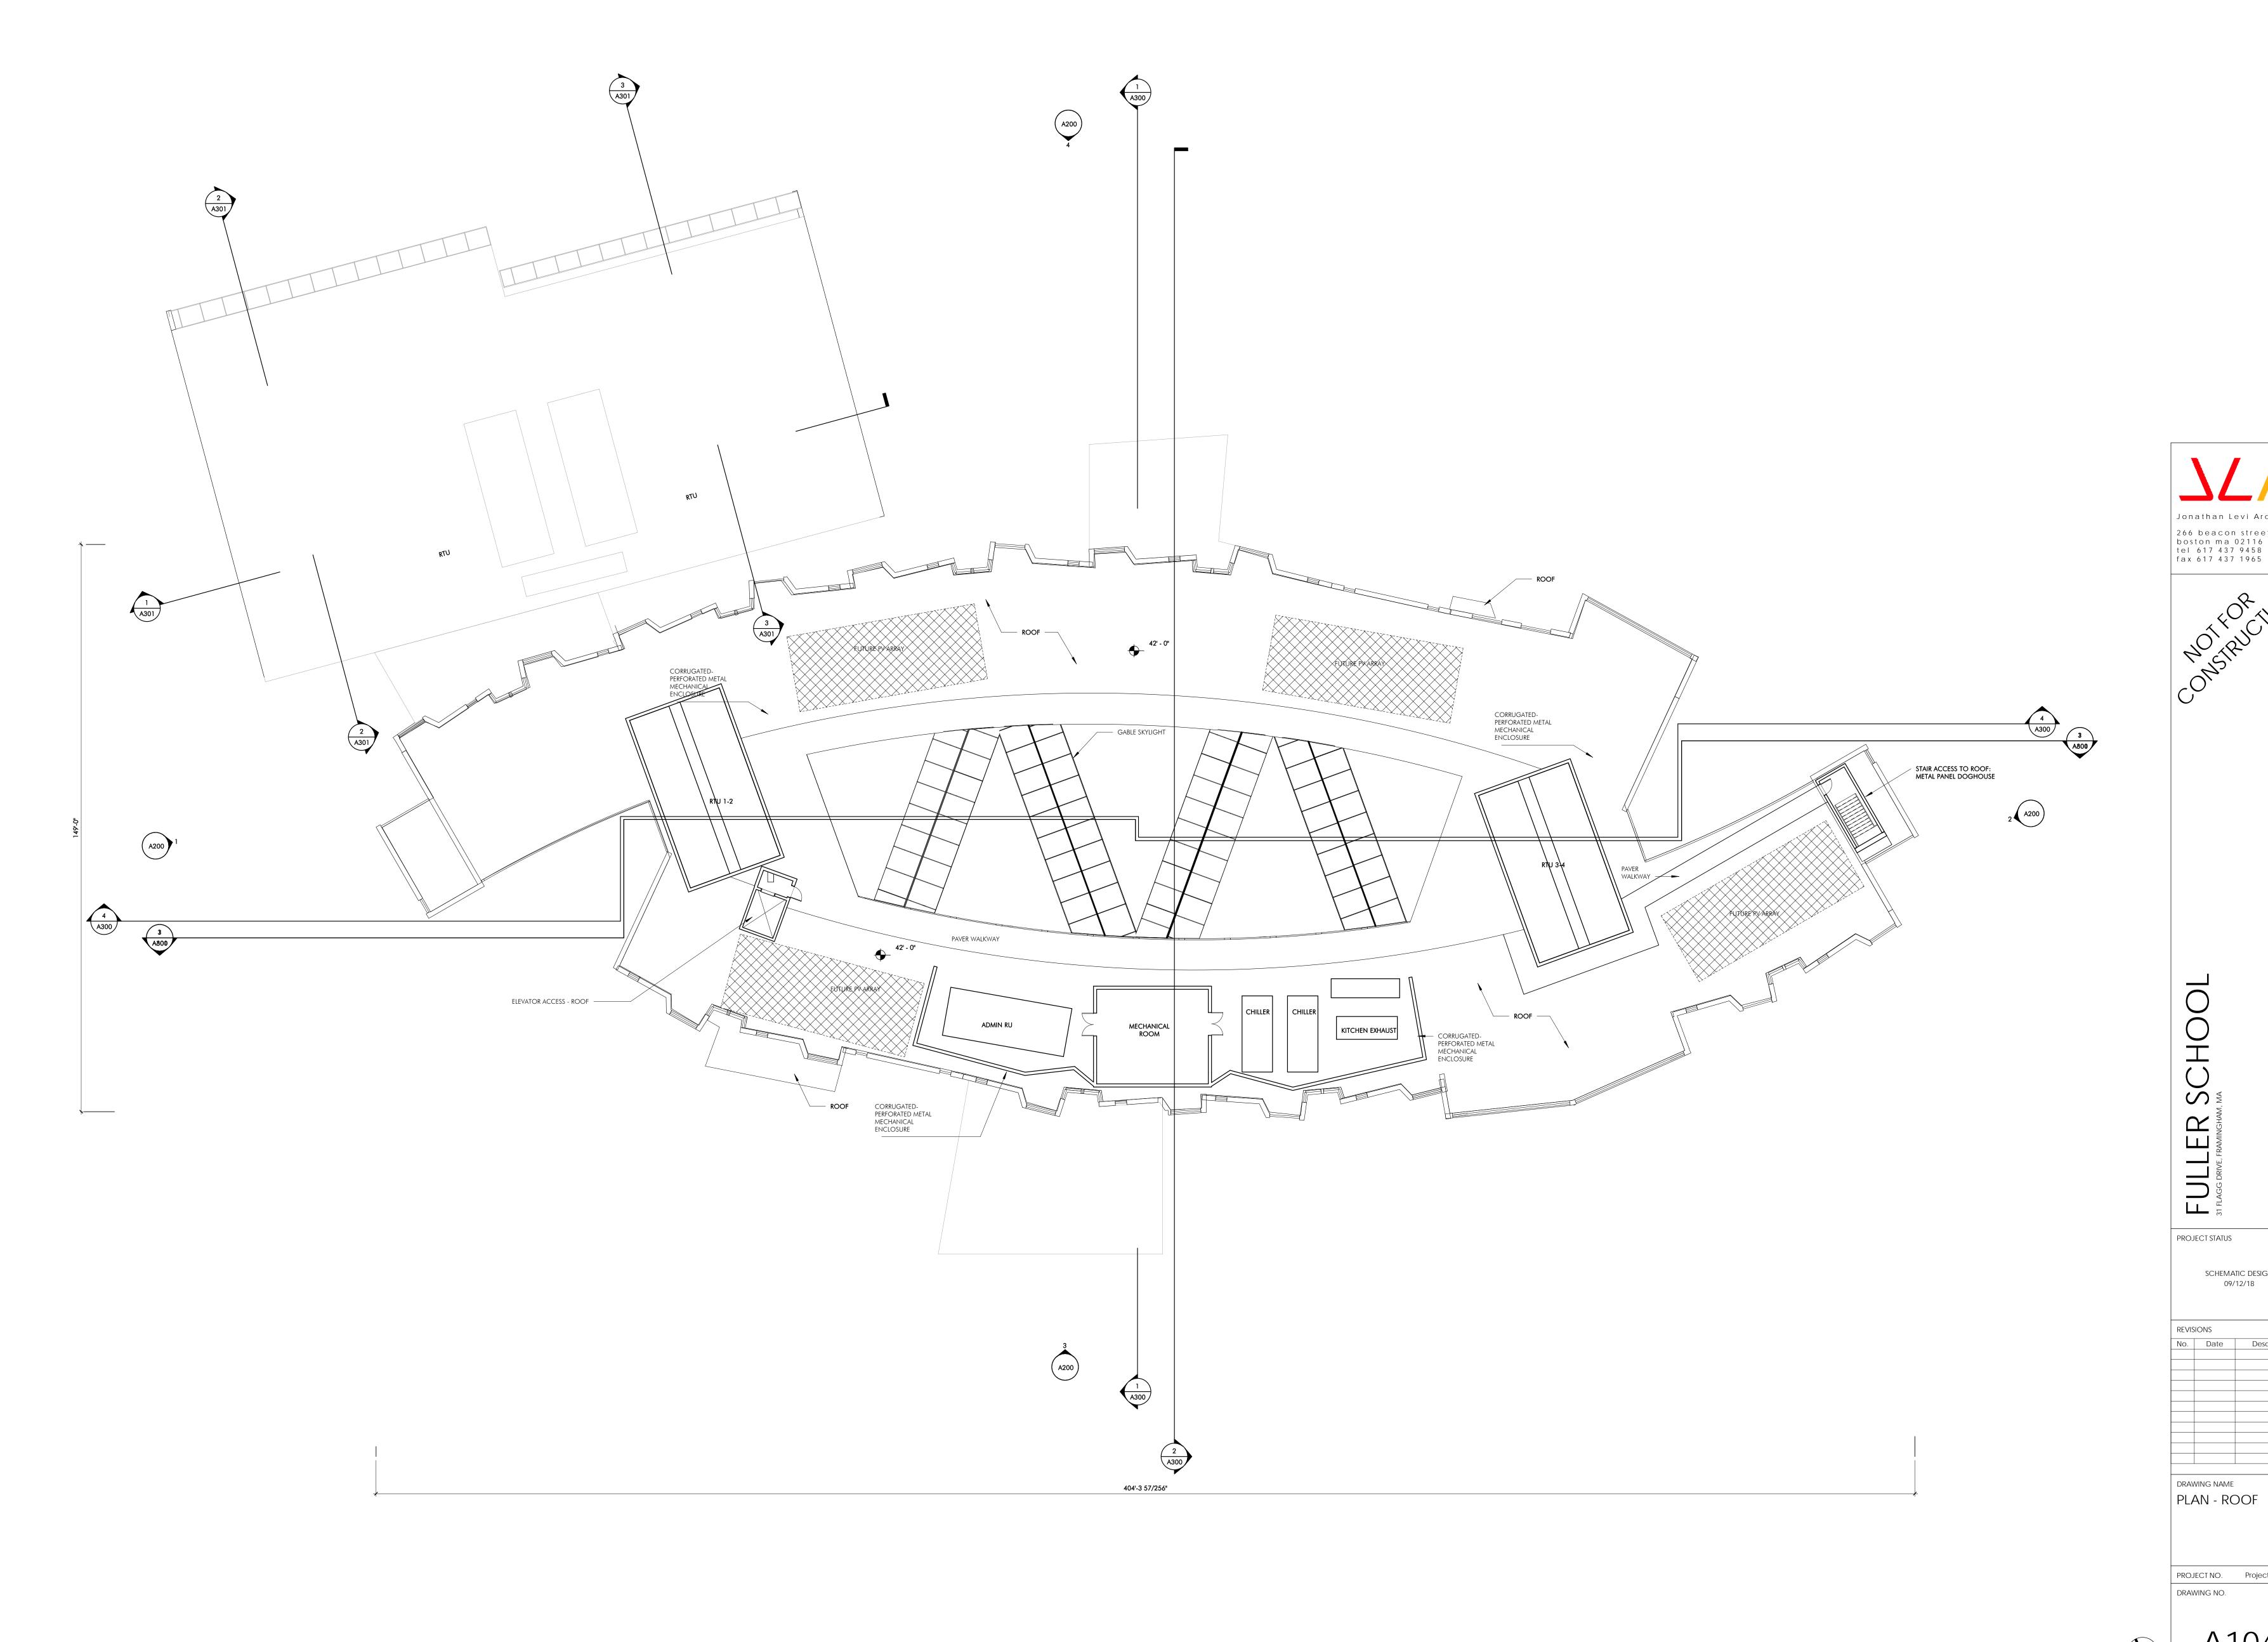

ROOF PLAN

1/16" = 1'-0"

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SCHOOL


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09/12/18

REVISIONS

DRAWING NAME

PROJECT NO. Project Number DRAWING NO.



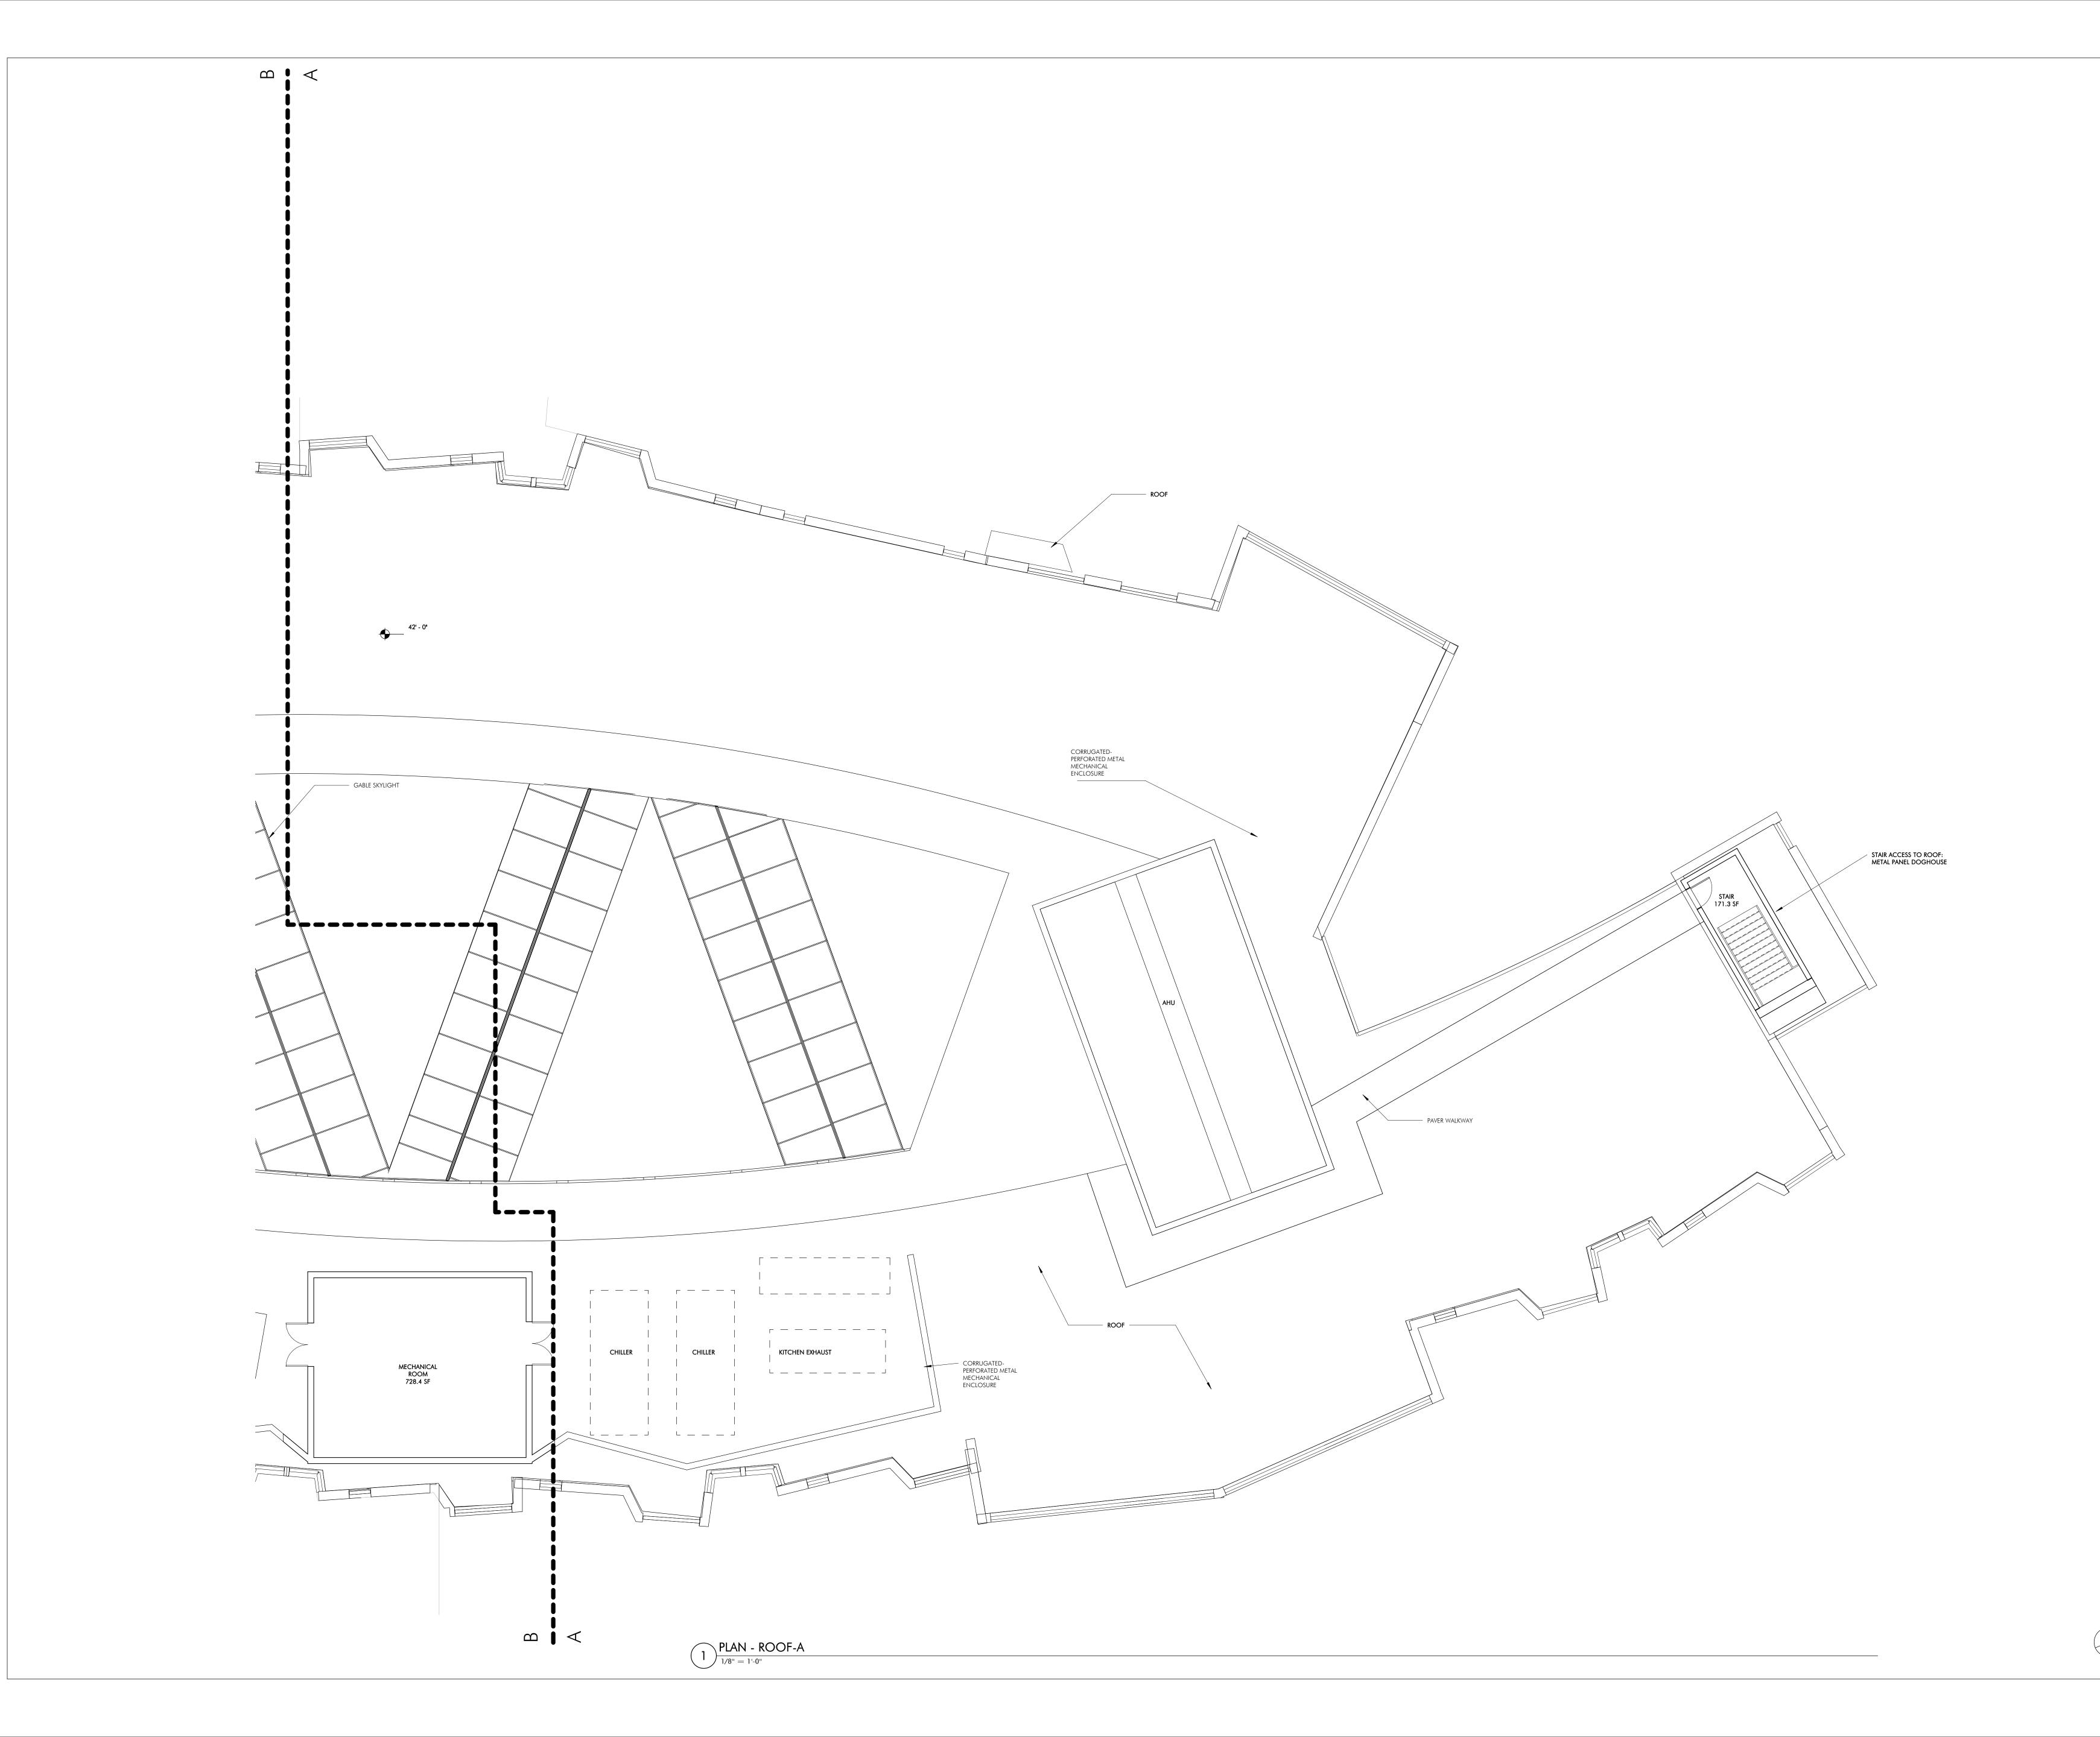

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FULLER SCHOOL
31 FLAGG DRIVE, FRAMINGHAM, MA

PROJECT STATUS

REVISIONS

No. Date Description

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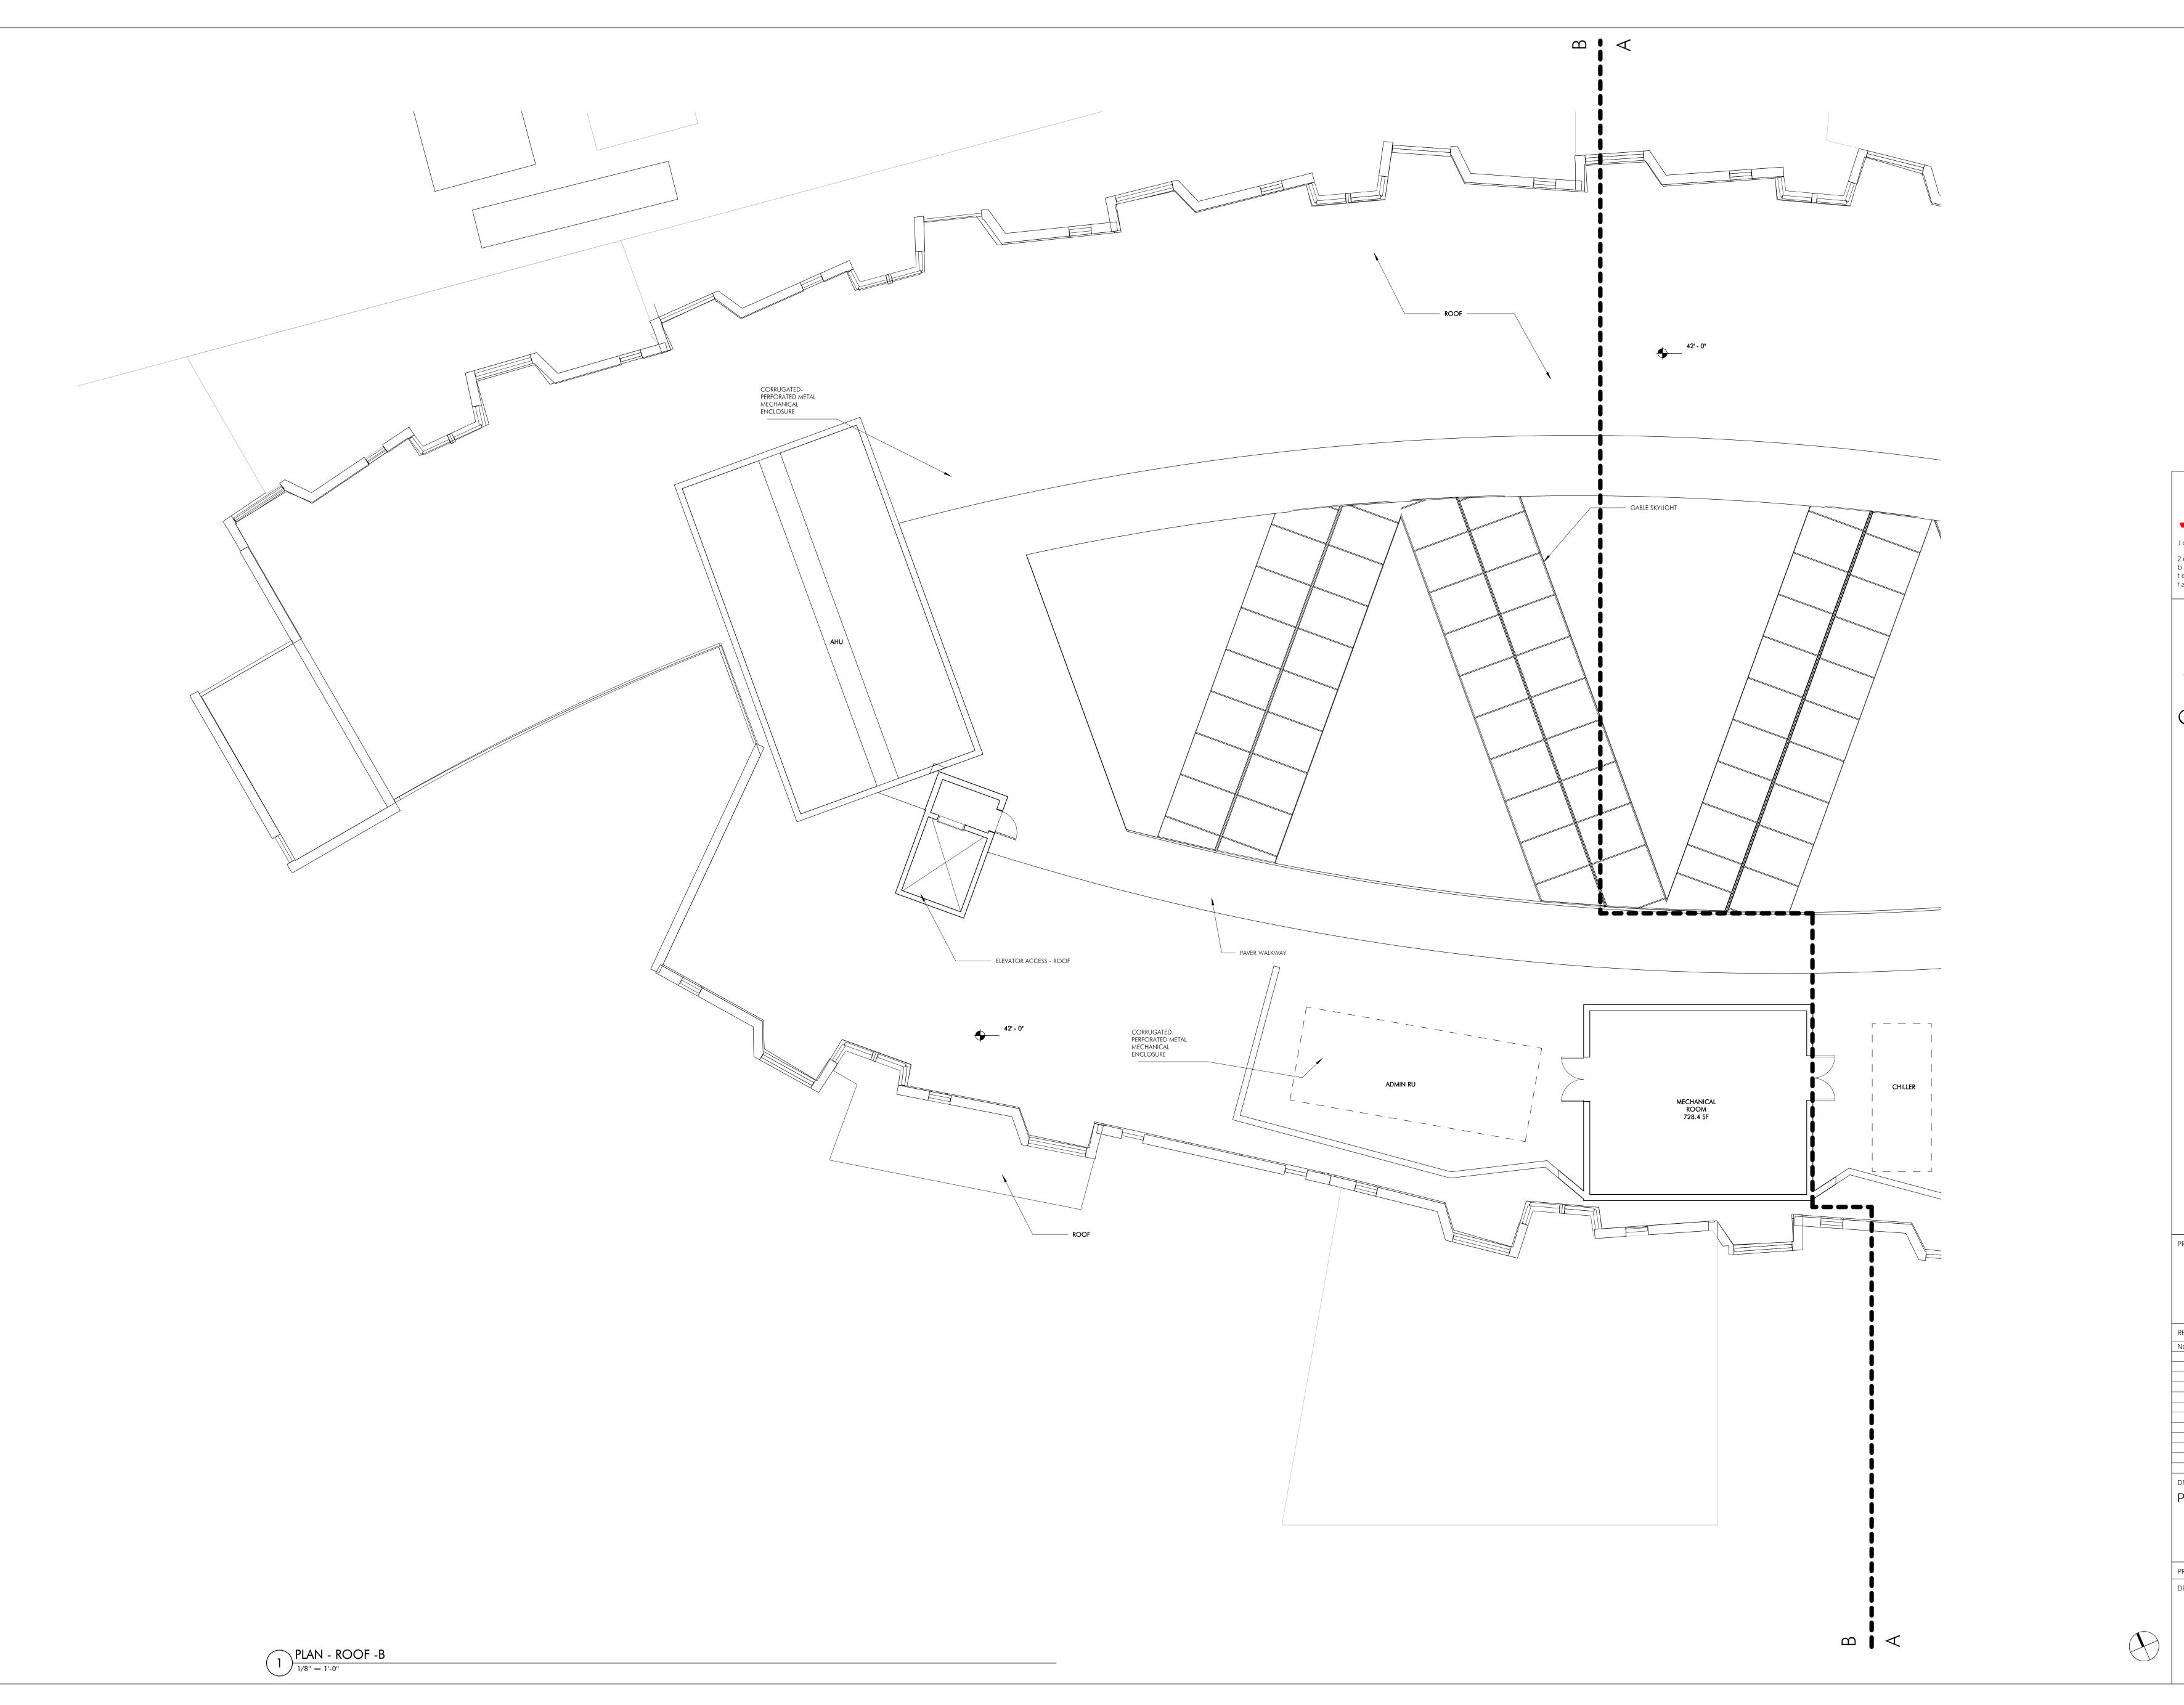
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PLAN - ROOF-A

PROJECT NO. Project Number

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PROJECT STATUS


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DRAWING NAME

PLAN - ROOF-B

PROJECT NO. Project Number DRAWING NO.



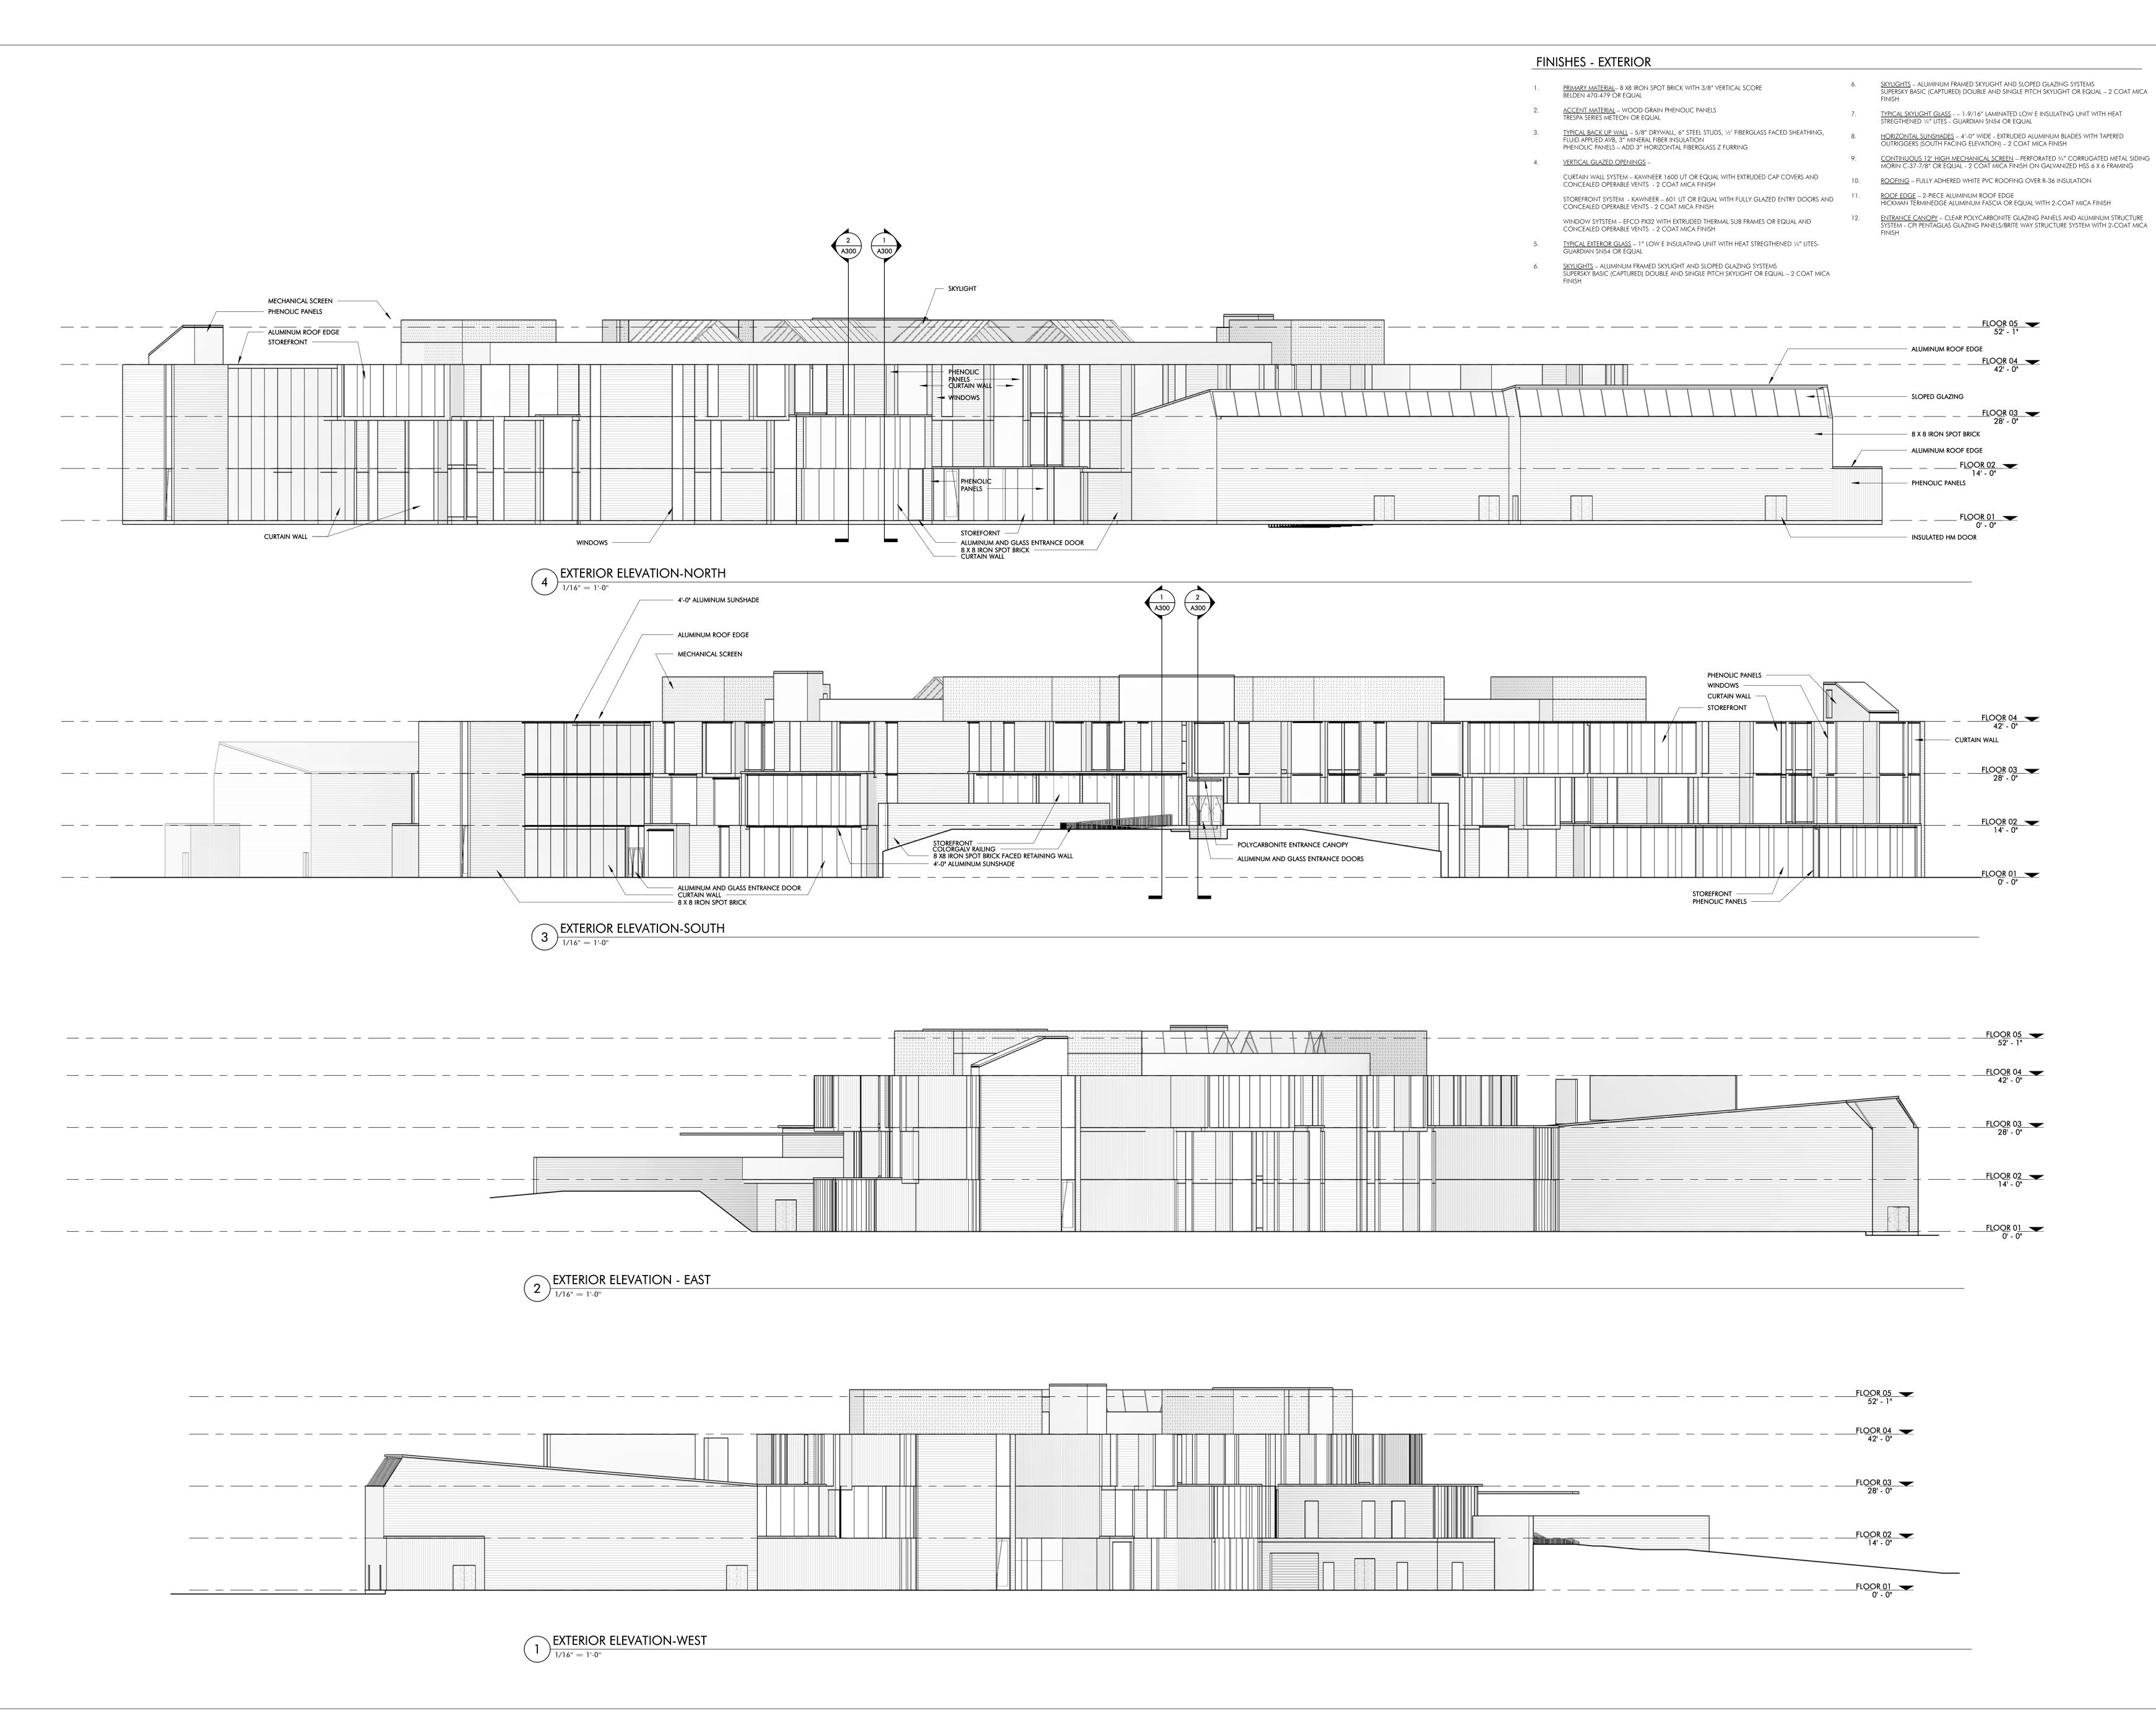

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PROJECT STATUS

REVISIONS

No. Date Description

SCHEMATIC DESIGN 09/12/18

DRAWING NAME
EXTERIOR

ELEVATIONS

PROJECT NO. Project Number

DRAWING NO.



FULLER SCHOOL

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PROJECT STATUS

REVISIONS

No. Date Descrip

SCHEMATIC DESIGN 09/12/18

No. Date Description

DRAWING NAME
BUILDING
SECTIONS

PROJECT NO. Project Number

DRAWING NO.



FULLER SCHOOL
31 FLAGG DRIVE, FRAMINGHAM, MA

PROJECT STATUS

SCHEMATIC DESIGN 09/12/18


No. Date Description

BUILDING SECTIONS

PROJECT NO. Project Number

DRAWING NO.

- 1. <u>Primary material</u> 8 x8 iron spot brick with 3/8" vertical score belden 470-479 or equal
- <u>ACCENT MATERIAL</u> WOOD GRAIN PHENOLIC PANELS TRESPA SERIES METEON OR EQUAL
- TYPICAL BACK UP WALL 5/8" DRYWALL, 6" STEEL STUDS, ½' FIBERGLASS FACED SHEATHING, FLUID APPLIED AVB, 3" MINERAL FIBER INSULATION PHENOLIC PANELS ADD 3" HORIZONTAL FIBERGLASS Z FURRING
- 4. <u>VERTICAL GLAZED OPENINGS</u> CURTAIN WALL SYSTEM – KAWNEER 1600 UT OR EQUAL WITH EXTRUDED CAP COVERS AND CONCEALED OPERABLE VENTS - 2 COAT MICA FINISH STOREFRONT SYSTEM - KAWNEER – 601 UT OR EQUAL WITH FULLY GLAZED ENTRY DOORS AND CONCEALED OPERABLE VENTS - 2 COAT MICA FINISH WINDOW SYTSTEM – EFCO PX32 WITH EXTRUDED THERMAL SUB FRAMES OR EQUAL AND CONCEALED OPERABLE VENTS - 2 COAT MICA FINISH
 - $\frac{\text{TYPICAL EXTEROR GLASS}}{\text{GUARDIAN SN54 OR EQUAL}} 1\text{" LOW E INSULATING UNIT WITH HEAT STREGTHENED 1/4" LITESGRAPH LITESGRAPH SN54 OR EQUAL}$
- <u>SKYLIGHTS</u> ALUMINUM FRAMED SKYLIGHT AND SLOPED GLAZING SYSTEMS SUPERSKY BASIC (CAPTURED) DOUBLE AND SINGLE PITCH SKYLIGHT OR EQUAL 2 COAT MICA FINISH
- <u>SKYLIGHTS</u> ALUMINUM FRAMED SKYLIGHT AND SLOPED GLAZING SYSTEMS SUPERSKY BASIC (CAPTURED) DOUBLE AND SINGLE PITCH SKYLIGHT OR EQUAL 2 COAT MICA
- Typical skylight glass — 1-9/16" laminated low e insulating unit with heat stregthened ½" lites Guardian SN54 or Equal
- $\frac{\text{HORIZONTAL SUNSHADES}}{\text{OUTRIGGERS}} = 4' \text{-0"} \text{ WIDE EXTRUDED ALUMINUM BLADES WITH TAPERED} \\ \text{OUTRIGGERS (SOUTH FACING ELEVATION)} = 2 \text{ COAT MICA FINISH} \\$
- CONTINUOUS 12' HIGH MECHANICAL SCREEN PERFORATED 34" CORRUGATED METAL SIDING MORIN C-37-7/8" OR EQUAL 2 COAT MICA FINISH ON GALVANIZED HSS 6 X 6 FRAMING <u>ROOFING</u> – FULLY ADHERED WHITE PVC ROOFING OVER R-36 INSULATION
- <u>Roof Edge</u> 2-Piece Aluminum Roof Edge Hickman Terminedge Aluminum Fascia or Equal With 2-coat mica Finish
- ENTRANCE CANOPY CLEAR POLYCARBONITE GLAZING PANELS AND ALUMINUM STRUCTURE SYSTEM CPI PENTAGLAS GLAZING PANELS/BRITE WAY STRUCTURE SYSTEM WITH 2-COAT MICA FINISH

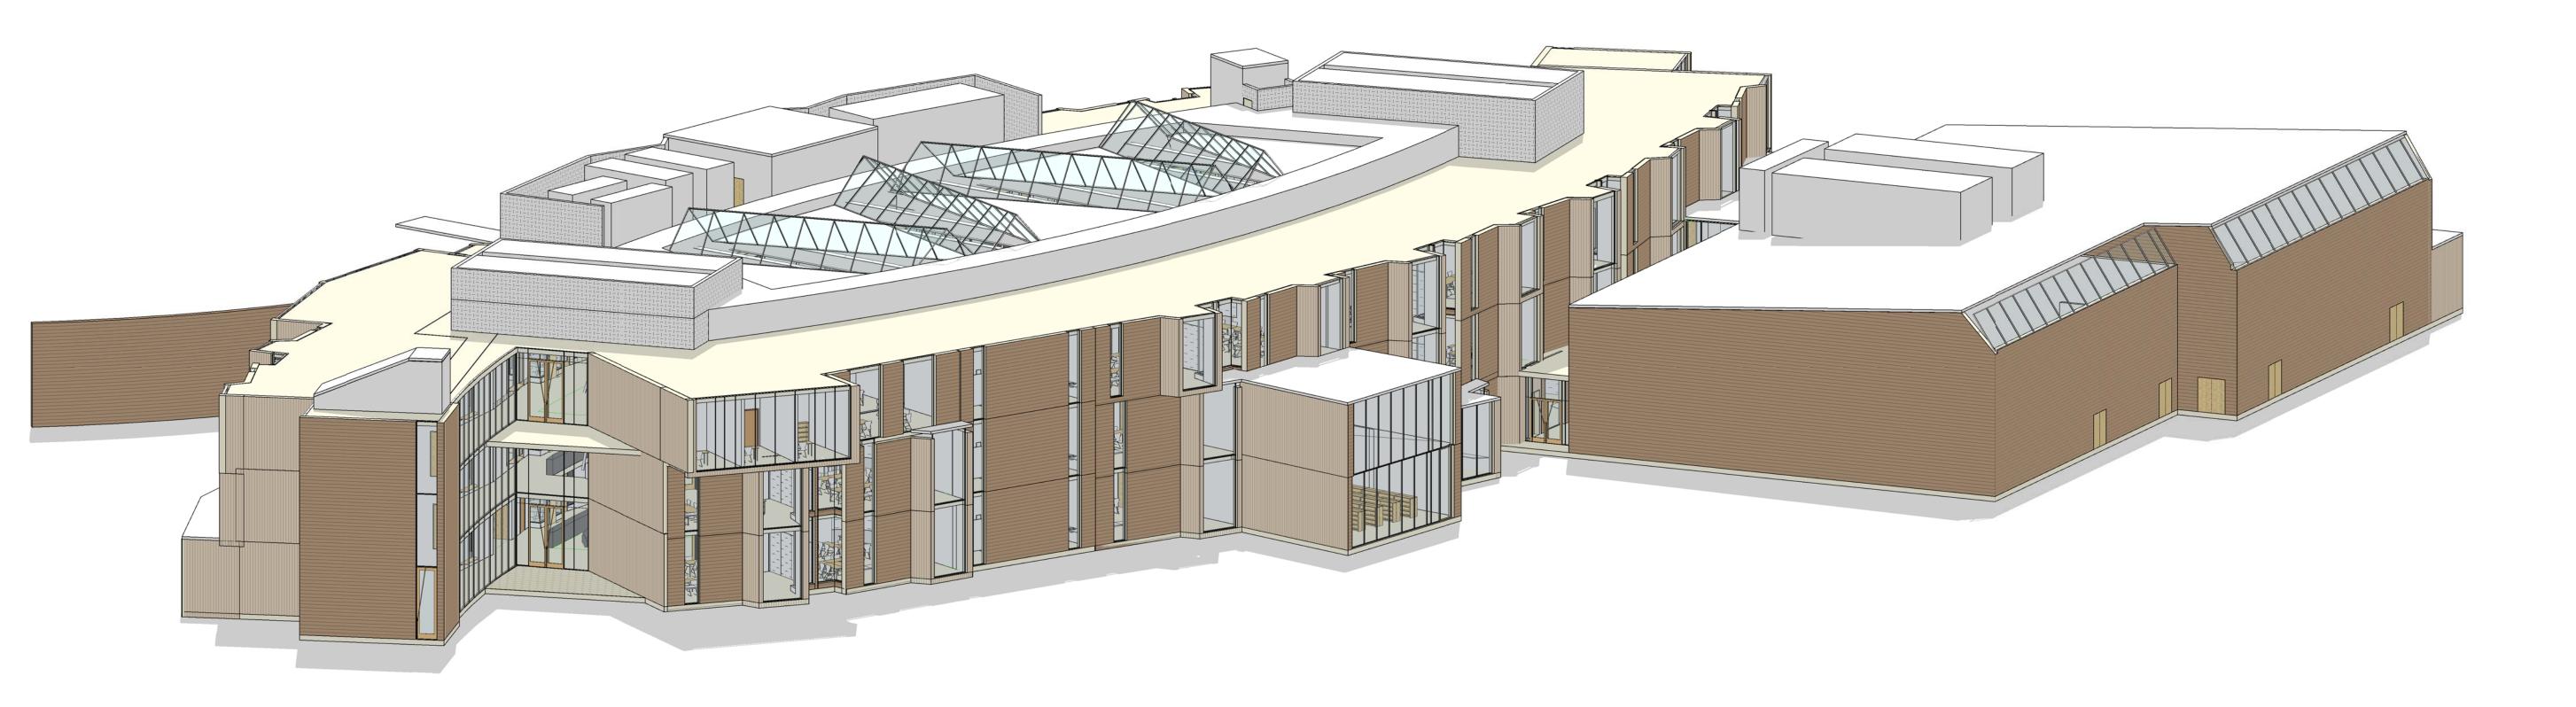

2 3D-NORTHEAST








PROJECT STATUS

REVISIONS

SCHEMATIC DESIGN 09/12/18

DRAWING NAME EXTERIOR 3D VIEWS

PROJECT NO. Project Number

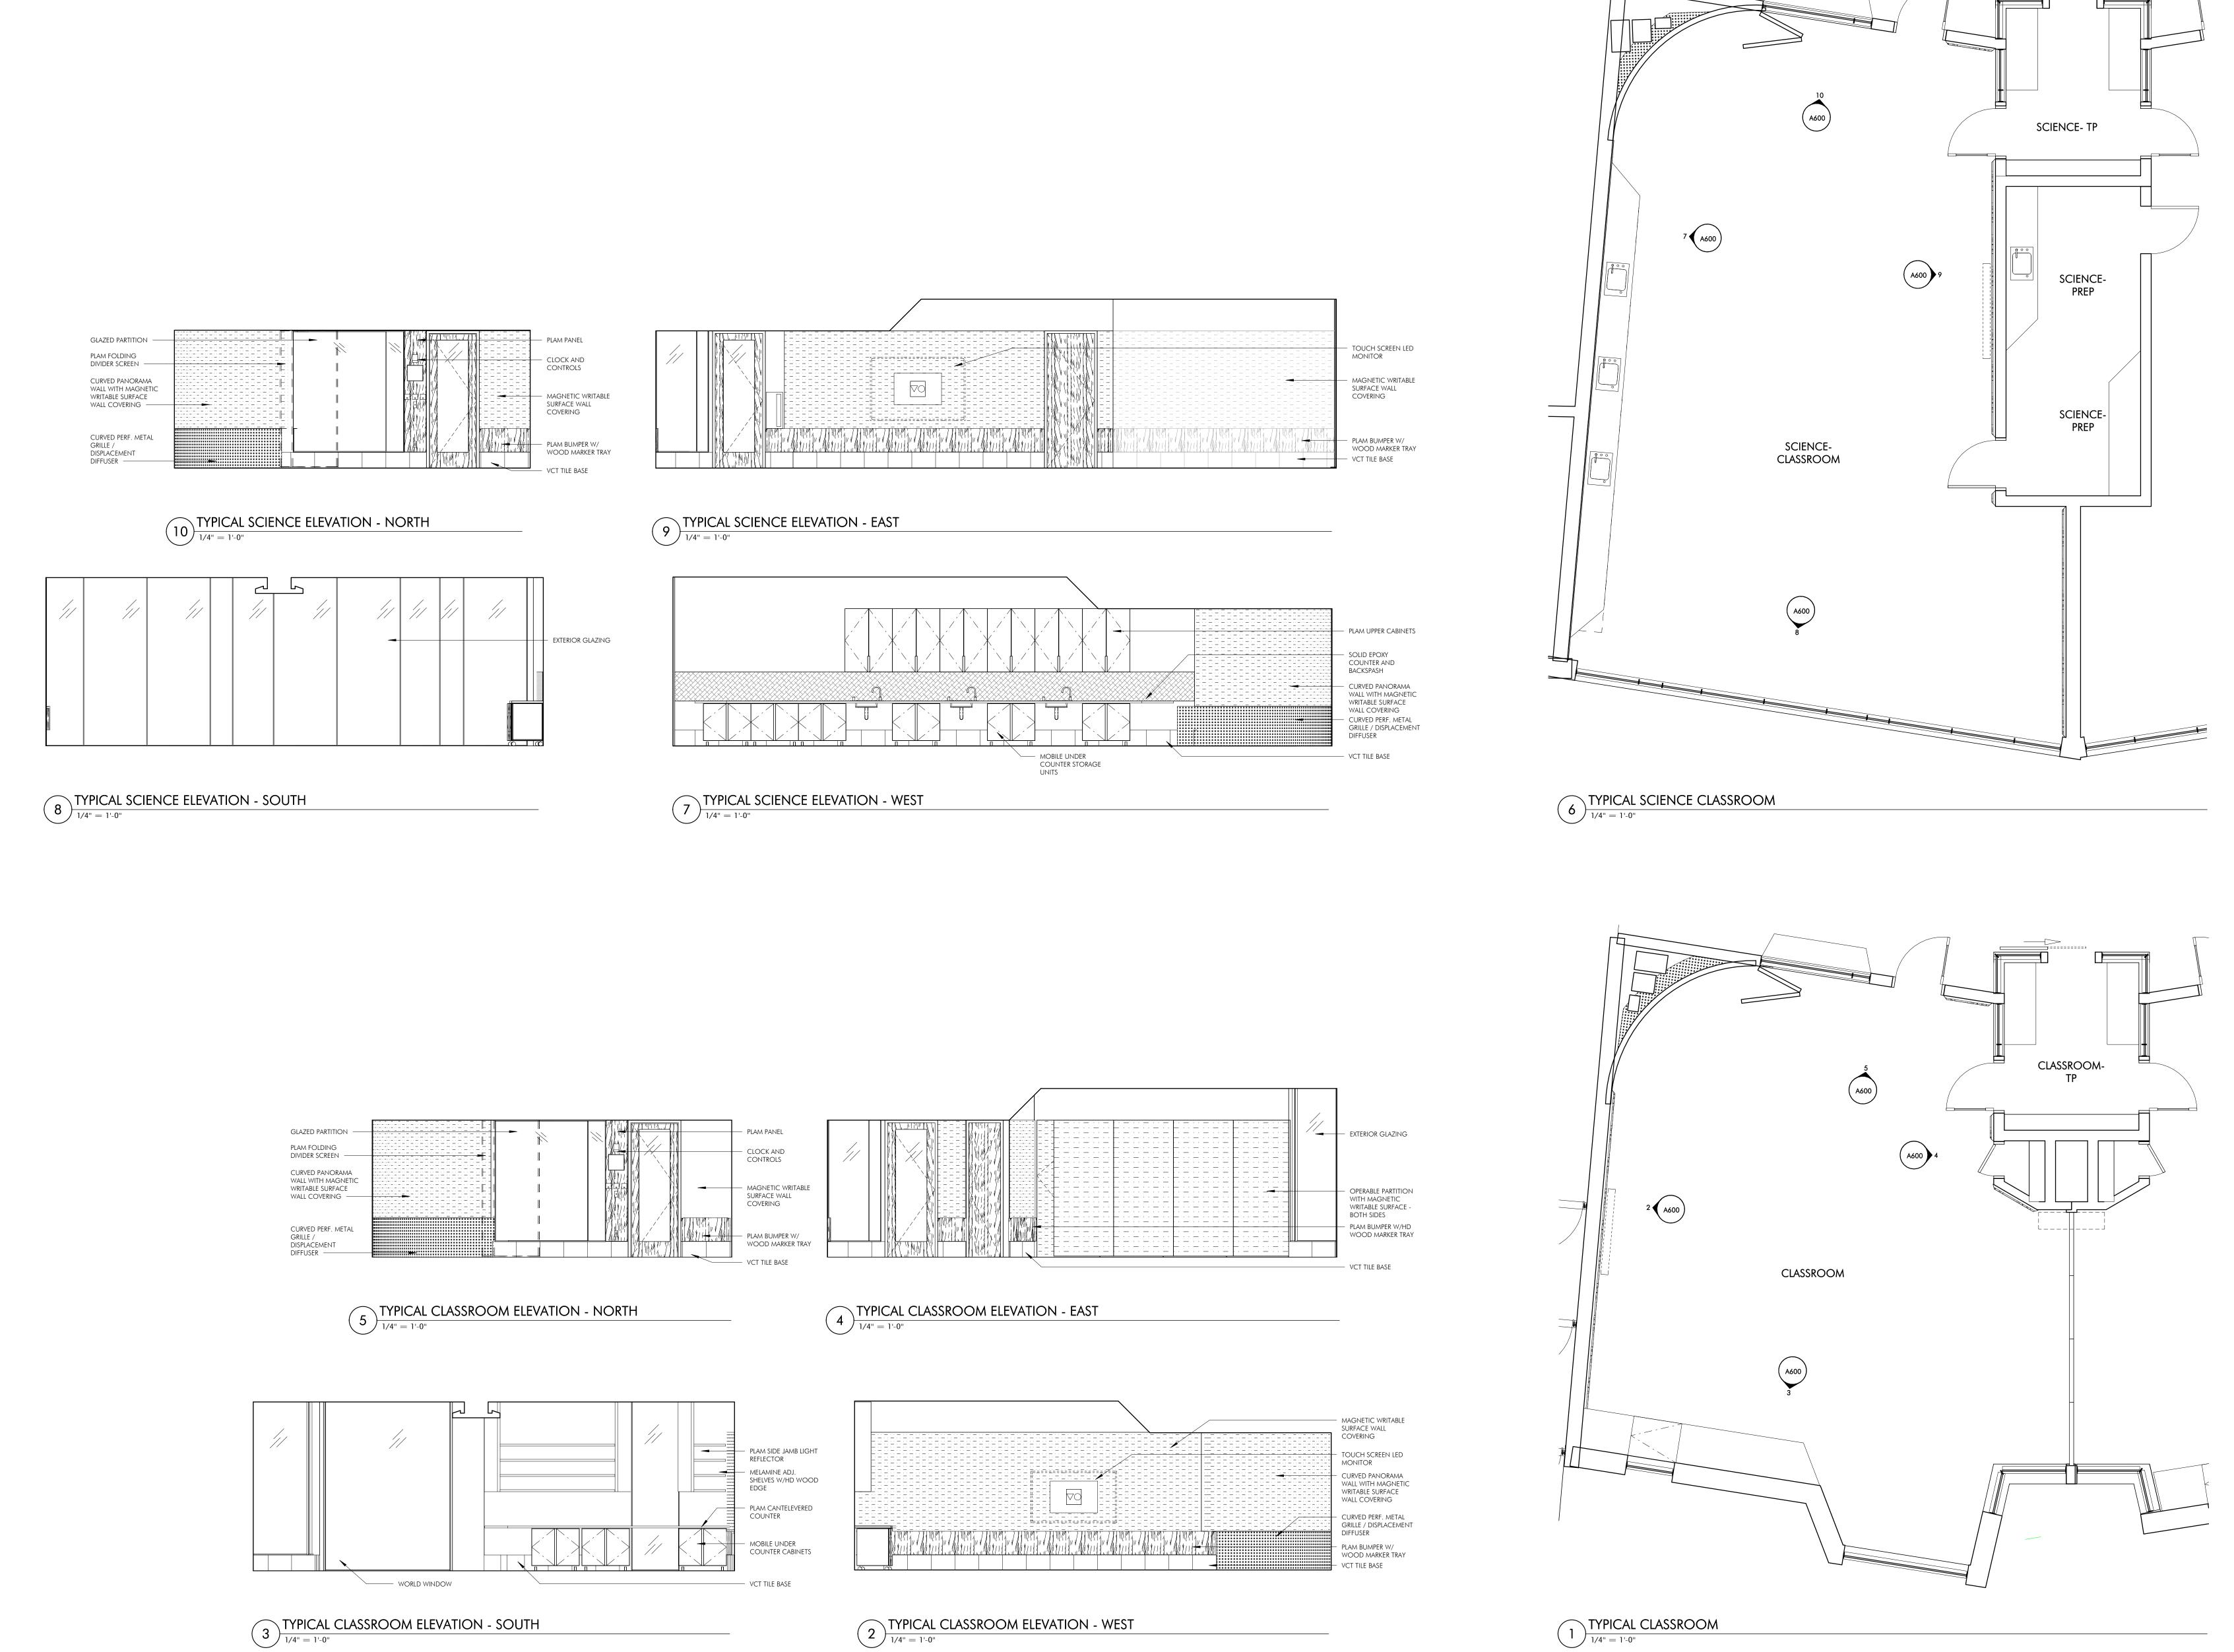

TYPICAL CLASSROOM

1/4" = 1'-0"

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PROJECT STATUS


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SCHEMATIC DESIGN 09/12/18

REVISIONS No. Date Description


DRAWING NAME TYPICAL INTERIOR ELEVATIONS

PROJECT NO. Project Number DRAWING NO.

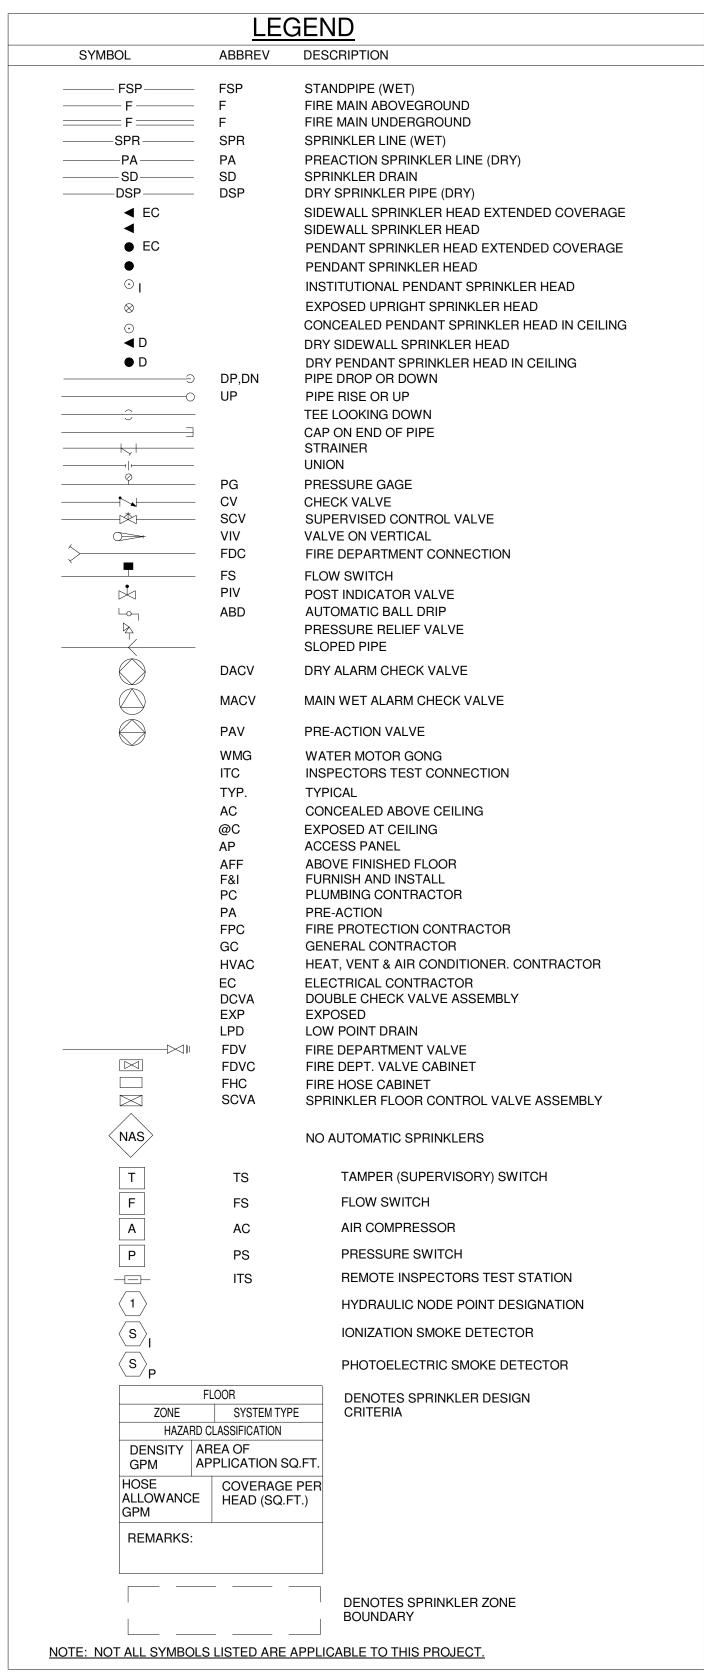

GENERAL NOTES

- 1. THE WORK HEREIN REQUIRED INCLUDES A HYDRAULICALLY DESIGNED SPRINKLER SYSTEM AS SPECIFIED IN THE DOCUMENTS AND AS APPROVED BY THE ARCHITECT.
- 2. THE FIRE PROTECTION DRAWINGS ARE DIAGRAMMATIC AND ARE TO BE USED FOR THE PURPOSE OF ESTABLISHING GENERAL LOCATIONS OF PIPING RUNS, SIZES OF PIPING, AND QUANTITIES OF FIXTURES AND EQUIPMENT TO BE FURNISHED HEREIN. REFER TO ARCHITECTURAL DRAWINGS FOR DIMENSIONS FOR EXACT LOCATIONS OF ALL SPRINKLER HEADS, AND EQUIPMENT, INCLUDING MOUNTING HEIGHTS. IN THE EVENT OF CONFLICT OR IF DIMENSIONS ARE NOT SHOWN, OBTAIN
- FIELD DIRECTIVE FROM THE ARCHITECT AS TO THE LOCATIONS OF ALL VISIBLE EQUIPMENT. 3. ALL PIPING SHOWN ON THESE PLANS OR THOSE TO BE DESIGNED HEREIN SHALL BE RUN CONCEALED ABOVE SUSPENDED CEILINGS, IN CHASES, OR IN PARTITIONS UNLESS SPECIFICALLY NOTED OTHERWISE.
- 4. ALL SPRINKLER HEADS IN CEILING TILES SHALL BE LOCATED IN THE EXACT CENTER OF 2'x2' TILE OR FOR A 2'x4' TILE IN THE CENTER OF EITHER HALF, UNLESS SPECIFICALLY APPROVED OTHERWISE BY THE ARCHITECT.
- 5. REFER TO ARCHITECTURAL REFLECTED CEILING PLANS FOR CEILING HEIGHTS AND CEILING MATERIALS AND LAYOUTS. REFER TO THE RESPECTIVE PLUMBING. HVAC AND ELECTRICAL DRAWINGS FOR LIGHTING, DIFFUSER AND REGISTER LAYOUTS IN CEILINGS AND FOR PIPING, DUCTWORK AND EQUIPMENT ABOVE CEILINGS FOR COORDINATION PURPOSES. IN THE EVENT OF CONFLICT OR IF DIMENSIONS ARE NOT SHOWN, OBTAIN FIELD DIRECTIVE FROM THE ARCHITECT AS TO THE LOCATIONS OF ALL VISIBLE EQUIPMENT.
- 6. THE SPRINKLER CONTRACTOR SHALL PROVIDE AS PART OF THIS CONTRACT ALL SPRINKLERS BELOW FIXED OBSTRUCTIONS 48" AND LARGER AS REQUIRED BY NFPA 13, 8.6.5.3.3. IT IS THE RESPONSIBILITY OF THE SPRINKLER CONTRACTOR TO PROVIDE THE REQUIRED SPRINKLERS AND ALL ASSOCIATED PIPING, FITTINGS, HANGERS, ETC. FOR A COMPLETE INSTALLATION.
- 7. ATTENTION IS CALLED TO THE REQUIREMENT FOR THE PREPARATION OF COORDINATION DRAWINGS. IN ADDITION TO THE PREPARATION OF SHOP DRAWINGS ALSO PREPARE COORDINATION DRAWINGS AS OUTLINED IN THE SPECIFICATION. THE APPROVAL OF THE SHOP DRAWINGS INCLUDING DIMENSIONS SHOWN THEREIN DOES NOT RELIEVE THE CONTRACTOR.
- 8. SPECIFIC ATTENTION IS DIRECTED TO THE REQUIREMENTS OF MA BUILDING CODE AND NFPA 241-2009 REGARDING THE MAINTENANCE OF FIRE PROTECTION SYSTEMS INCLUDING STANDPIPES AND BULK FIRE MAINS BOTH DURING CONSTRUCTION AND DEMOLITION. MAINTAIN THE SYSTEMS AS REQUIRED BY THESE STANDARDS AS A MINIMUM.
- 9. THE SPRINKLER CONTRACTOR SHALL PROVIDE AS PART OF HIS CONTRACT AN INSPECTOR'S TEST STATION ON EACH SPRINKLER ZONE. THE INSPECTOR'S TEST STATION WILL BE LOCATED AT THE MOST HYDRAULICALLY REMOTE PART OF EACH ZONE AND SHALL BE IDENTIFIED ON THE SPRINKLER SHOP DRAWINGS.
- 10. REFER TO NFPA 13 TABLE 8.3.2.5(a) FOR TEMPERATURE RATING OF SPRINKLERS BASED ON DISTANCE FROM HEAT SOURCES SUCH AS HEATING DUCTS, DIFFUSERS AND UNIT HEATERS.

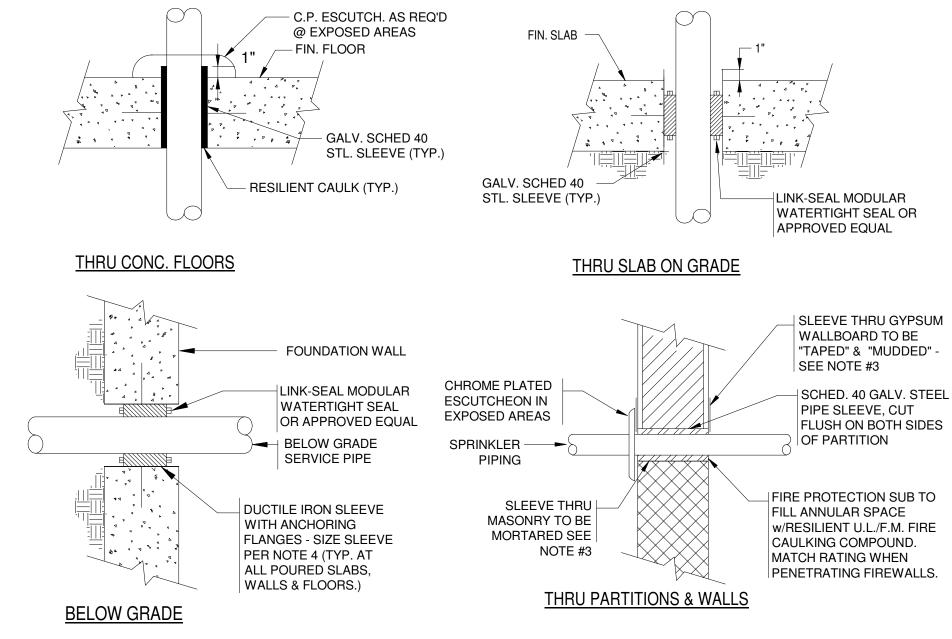


TYPICAL SLEEVE CONDITION DETAILS

N.T.S.

NOTE:


1. ALL PIPING PENETRATING ALL PARTITIONS, WHETHER FIRE OR SMOKE RATED OR NOT, CONCEALED OR EXPOSED, SHALL BE SLEEVED 2. WHERE CONCRETE WALLS, SLABS, ETC., ARE CORE DRILLED, INSTALL SLEEVE FLUSH WITH BOTH SIDES, CAULKED & LEADED IN PLACE. 3. REFER TO DIVISION 4 & 9 FOR PROCEDURES & METHODS OF PATCHING AROUND SLEEVES AT GYPSUM, PLASTER & MASONRY. REFER TO SPECS FOR DELINEATION OF RESPONSIBILITY. SLEEVES SHALL BE SIZED TO PROVIDE MIN. 1" CLEARANCE BETWEEN PIPE O.D. & 4. FOR PIPING UP TO 3" IN SIZE. PROVIDE 2" CLEARANCE BETWEEN PIPE O.D. & SLEEVE I.D. FOR PIPING 4" IN SIZE AND GREATER.

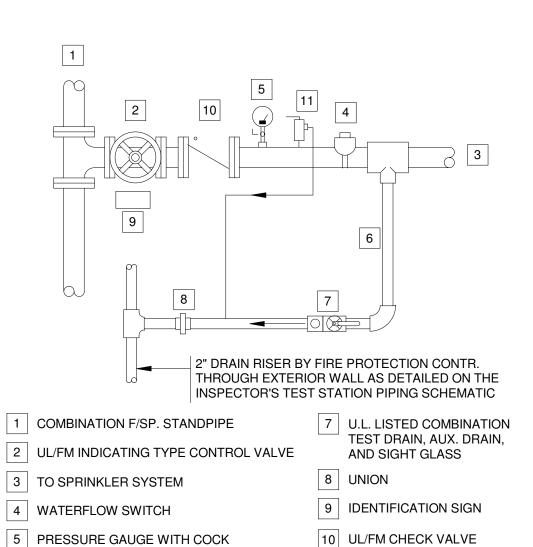


SPRINKLER CONTROL VALVE **ASSEMBLY (SCVA) DETAIL** FP001 SCALE: N.T.S.

11 3/4" RELIEF VALVE PROVIDE


REDUCING & CHECK VALVES

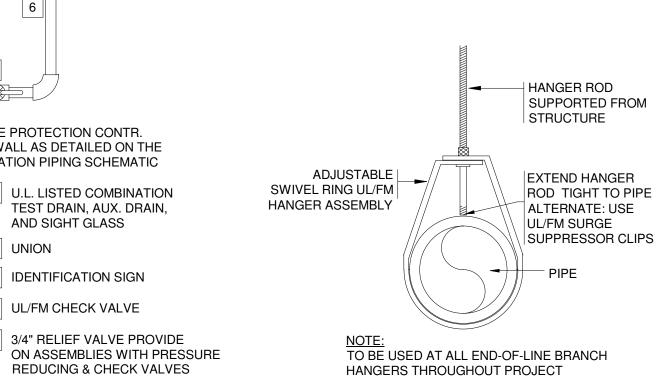

TYPICAL END-OF-LINE BRANCH PIPE HANGER DETAIL N.T.S.

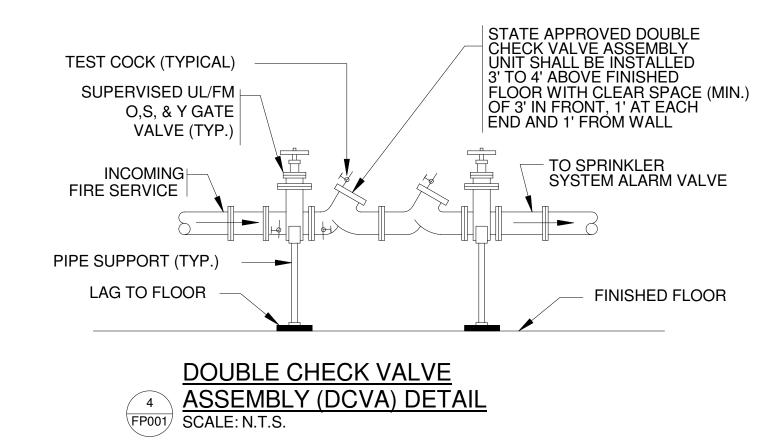



- 1. SUPPORT PIPING AND FITTINGS AS REQUIRED TO CONFORM TO MANUFACTURERS AND OR CODE REQUIREMENTS.
- 2. MATERIALS AND METHODS FOR THIS INSTALLATION SHALL CONFORM TO ALL
- STATE & U.S. PUBLIC HEALTH SERVICES CODES AND REGULATIONS 3. FILE FOR AND OBTAIN ALL REQUIRED APPROVALS & PERMITS PRIOR TO INSTALLATION

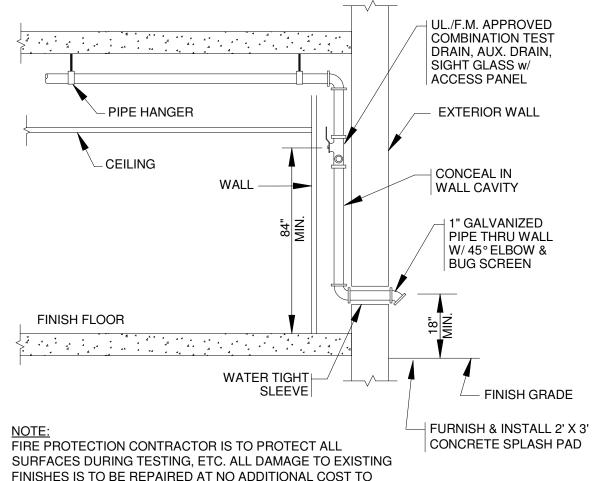

6 1" DRAIN LINE

FINISHES IS TO BE REPAIRED AT NO ADDITIONAL COST TO OWNER. PROVIDE SPLASH BLOCK AT ALL NON-PAVED AREAS.

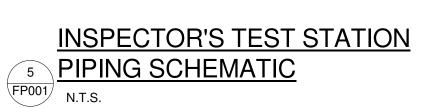


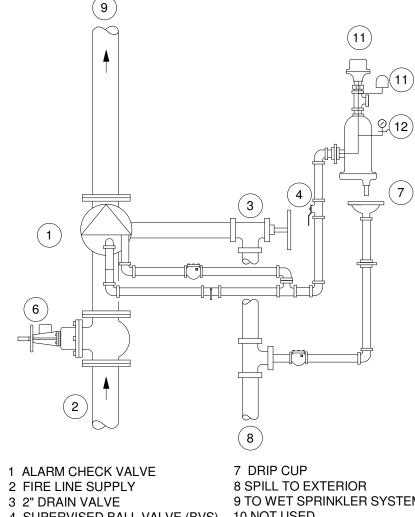

9 TO WET SPRINKLER SYSTEM 4 SUPERVISED BALL VALVE (BVS) 10 NOT USED 11 PRESSURE SWITCH FOR FAP 5 NOT USED SIGNALING STROBE & ELECTRIC BELL 6 TAMPER ALARM SWITCH 12 PRESSURE GAUGE

6 MAIN ALARM CHECK VALVE DETAIL FP001 SCALE: N.T.S.



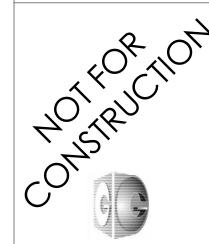

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S Ш Ш

> PROJECT STATUS SCHEMATIC DESIGN

REVISIONS No. Date Description

09/07/18

DRAWING NAME LEGEND, SCHEDULES, AND

PROJECT NO. Project Number DRAWING NO.



DETAILS



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FULLER SCHOOL

PROJECT STATUS

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09/07/18

REVISIONS


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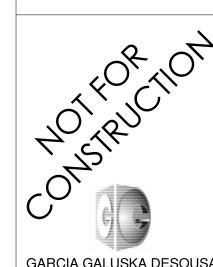
No. Date Descript

FIRST FLOOR RCP -FIRE PROTECTION

PROJECT NO. Project Number

FP1 01



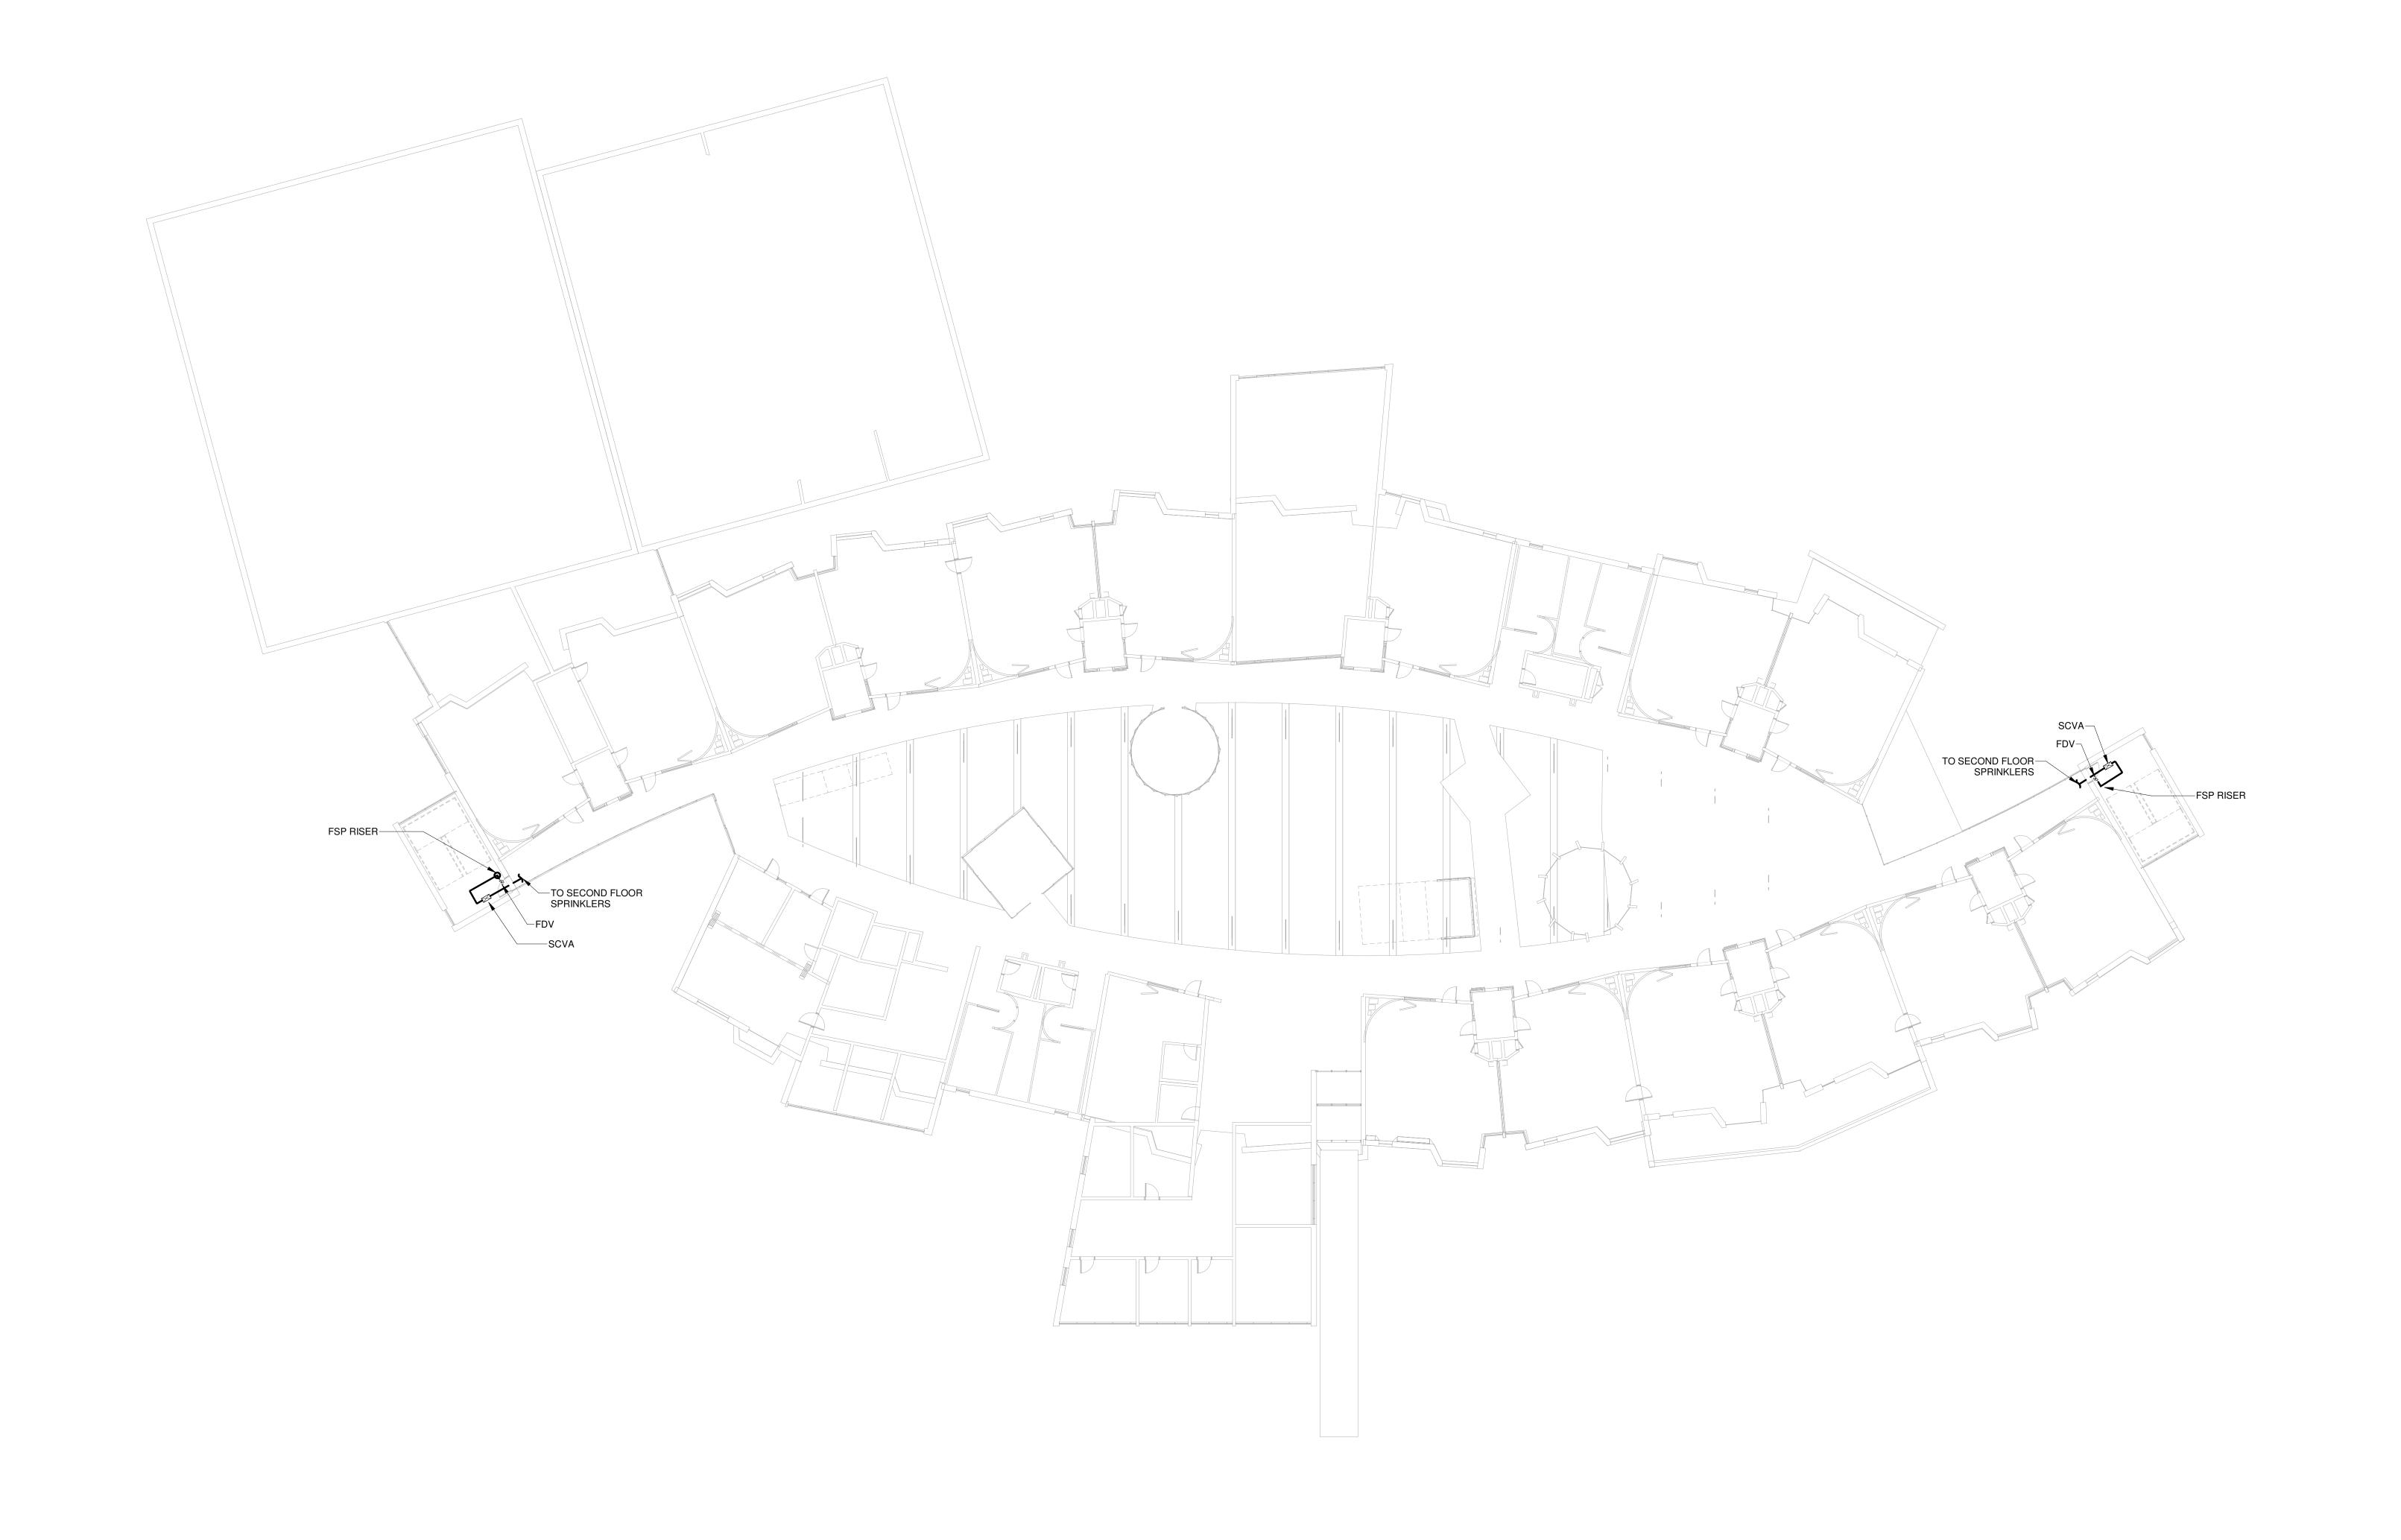

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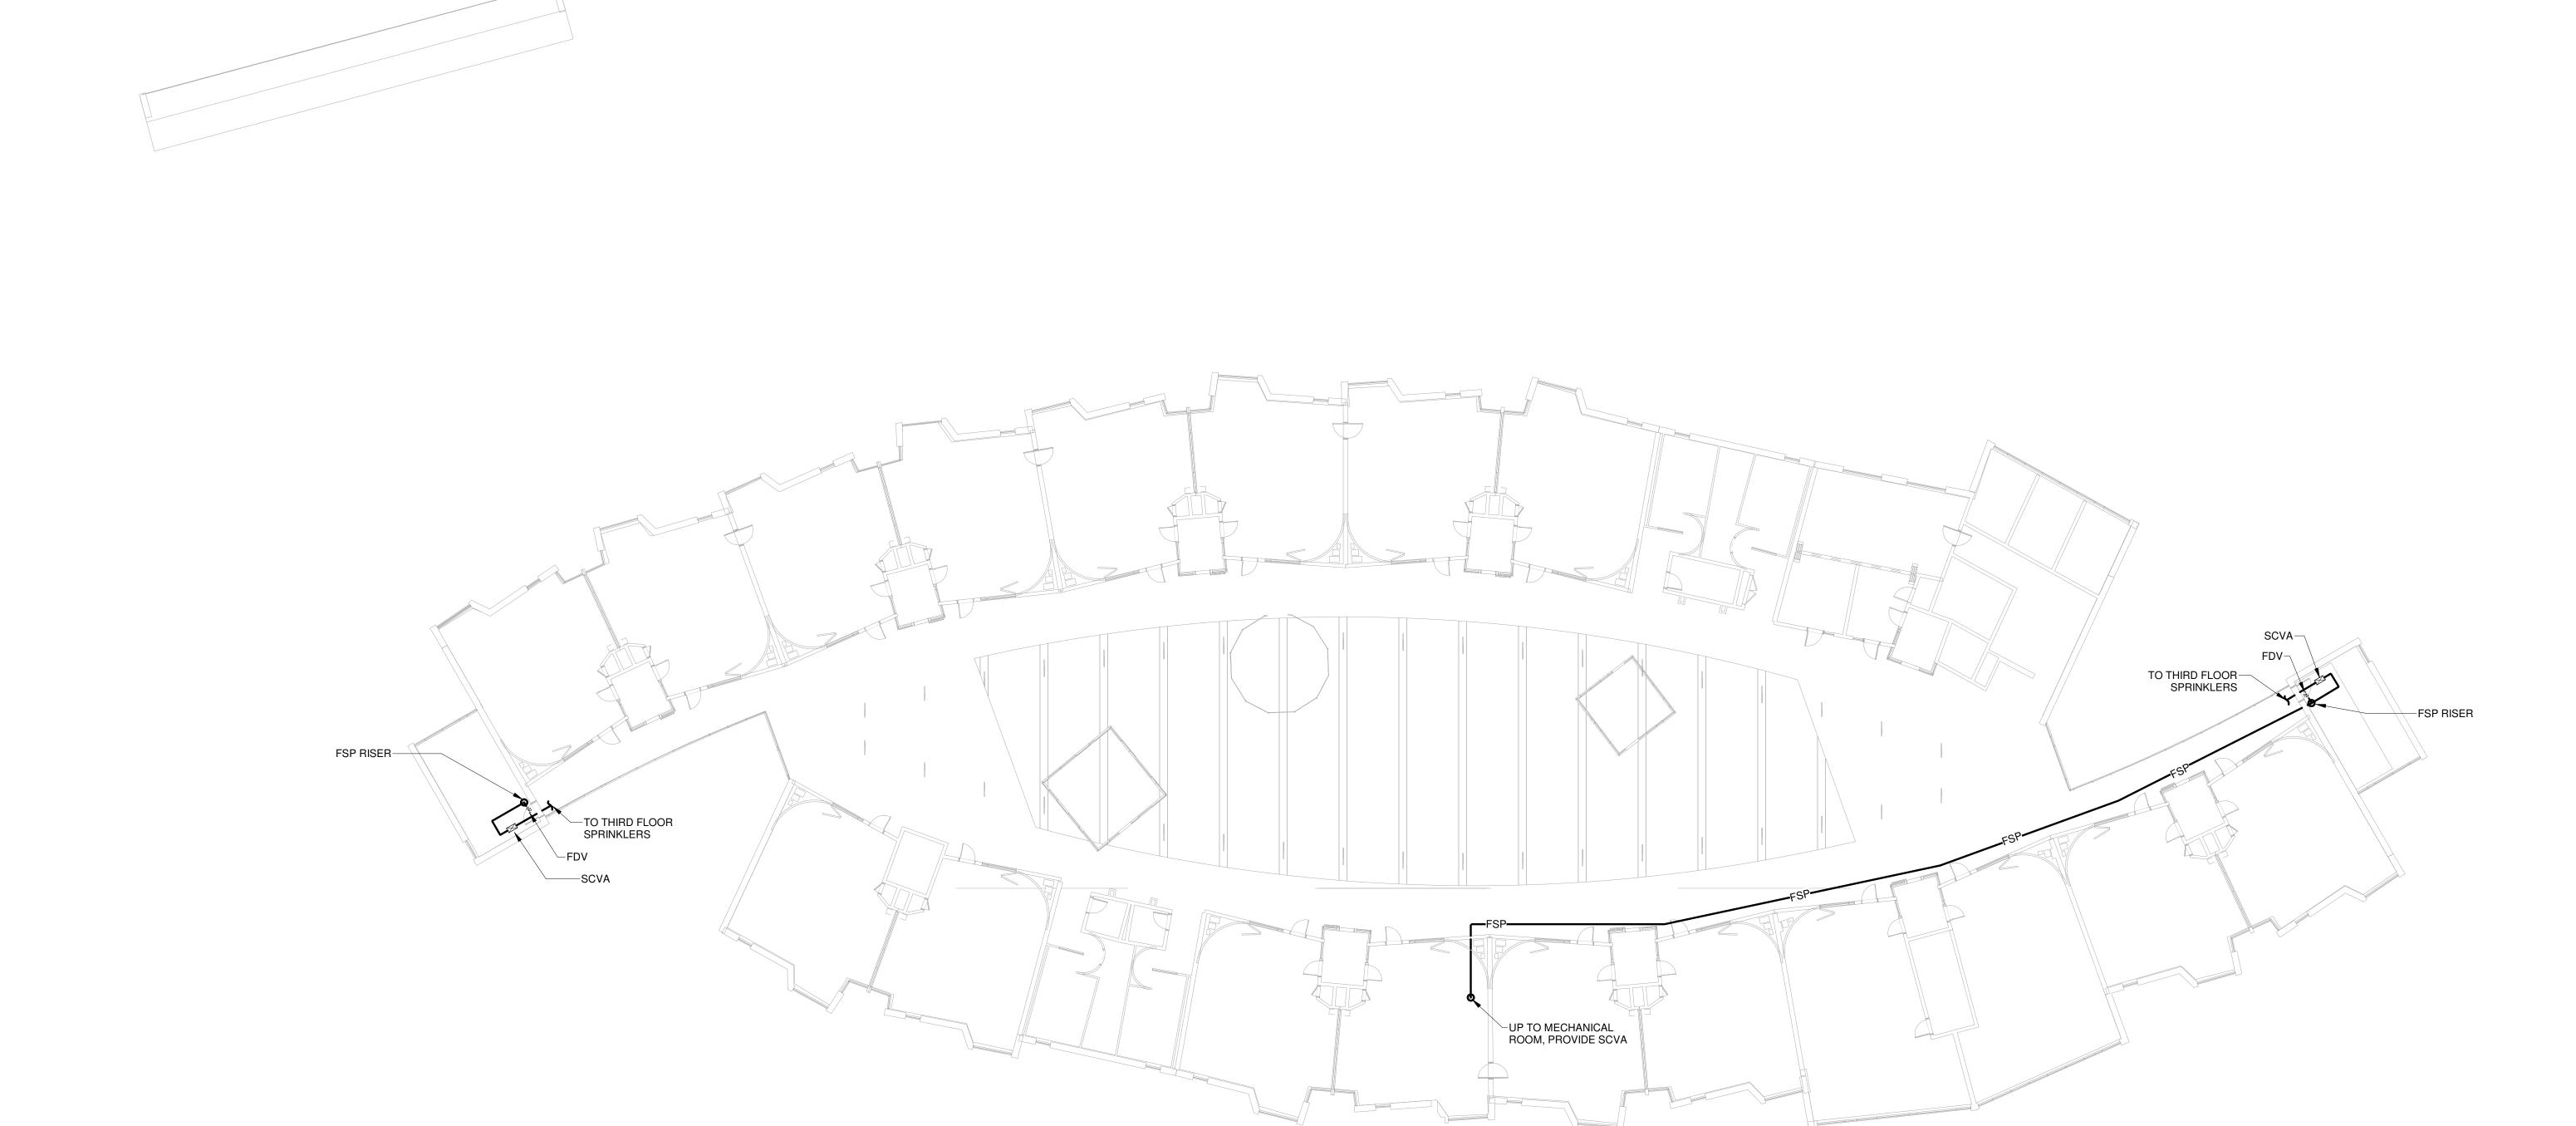
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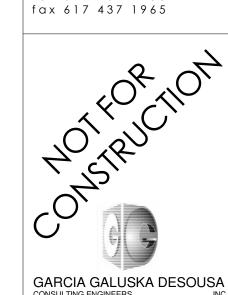
No. Date De

SECOND FLOOR RCP - FIRE PROTECTION

PROJECT NO. Project Number

FP1 02





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PROJECT STATUS

SCHEMATIC DESIGN 09/07/18

REVISIONS

No. Date Descrip

THIRD FLOOR RCP -FIRE PROTECTION

PROJECT NO. Project Number

DRAWING NO.

FP1 03

	<u>LEGENI</u>	<u> </u>
SYMBOL	ABBREV	DESCRIPTION
	NEW	NEW WORK (DARK)
	EX	EXISTING WORK (LIGHT)
	S/W	SOIL/WASTE ABV. GRADE
	S/W V	SOIL/WASTE UNDERGROUND VENT ABV. GRADE
	V	VENT UNDERGROUND
IW	IW	INDIRECT WASTE
	RL RL	RAIN LEADER ABV. GRADE RAIN LEADER UNDERGROUND
OD	OD	OVERFLOW DRAIN
	CW	COLD WATER
	HW	HOT WATER
	HWR HW 140°	HOT WATER RETURN HOT WATER 140°F
	HWR 140°	
NPCW	NPCW	HOT WATER RETURN
		HOT WATER 140°F HOT WATER RETURN 140°F
NFNWN		NOT WATER RETORN 140 F
G	G	FUEL GAS PIPING
	DP,DN	PIPE DROP OR DOWN
	UP	PIPE RISE OR UP TEE LOOKING DOWN
		CAP ON END OF PIPE
	FD RD AD	FLOOR DRAIN, ROOF DRAIN, AREA DRAIN
		STRAINER UNION
	CO	CLEANOUT
$\circ\dashv$	DCO	DANDY CLEANOUT
	FCO	FLOOR CLEANOUT
Y	PG/TG SA /\	PRESSURE GAGE/TEMPERATURE GAGE SHOCK ABSORBER
—————————————————————————————————————		BALANCING VALVE
•	BV	BALL VALVE
	CV	CHECK VALVE GAS COCK
		GAS PRESSURE REGULATOR
	.	SOLENOID VALVE
	GV PRV	GATE VALVE PRESSURE REDUCING VALVE
	VOV	VALVE ON VERTICAL
	PT	P-TRAP
	S&W EL	STOP & WASTE VALVE EXPANSION LOOP
	LL	PIPE GUIDE
		PIPE ANCHOR
	HB/WH	FLOW IN DIRECTION OF ARROW HOSE BIBB/WALL HYDRANT
GW	GW	GARAGE WASTE UNDERGROUND
——— GV ———	GV	GARAGE VENT
GV	GV TP	GARAGE VENT UNDERGROUND TRAP PRIMER
TW	TW	TEMPERED WATER
	TYP.	TYPICAL
	FFE INV	FINISHED FLOOR ELEVATION INVERT ELEVATION
	VTR	VENT THRU ROOF
	AVTR	ACID VENT THRU ROOF
	AP AFF	ACCESS PANEL ABOVE FINISHED FLOOR
	AFG	ABOVE FINISHED FLOOR ABOVE FINISHED GRADE
	FG	FINISHED GRADE
	CP	CAST IRON CHROME PLATED
	CP UC	UNDER COUNTER
	F&I	FURNISH AND INSTALL
	PC EBC	PLUMBING CONTRACTOR
	FPC GC	FIRE PROTECTION CONTRACTOR GENERAL CONTRACTOR
	HVAC	HEAT, VENT & AIR COND. CONTRACTOR
	DCVA	DOUBLE CHECK VALVE ASSEMBLY
	RPBP STK	REDUCED PRESSURE BACKFLOW PREVENTOR STACK
	STP	STANDPIPE
	EXP	EXPOSED SUPPLIEDS
	FBO	FURNISHED BY OTHERS

NOTE: NOT ALL SYMBOLS LISTED ARE APPLICABLE TO THIS PROJECT **GENERAL NOTES**

1. THE PLUMBING DRAWINGS ARE DIAGRAMMATIC AND ARE TO BE USED FOR THE PURPOSE OF ESTABLISHING GENERAL LOCATIONS OF PIPING RUNS, SIZES OF PIPING, AND QUANTITIES OF FIXTURES AND EQUIPMENT TO BE FURNISHED HEREIN. REFER TO ARCHITECTURAL DRAWINGS FOR DIMENSIONS FOR EXACT LOCATIONS OF ALL PLUMBING FIXTURES, AND EQUIPMENT, INCLUDING FLOOR DRAINS, AND MOUNTING HEIGHTS. IN THE EVENT OF CONFLICT OR IF DIMENSIONS ARE NOT SHOWN, OBTAIN FIELD DIRECTIVE FROM THE ARCHITECT AS TO THE LOCATIONS OF ALL VISIBLE EQUIPMENT. PAY PARTICULAR CARE TO COORDINATE WITH THE ARCHITECT'S FIELD REPRESENTATIVE ALL FLOOR DRAIN AND FLOOR CLEANOUT LOCATIONS.

2. ALL PIPING SHOWN ON THIS PLAN SHALL BE RUN CONCEALED ABOVE SUSPENDED CEILINGS, IN CHASES, OR IN PARTITIONS UNLESS SPECIFICALLY NOTED OTHERWISE.


3. INSTALL ALL NEW VALVES SO AS TO BE EASILY ACCESSIBLE AND OPERABLE.

4. THE PLUMBING DRAWINGS ARE INTENDED TO INDICATE THE SIZING AND DESIGN FOR THE MAIN SUPPLY AND WASTE PIPING AND FOCUSES ON RUNS AND SIZES OF THE MAIN RISERS, STACKS AND VENT TERMINATION. IT IS NOT INTENDED TO INDICATE EVERY TRAP AND FIXTURE CONNECTION. CONTRACTOR IS REQUIRED TO PROVIDE ALL CONNECTIONS, TO MAKE ALL CONNECTIONS TO ALL DRAINS AND FIXTURES WHICH ARE SHOWN AND SCHEDULED ON THE PLUMBING DRAWINGS.

SHOCK A	SHOCK ABSORBER SCHEDULE							
PDI SYMBOL	A	B	C	D	E	F		
ZURN SERIES 1250-XL OR EQ.	Α	В	С	D	E	F		
FIXTURE UNITS	1-11	12-32	33-60	61-113	114-154	155-330		

P. NO.	FIXTURE	S/W	VENT	CW	HW	KW	KV	AW	AV	NPCW	NPHW	TW	GAS	REMARKS
P-1	WATER CLOSET	4"	2"	11/4"*	-	-	-	-	-	-	-	-	-	*SUPPLY RISER & 1" STUBOUT TO FLUSH VLV.
P-1A	WATER CLOSET, ACCESSIBLE	4"	2"	11/4"*	-	-	-	-	-	-	-	-	-	*SUPPLY RISER & 1" STUBOUT TO FLUSH VLV.
P-2	URINAL	3"	2"	1"**	-	-	-	-	-	-	-	-	-	**SUPPLY RISER & 3/4" STUBOUT TO FLUSH VLV.
P-2A	URINAL, ACCESSIBLE	3"	2"	1"**	-	-	-	-	-	-	-	-	-	**SUPPLY RISER & 3/4" STUBOUT TO FLUSH VLV.
P-3	LAVATORY ACCESSIBLE	1½"	11/2"	1/2"	1/2"	-	-	-	-	-	-	-	-	COUNTER MOUNTED
P-3A	LAVATORY ACCESSIBLE	1½"	11/2"	1/2"	1/2"	-	-	-	-	-	-	-	-	WALL MOUNTED
P-4	DRINKING FOUNTAIN	1½"	11/2"	1/2"	-	-	-	-	-	-	-	-	-	
P-5	MOP RECEPTOR	3"	2"	1/2"	1/2"	-	-	-	-	-	-	-	-	FLOOR MOUNTED
P-6	SHOWER, ACCESSIBLE	2"	2"	1/2"	1/2"	-	-	-	-	-	-	-	-	
P-7	ART SINK	2"	2"	1/2"		1/2"	-	WITH	SOLIDS	INTERC	EPTOR			
P-7A	ART SINK, ACCESSIBLE	2"	2"	1/2"		1/2"	-			INTERC				

COORDINATE ALL ROUGH-IN REQUIREMENTS WITH ARCHITECTURAL DRAWINGS, ACCESSIBLE HEIGHTS VARY.

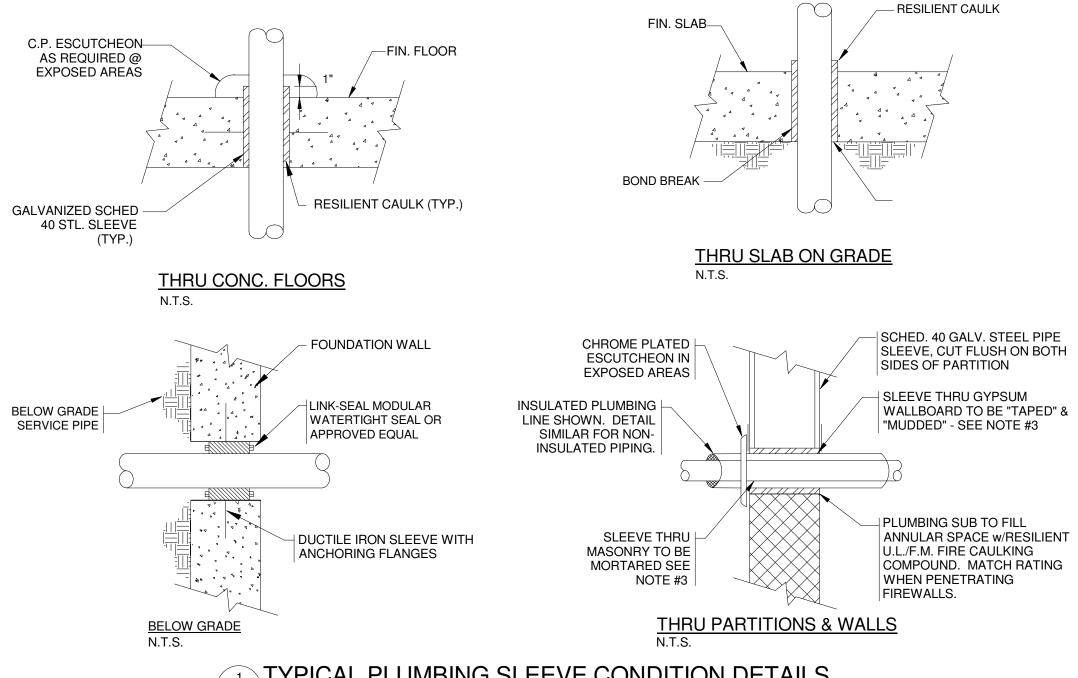


1 TYPICAL PLUMBING SLEEVE CONDITION DETAILS P001 N.T.S.

NOTE:


1. ALL PIPING PENETRATING ALL PARTITIONS, WHETHER FIRE OR SMOKE RATED OR NOT, CONCEALED OR EXPOSED, SHALL BE SLEEVED AS DETAILED.

- 2. WHERE CONC. WALLS, SLABS, ETC., ARE CORE DRILLED, INSTALL SLEEVE FLUSH WITH BOTH SIDES, CAULKED & LEADED IN PLACE.
- 3. REFER TO DIVISION 4 & 9 FOR PROCEDURES & METHODS OF PATCHING AROUND SLEEVES AT GYPSUM, PLASTER & MASONRY. REFER TO SPECS FOR DELINEATION OF
- 4. SLEEVES SHALL BE SIZED TO PROVIDE MIN. 1" CLEARANCE BETWEEN PIPE O.D. & SLEEVE I.D.

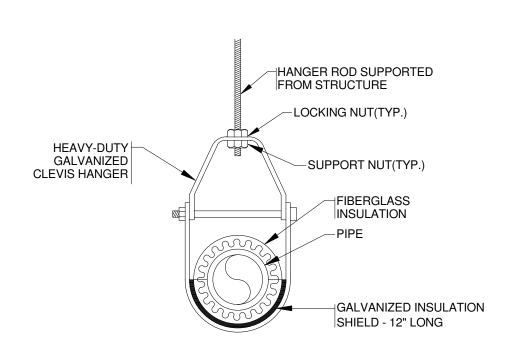


TYPICAL PIPE HANGER DETAIL THIS DETAIL INDICATES HANGING OF INSULATED PIPING WHICH MAY BE EITHER WATER OR STORM DRAIN. CLEVIS HANGER

DETAIL APPLIES TO ALL PLUMBING PIPING ON THIS PROJECT.

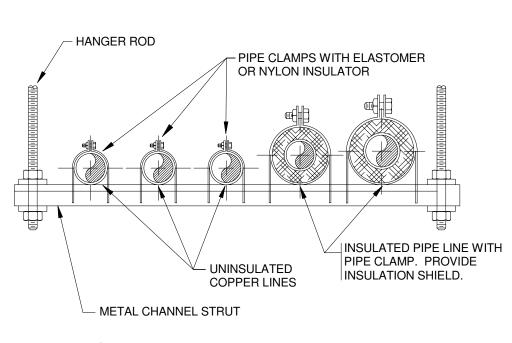


TRAPEZE PIPE HANGER
P001 N.T.S.

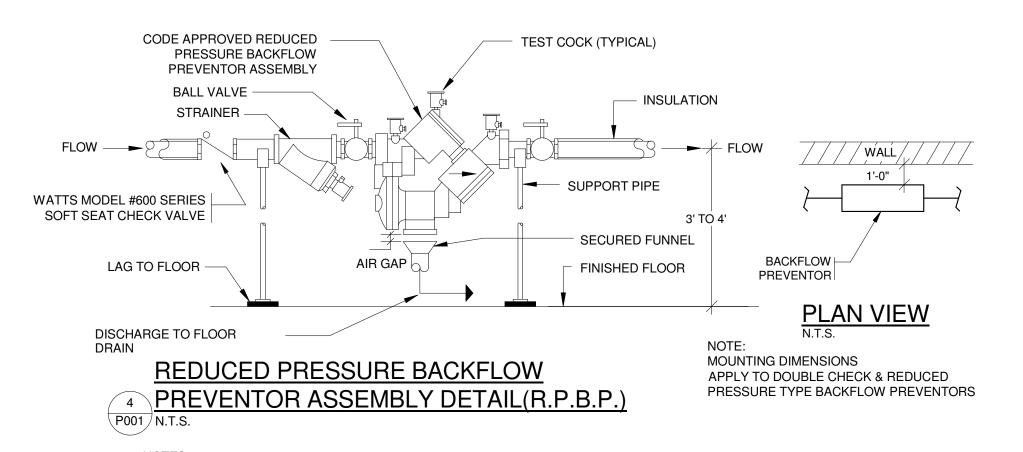

- 1. LOCATE BACKFLOW PREVENTOR 3' TO 4' ABOVE FINISHED FLOOR, 1' FROM WALL AND EASILY
- 2. MATERIALS AND METHODS FOR THIS INSTALLATION SHALL CONFORM TO ALL STATE AND U.S. PUBLIC HEALTH SERVICES CODES AND REGULATIONS.
- 3. FILE FOR AND OBTAIN ALL REQUIRED APPROVALS AND PERMITS PRIOR TO INSTALLATION



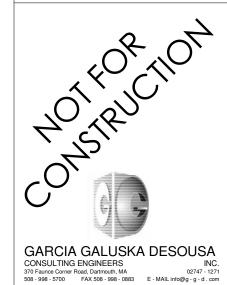

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PROJECT STATUS SCHEMATIC DESIGN 09/07/18

REVISIONS Description

DRAWING NAME LEGEND, NOTES, SCHEDULES, AND DETAILS

PROJECT NO. Project Number DRAWING NO.







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FULLER SCHOOL

PROJECT STATUS

SCHEMATIC DESIGN 09/07/18

REVISIONS

No. Date Descripti

FIRST FLOOR
BELOW SLAB PLAN
- PLUMBING

PROJECT NO. Project Number

P1 AA





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FULLER SCHOOL
31 FLAGG DRIVE, FRAMINGHAM, MA

SCHEMATIC DESIGN 09/07/18

REVISIONS

No. Date Description


DRAWING NAME
FIRST FLOOR PLAN PLUMBING

PROJECT NO. Project Number

DRAWING NO.

P1.01



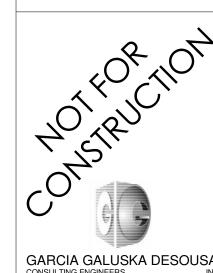

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FULLER SCHOOL

PROJECT STATUS

SCHEMATIC DESIGN
09/07/18

REVISIONS

No. Date Description

SECOND FLOOR PLAN - PLUMBING

PROJECT NO. Project Number

DRAWING NO.

P1 02

CARCIA GALLISKA DESCUISA

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SCHOOL

FULLER 31 FLAGG DRIVE, FRAMINGHAN

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REVISIONS


No. Date Description

DRAWING NAME

THIRD FLOOR PLAN
- PLUMBING


PROJECT NO. Project Number
DRAWING NO.

P1.03

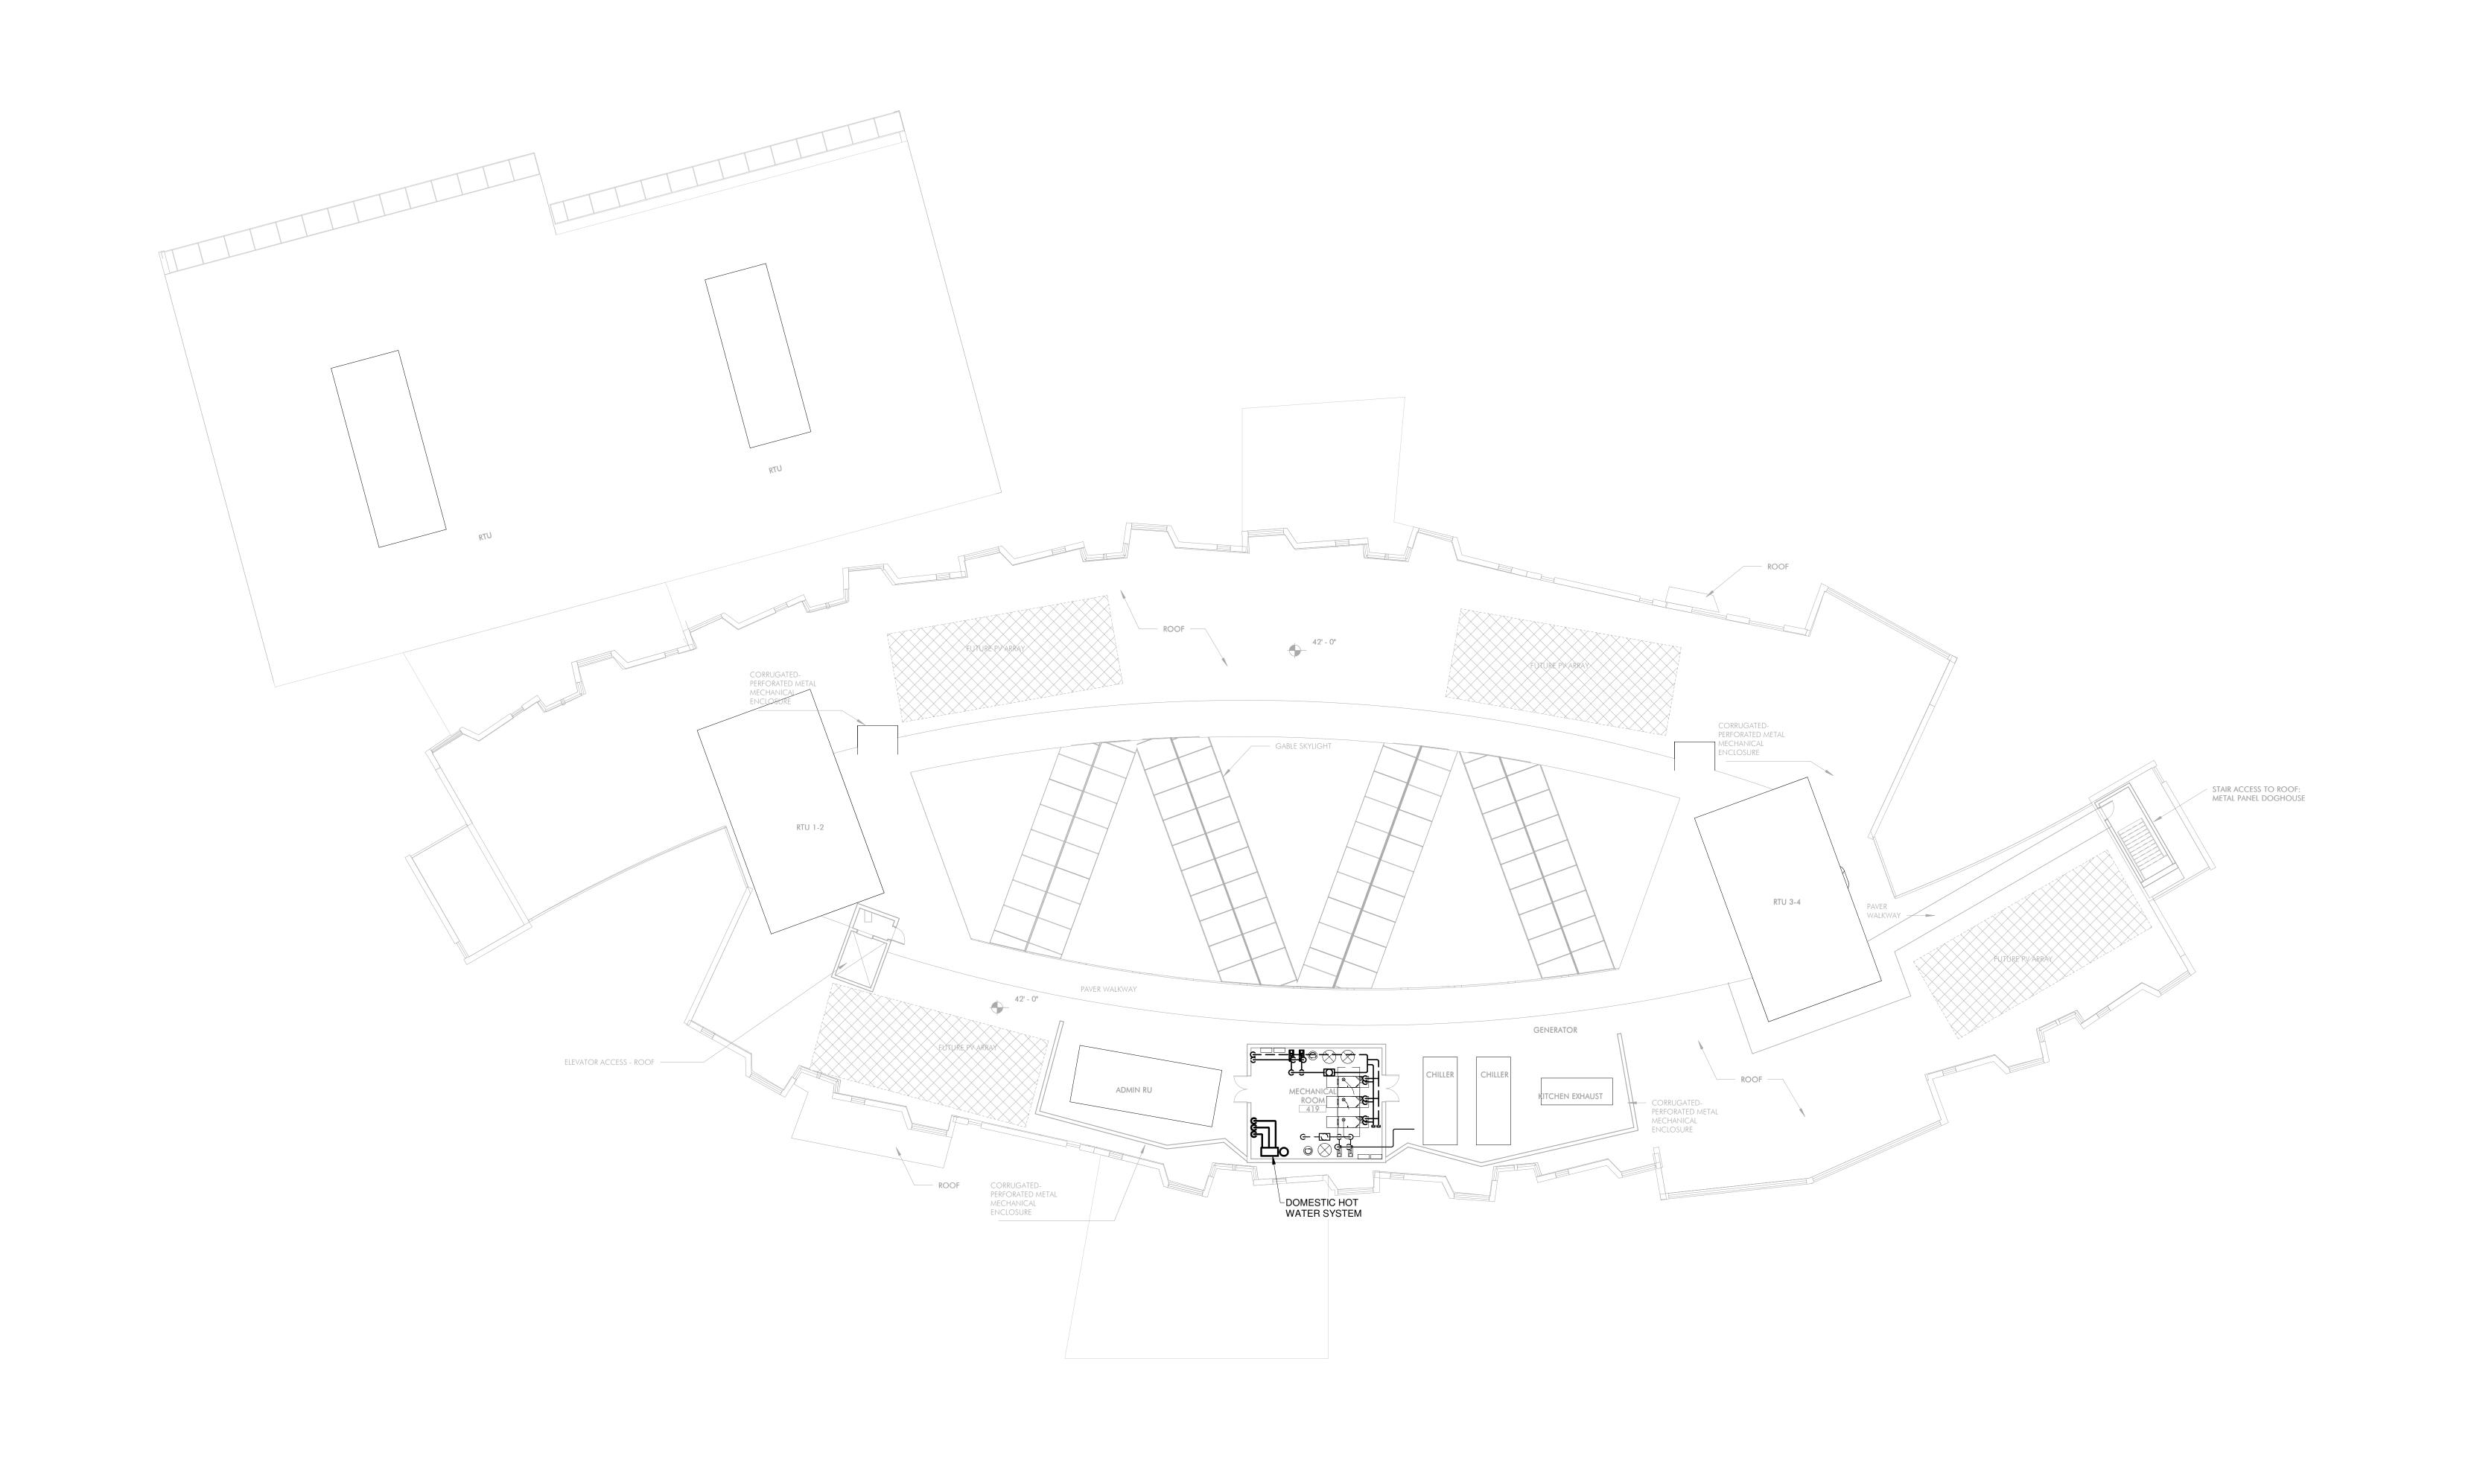

1 ROOF PLAN P1.04 1/16" = 1'-0" Jonathan Levi Architects

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fax 617 437 1965

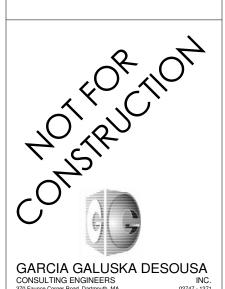

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PROJECT STATUS

SCHEMATIC DESIGN
09/07/18

REVISIONS

No. Date Description

ROOF PLAN -PLUMBING


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DRAWING NO.

P1.04





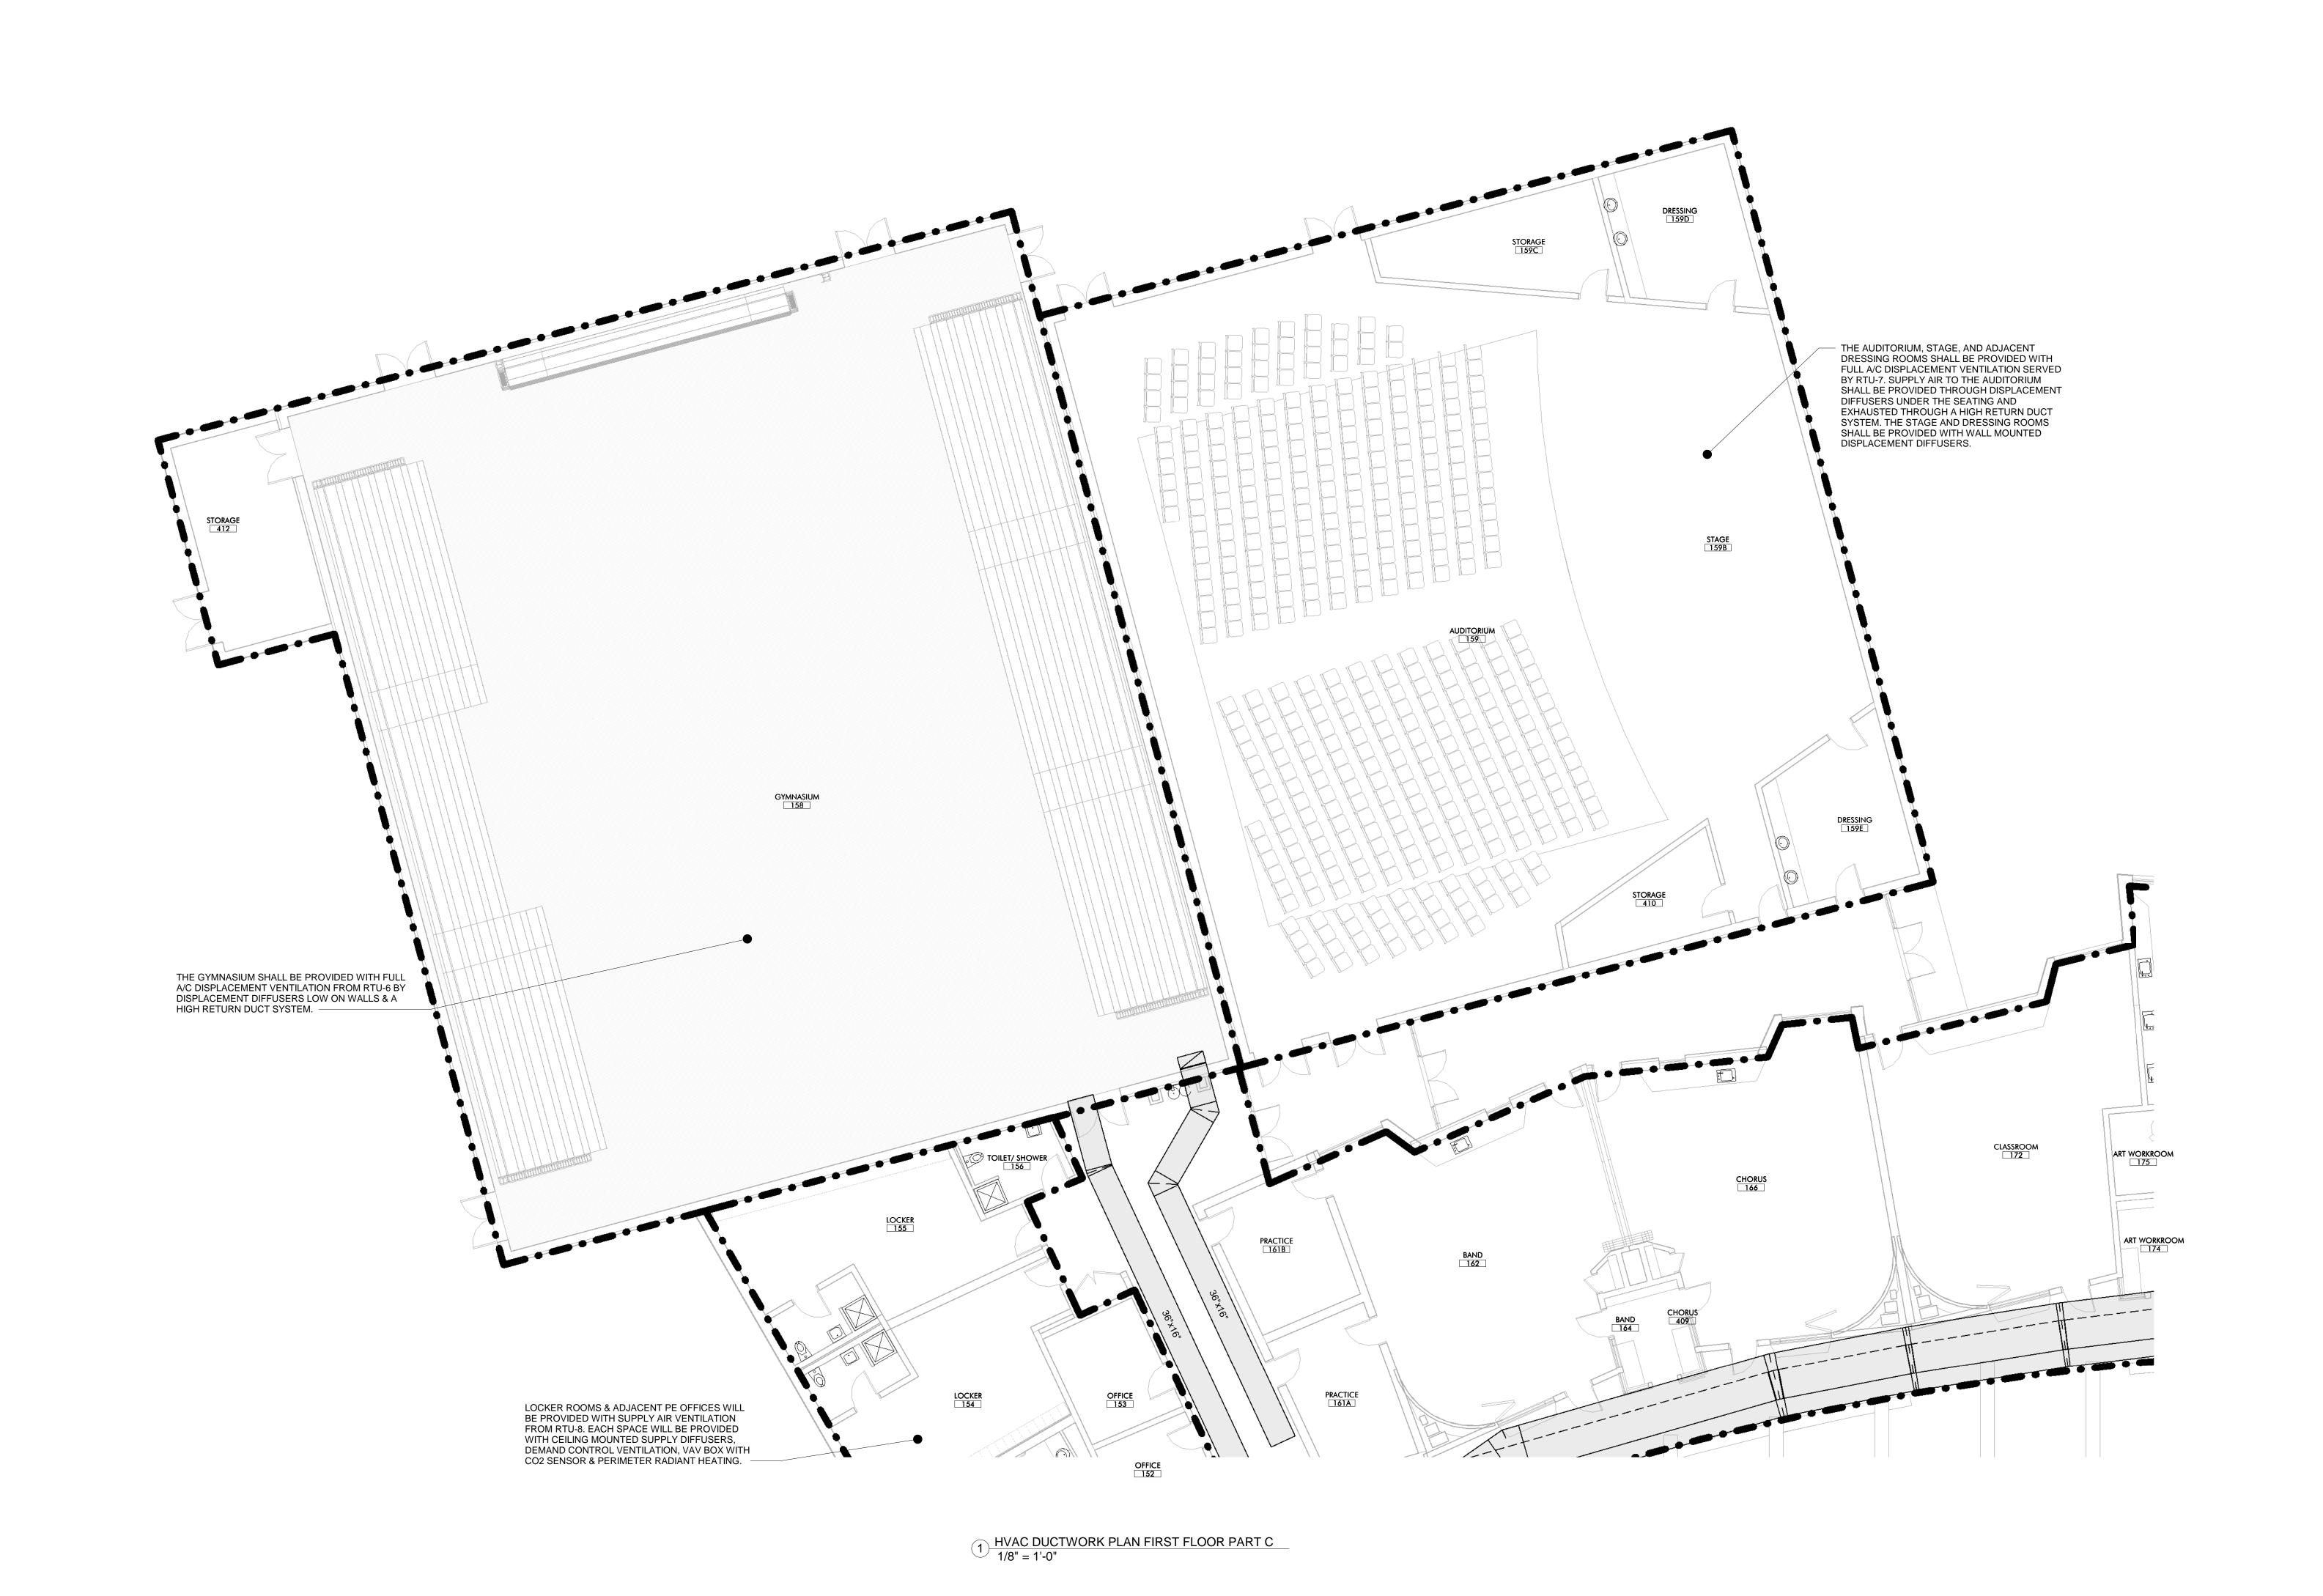

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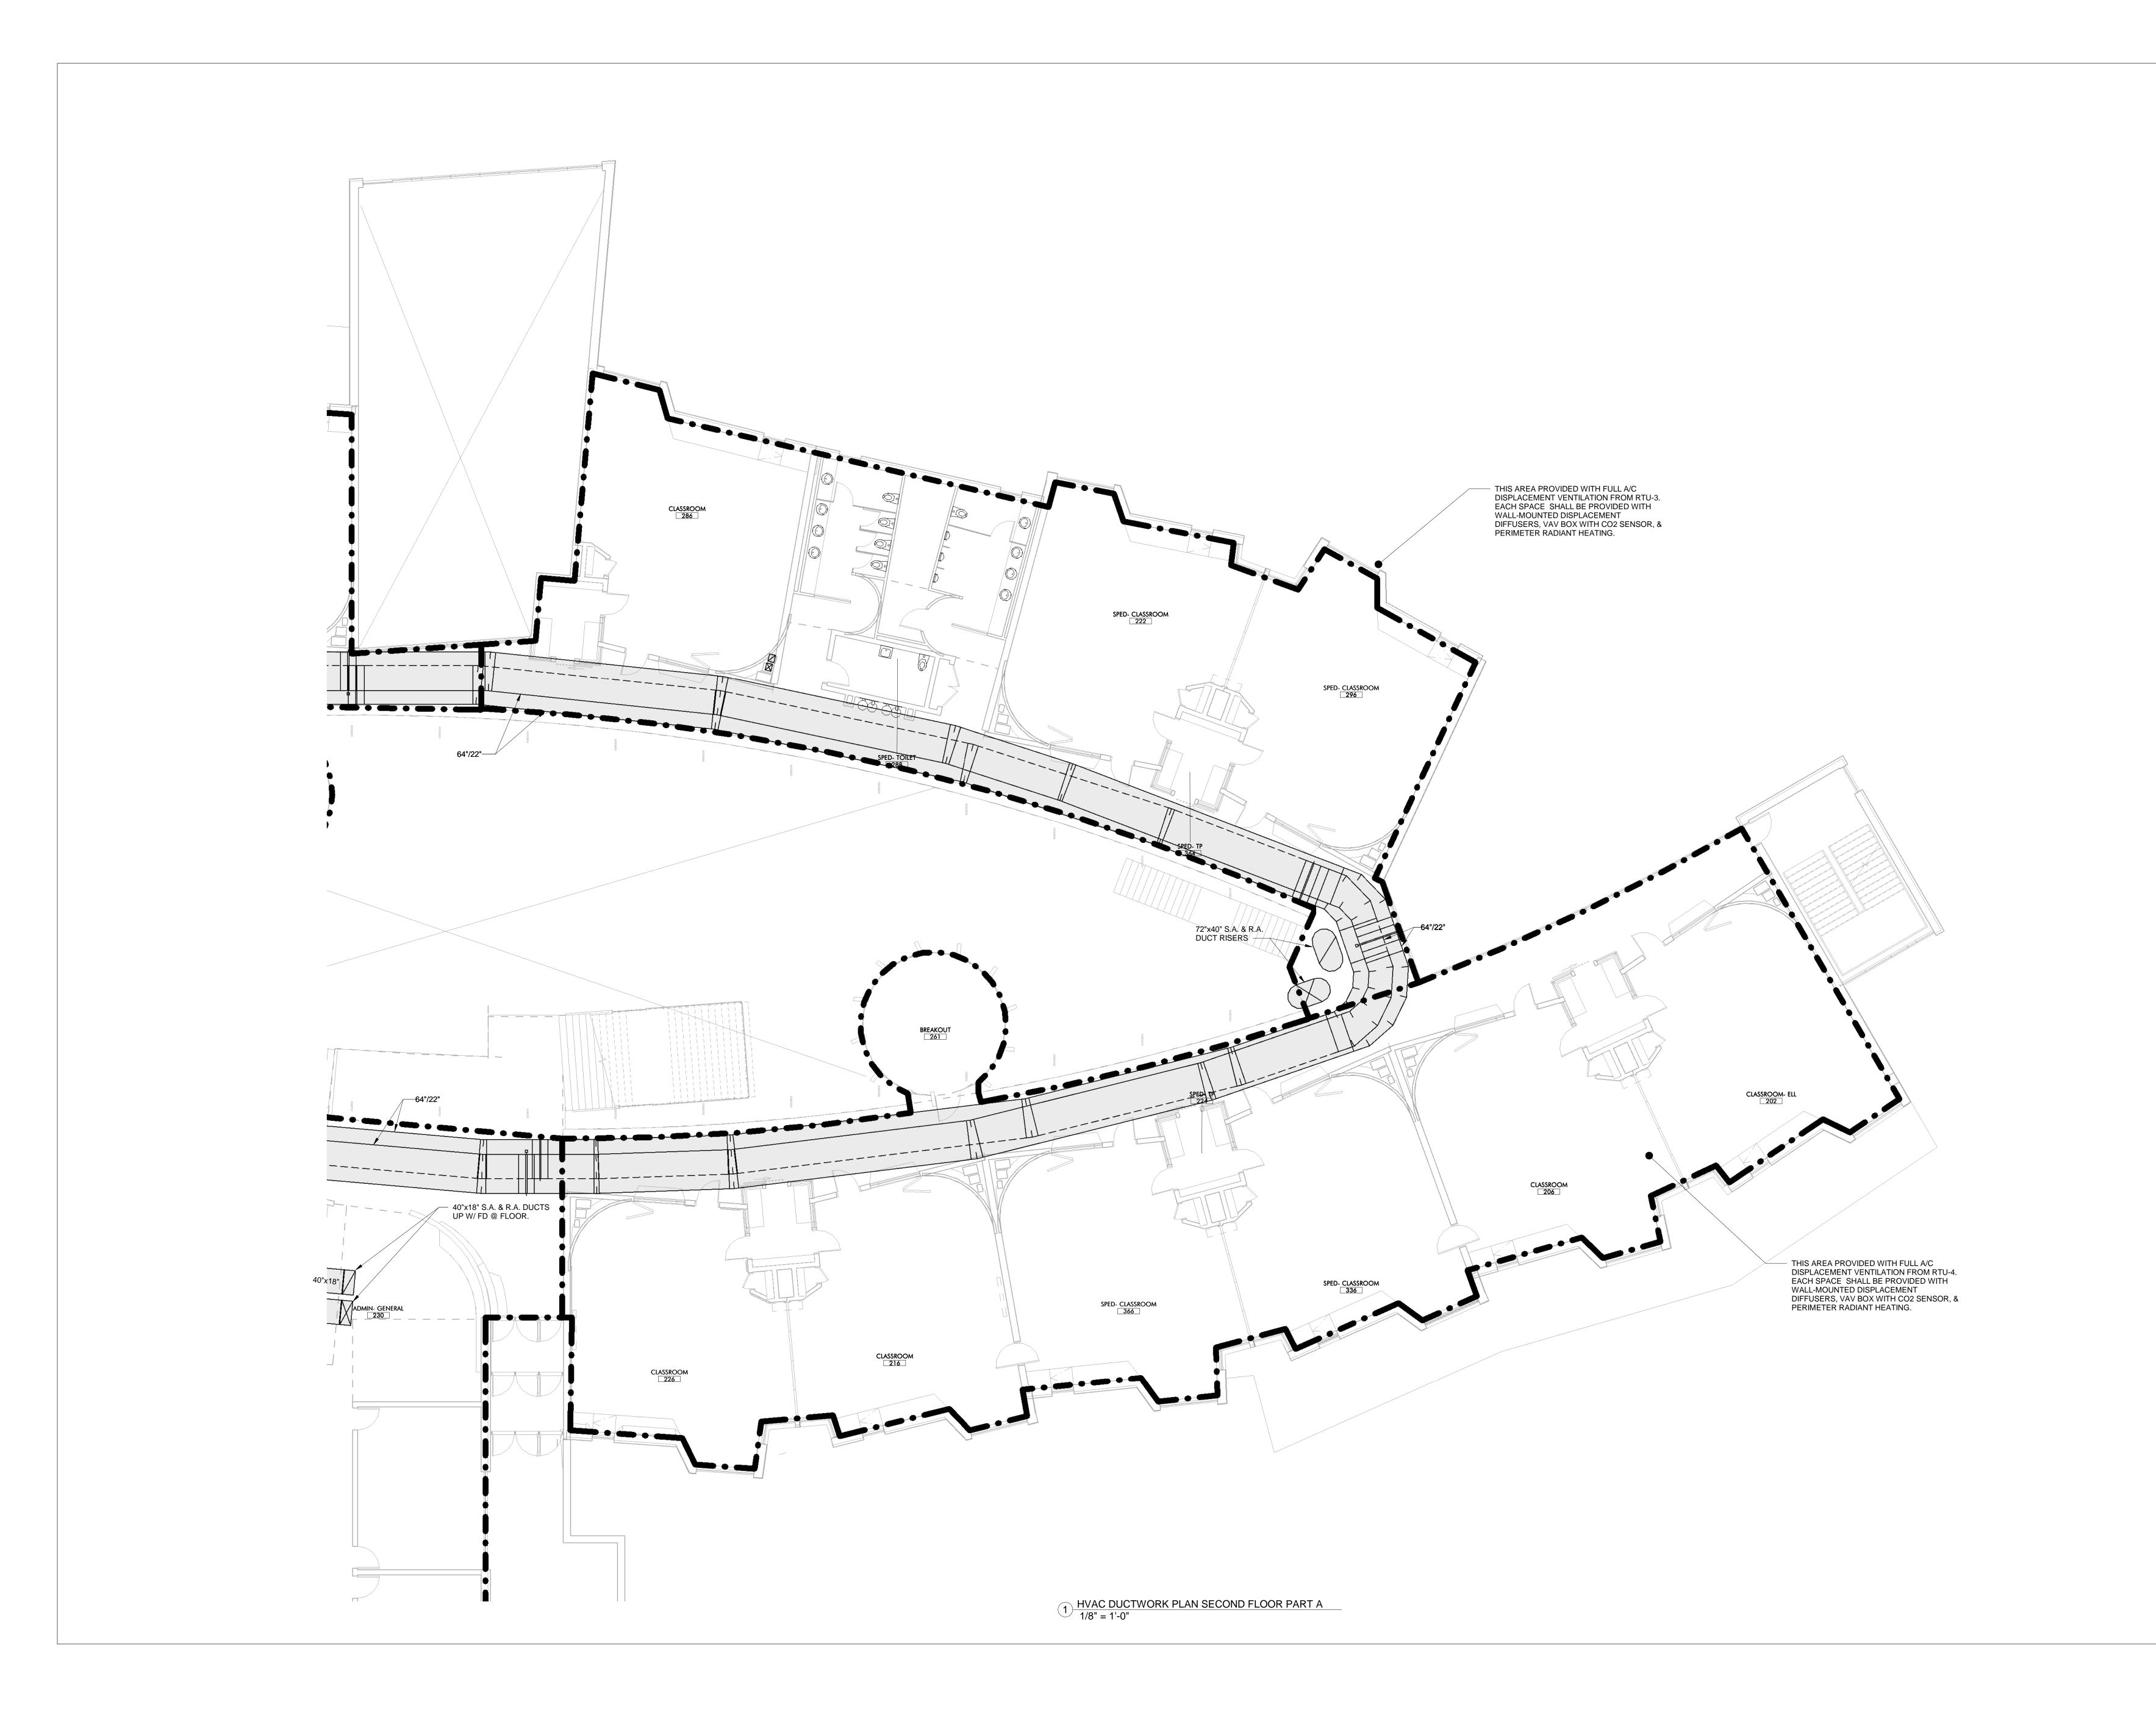
Issue Date

REVISIONS

DRAWING NAME DUCTWORK PLAN FLOOR 1-C - HVAC

> PROJECT NO. Project Number DRAWING NO.





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FULLER SCHOOL
3 FLAGG DRIVE, FRAMINGHAM, MA

PROJECT STATUS

Issue Date 09/07/18

REVISIONS


No. Date [

DUCTWORK PLAN FLOOR 2-A - HVAC

PROJECT NO. Project Number

DRAWING NO.

M102A

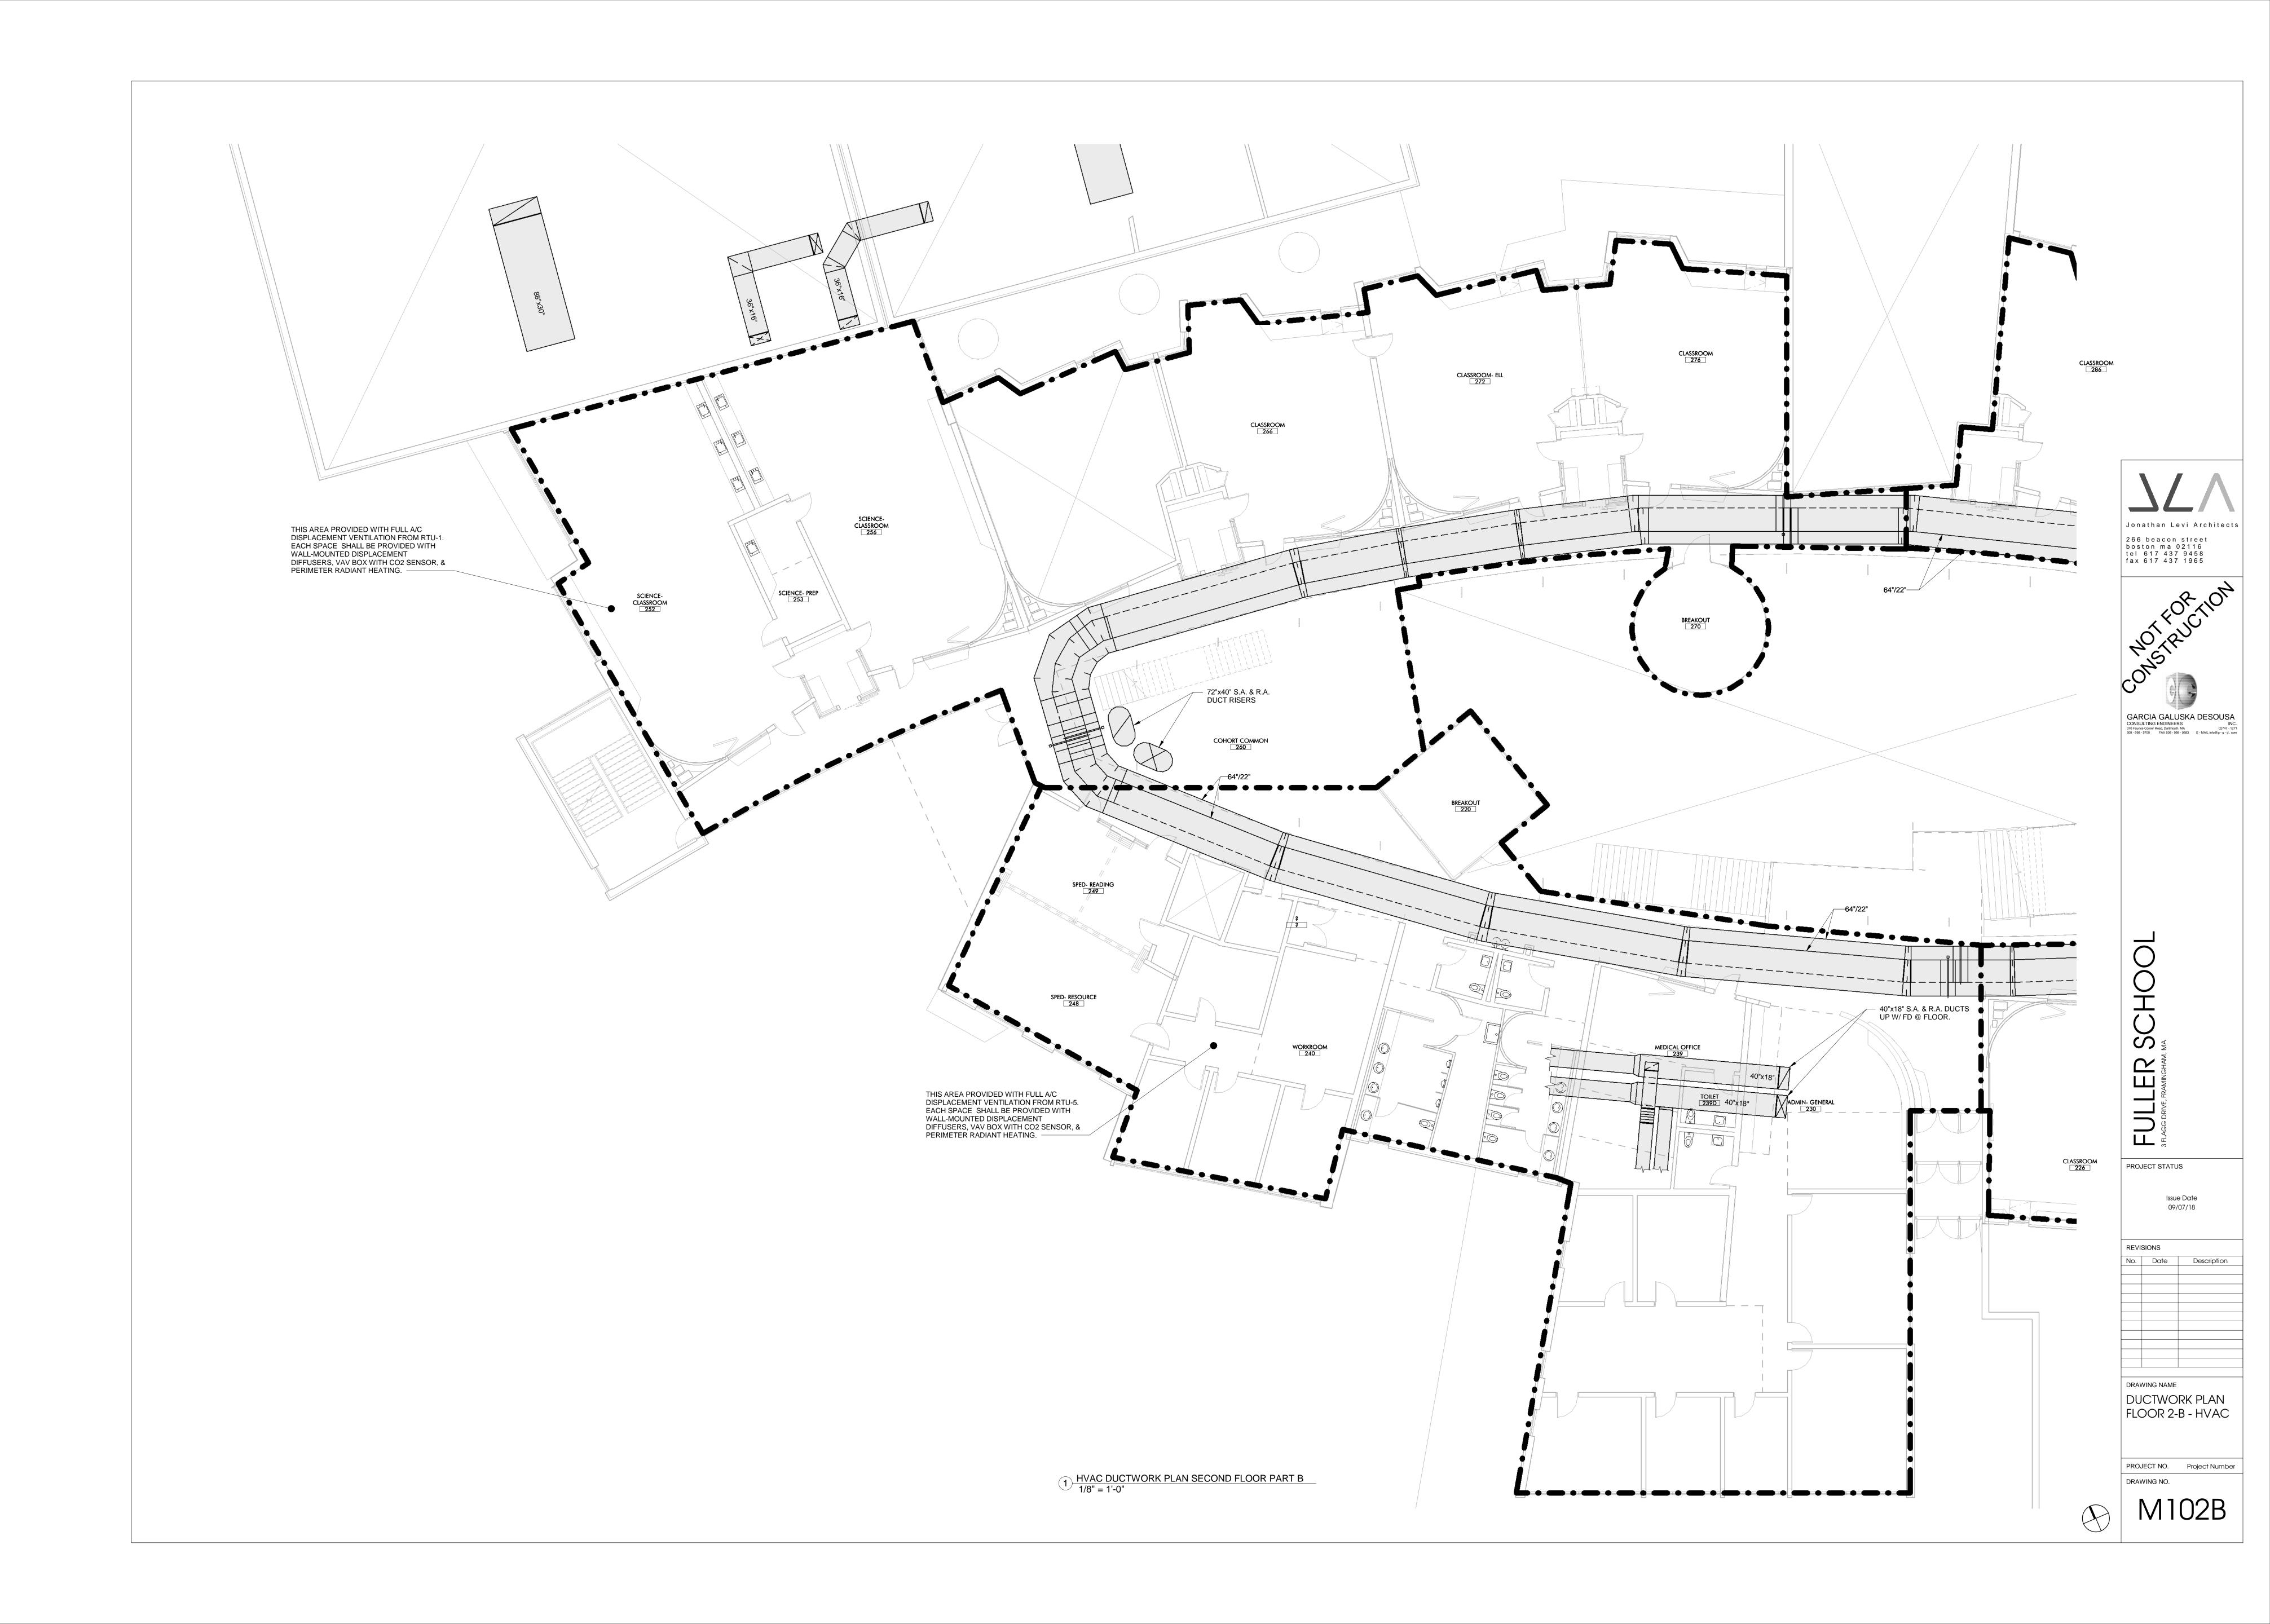

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PROJECT STATUS

Issue Date 09/07/18

REVISIONS

No. Date Description

DRAWING NAME DUCTWORK PLAN FLOOR 2-C - HVAC

PROJECT NO. Project Number





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PROJECT STATUS


Issue Date

09/07/18

REVISIONS

DRAWING NAME DUCTWORK PLAN FLOOR 3-A - HVAC

PROJECT NO. Project Number DRAWING NO.

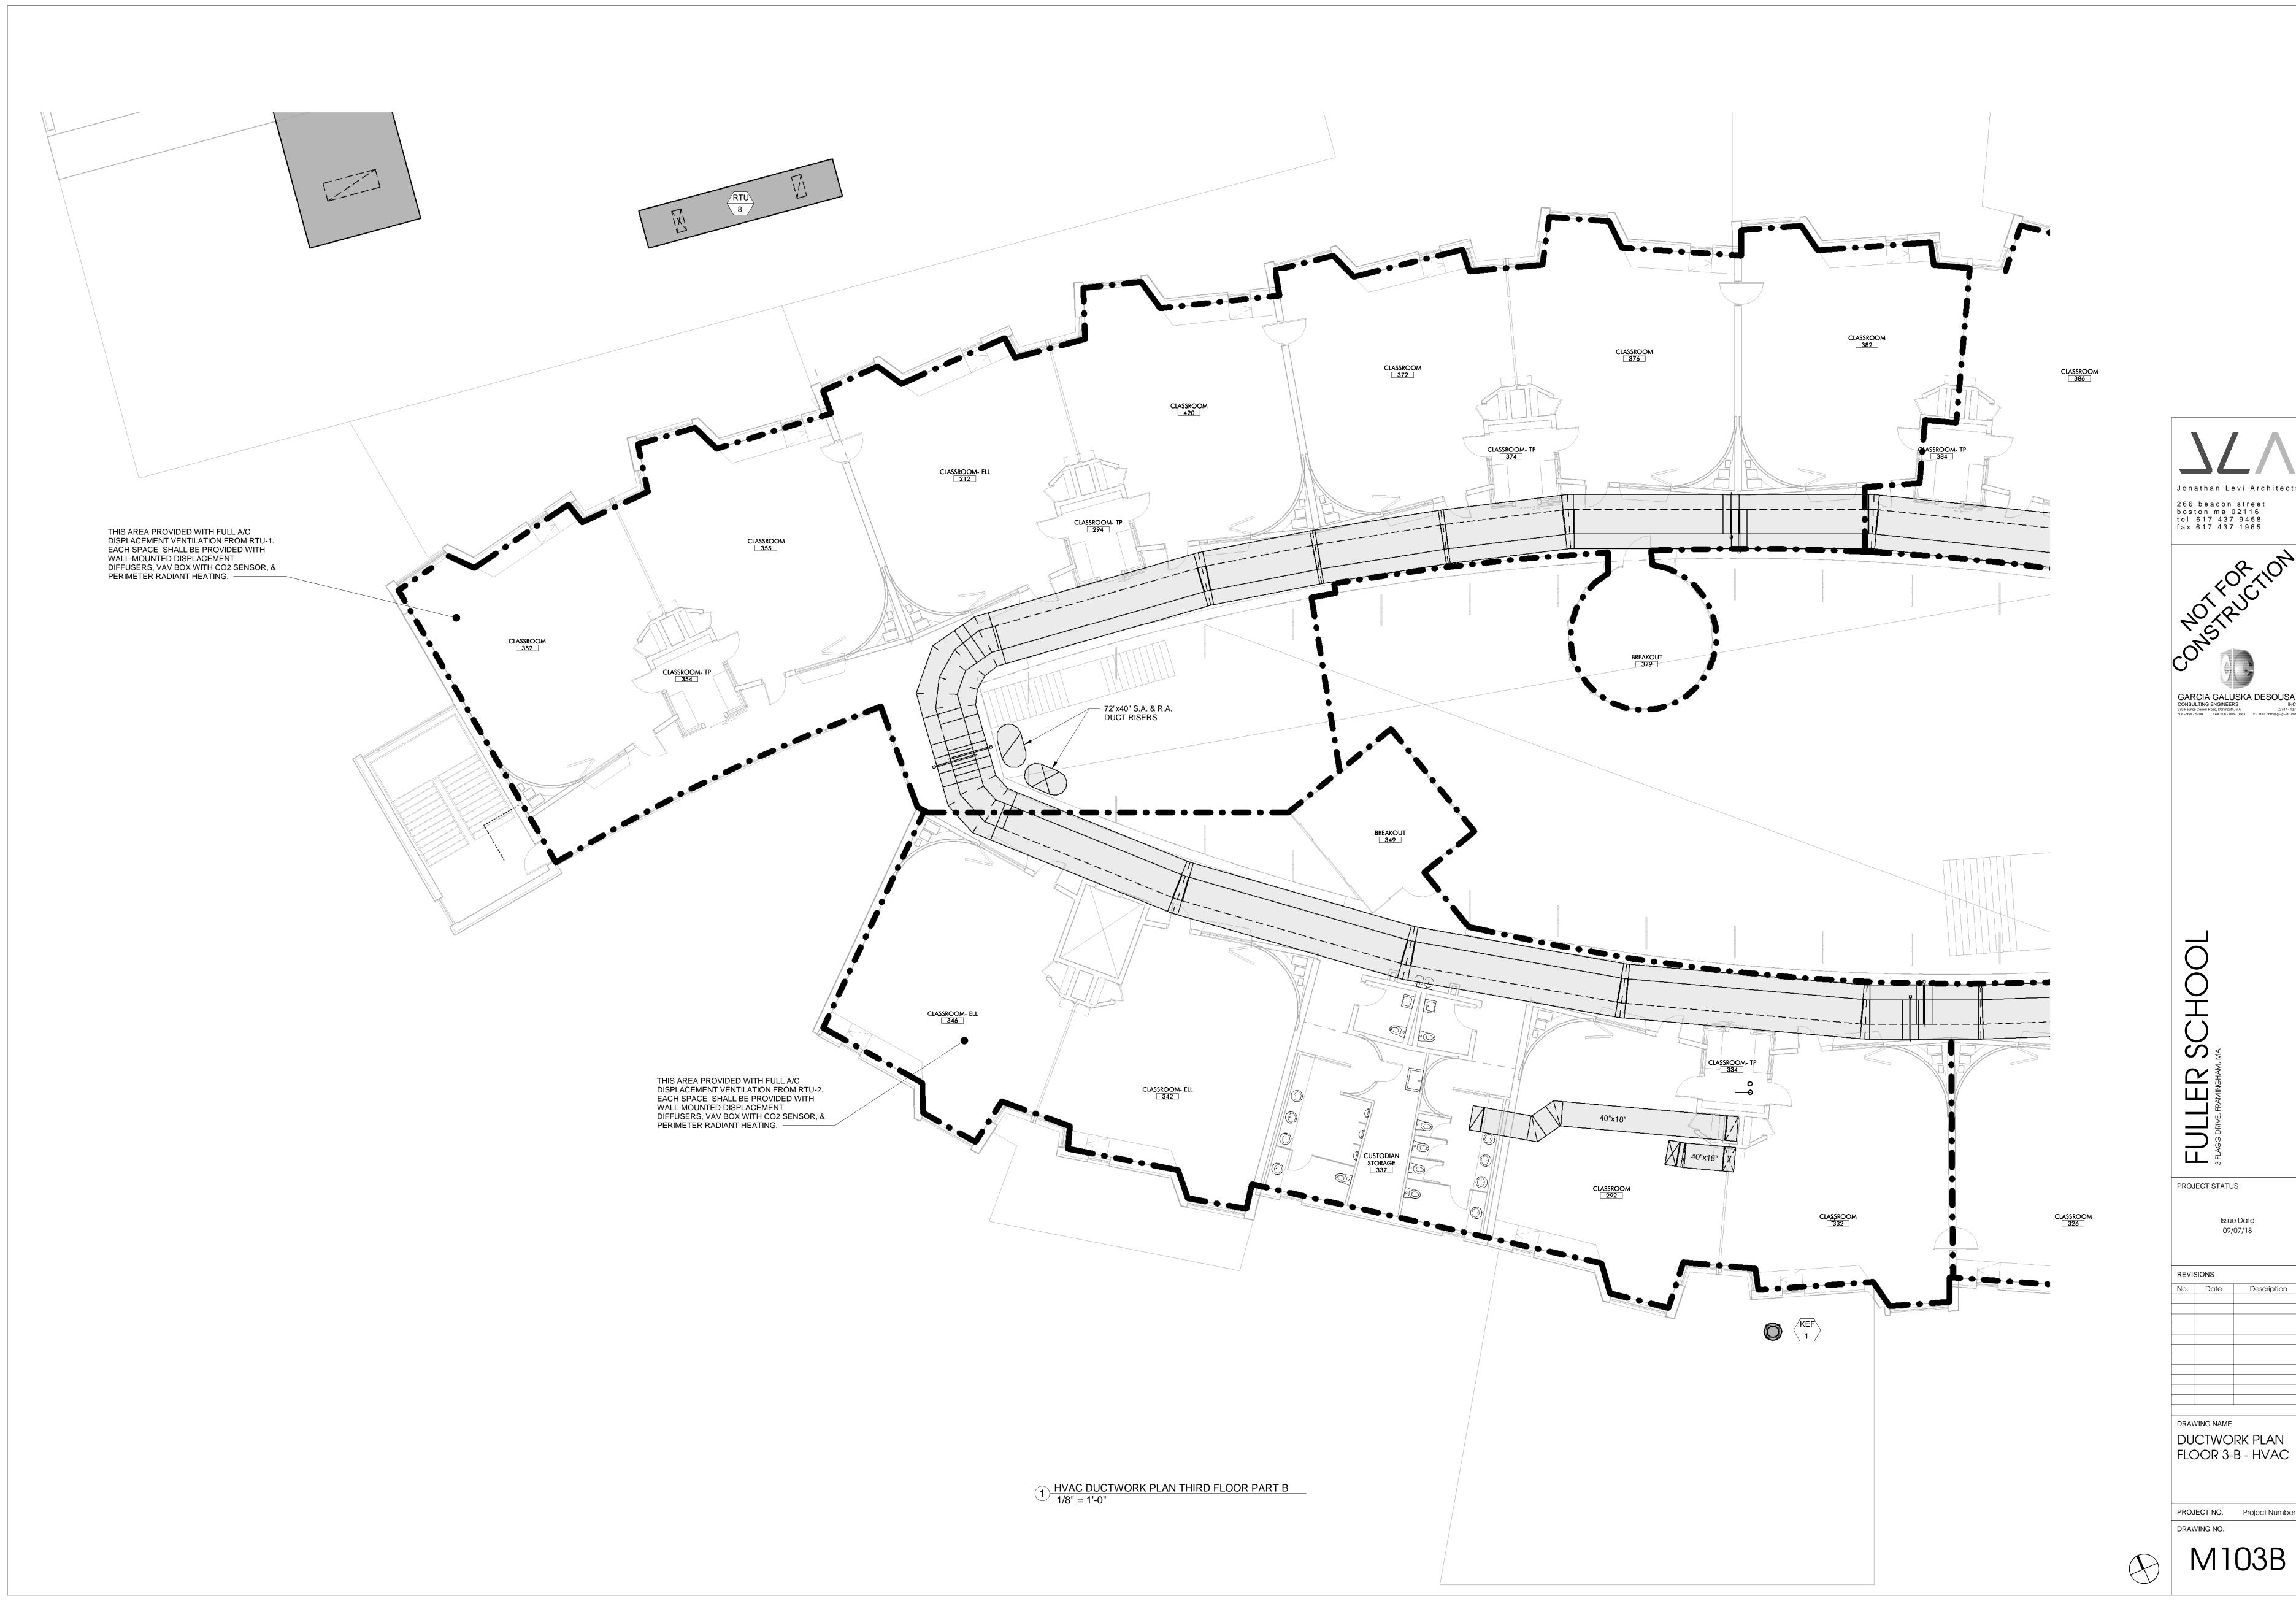

Jonathan Levi Architects



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PROJECT NO. Project Number

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SCHOOL


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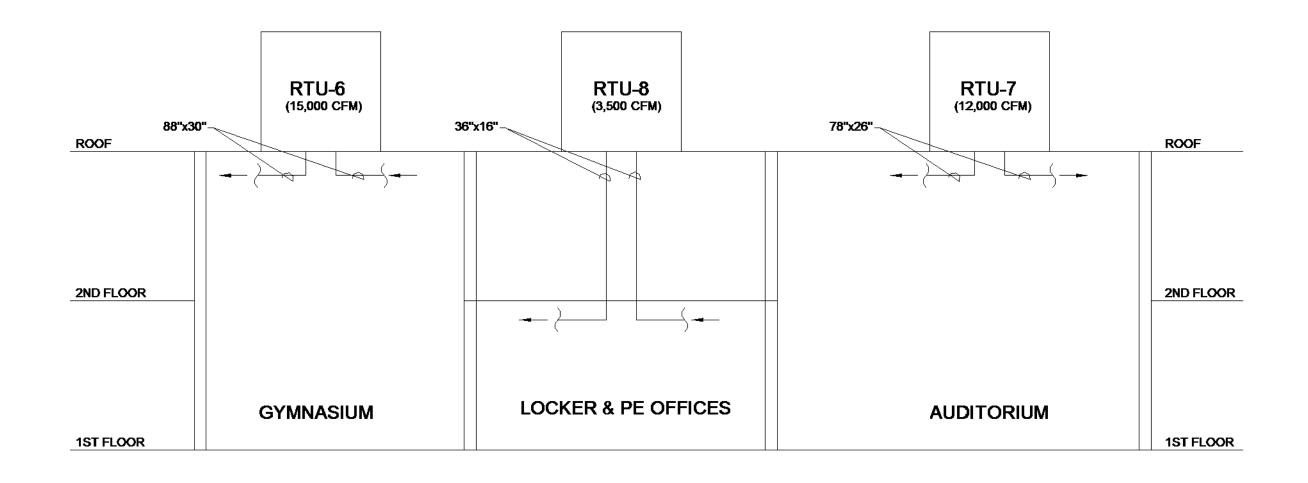
Issue Date 09/07/18

REVISIONS No. Date Description

DRAWING NAME DUCTWORK PLAN FLOOR 3-C - HVAC


PROJECT NO. Project Number DRAWING NO.



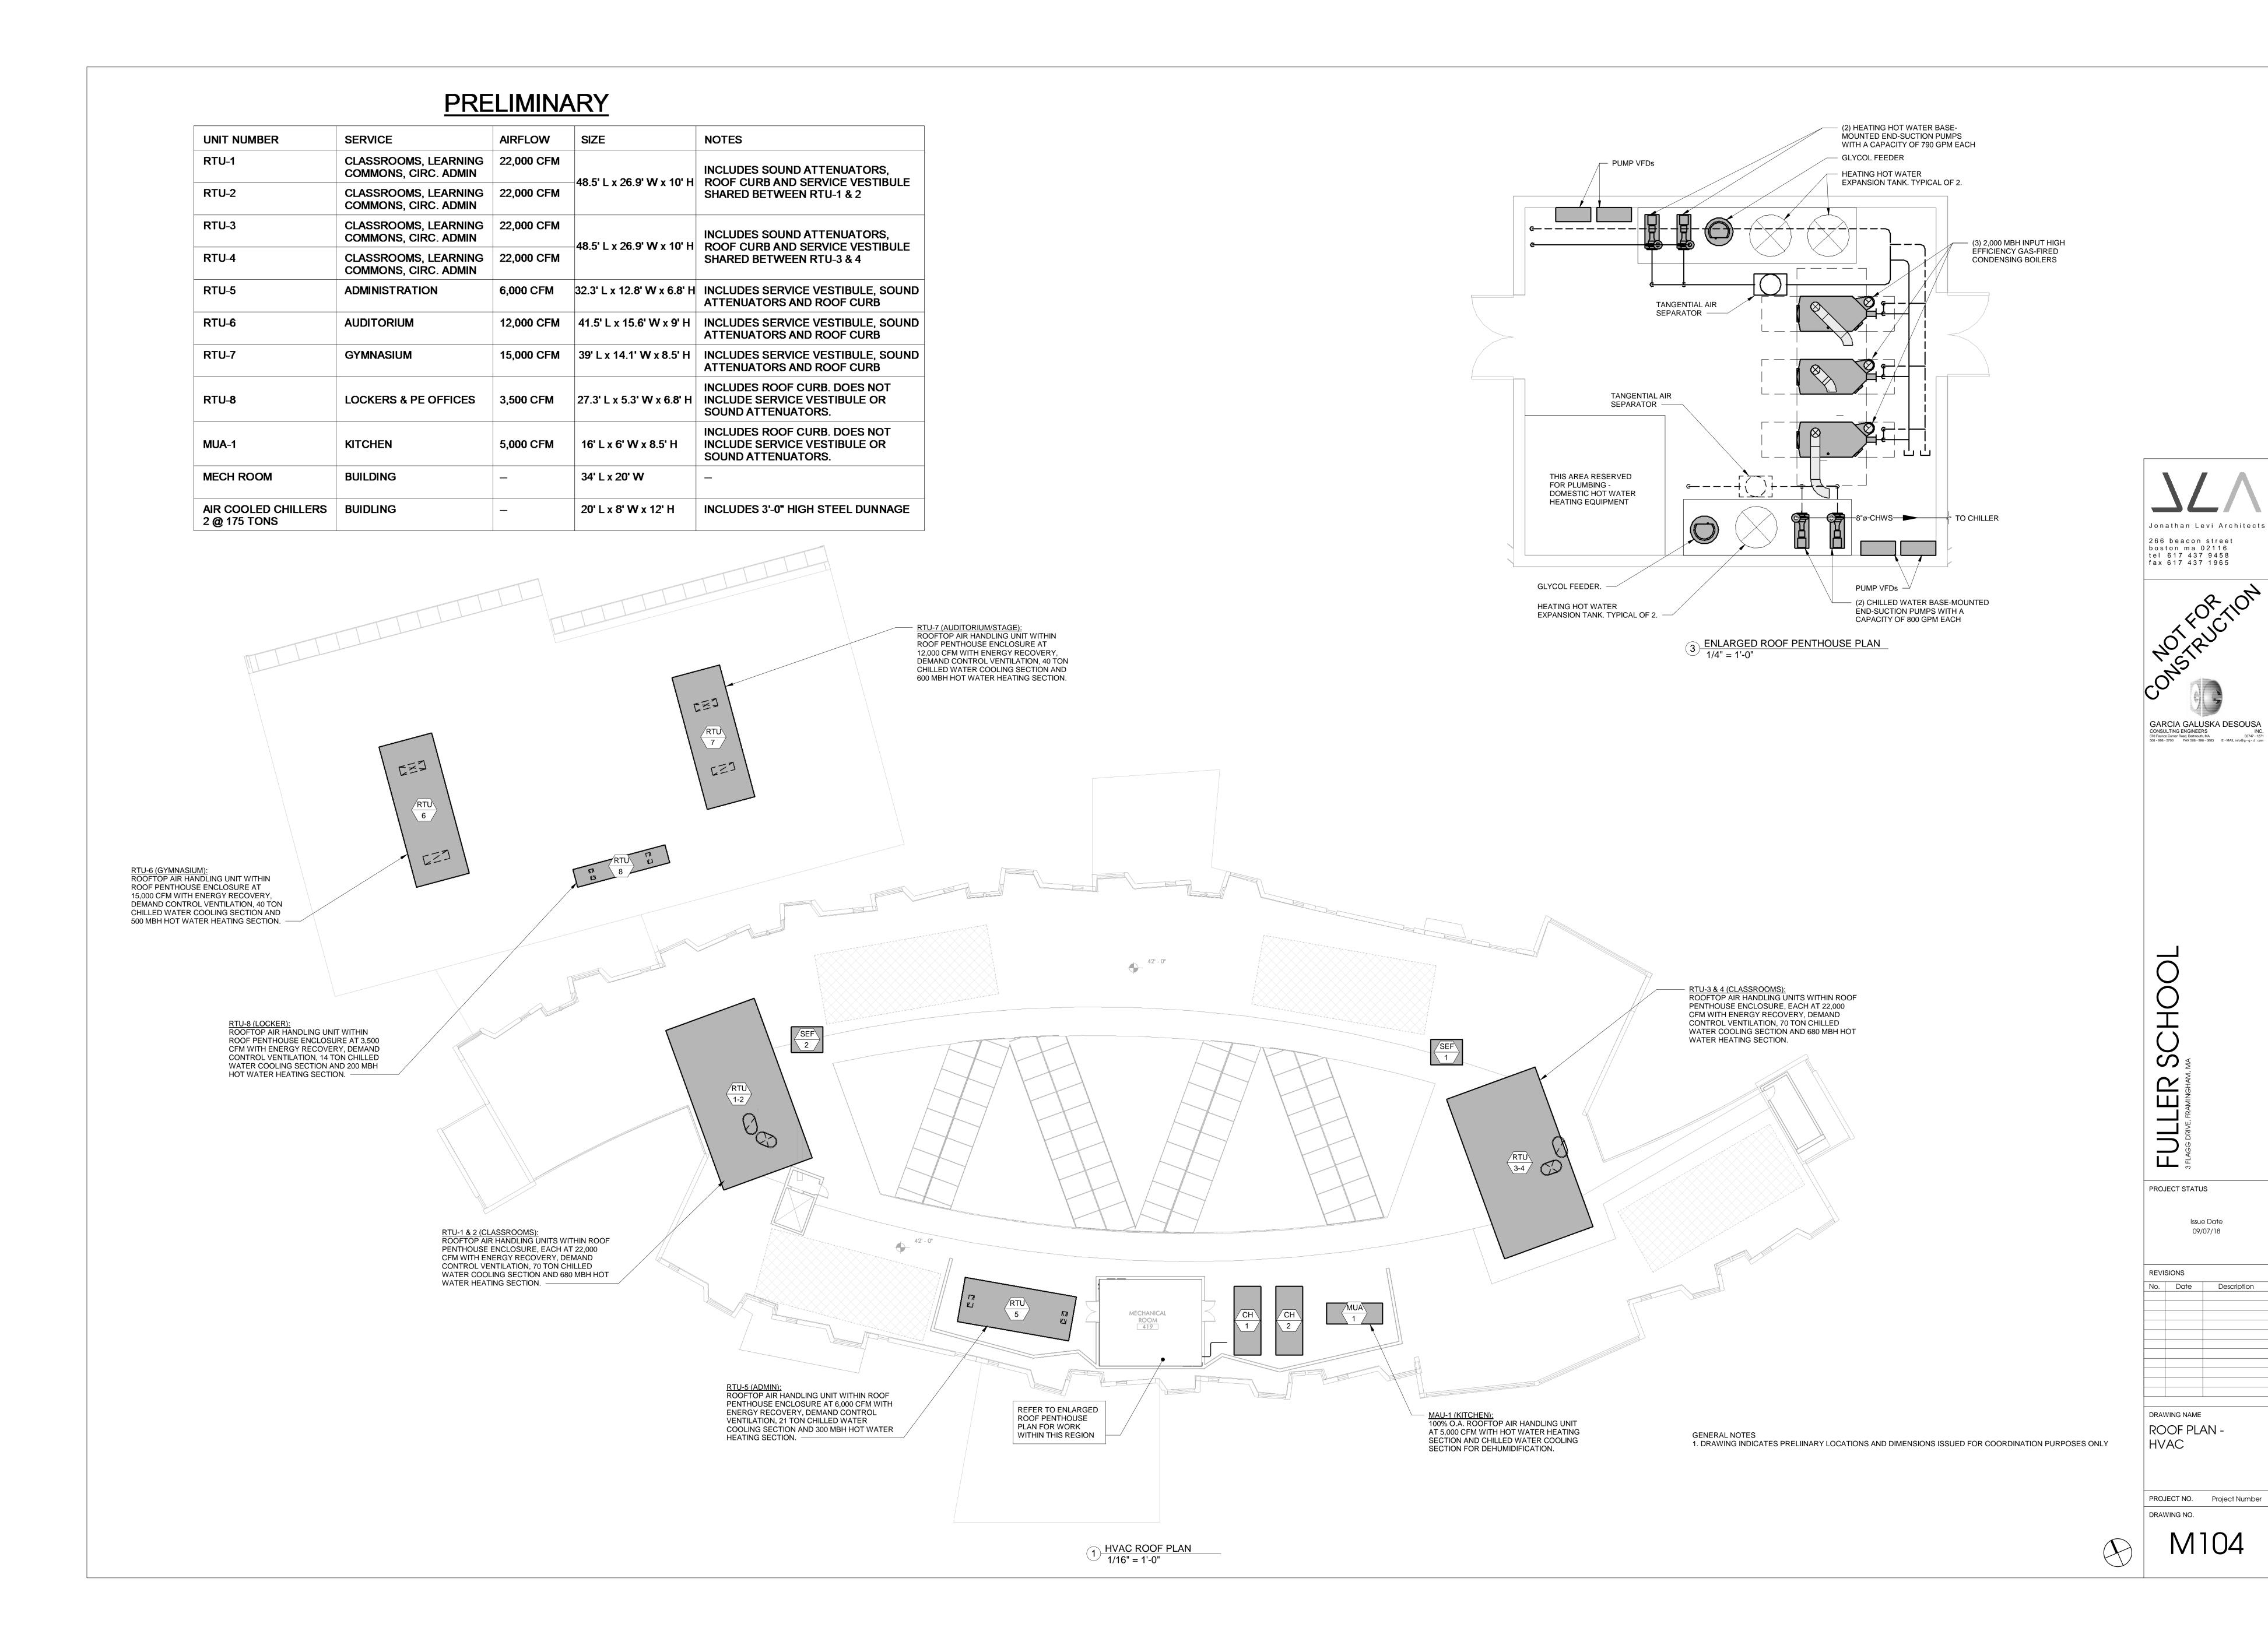

AIRFLOW DIAGRAMS



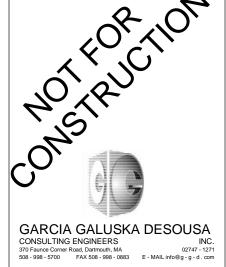


SCHOOL


PROJECT STATUS

REVISIONS

Issue Date 09/07/18

DRAWING NAME AHU AIRFLOW DIAGRAM

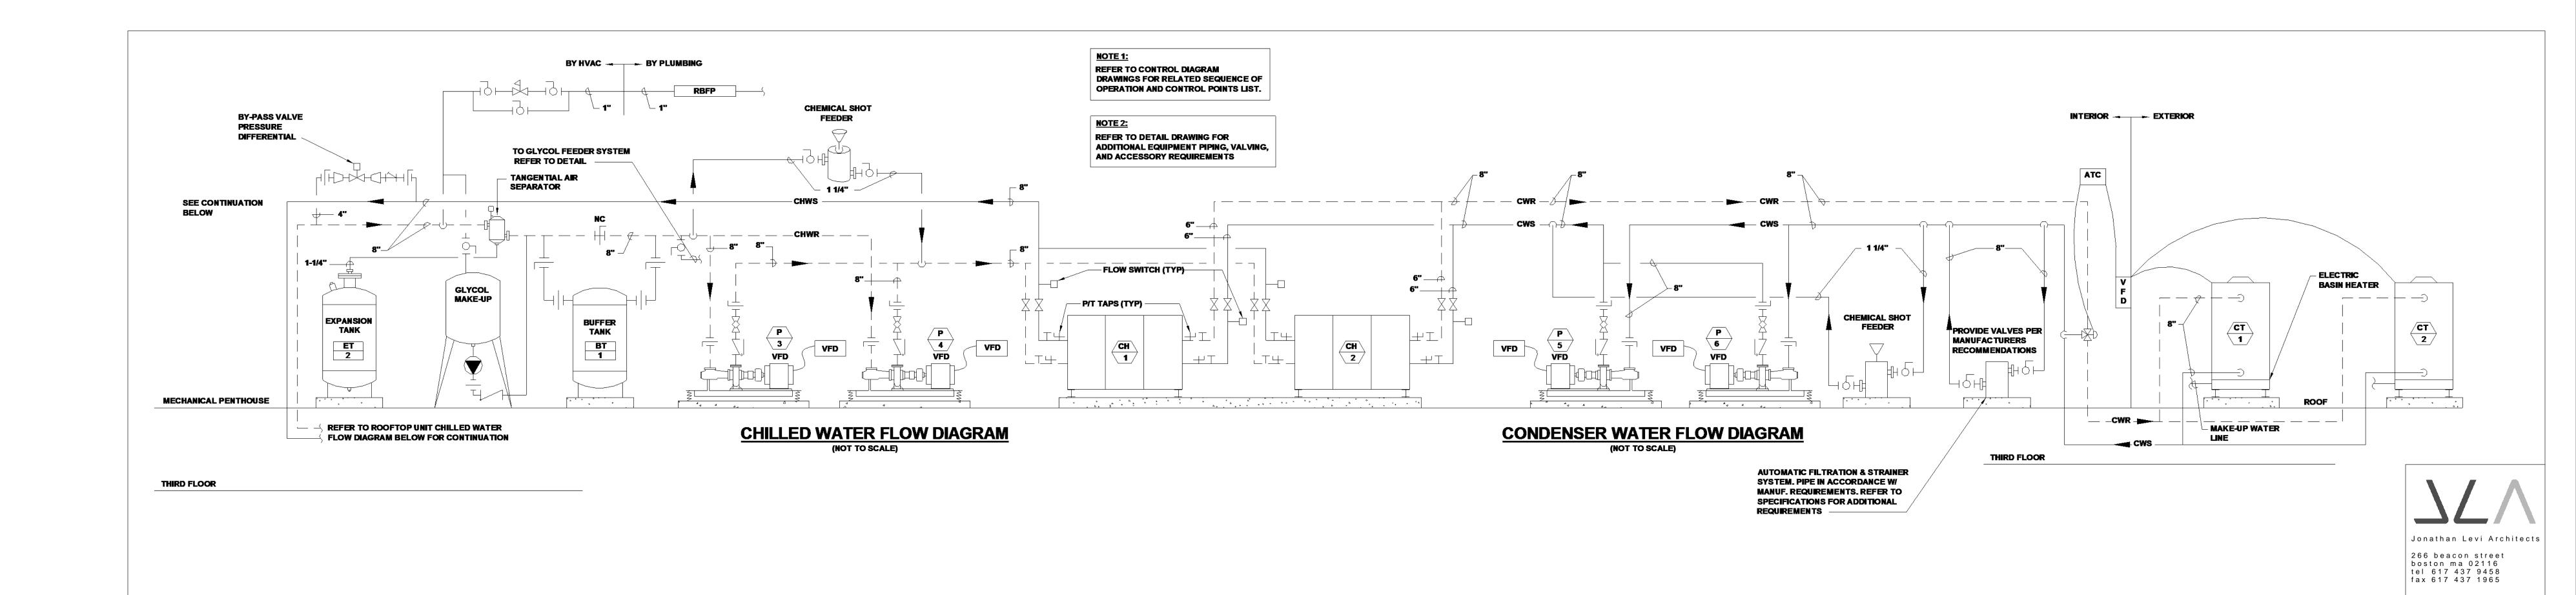

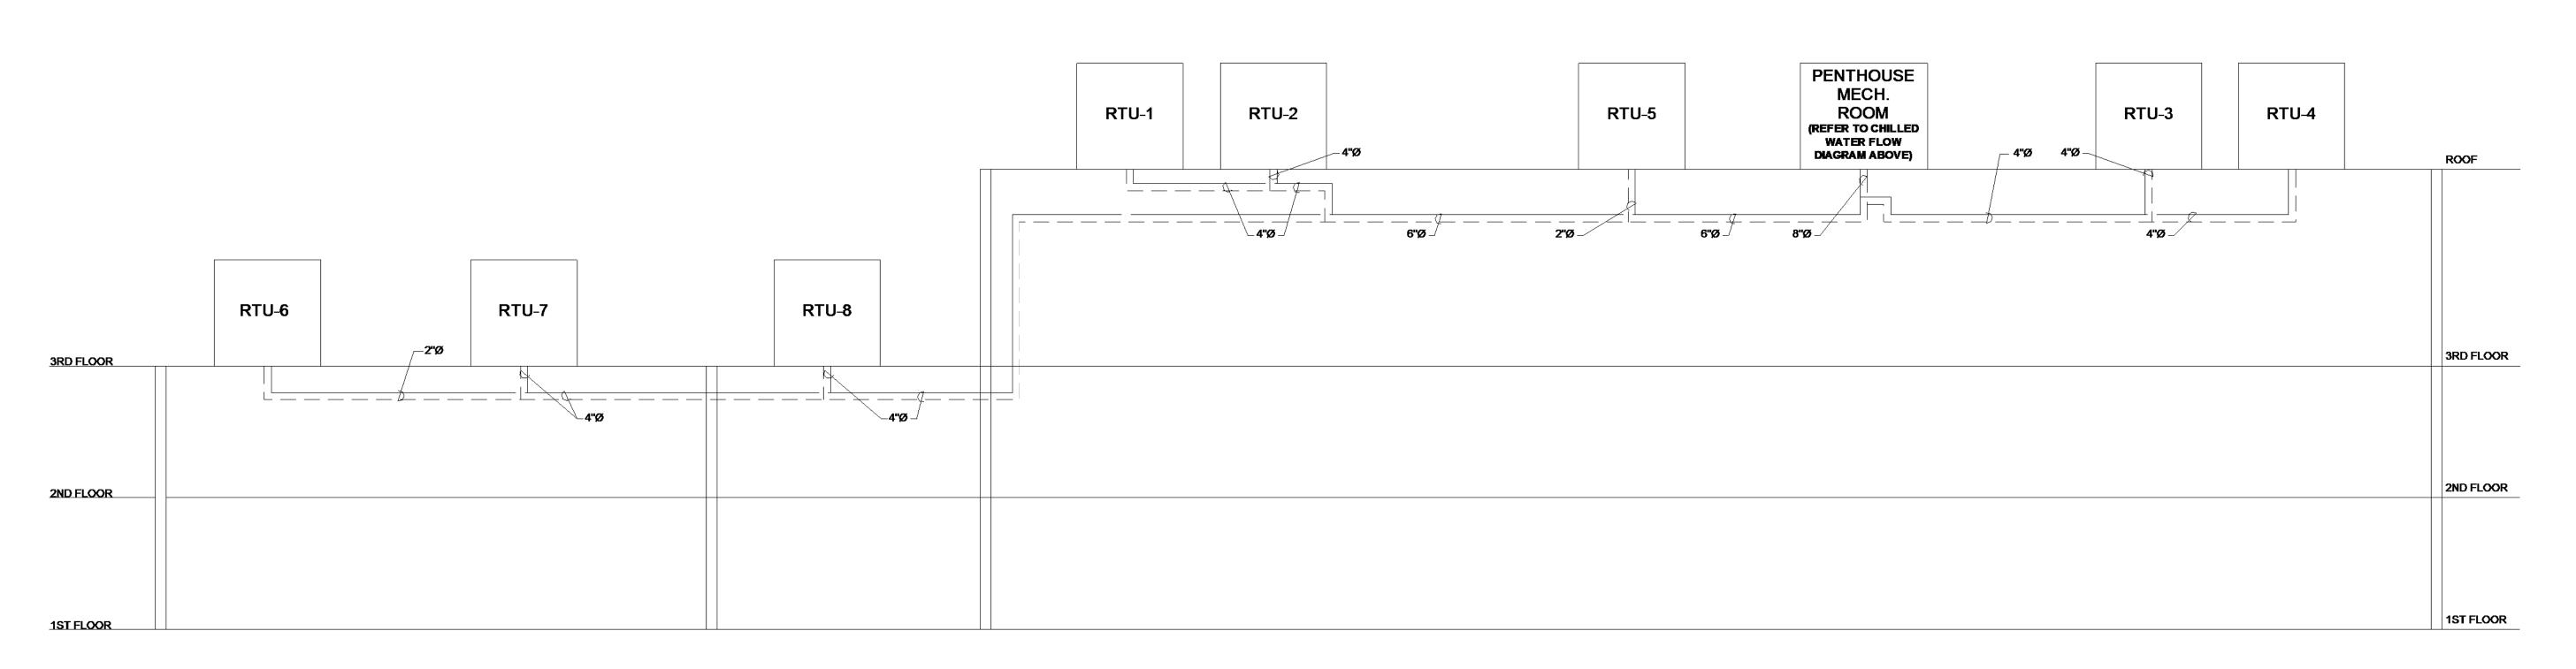

ROOFTOP UNIT CHILLED WATER FLOW DIAGRAM

FULLER Issue Date 09/07/18

GARCIA GALUSKA DESOUSA

CONSULTING ENGINEERS


370 Faunce Corner Road, Dartmouth, MA
508 - 998 - 5700


FAX 508 - 998 - 6 - 0 CORNER

E - MAIL info@g - g - d . corn

PROJECT STATUS

DRAWING NAME CHW FLOW DIAGRAM

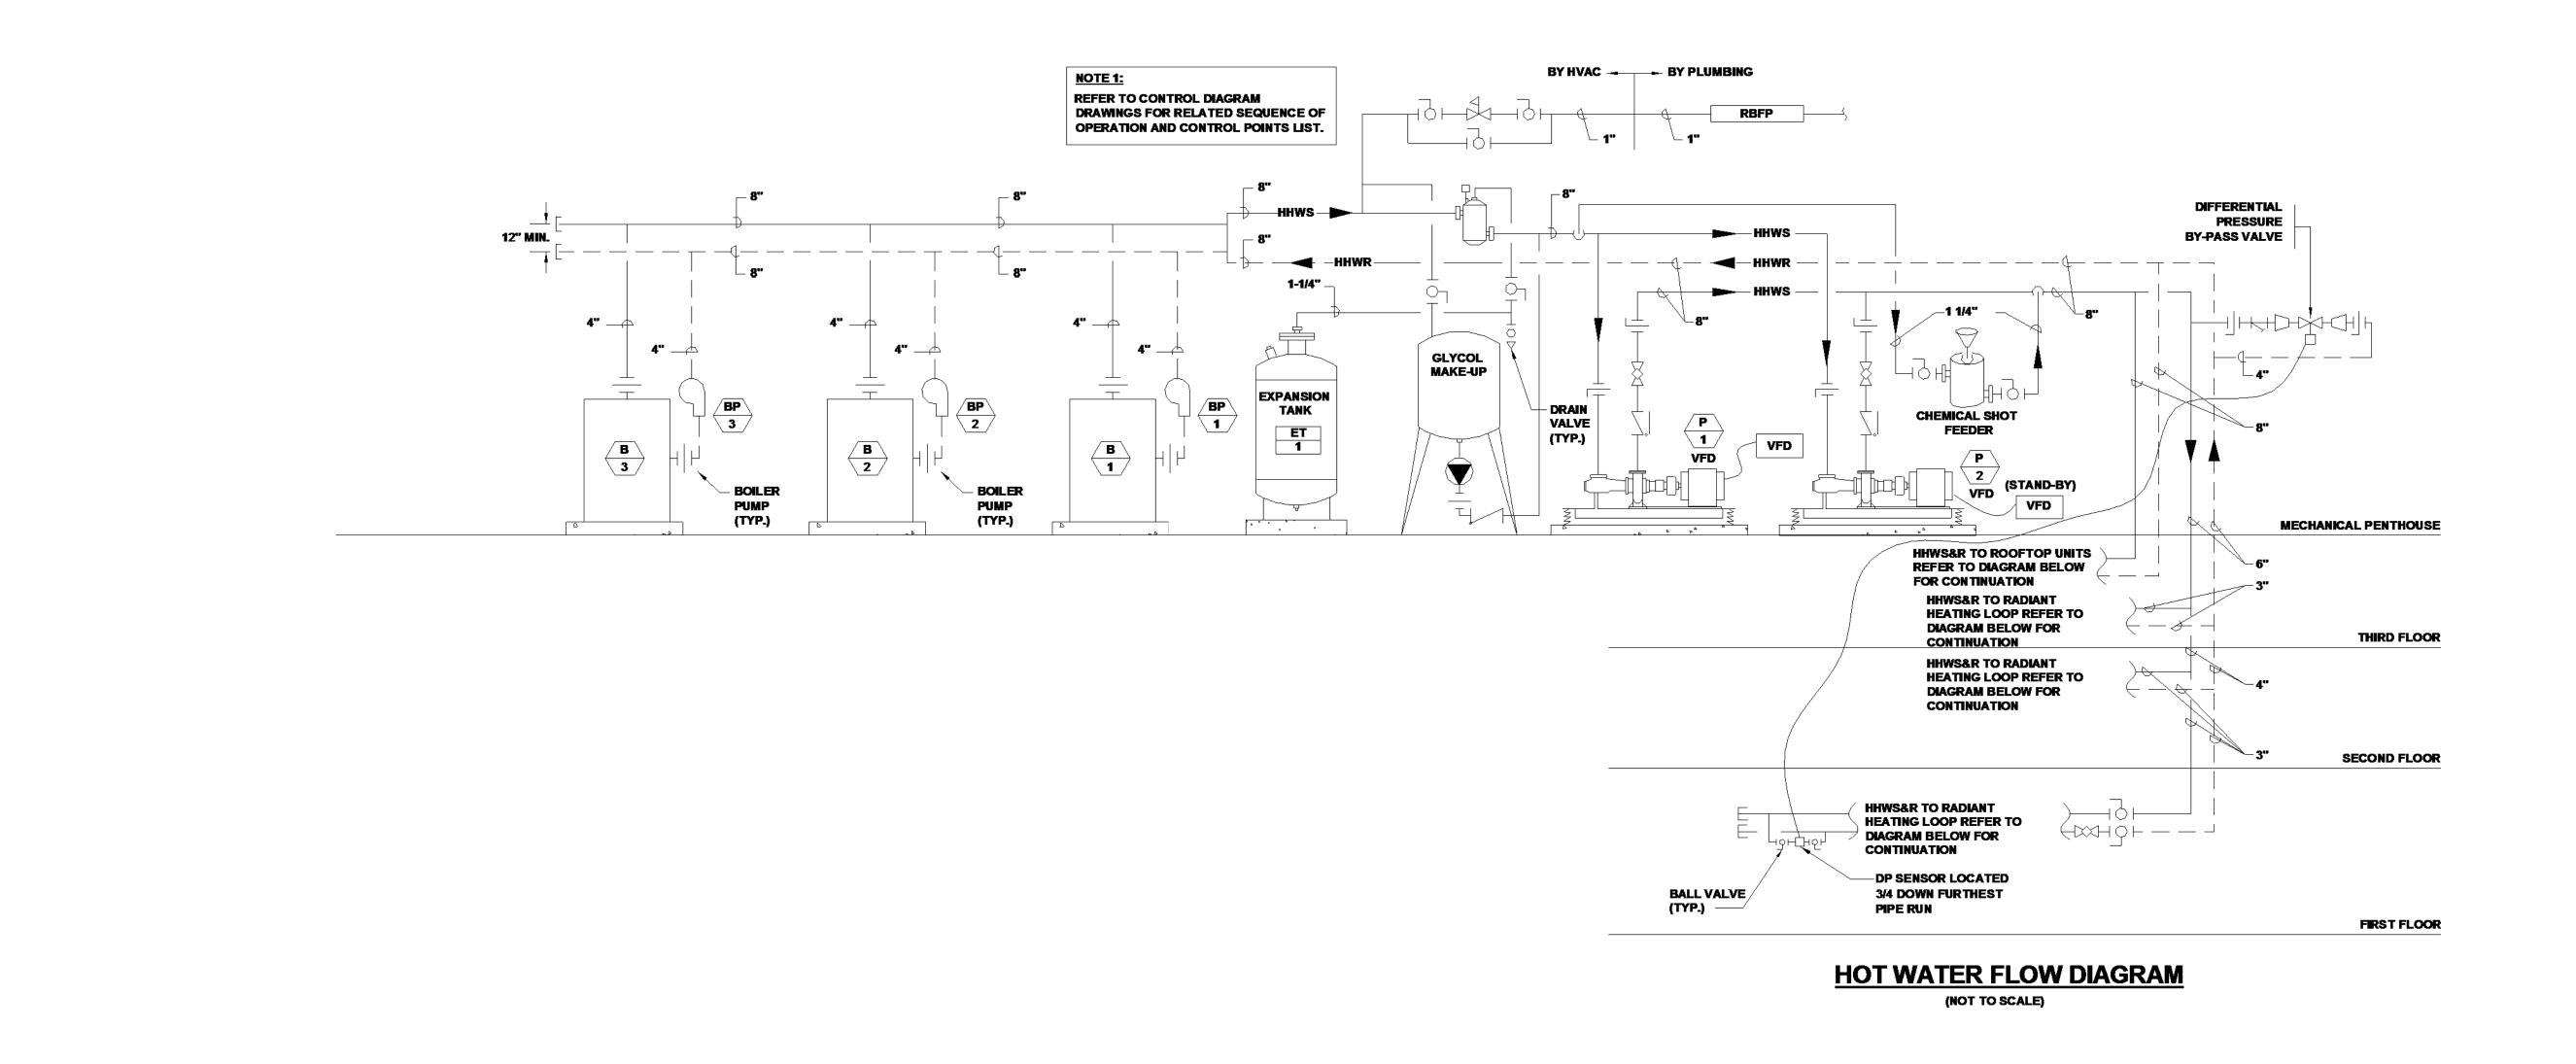

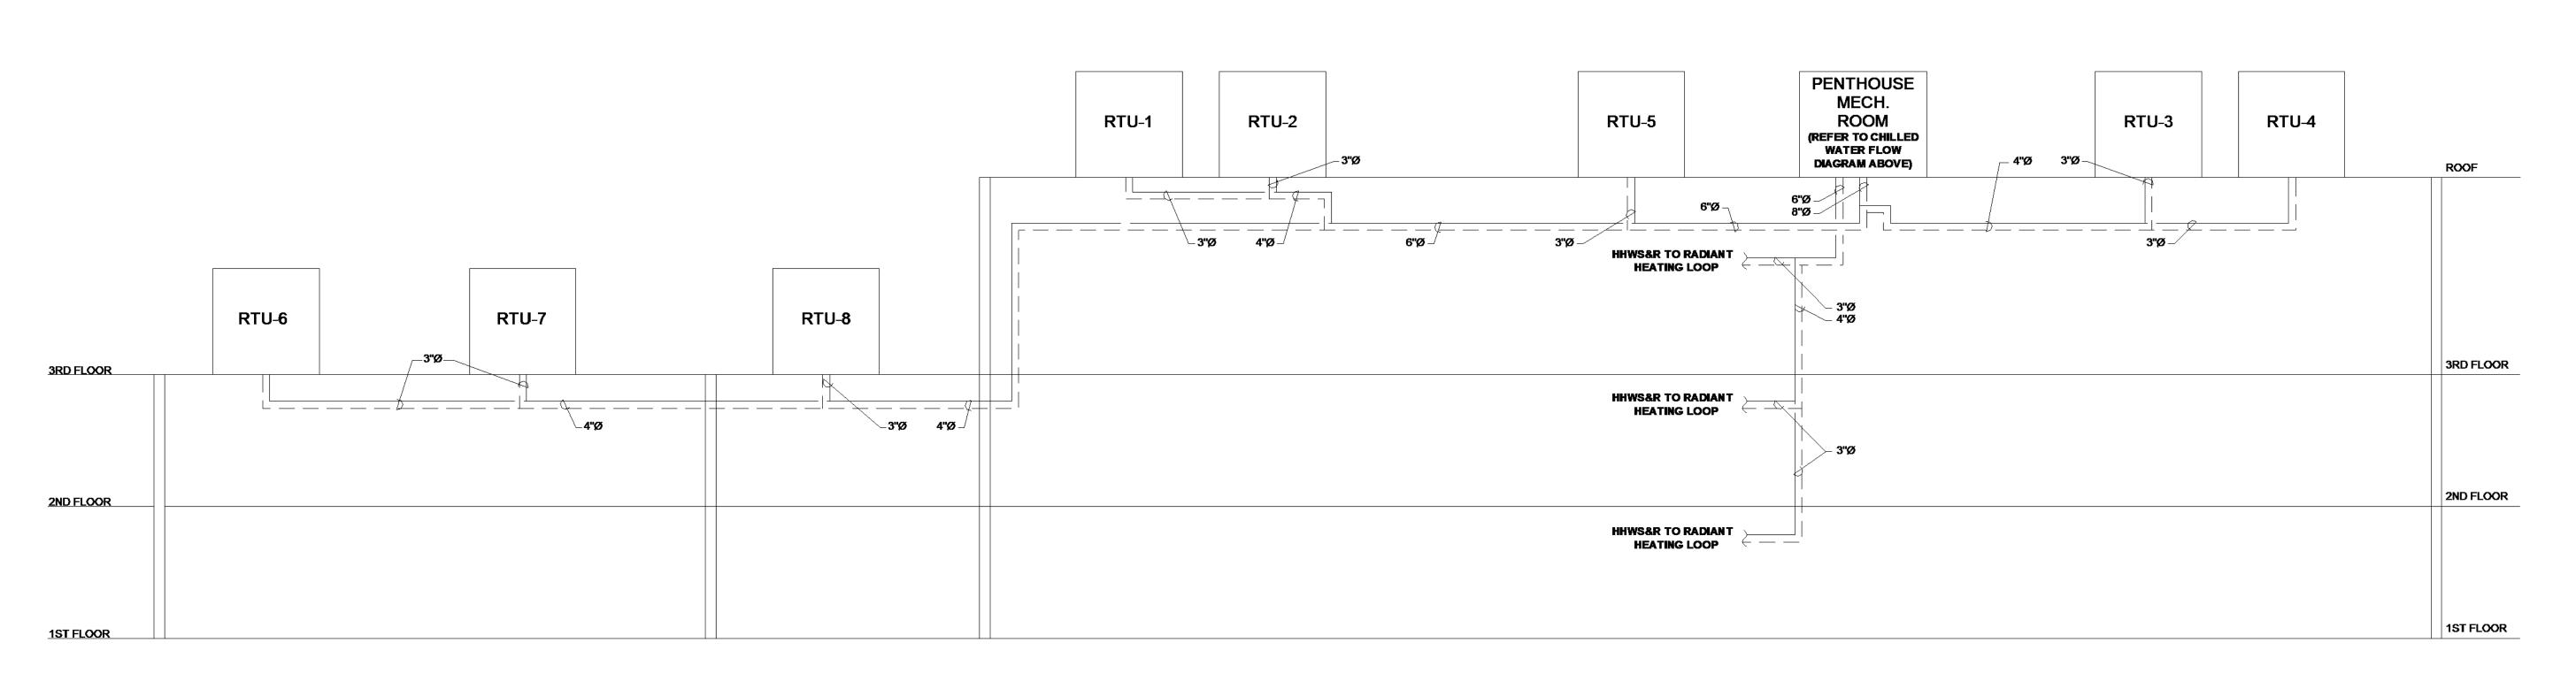

ROOFTOP UNIT & RADIANT HEATING HOT WATER FLOW DIAGRAM



SCHOOL FULLER PROJECT STATUS

Issue Date 09/07/18

REVISIONS

DRAWING NAME HHW FLOW DIAGRAM