


1 1 EXISTING SITE PLAN SHELDON

1" = 80'-0"

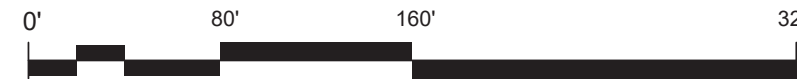

CONSTRUCTION DRAWING SET
4J SECURITY IMPROVEMENTS
 PROJECT #: 2207
 EUGENE SCHOOL DISTRICT 4J

SHEET TITLE:
**SITE PLANS
 SHELDON**

REVISIONS:

#	DESCRP.	DATE
1	ADD 2	04/04/23

ISSUE DATE: 03.15.23

A01-A



PVOT
 ARCHITECTURE

GENERAL NOTES - DEMOLITION

- A. PROTECT ALL EXISTING CONSTRUCTION TO REMAIN.
- B. COORDINATE WITH OWNER FOR REMOVAL AND STORAGE OF (E) EQUIPMENT AND CASEWORK TO BE SALVAGED.
- C. REMOVE EXISTING DOOR WALL STOPS WHERE DOORS NO LONGER EXIST.
- D. PROTECT (E) FLOORS, WALLS, CEILING & FINISHES TO REMAIN.
- E. REMOVE AND STORE MATERIAL AND EQUIPMENT WHERE INDICATED TO BE SALVAGED OR RELOCATED.
- F. WHEN REMOVING FLOOR FINISHES REMOVE ALL ADHESIVE, GROUT, RESIDUE AND DEBRIS.
- G. COORDINATE WITH ELECTRICAL FOR ITEMS TO BE DEMOLISHED, REMOVED, AND/OR SALVAGED.
- H. COORDINATE WITH MECHANICAL/PLUMBING FOR ITEMS TO BE DEMOLISHED, AND/OR SALVAGED.
- I. COORDINATE WITH OWNERS MODULAR SYSTEMS FURNITURE CONTRACTOR FOR CHANGES TO FURNITURE AND SYSTEM CASEWORK.
- J. COORDINATE WITH OWNER FOR ANY CEILING/FLOORING DISRUPTION REGARDING ACM.

GENERAL NOTES - FLOOR PLANS




- A. DIMENSIONS SHOWN ARE TO THE FACE OF STUD, CONCRETE OR MASONRY UNLESS OTHERWISE NOTED. CONTACT THE ARCHITECT FOR ANY ADDITIONAL DIMENSIONS REQUIRED TO LAY OUT THE WORK.
- B. MASONRY DIMENSIONS ARE THE ACTUAL MASONRY UNIT SIZES UNLESS OTHERWISE NOTED.
- C. REPAIR PATCHED SURFACES THAT ARE DAMAGED, LIFTED, DISCOLORED, OR SHOWING OTHER IMPERFECTIONS DUE TO PATCHING WORK. IF DEFECTS ARE DUE TO CONDITION OF SUBSTRATE, REPAIR SUBSTRATE PRIOR TO REPAIRING FINISH.
- D. WHERE (E) FLOOR IS TO REMAIN, PROTECT FROM DAMAGE. PATCH AND REPAIR ANY HOLES IN CONCRETE SLAB CAUSED BY DEMOLITION OF EXISTING WALLS, (I.E. WALL ANCHORS).
- E. PATCH AND REPAIR ANY WALL AND CEILING LOCATIONS WHERE EXISTING ELECTRICAL AND VOICEDATA OUTLET, JUNCTION BOXES, AND SIMILAR WALL MOUNTED ITEMS ARE REMOVED OR ABANDONED WITHIN THE WORK AREA.
- F. PATCH AND REPAIR WALL AND CEILING SURFACES WHERE MODULAR SYSTEMS FURNITURE WAS REMOVED BY SEPARATE CONTRACTOR.
- G. PATCH AND REPAIR ANY WALL LOCATIONS WHERE EXISTING WALL COVERING HAS BEEN REMOVED WITHIN THE WORK AREA.
- H. PATCH AND REPAIR ANY WALL LOCATIONS WHERE EXISTING WALL BASE HAS BEEN REMOVED WITHIN THE WORK AREA.
- I. PATCH AND REPAIR ANY WALL LOCATIONS WHERE EXISTING EQUIPMENT, ACCESSORIES, HARDWARE OR OTHER SURFACE MOUNTED ELEMENTS HAVE BEEN REMOVED WITHIN THE WORK AREA.
- J. VERIFY LOCATION OF PROX-CARD READERS, AUTOMATIC DOOR OPENERS AND WIRELESS ACTUATORS WITH ARCHITECT DURING ROUGH-IN PHASE OF THE WORK.
- K. COORDINATE WITH OWNER FOR ANY CEILING/FLOORING DISRUPTION REGARDING ACM.

DEMOLITION LEGEND

- (E) WALL TO REMAIN
- WALL TO BE DEMOLISHED
- DOOR AND FRAME TO BE DEMOLISHED


WALL FILL PATTERNS:

- EXISTING WALL ASSEMBLY
- NON FIRE-RATED WALL ASSEMBLY
- CR CARD READER
- REX REQUEST TO EXIT
- CASEWORK TAG-TAG ONLY ON EXISTING CASEWORK TO BE RELOCATED TAG PLACED ON FRONT OF CASEWORK ROTATE ACCORDINGLY

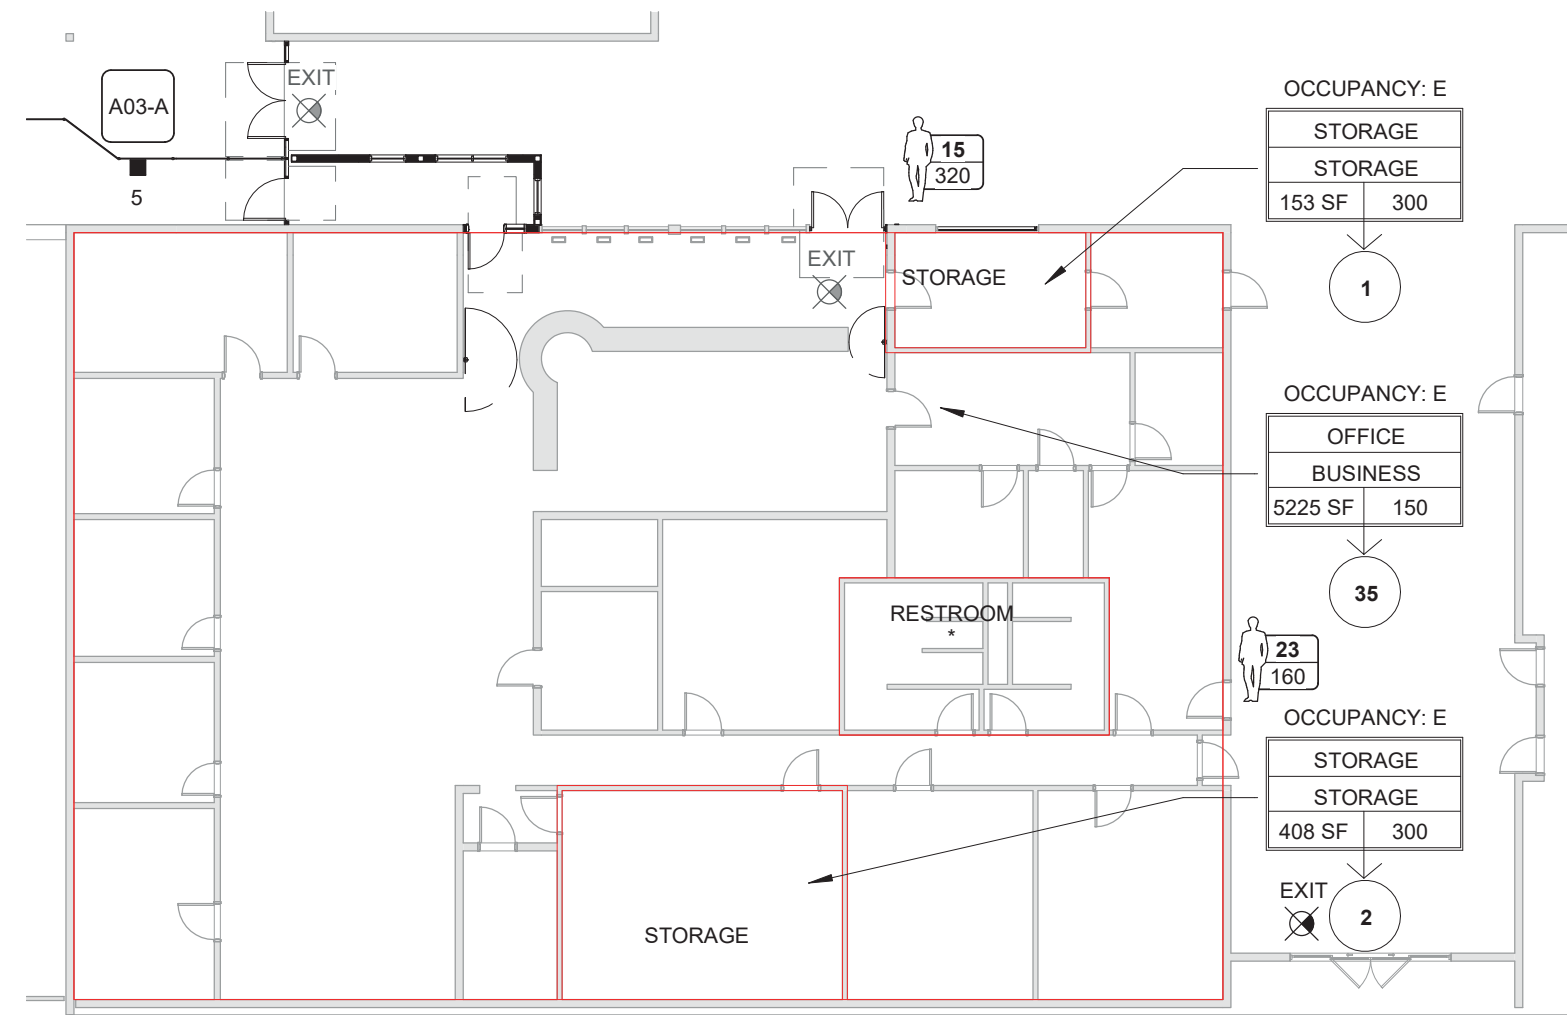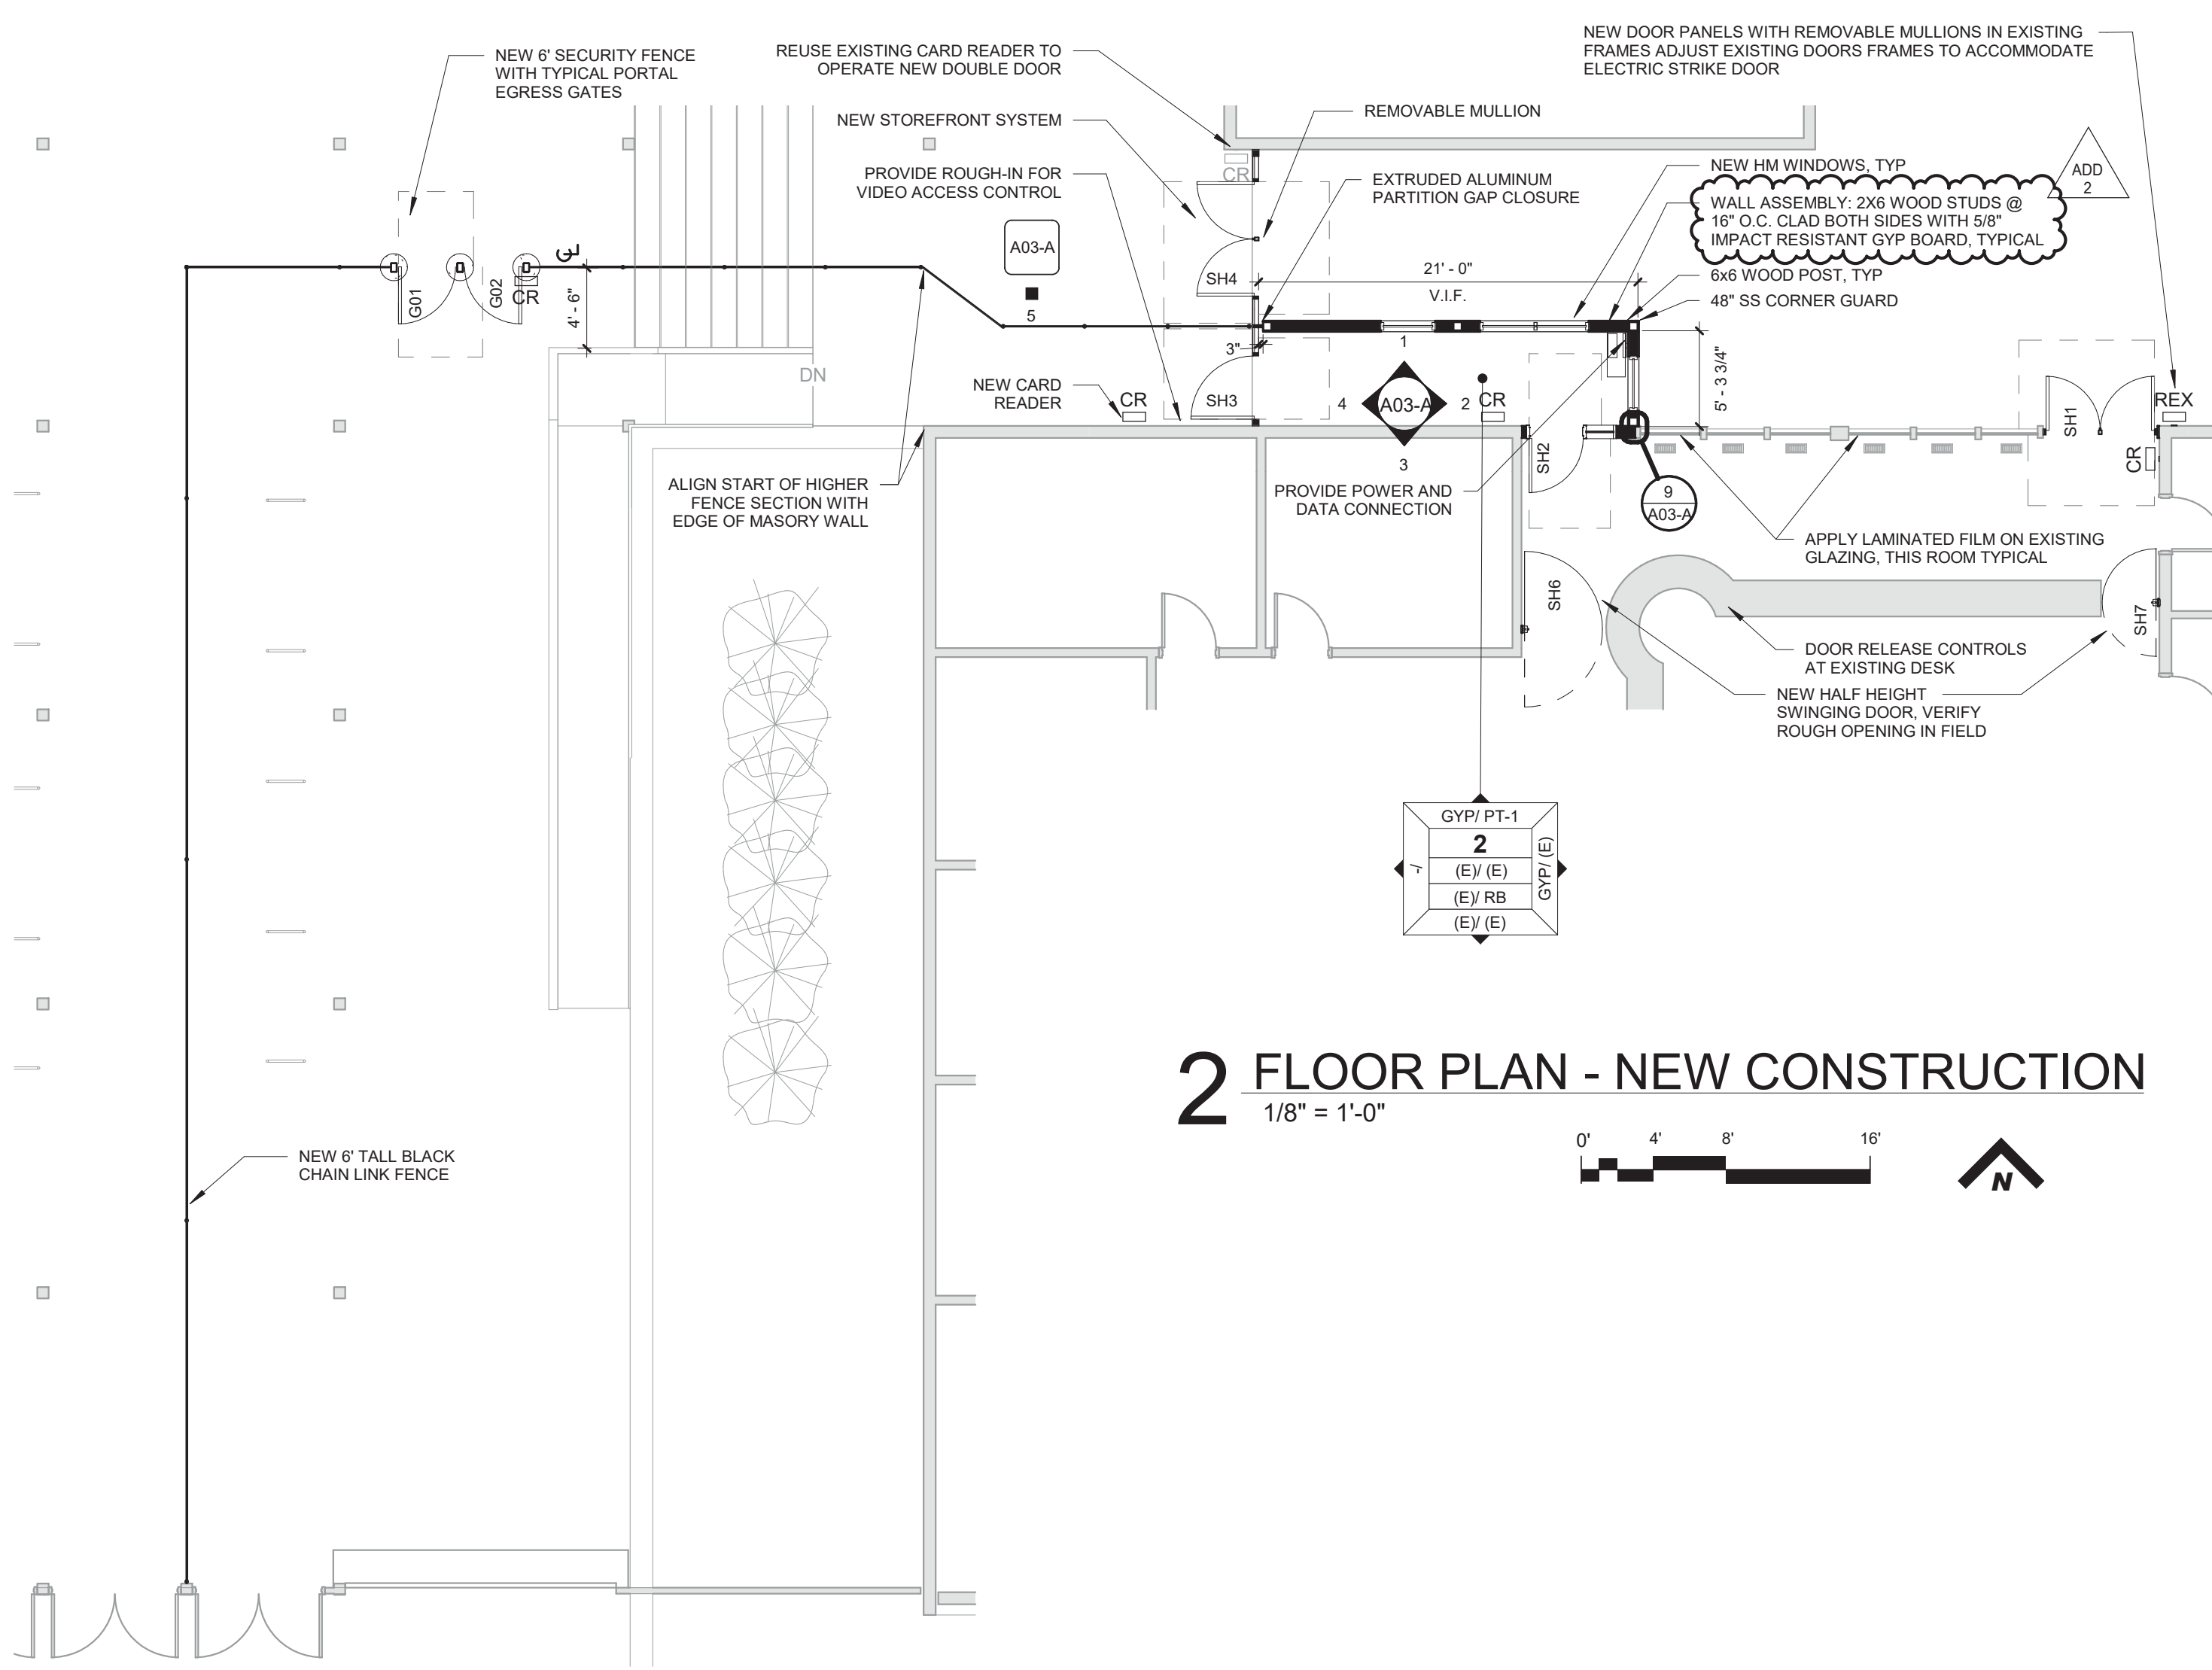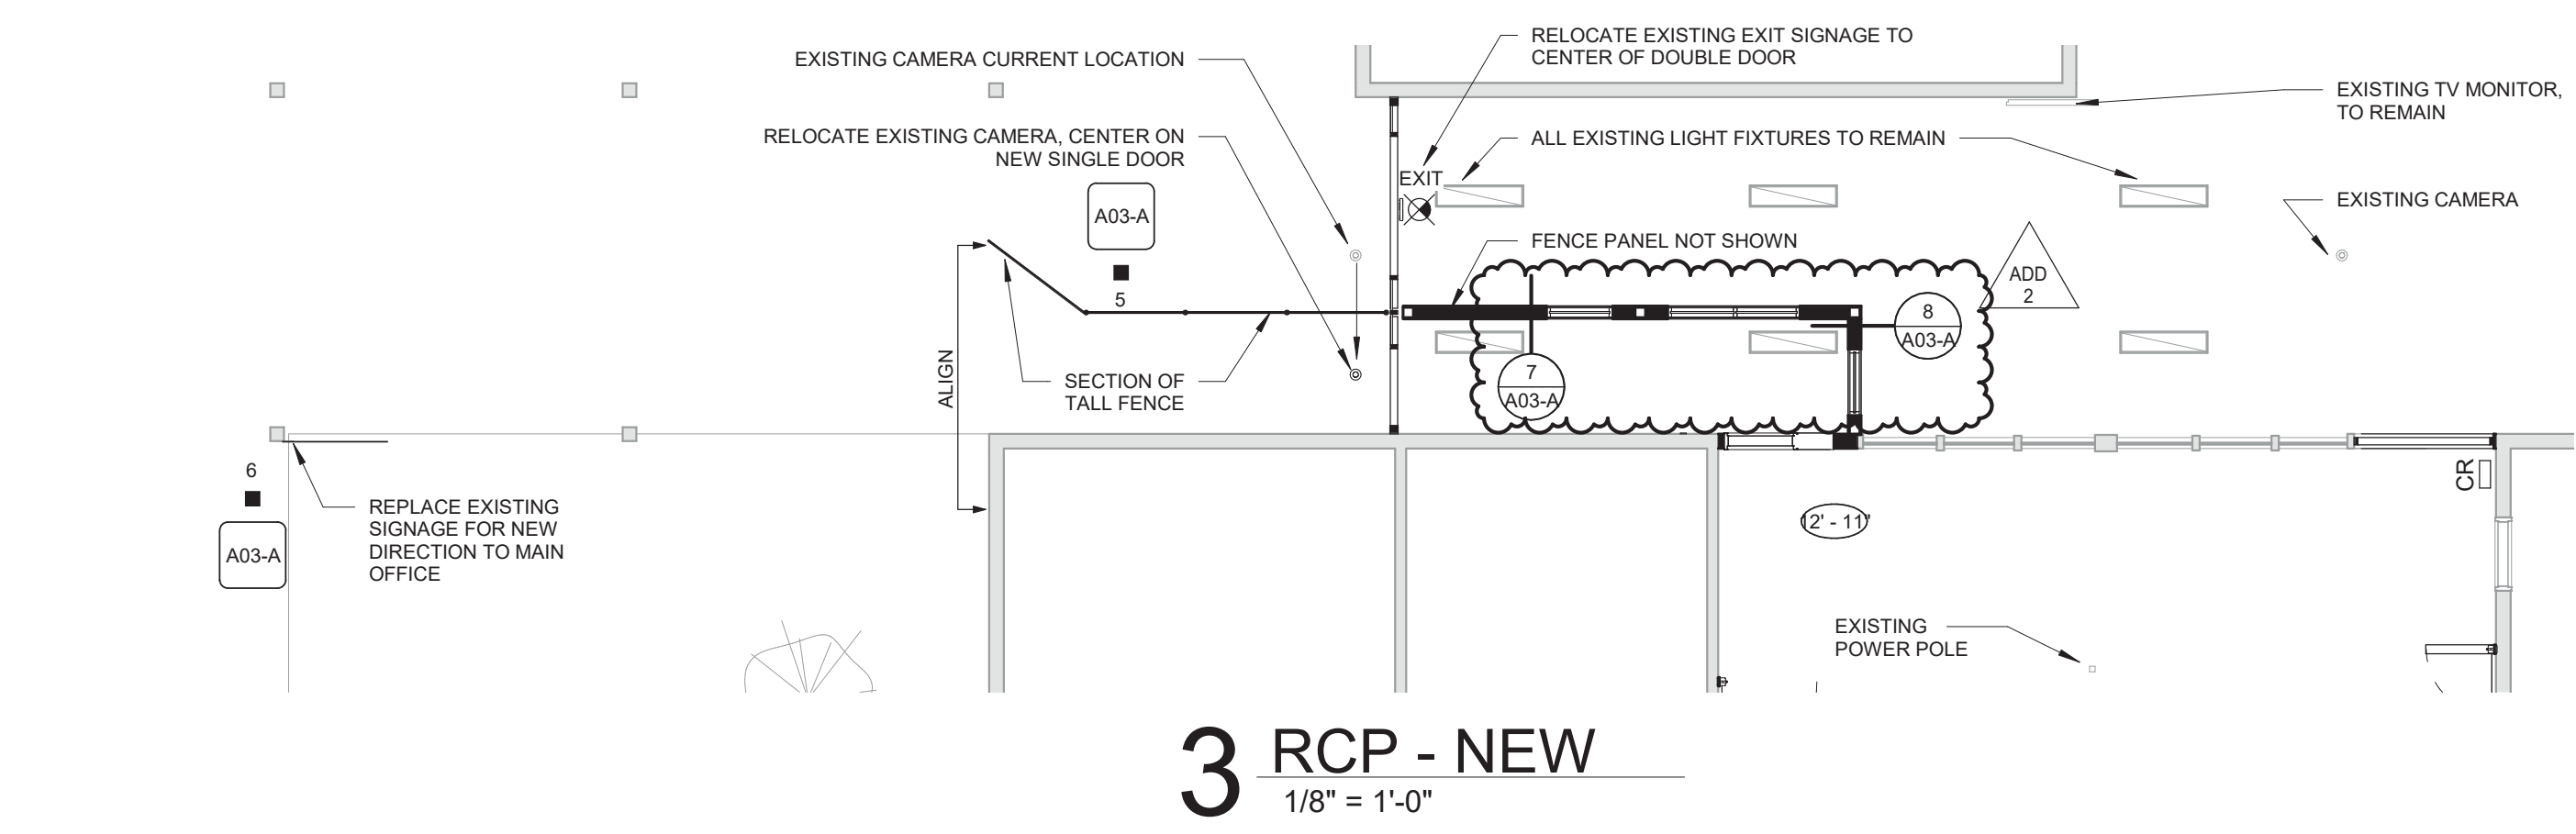

DOOR SCHEDULE - SH

MARK	WIDTH	HEIGHT	DOOR PANEL		DOOR FRAME		HARDWARE GROUP	COMMENTS
			TYPE	(E)	TYPE	FINISH		
SH1	6'-0"	7'-0"	WOOD	(E)			02	CONTROL ACCESS - SEE HARDWARE SPECIFICATION
SH2	4'-8"	7'-0"	WOOD	HM	PAINT		01	WITH SIDE LITE - CONTROL ACCESS - SEE HARDWARE SPECIFICATION
SH3	3'-6"	7'-0"	ALUM	ALUM			03	CONTROL ACCESS - SEE HARDWARE SPECIFICATION
SH4	6'-4"	7'-0"	ALUM	ALUM			03	CONTROL ACCESS - SEE HARDWARE SPECIFICATION
SH6	4'-4"	3'-6"	ALUM	ALUM	PER MANUFACTURER		PER MANUFACTURER	HALF HEIGHT ALUMINUM TRAFFIC DOOR - VERIFY OPENING IN FIELD
SH7	3'-0"	3'-6"	ALUM	ALUM	PER MANUFACTURER		PER MANUFACTURER	HALF HEIGHT ALUMINUM TRAFFIC DOOR - VERIFY OPENING IN FIELD

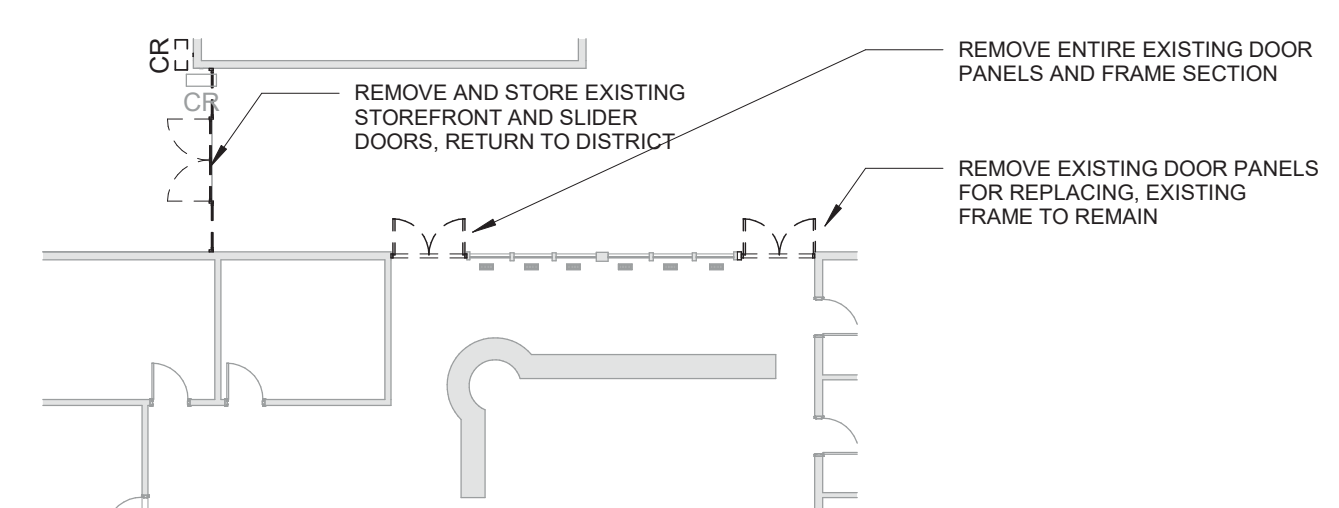


1 FLOOR PLAN - DEMOLITION
1/16" = 1'-0"


6 EGRESS PLAN -MAIN OFFICE
1/16" = 1'-0"

2 FLOOR PLAN - NEW CONSTRUCTION
1/8" = 1'-0"


3 RCP - NEW
1/8" = 1'-0"

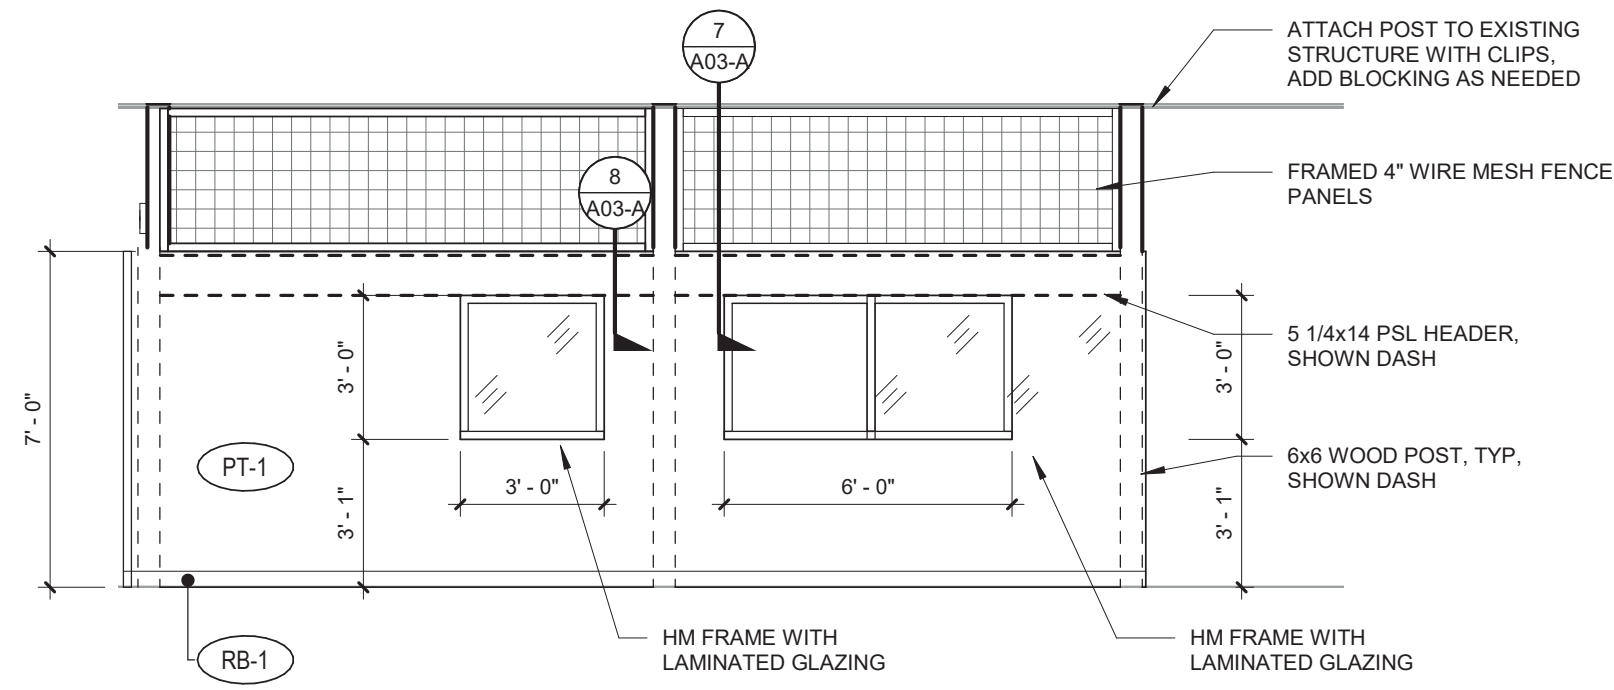


1 HS - SHELDON - ENTRY VESTIBULE - N
1/4" = 1'-0"

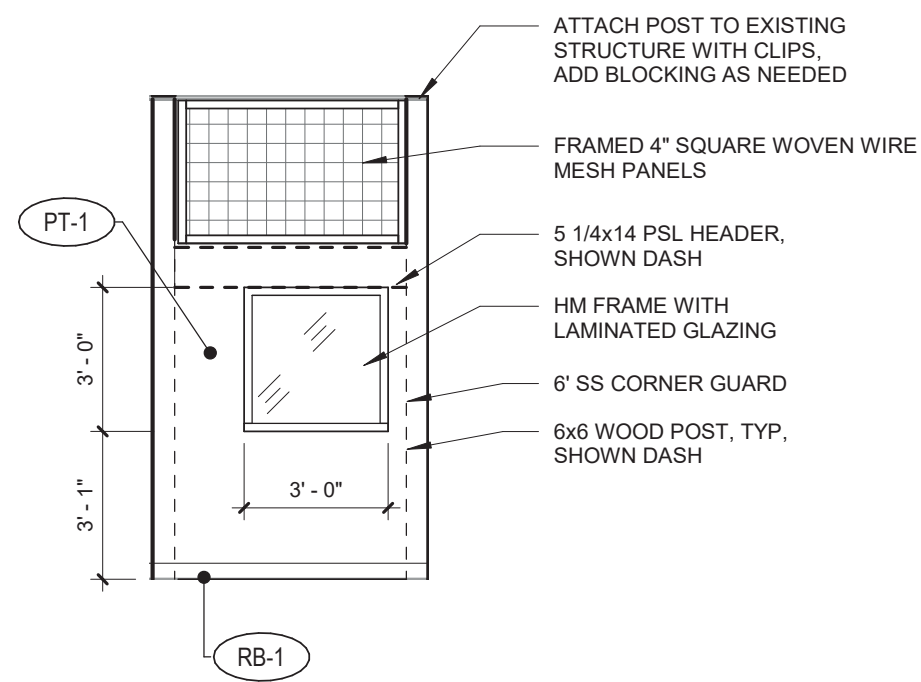


2 HS - SHELDON - ENTRY VESTIBULE - E
1/4" = 1'-0"

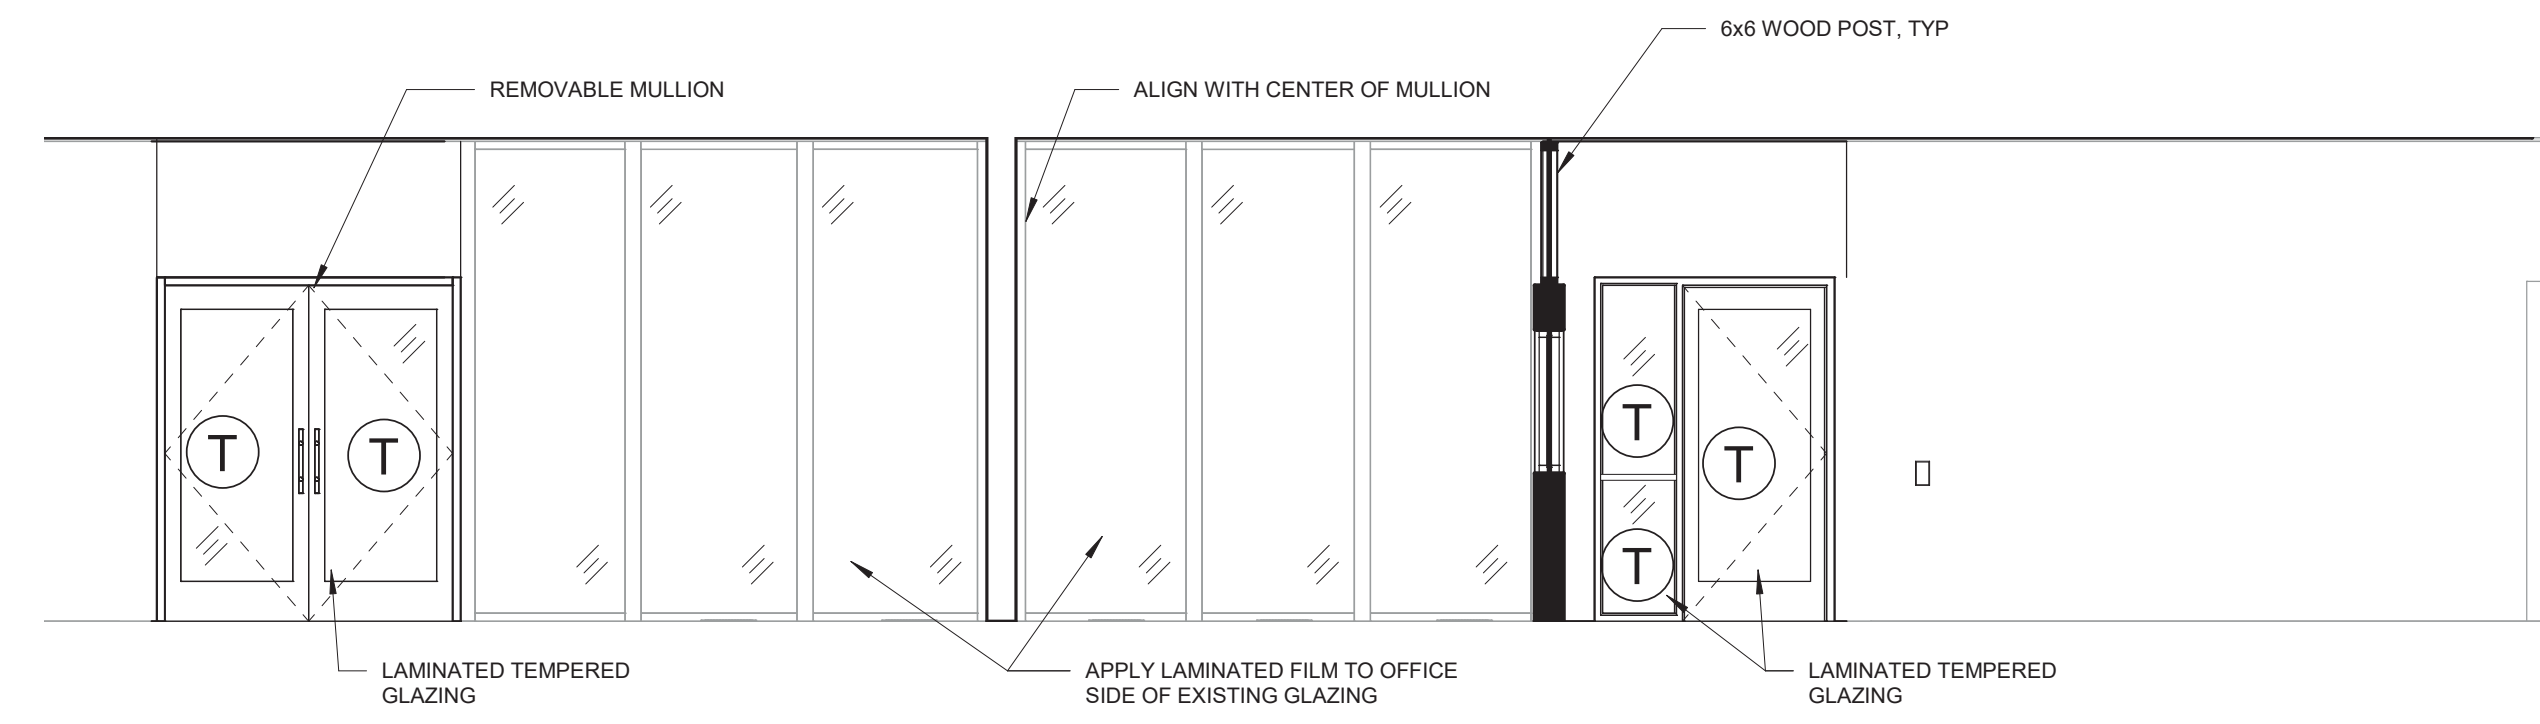


3 HS - SHELDON - ENTRY VESTIBULE - S
1/4" = 1'-0"

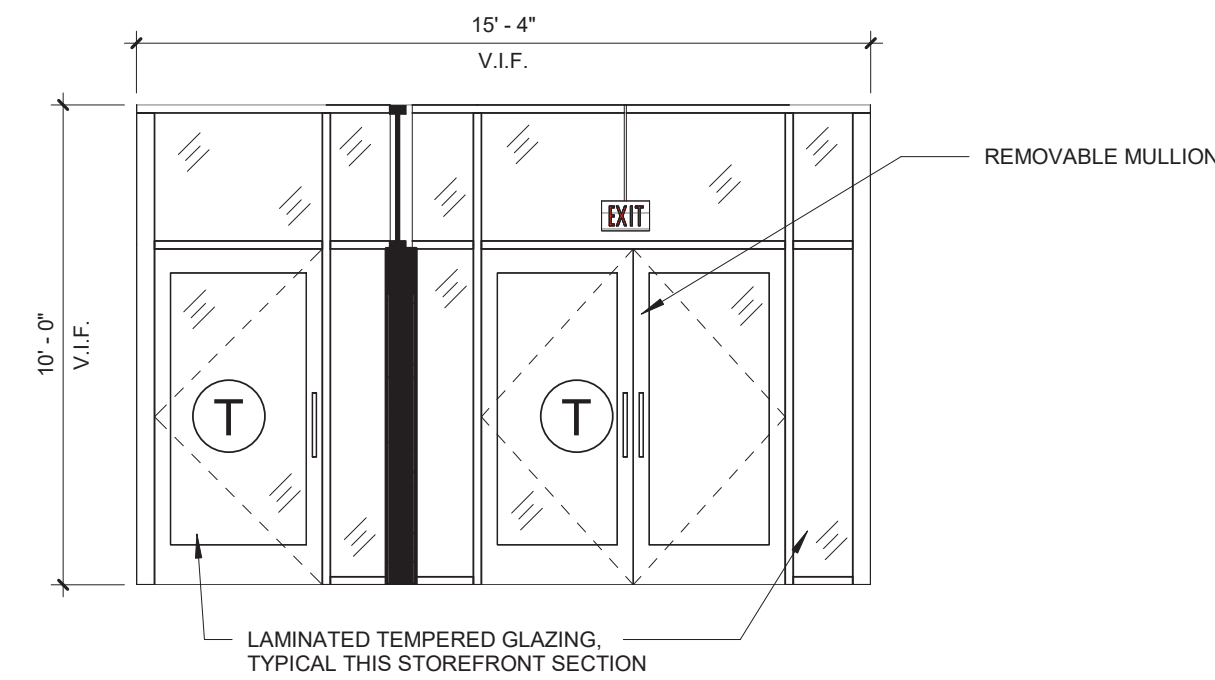


4 HS - SHELDON - ENTRY VESTIBULE - W
1/4" = 1'-0"

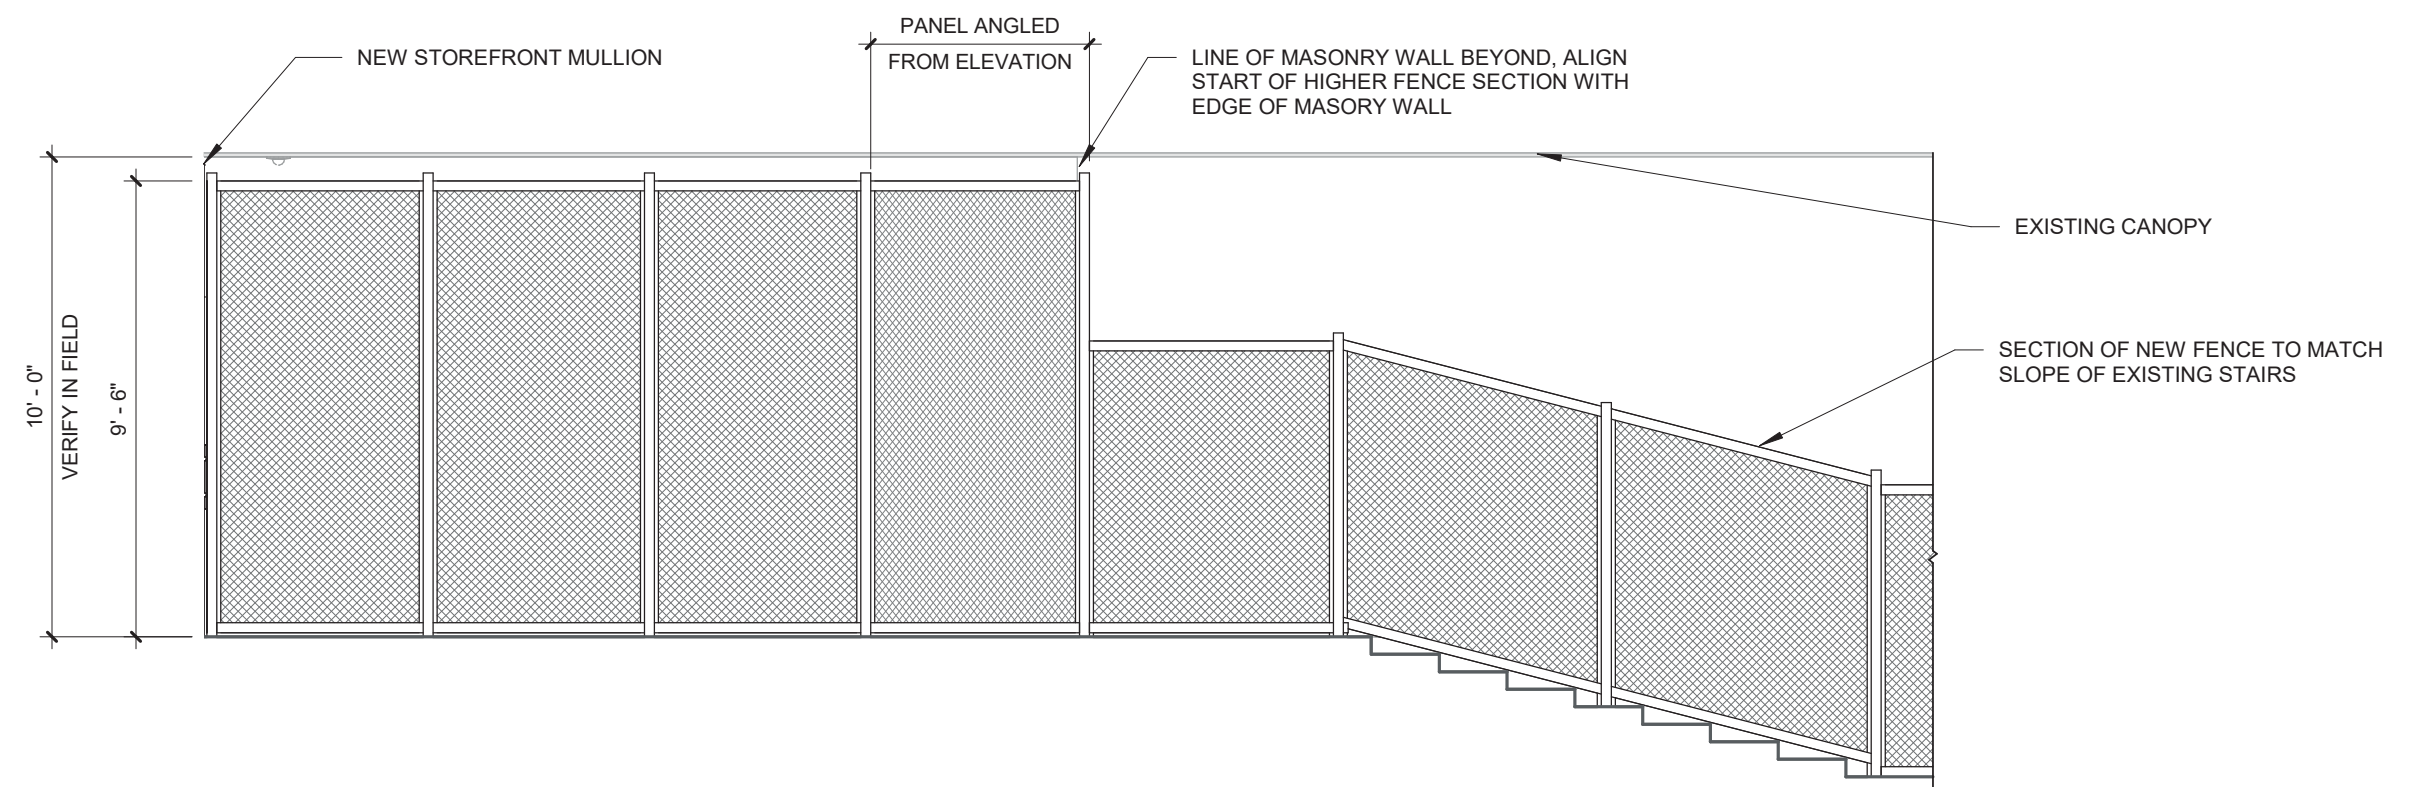


5 SHELDON FENCE ELEVATION
1/4" = 1'-0"

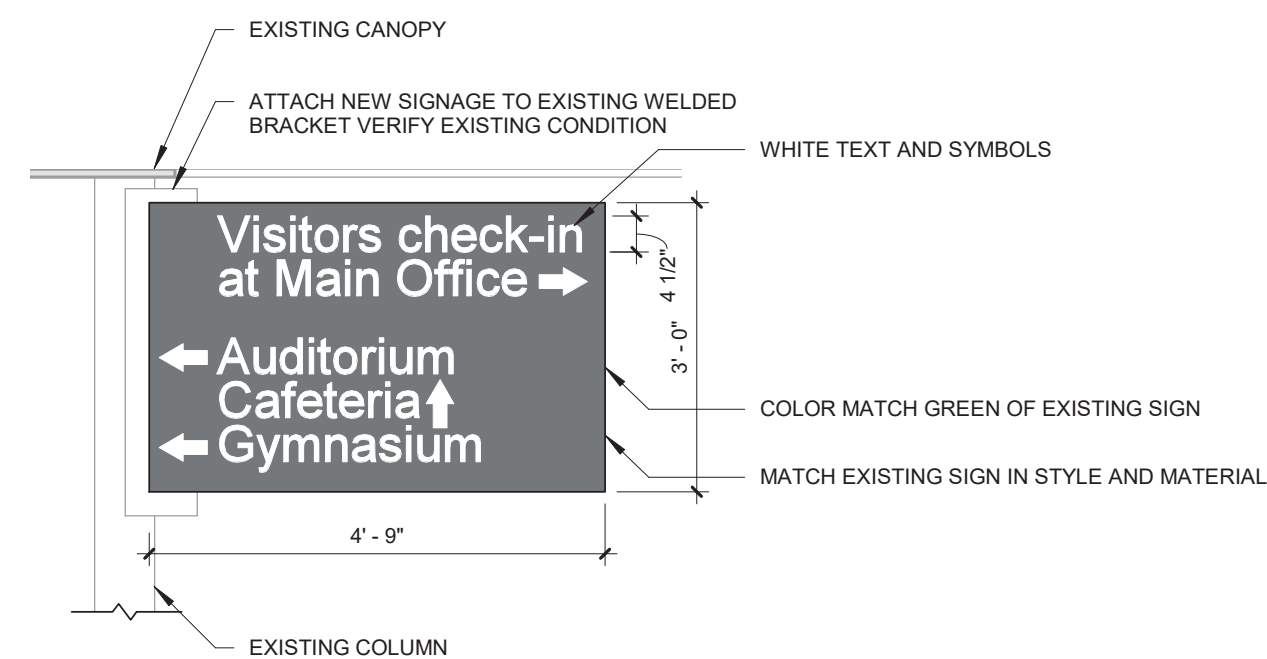


6 REPLACEMENT SIGNAGE
1/2" = 1'-0"

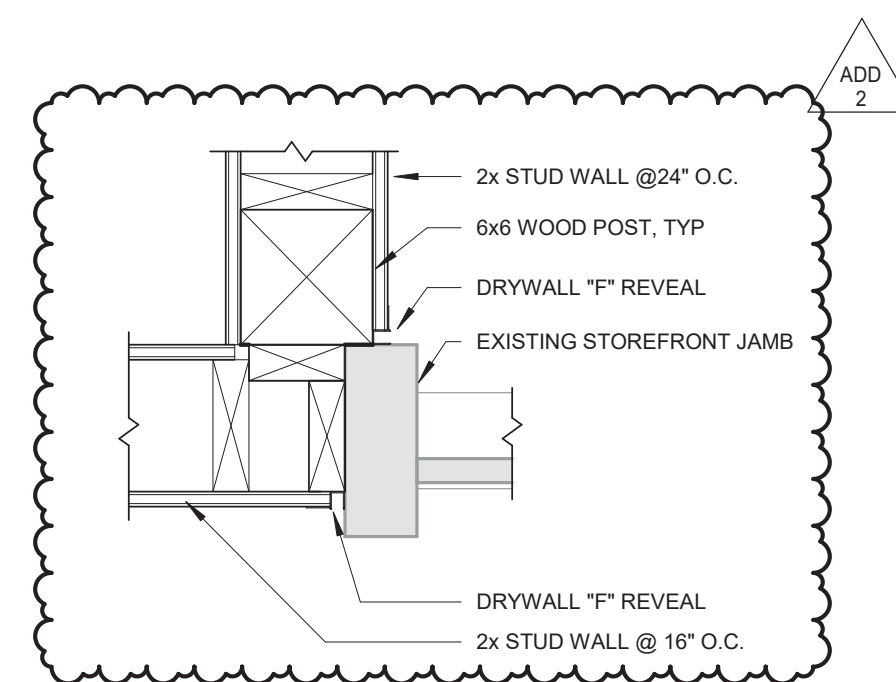

9 WALL DETAIL
1 1/2" = 1'-0"

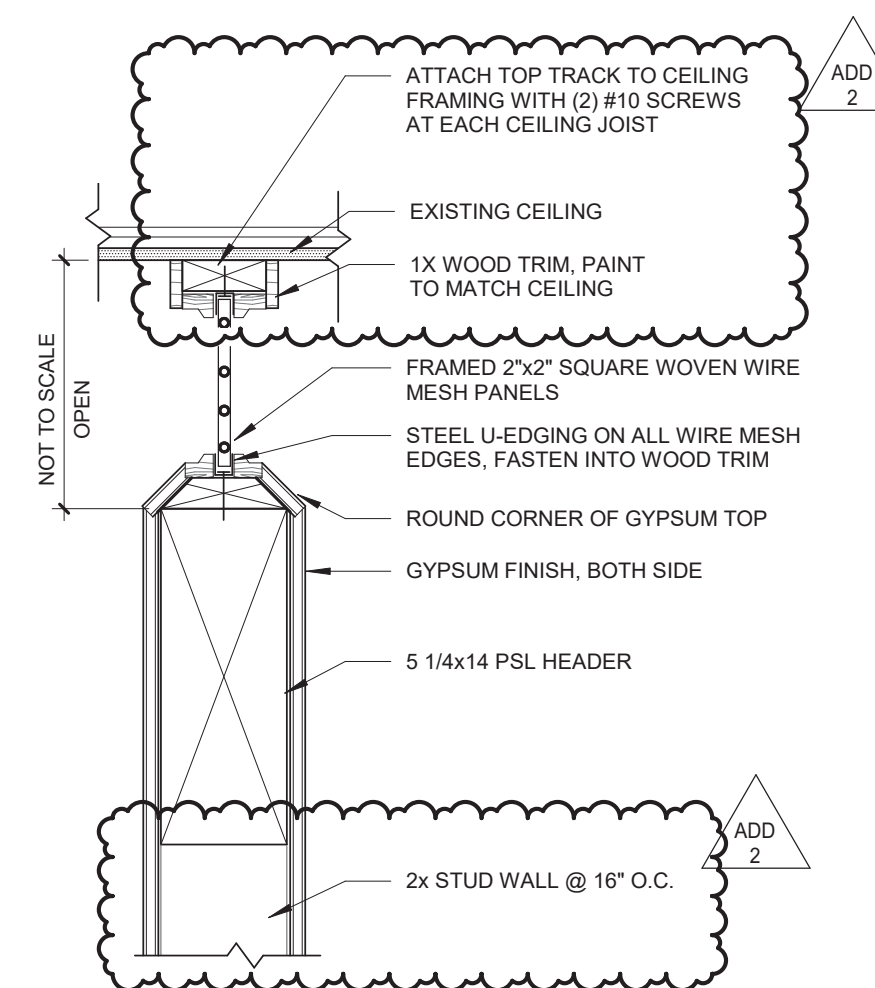

7 HEAD DETAIL
1 1/2" = 1'-0"

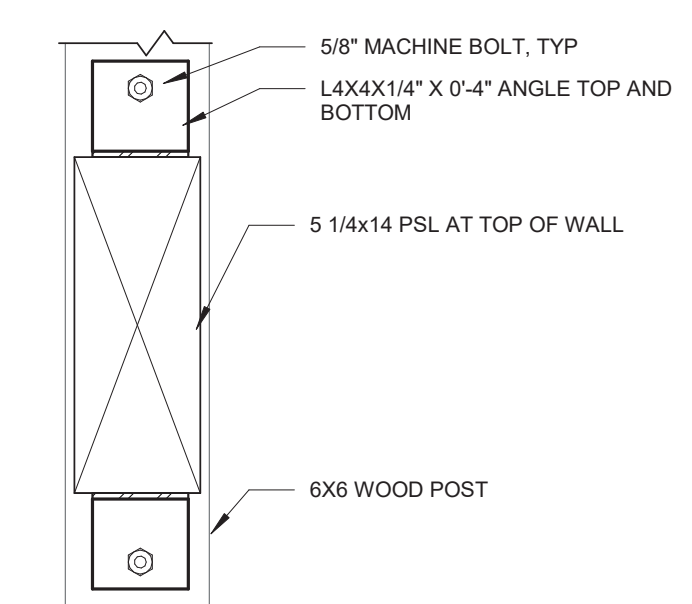

8 HEADER CONNECTION
1 1/2" = 1'-0"

VERIFY NEAREST FENCE POST PIER FOOTING AT MINIMUM OF 1'-0" CLEAR DISTANCE FROM EXISTING BUILDING FOUNDATION. ADD CHAIN LINK FILLER PANEL BETWEEN BUILDING FACE, TYP ALL NEW FENCE LOCATION

2'-0" WIDE CONCRETE MOW STRIP. PATCH AND REPAIR TURF AND ANY IRRIGATION

ADD 6" BLACK VINYL CHAIN LINK FENCE AND GATES

ADD 6" BLACK VINYL CHAIN LINK FENCE AND GATES


ADD 6" BLACK VINYL CHAIN LINK FENCE AND GATES

BOLT AND EPOXY STANDARD FENCE POST INTO EXISTING PAVEMENT. DO NOT EMBED FENCE POST THIS SECTION


FOR TYPICAL GATE DETAILS SEE SHEET A05-A

ADD 2

G04 G03

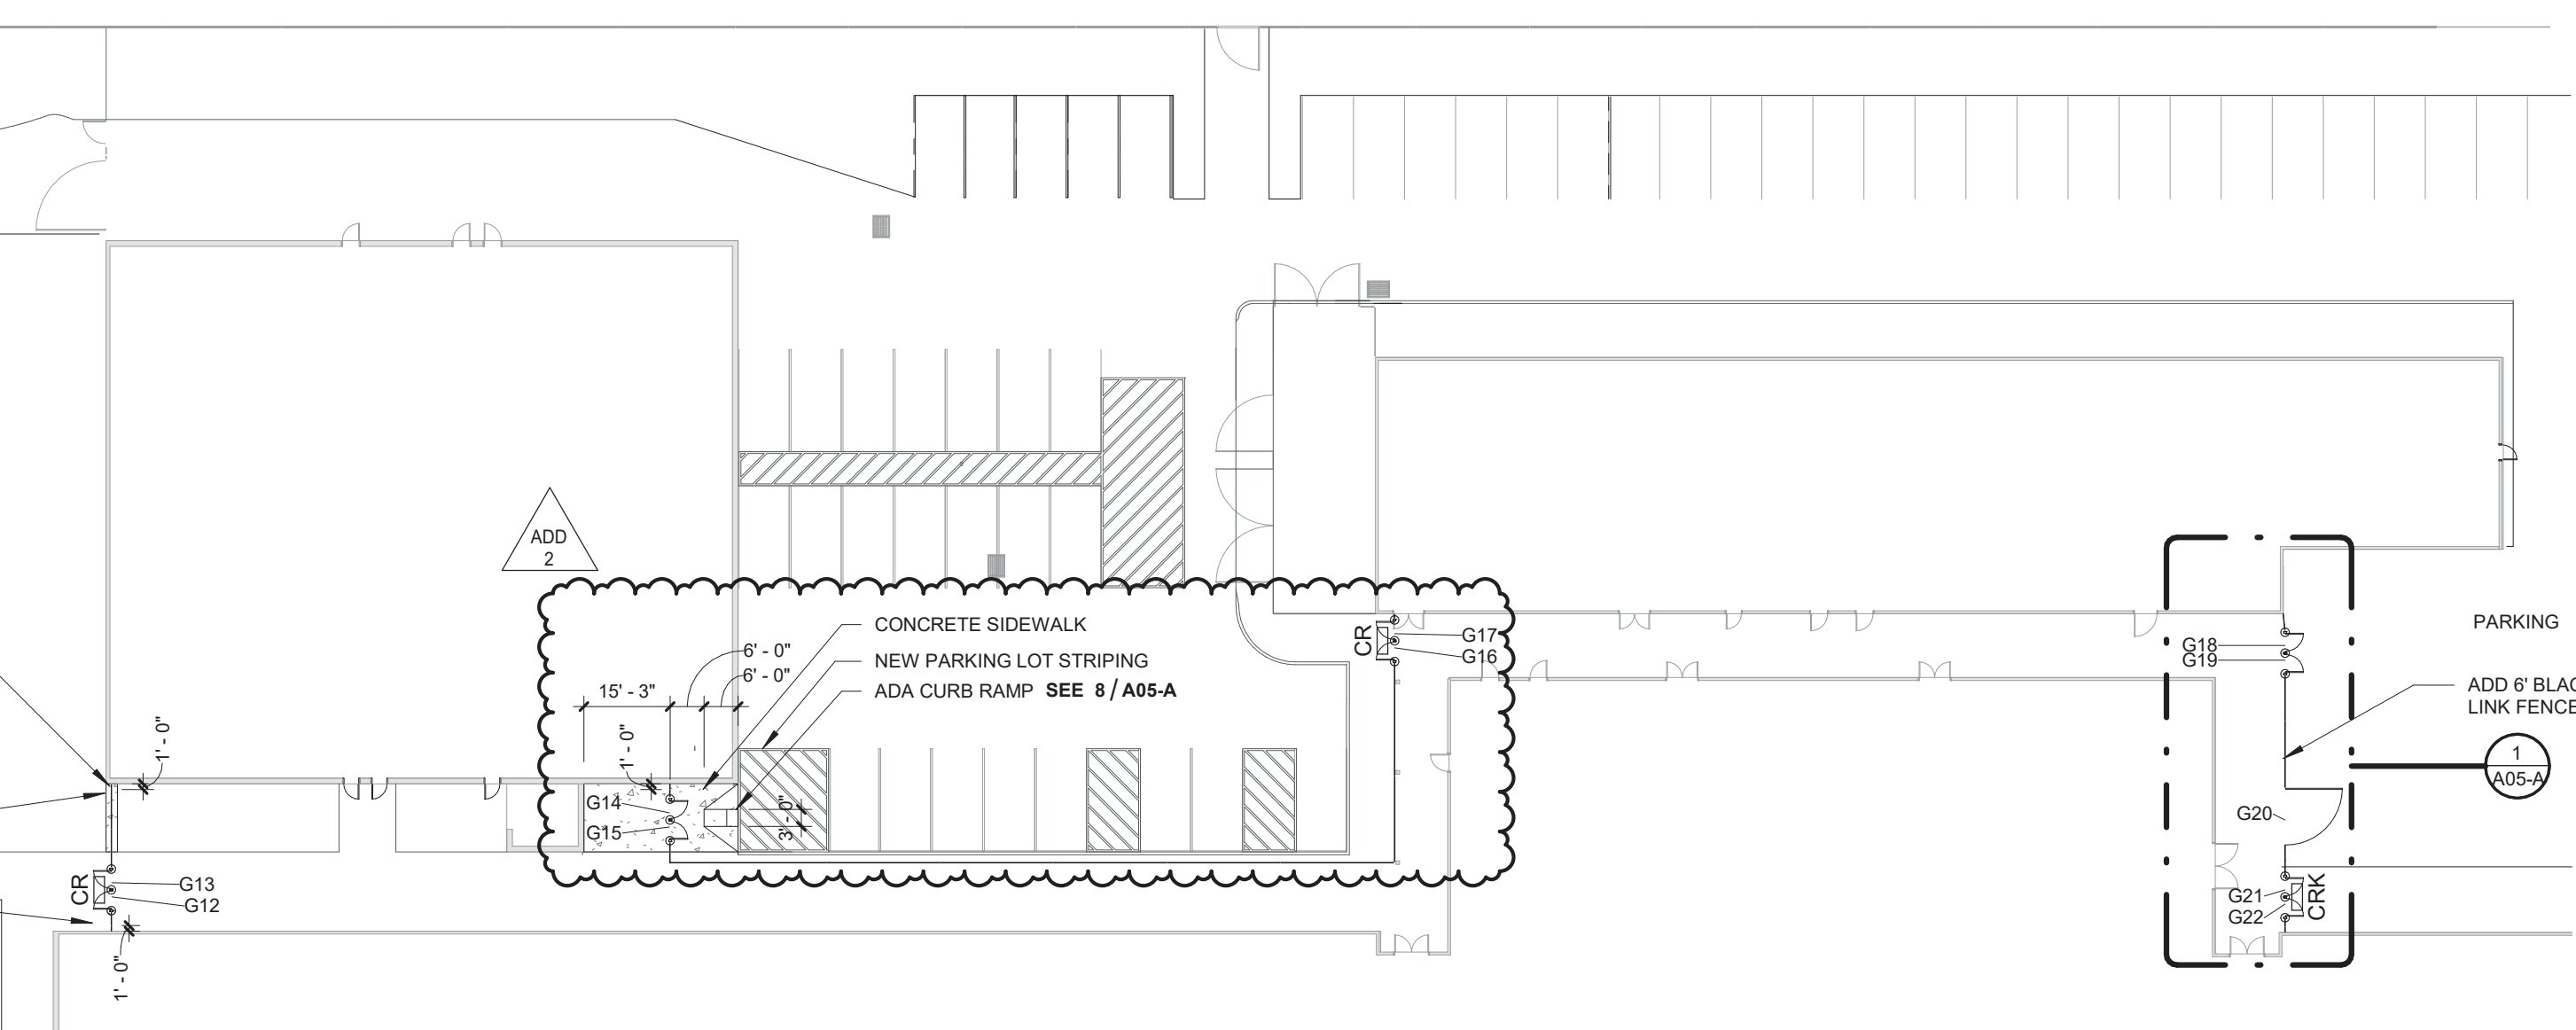

1 SHELDON SITE WORK
1" = 30'-0"






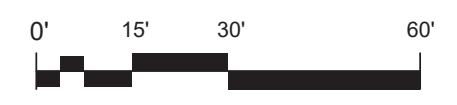


GENERAL NOTES

VERIFY EXISTING FOOTING IN FIELD. ALERT ARCHITECT ONCE THE EXISTING CONDITIONS ARE CONFIRMED.

DOOR SCHEDULE - SH GATES


MARK	WIDTH	HEIGHT	GATE TYPE	HARDWARE GROUP	COMMENTS
G01	3'-2"	6'-0"	STEEL	04	
G02	3'-2"	6'-0"	STEEL	05	PROVIDE CONTROL ACCESS - COORDINATE WITH ELECTRICAL
G03	3'-2"	6'-0"	STEEL	04	
G04	3'-2"	6'-0"	STEEL	04	
G05	12'-0"	6'-0"	STEEL	-	LOCKABLE CLASP PER GATE MANUFACTURER
G06	3'-2"	6'-0"	STEEL	04	
G07	3'-2"	6'-0"	STEEL	04	
G08	3'-2"	6'-0"	STEEL	04	
G09	3'-2"	6'-0"	STEEL	04	
G10	3'-2"	6'-0"	STEEL	05	PROVIDE CONTROL ACCESS - COORDINATE WITH ELECTRICAL
G11	3'-2"	6'-0"	STEEL	04	
G12	3'-2"	6'-0"	STEEL	05	PROVIDE CONTROL ACCESS - COORDINATE WITH ELECTRICAL
G13	3'-2"	6'-0"	STEEL	04	
G14	3'-2"	6'-0"	STEEL	05	PROVIDE CONTROL ACCESS - COORDINATE WITH ELECTRICAL
G15	3'-2"	6'-0"	STEEL	04	
G16	3'-2"	6'-0"	STEEL	05	PROVIDE CONTROL ACCESS - COORDINATE WITH ELECTRICAL
G17	3'-2"	6'-0"	STEEL	04	
G18	3'-0"	6'-0"	STEEL	04	
G19	3'-0"	6'-0"	STEEL	04	
G20	10'-0"	6'-0"	STEEL	-	LOCKABLE CLASP PER GATE MANUFACTURER
G21	3'-0"	6'-0"	STEEL	04	
G22	3'-0"	6'-0"	STEEL	05	PROVIDE CONTROL ACCESS - COORDINATE WITH ELECTRICAL

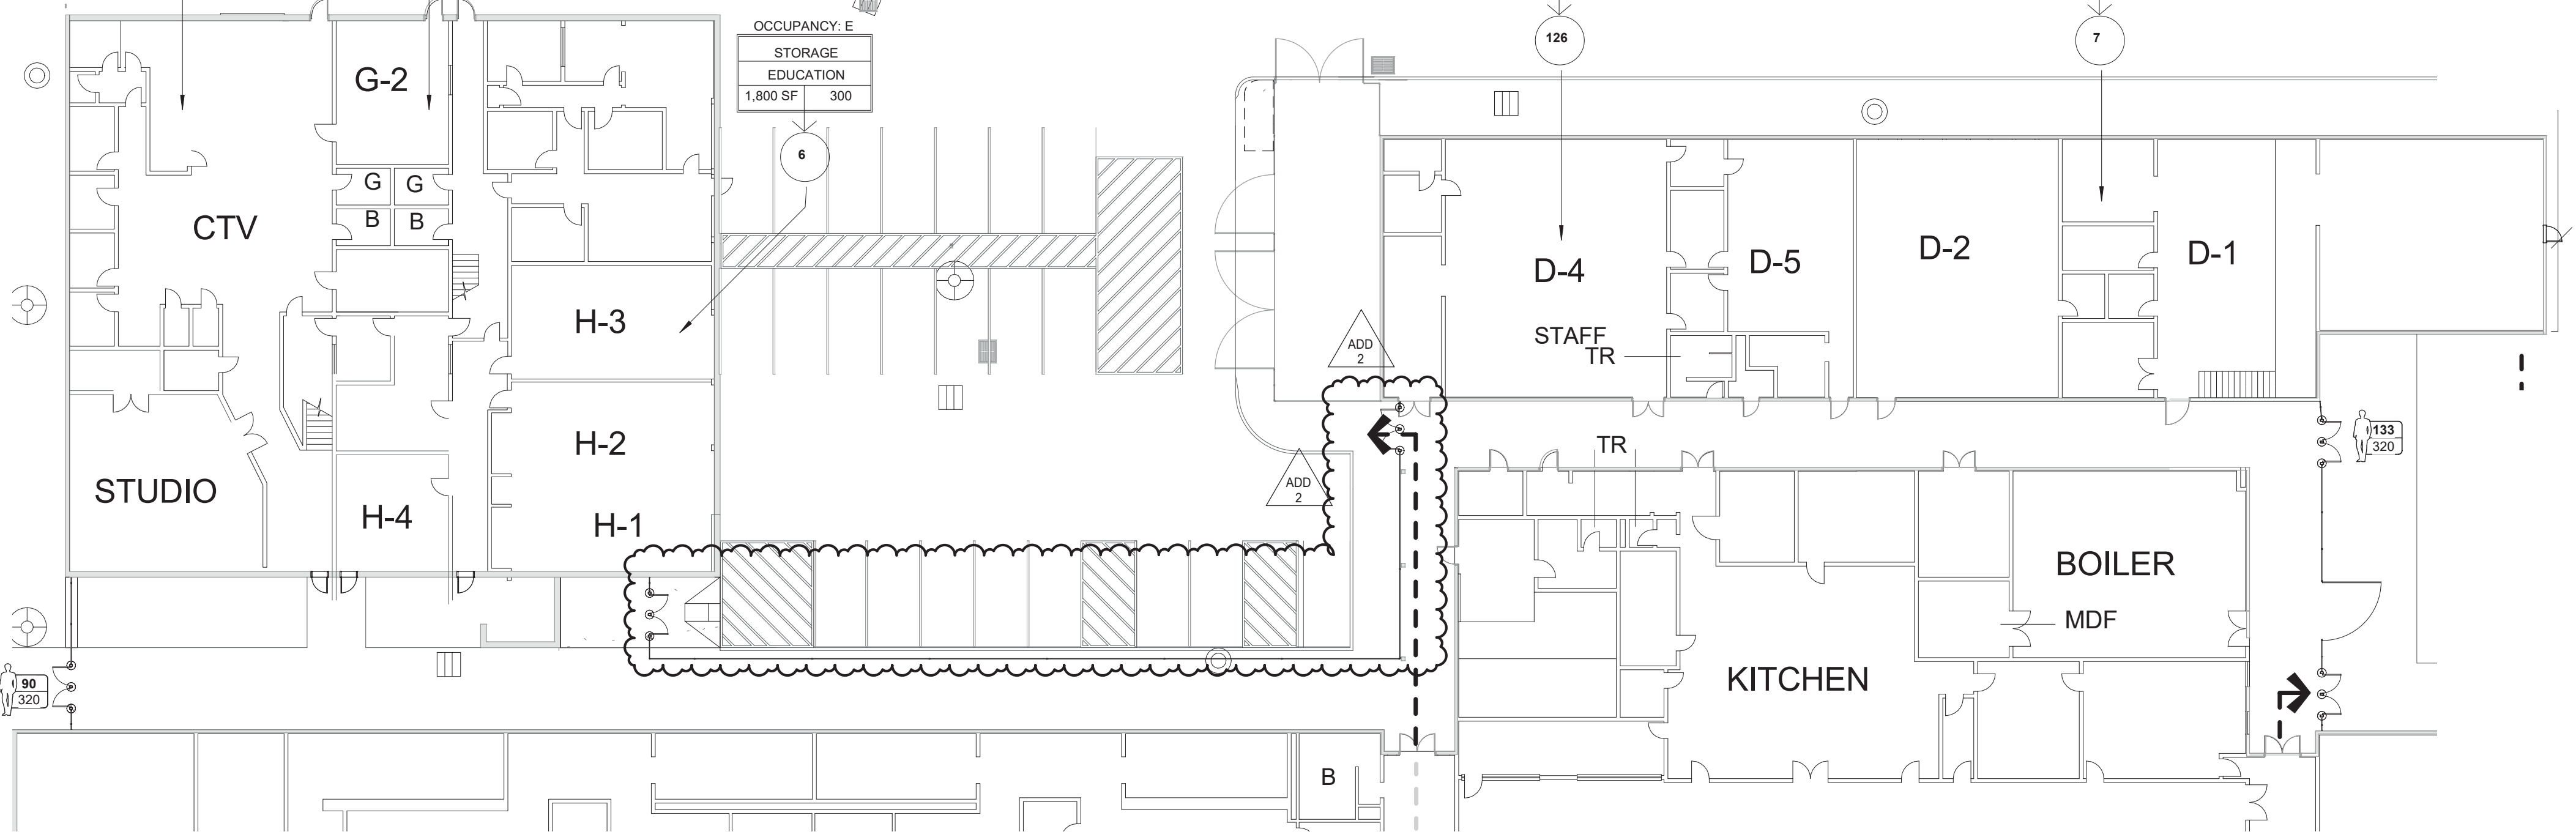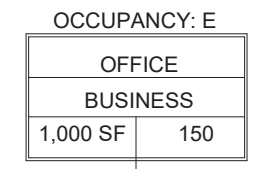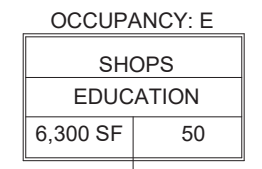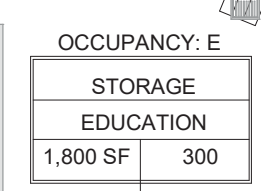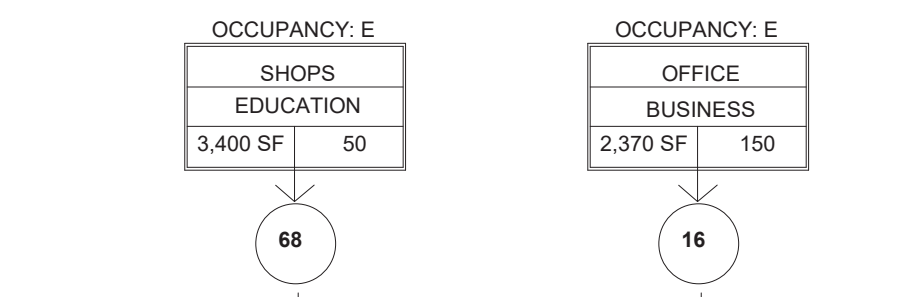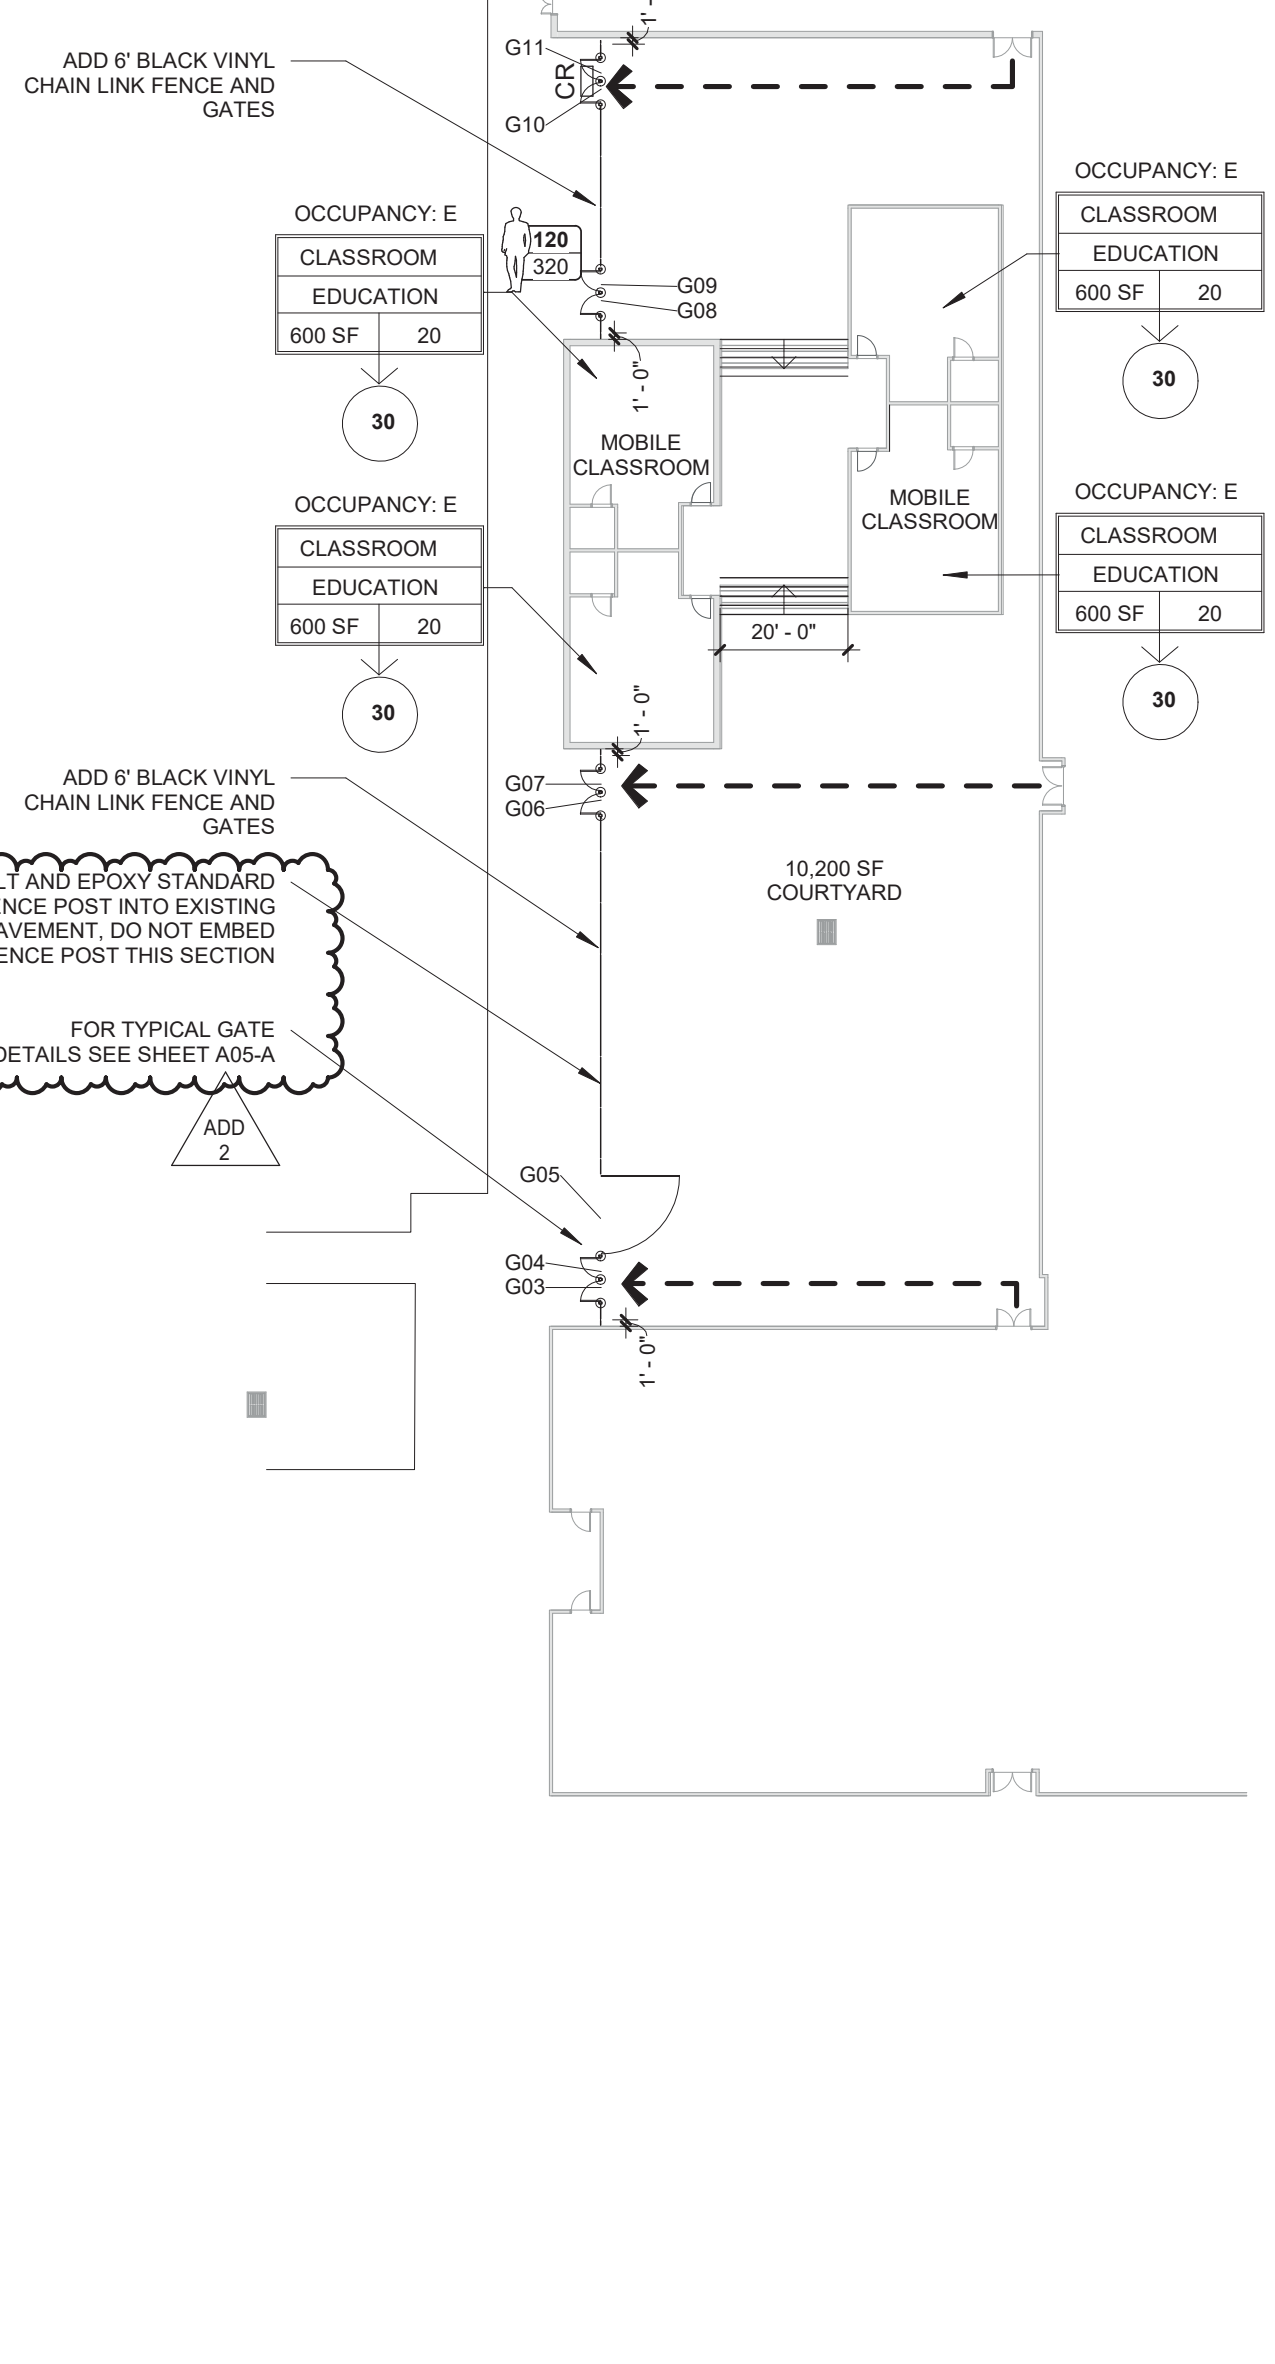


3 EGRESS SITE PLAN SHELDON
1" = 20'-0"

REVISIONS:


#	DESCRP.	DATE
1	ADD 2	04/04/23

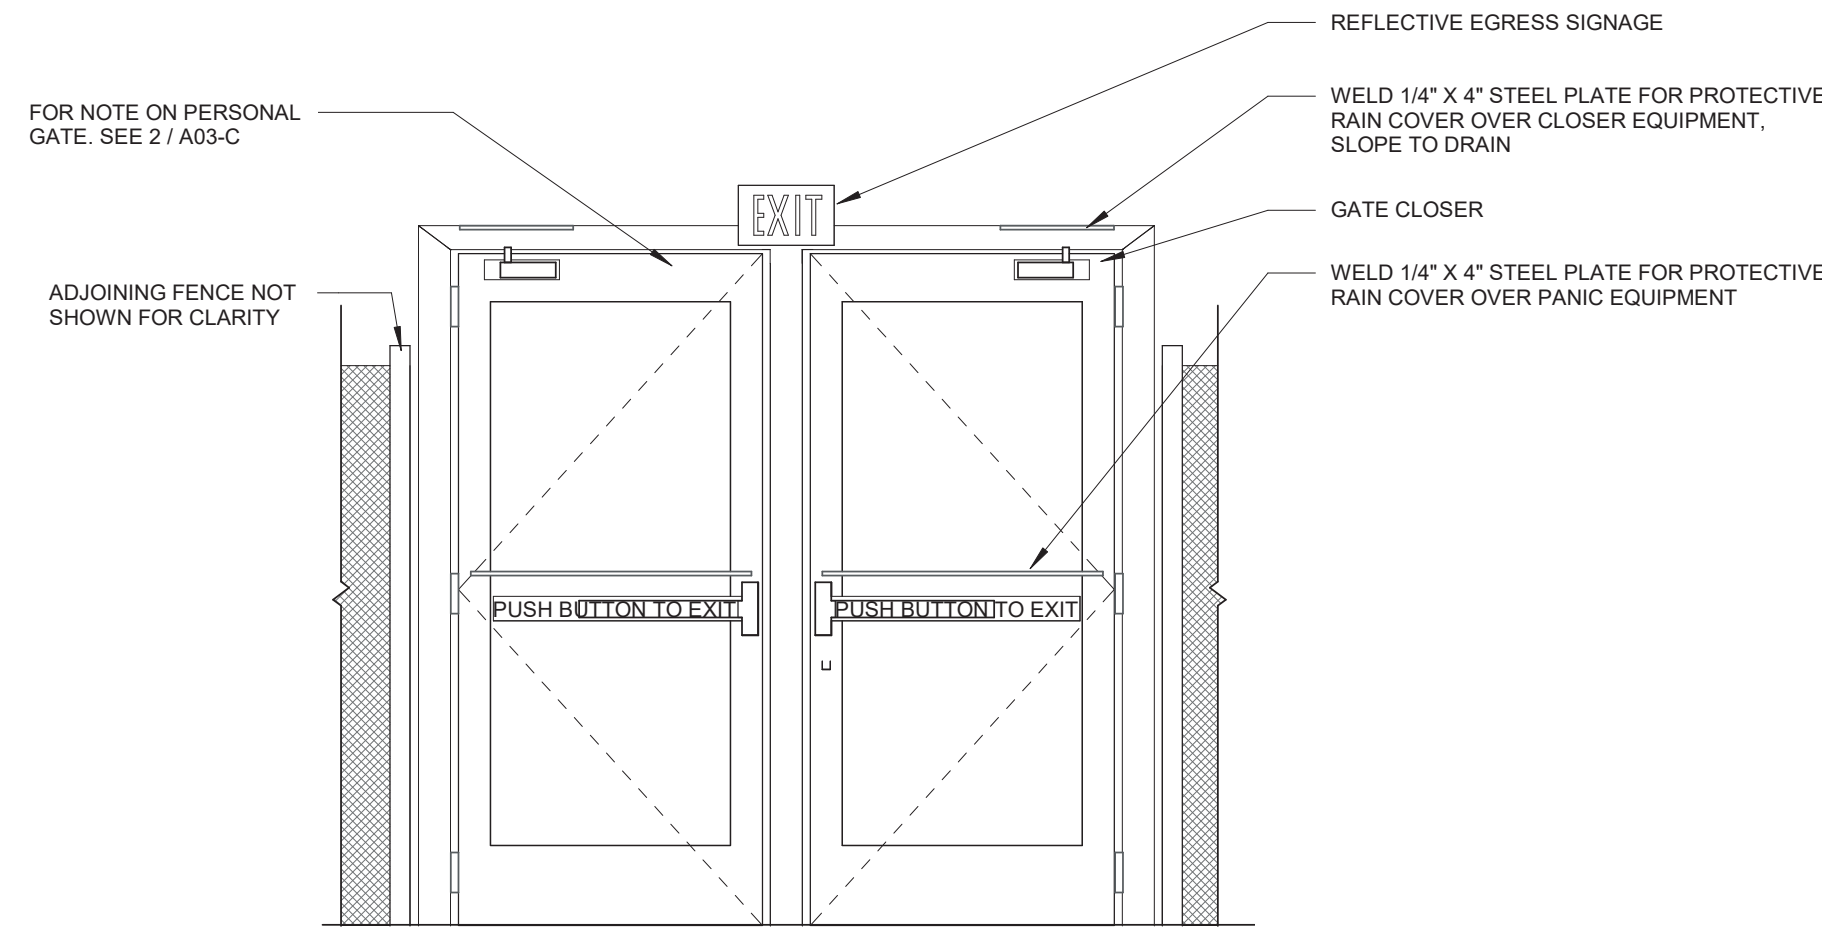


7 DOUBLE GATE SECURED SIDE ELEVATION
1/2" = 1'-0"

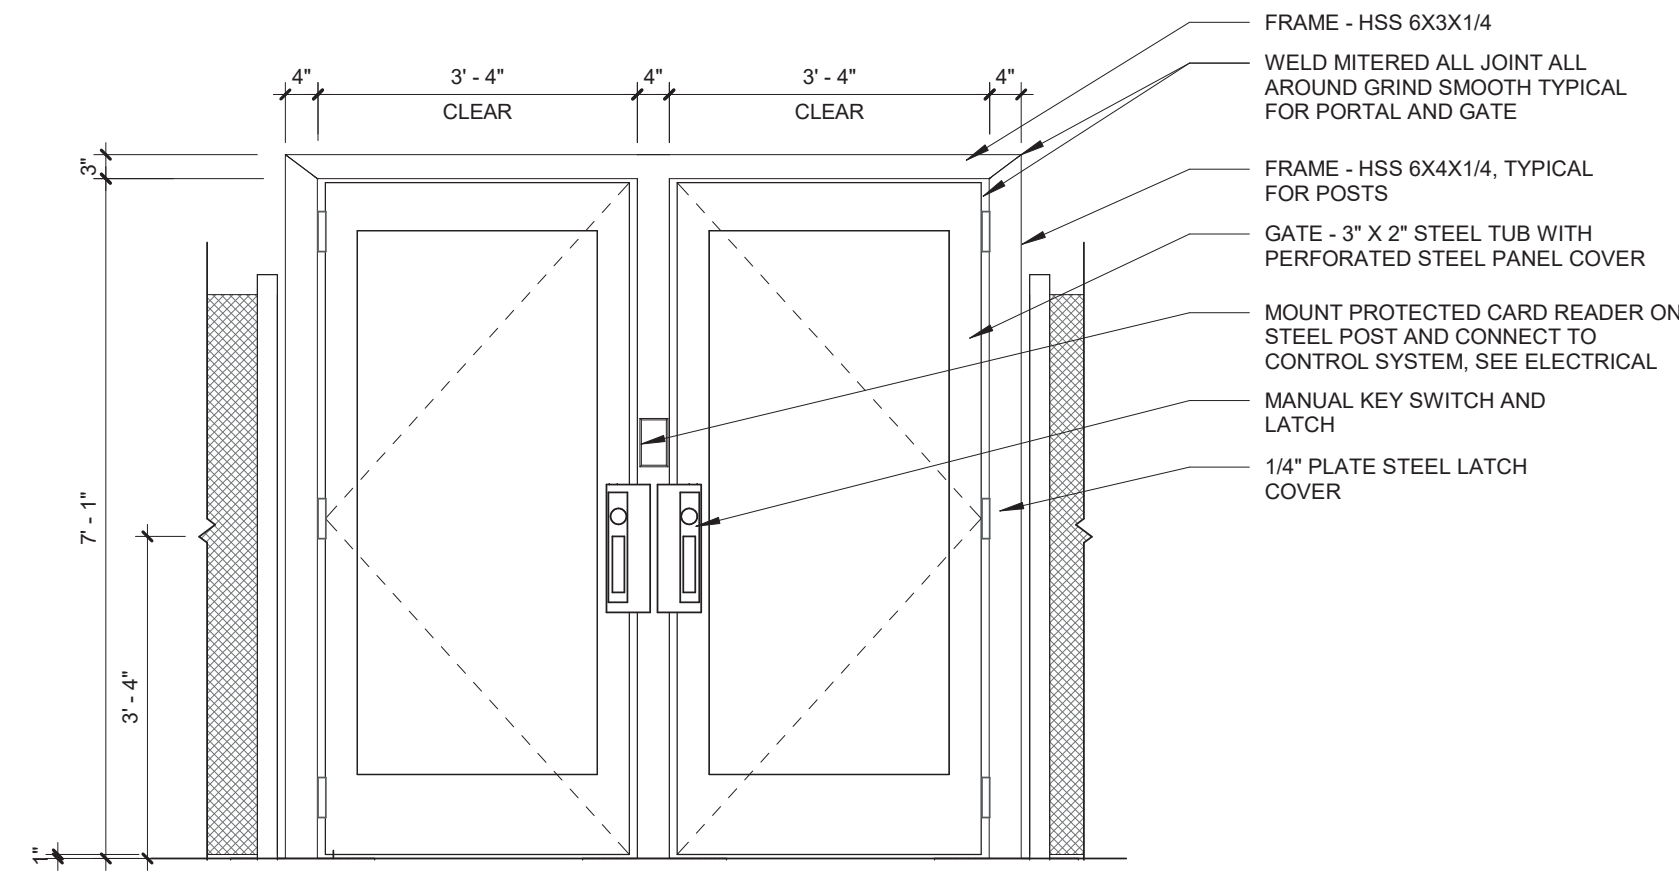


4 DOUBLE GATE NON-SECURED SIDE ELEVATION
1/2" = 1'-0"

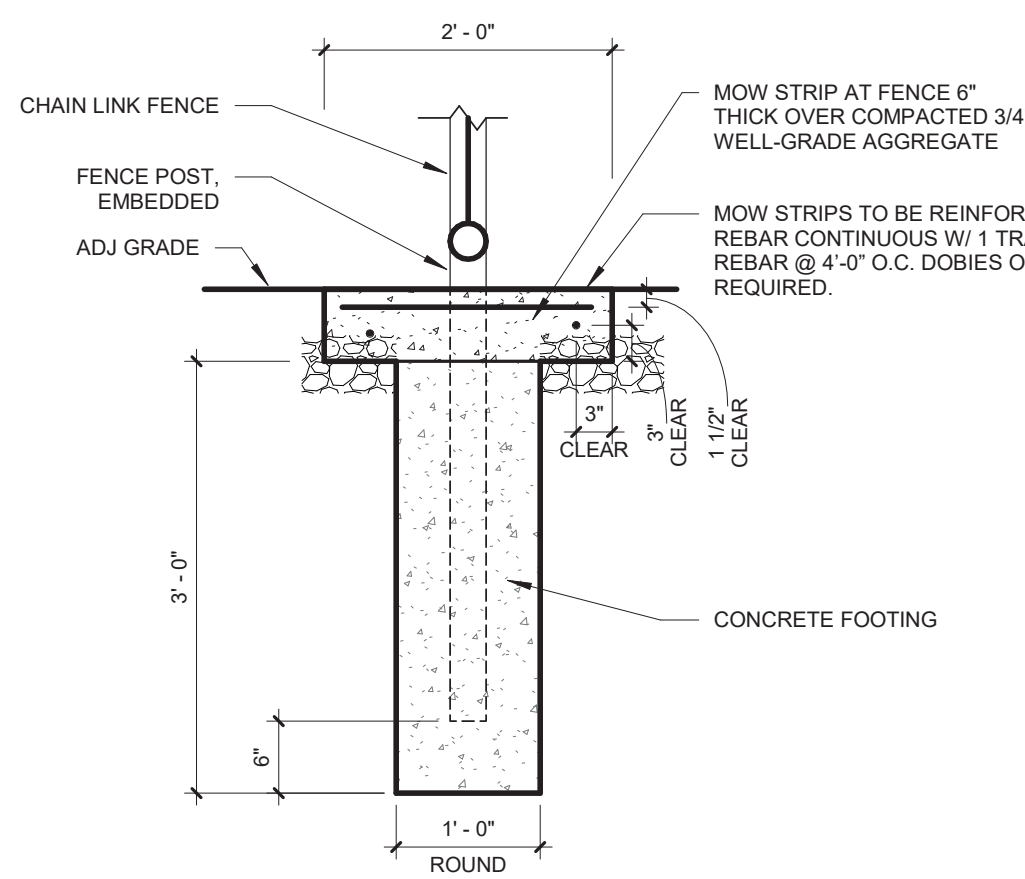


6 TYPICAL FENCE POST
3/4" = 1'-0"

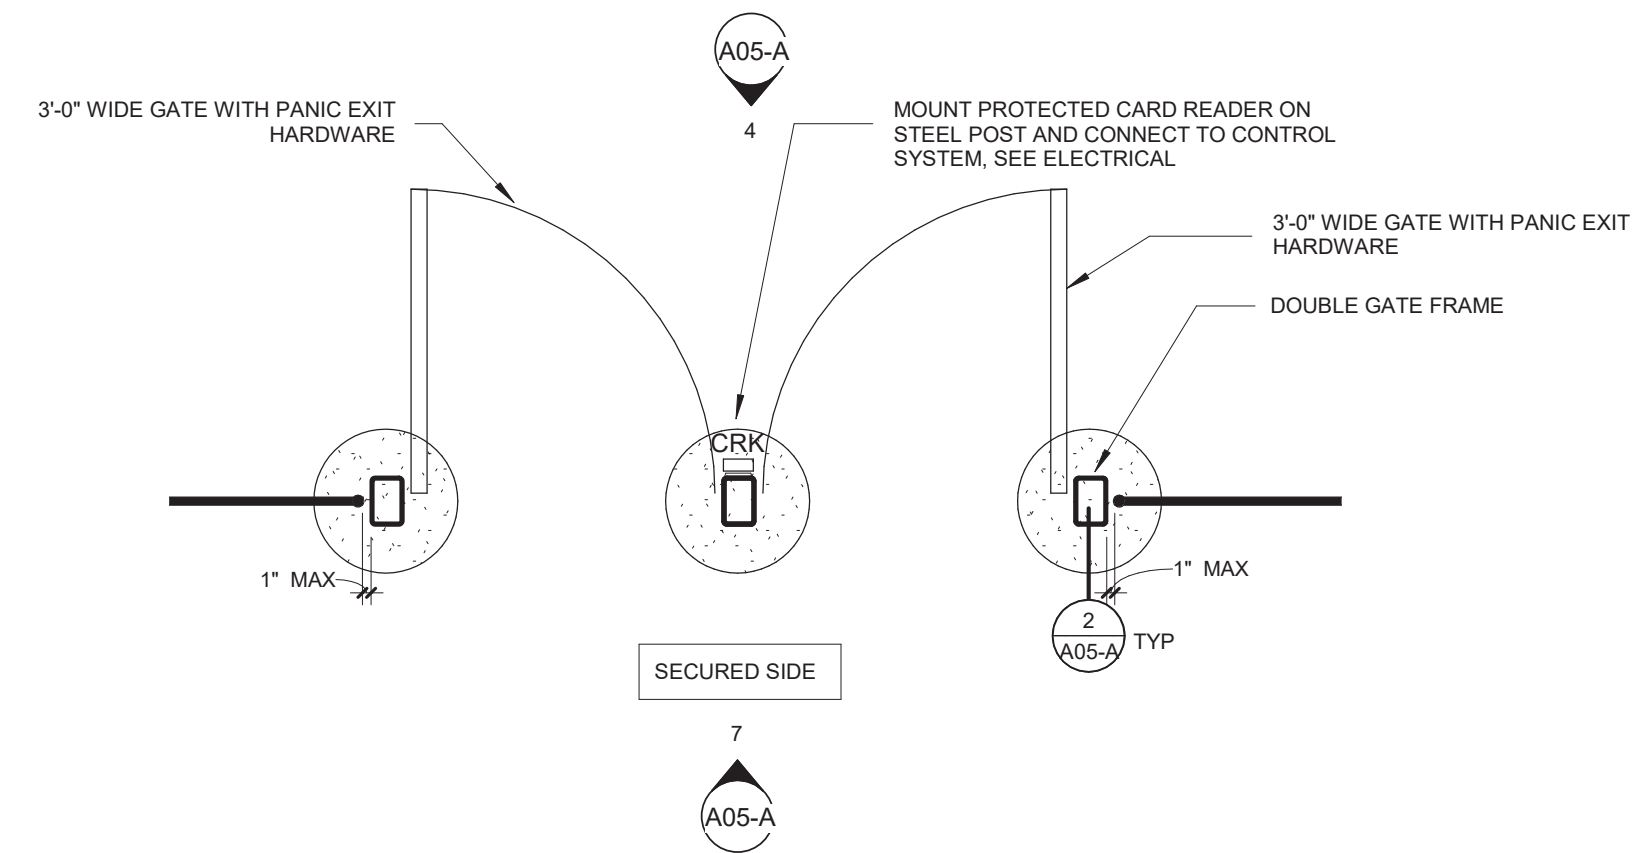


3 DOUBLE GATE PLAN
1/2" = 1'-0"

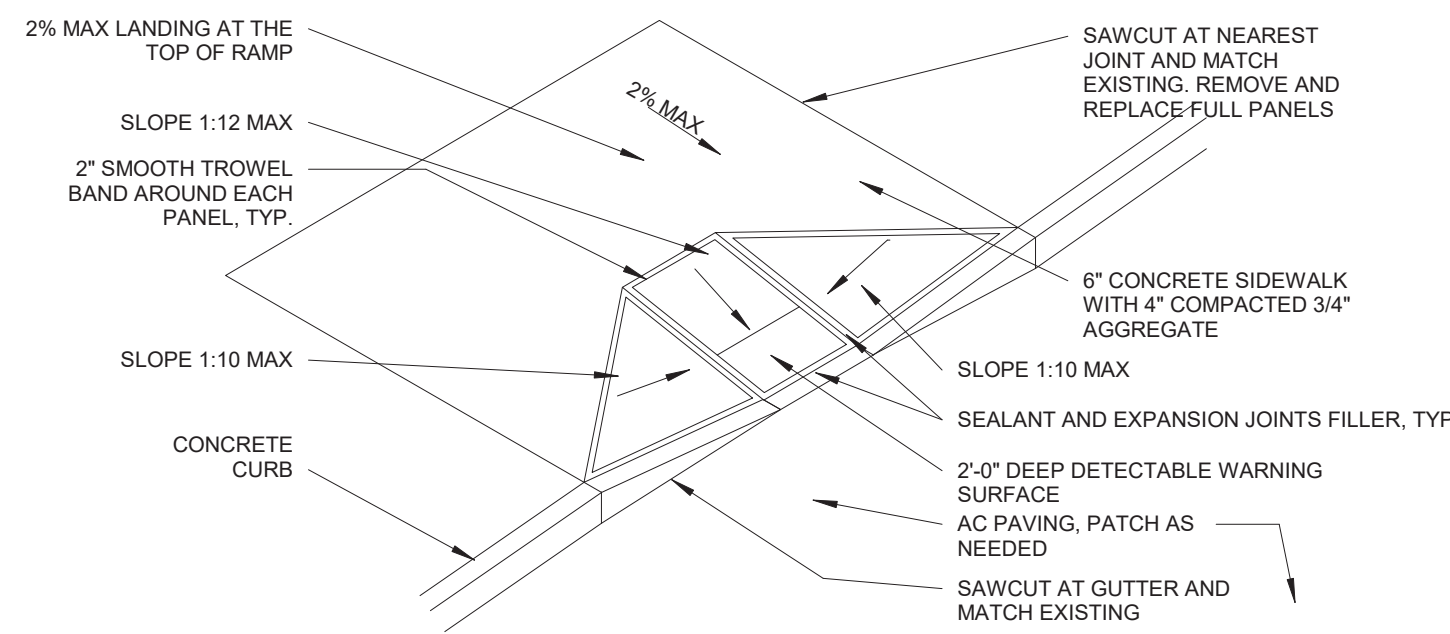

8 CURB RAMP
3/16" = 1'-0"

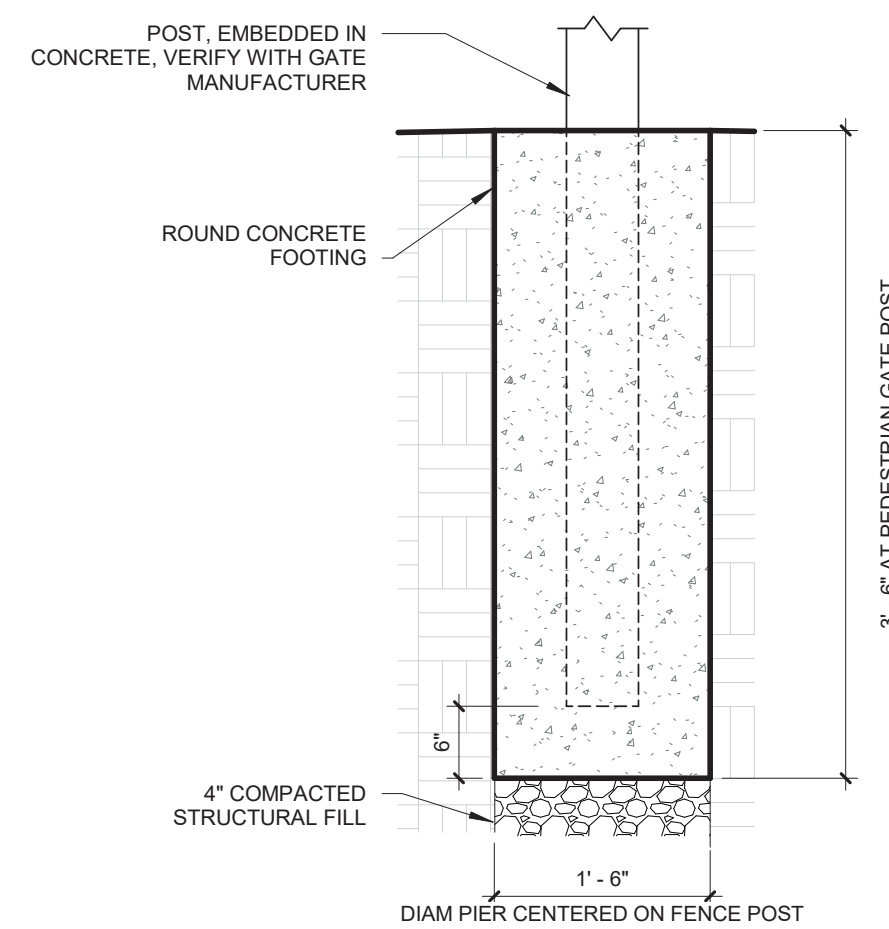

2 FOOTING AT VEHICULAR / PEDESTRIAN GATE POST
3/4" = 1'-0"

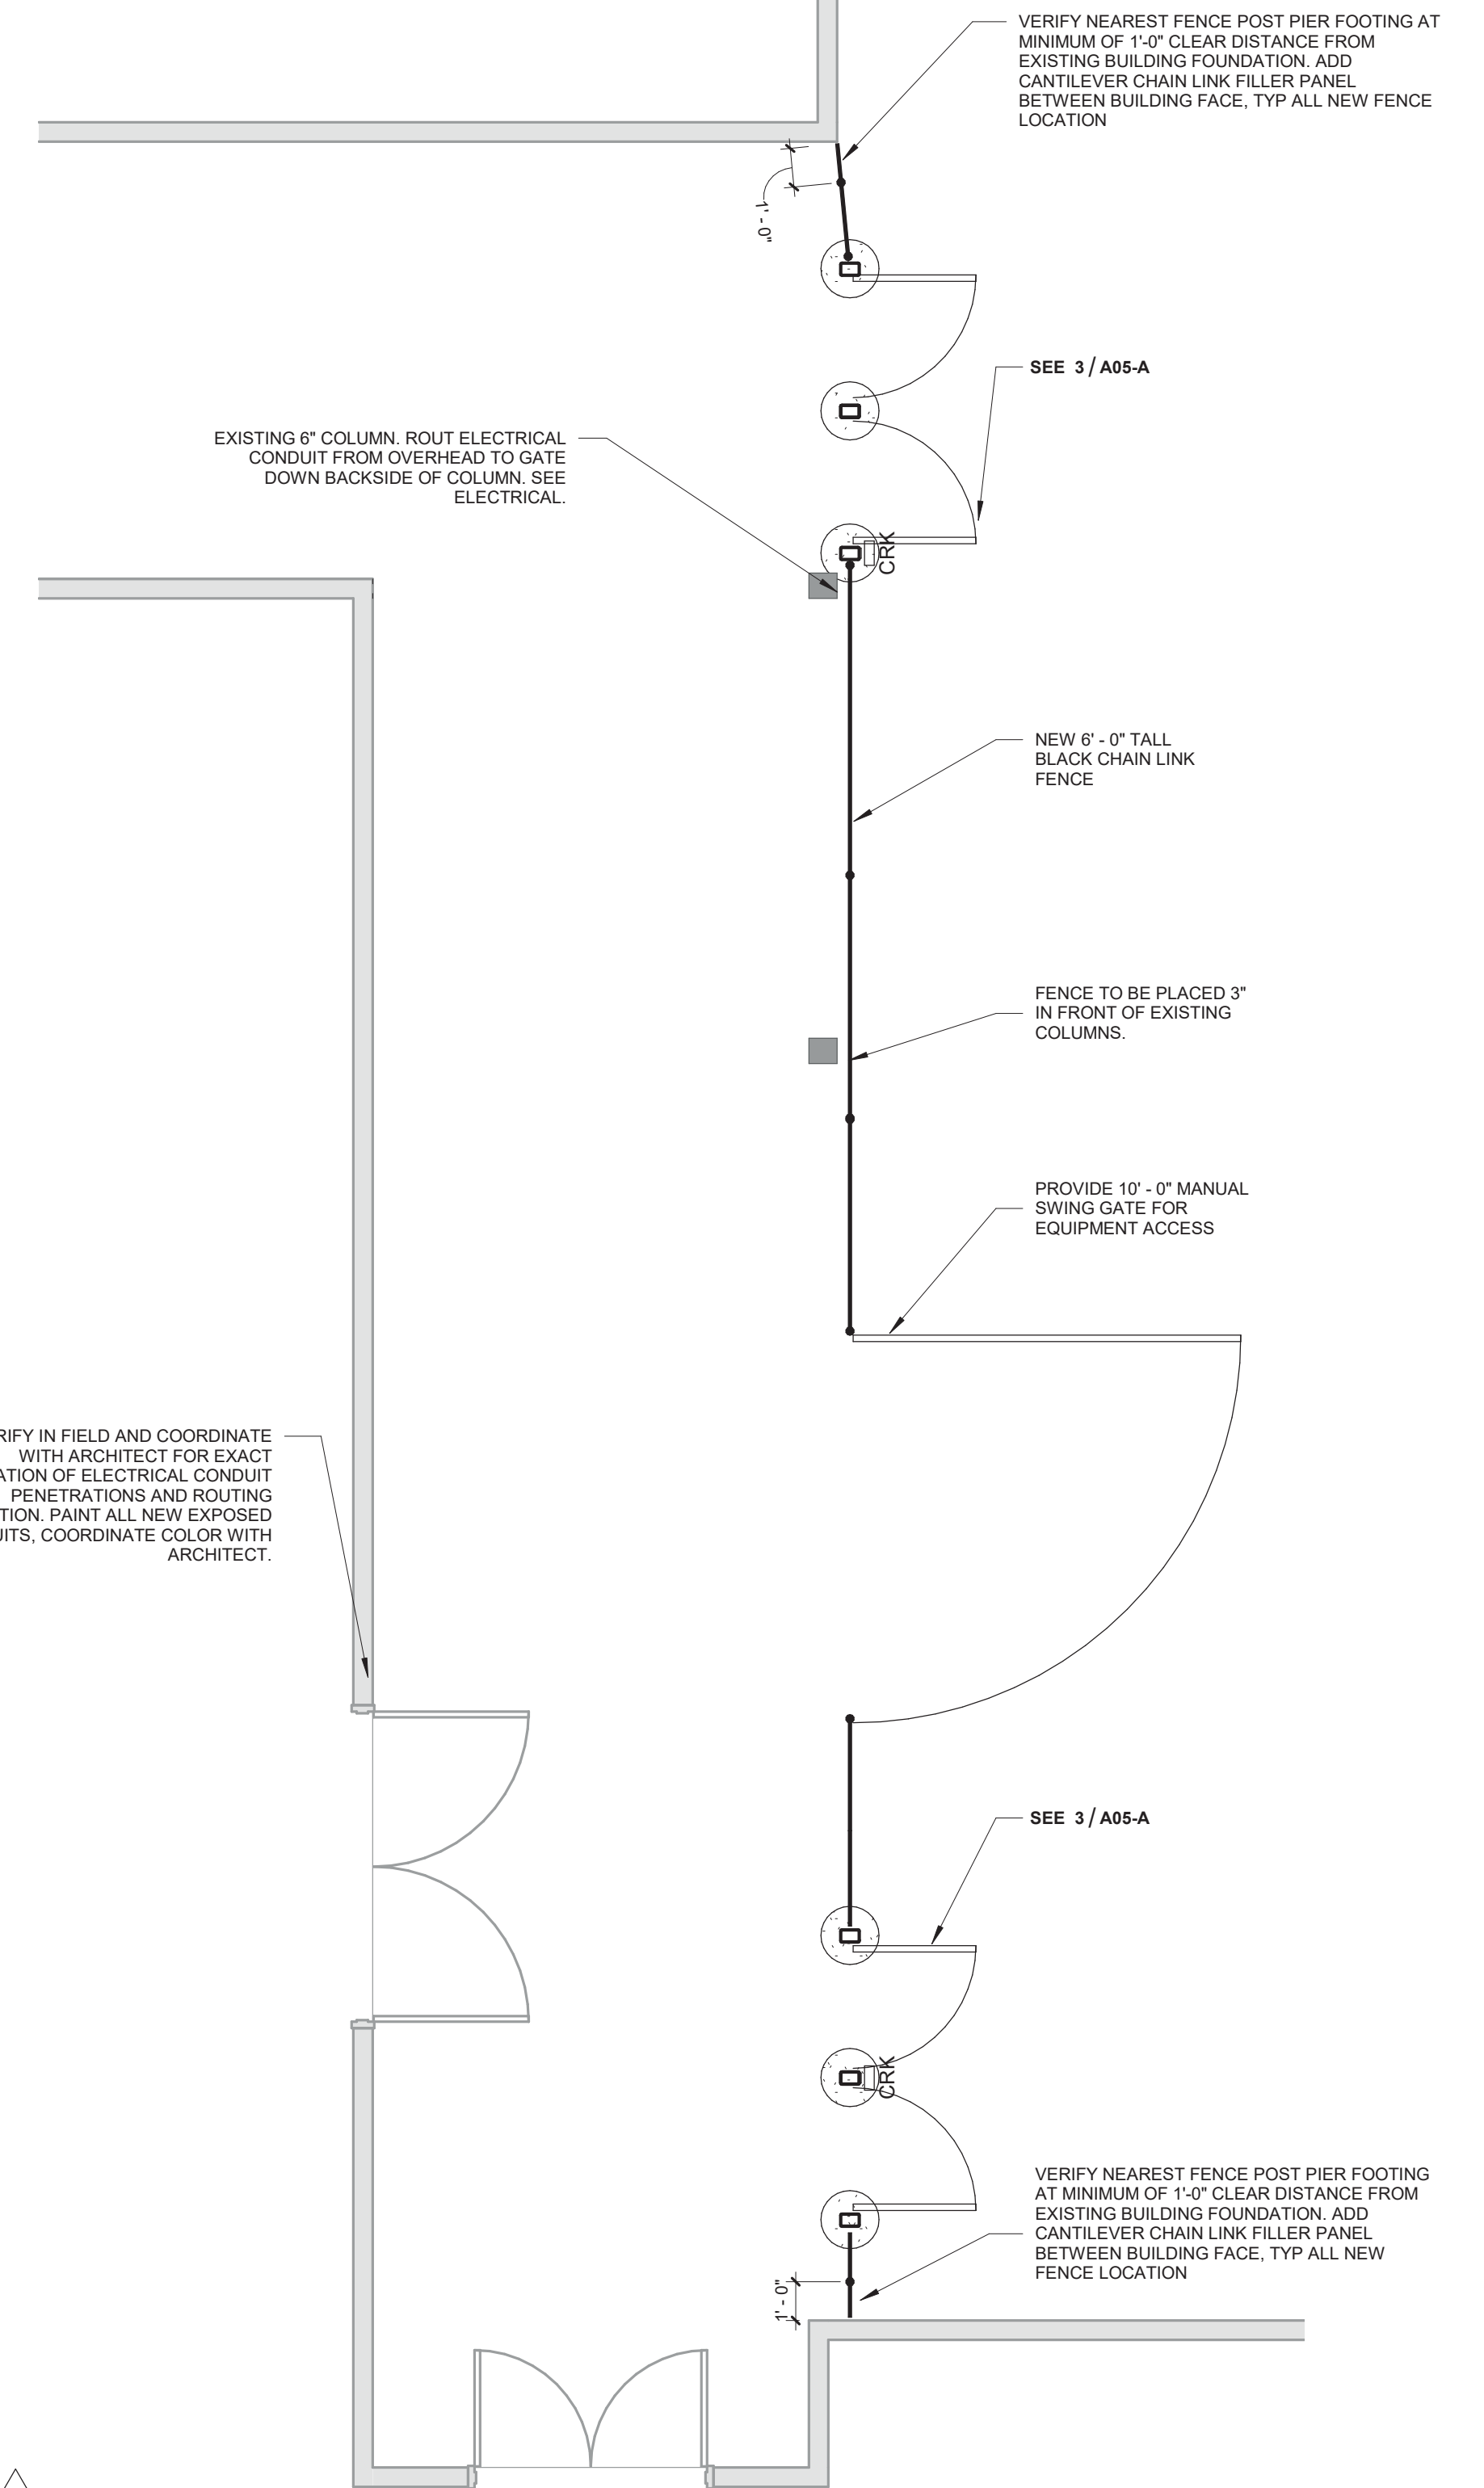


1 DOUBLE GATES AT MECHANICAL PLAN
1/4" = 1'-0"

REVISIONS:


#	DESCRP.	DATE
1	ADD 2	04/04/23

GENERAL NOTES


VERIFY EXISTING FOOTING IN FIELD. ALERT ARCHITECT ONCE THE EXISTING CONDITIONS ARE CONFIRMED.

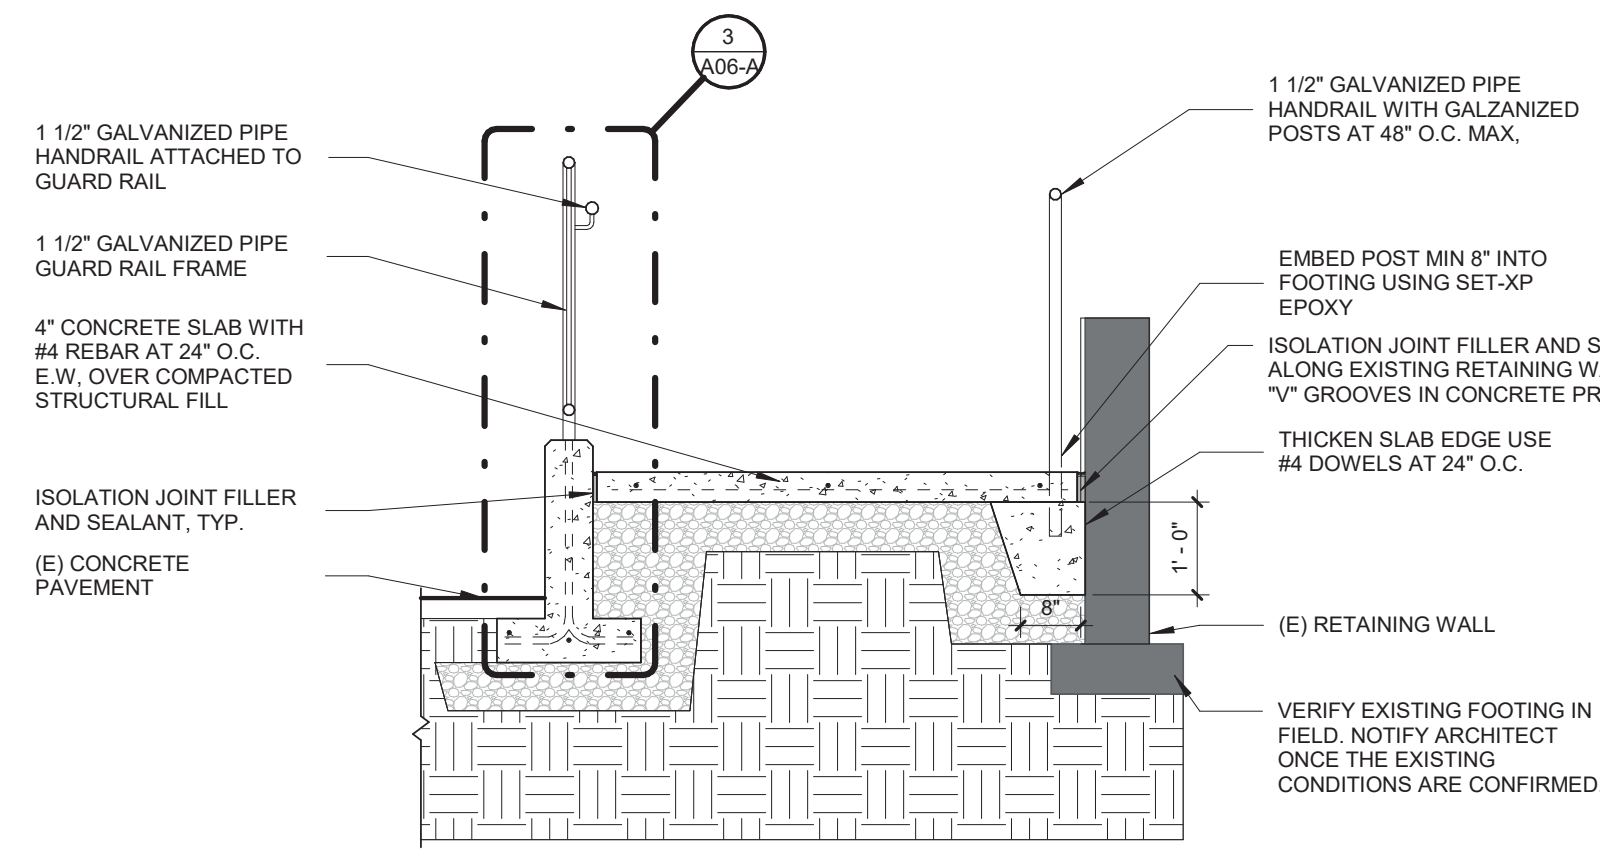


5 RAMP CROSS SECTION
1/2" = 1'-0"

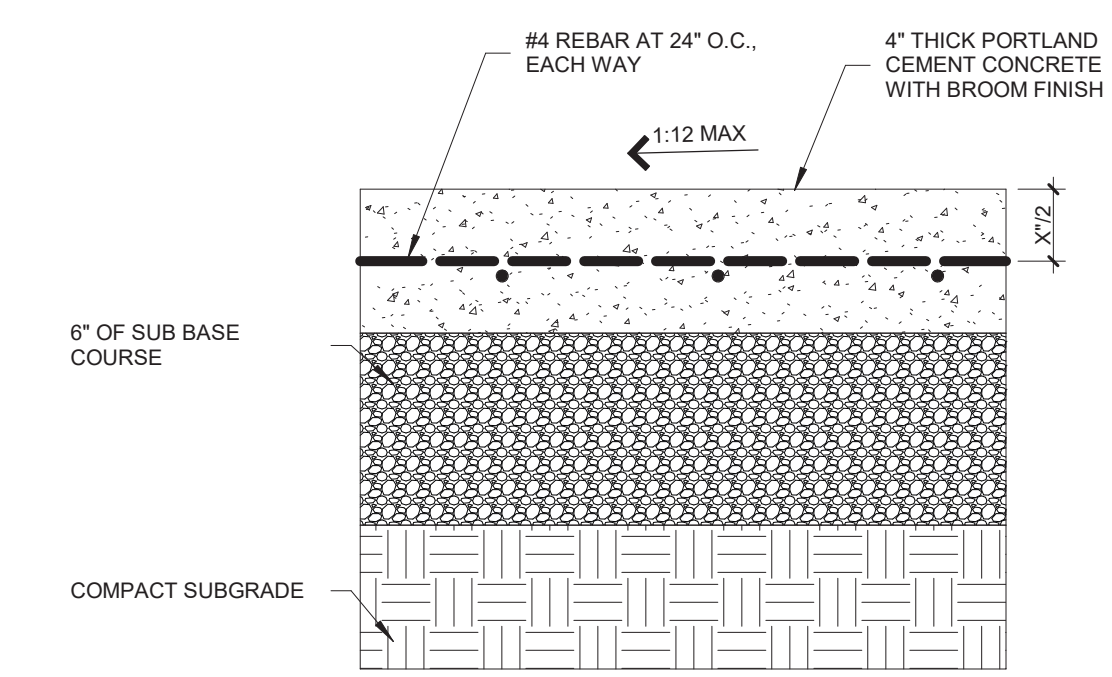


4 CONCRETE SIDEWALK
1 1/2" = 1'-0"

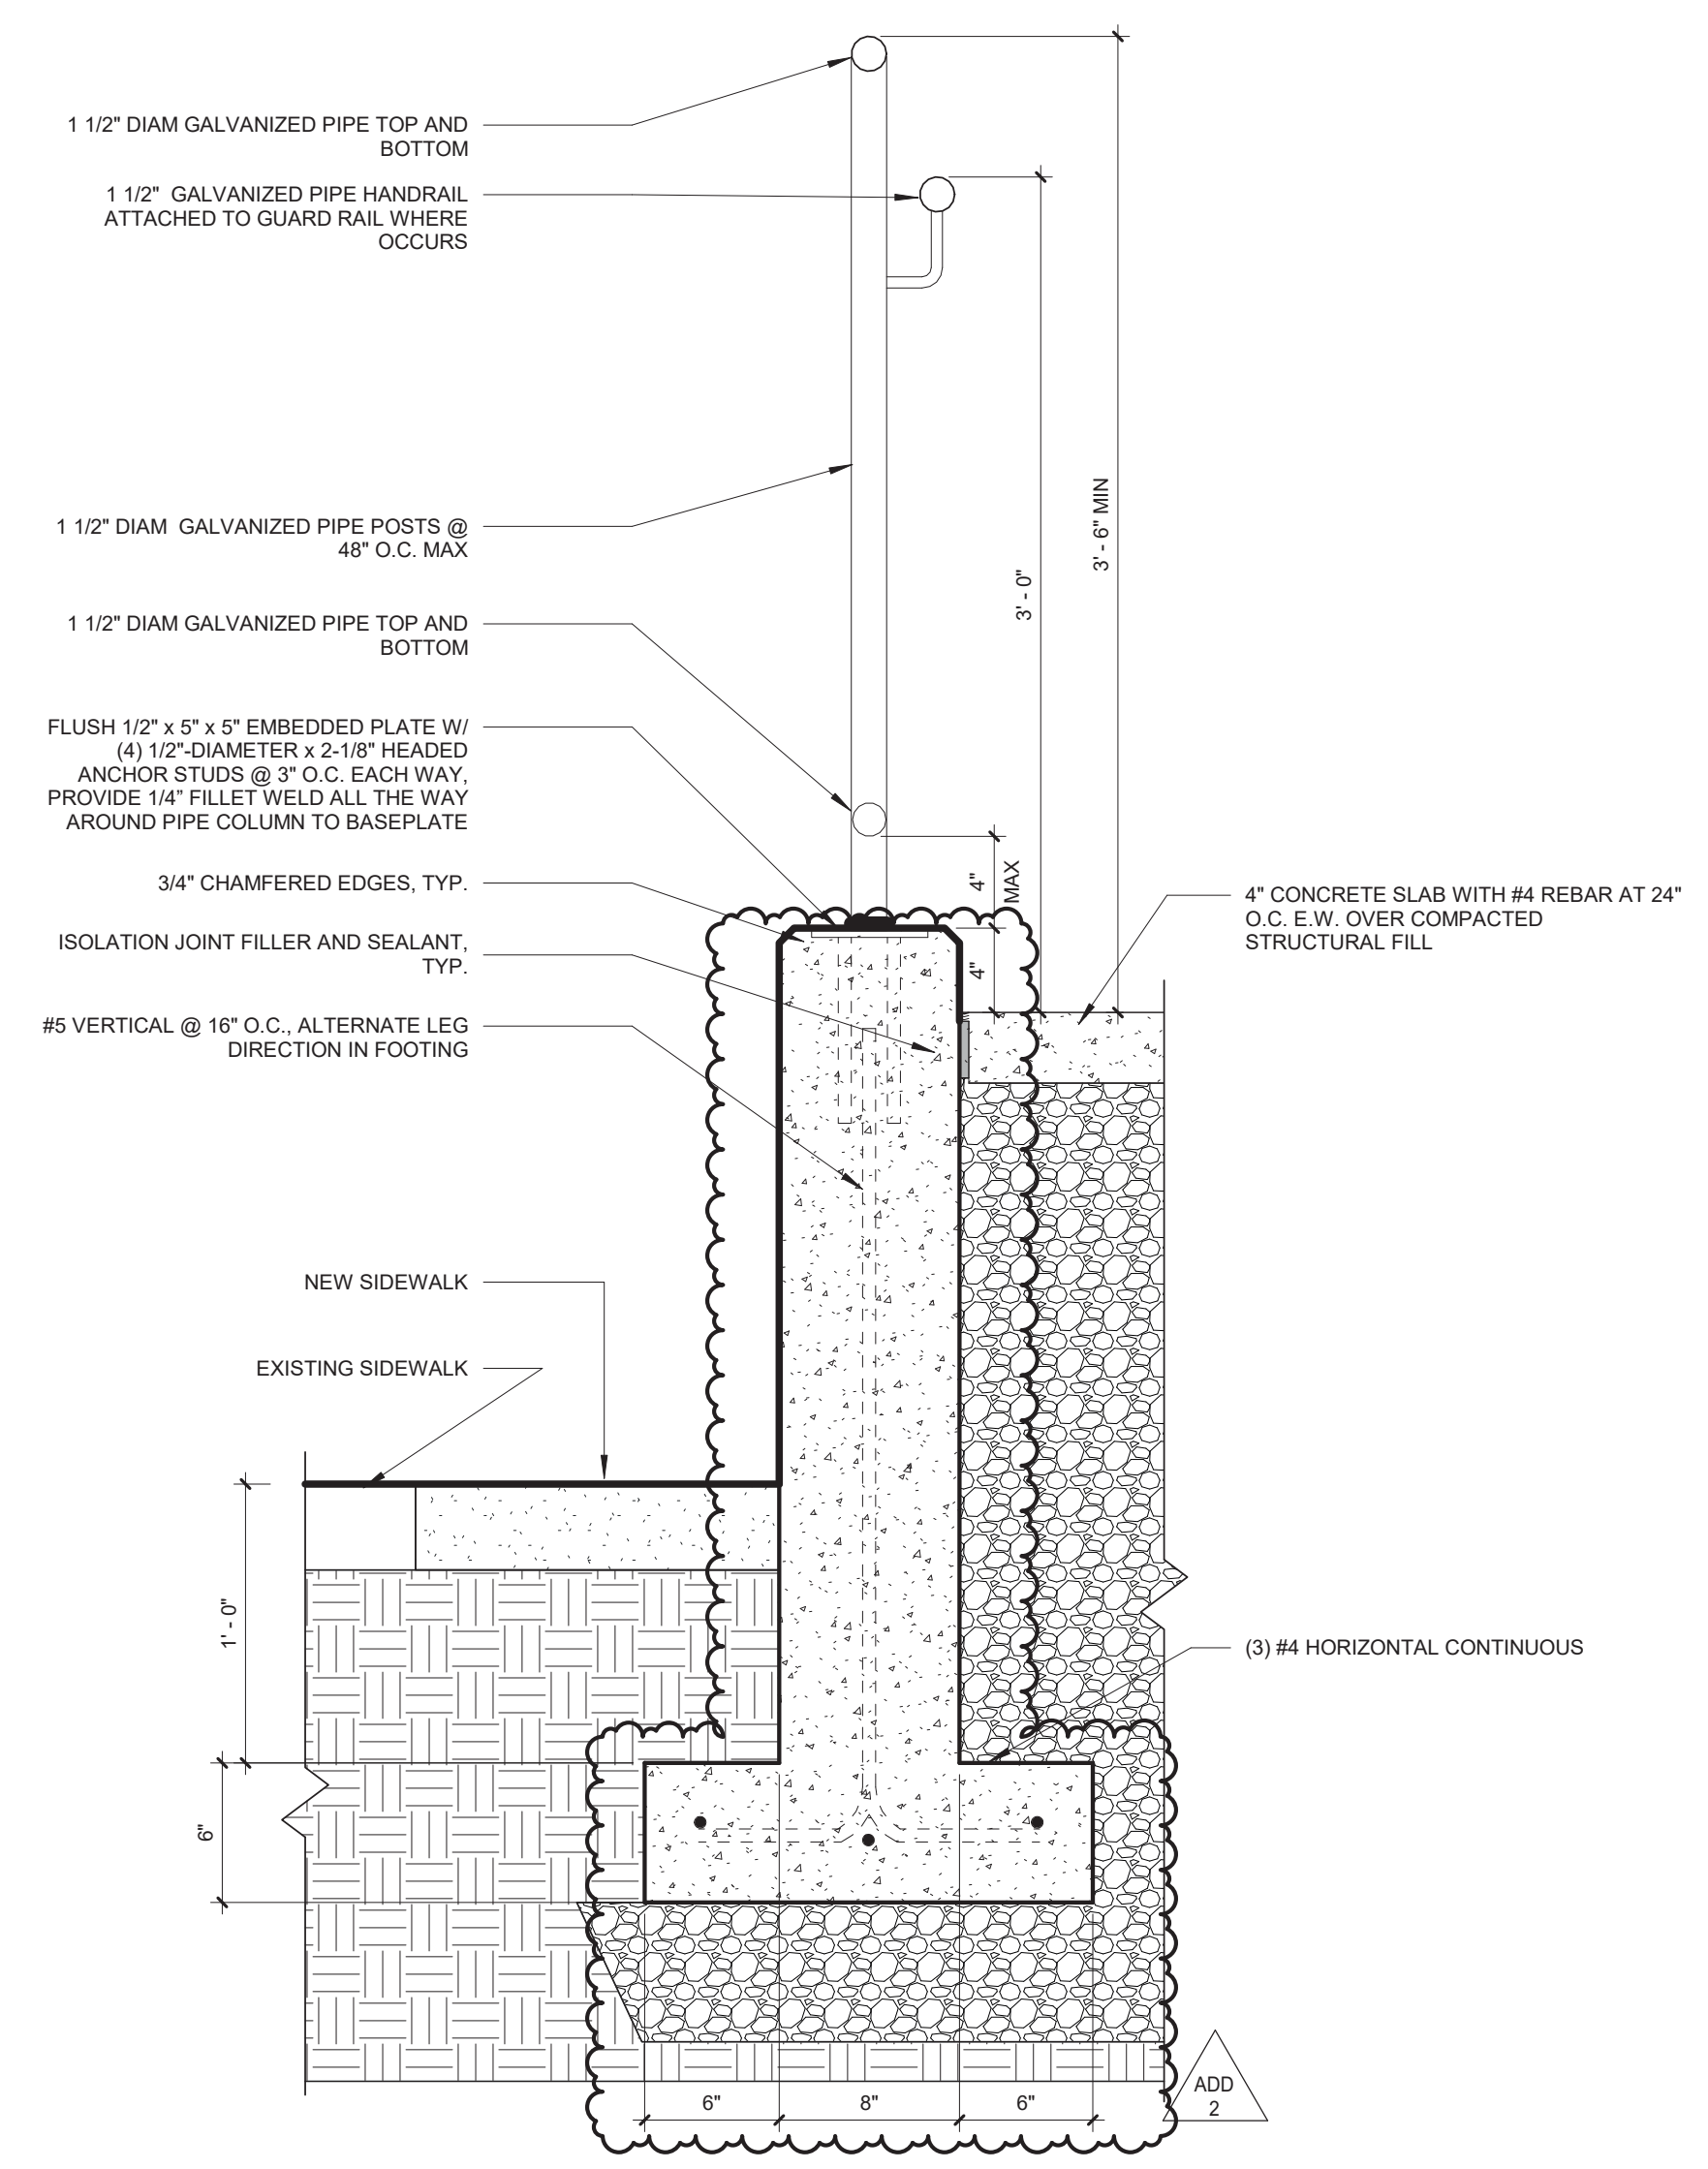


3 TYPICAL GUARDRAIL
1 1/2" = 1'-0"

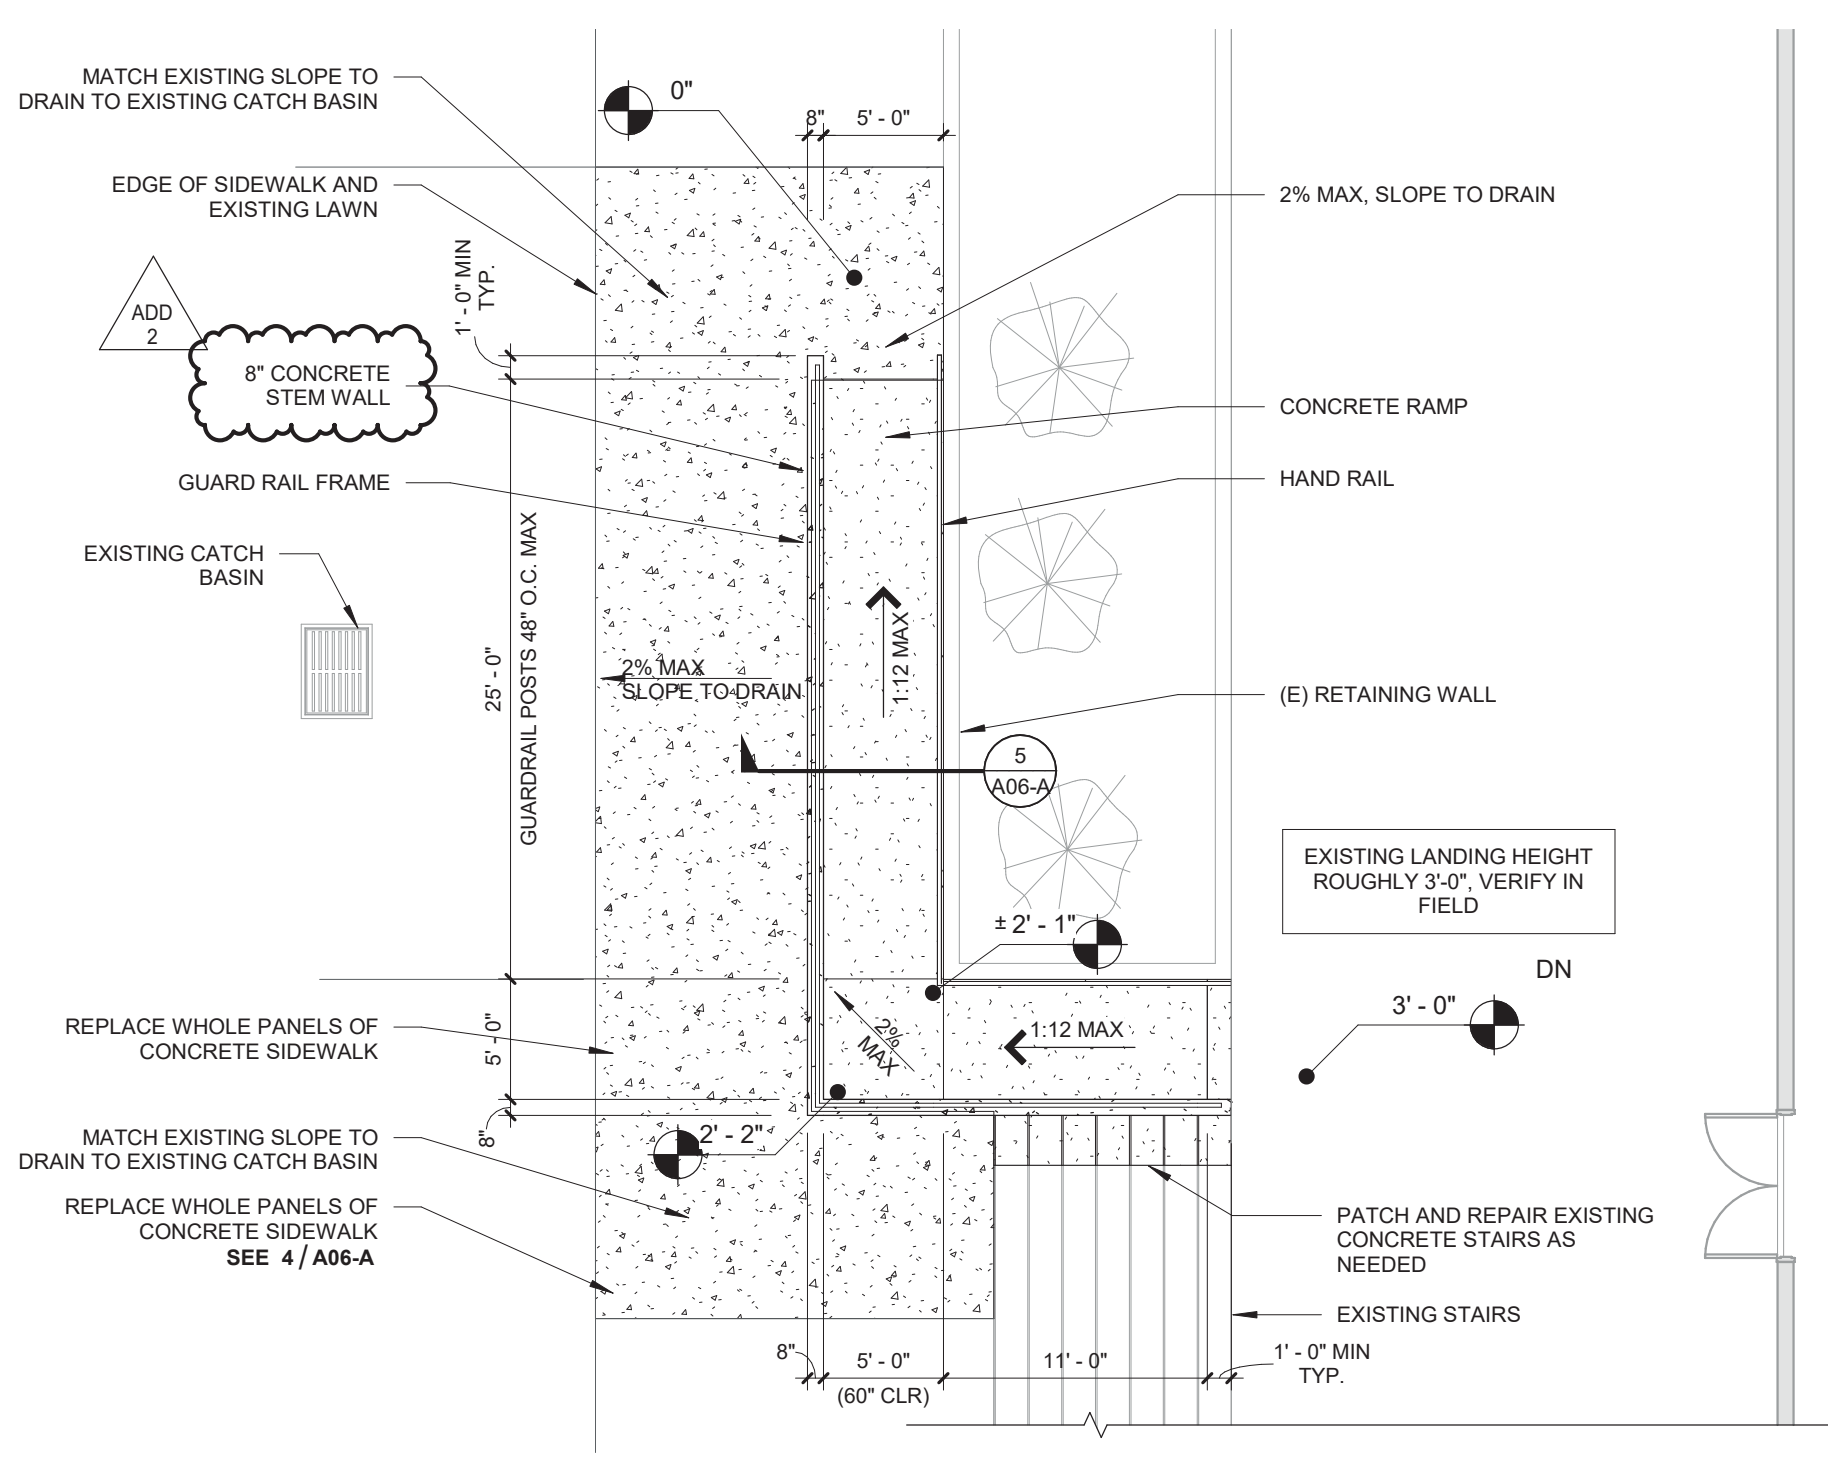

2 RAMP PLAN
1/8" = 1'-0"

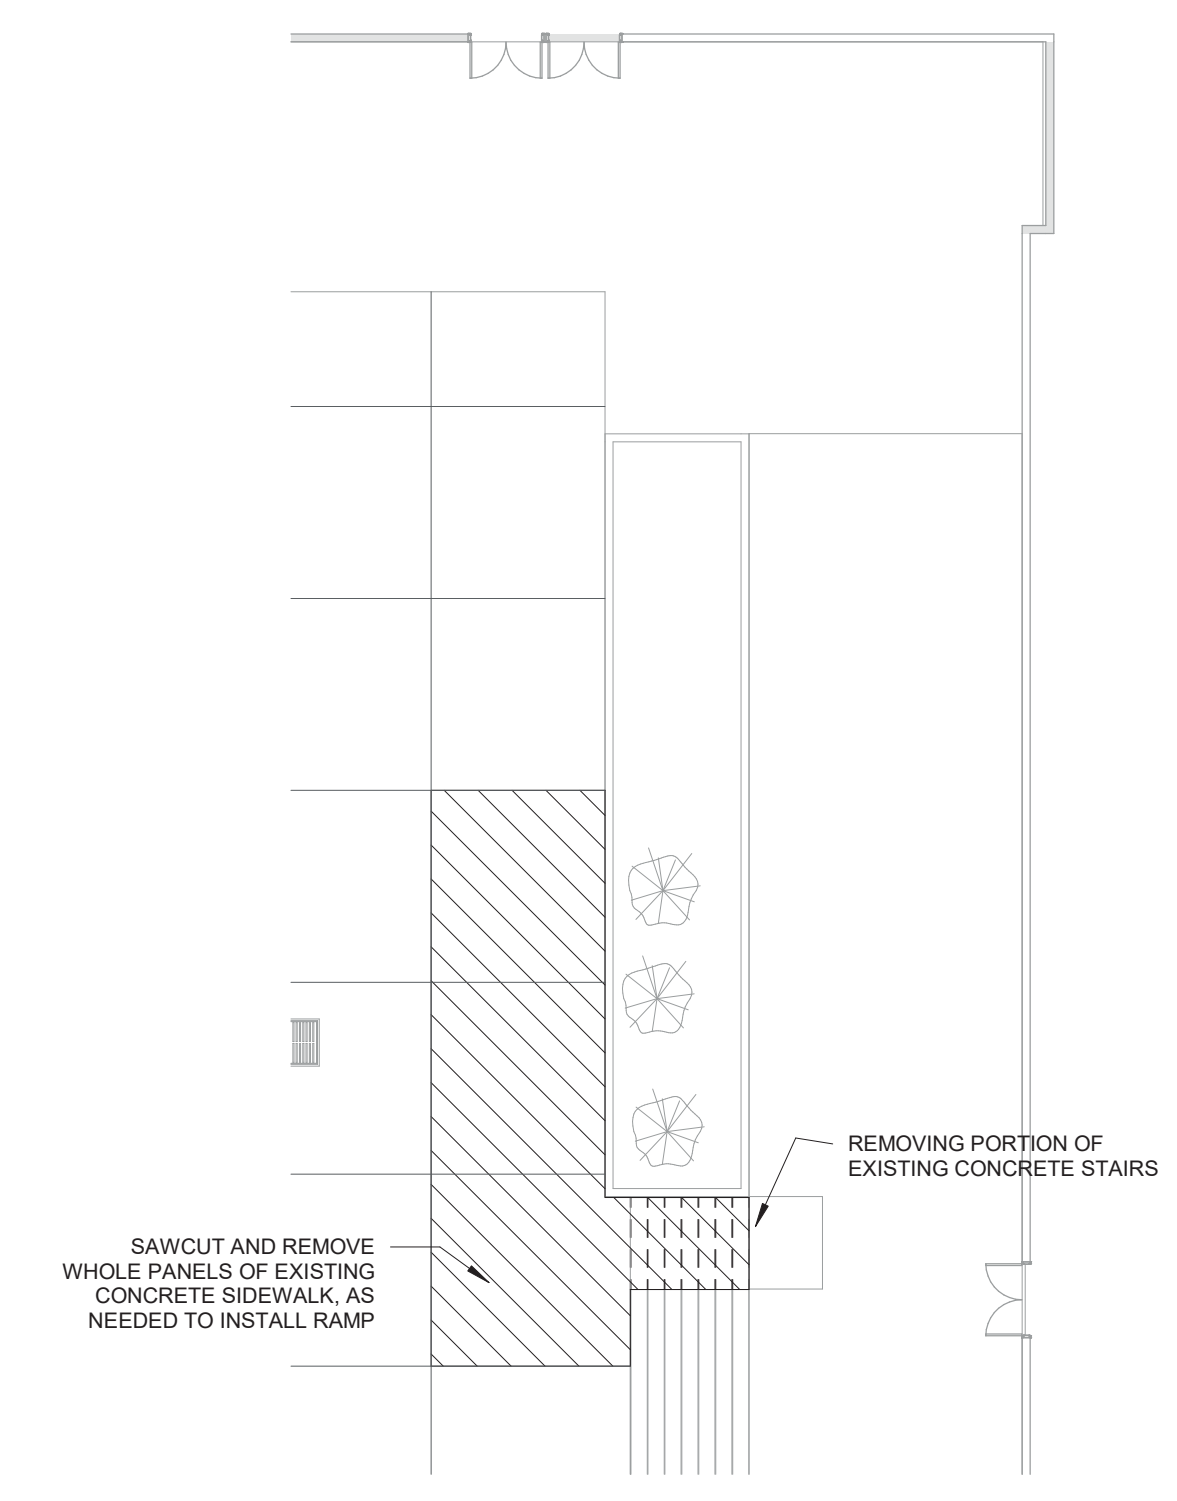

1 RAMP PLAN - DEMOLITION
1/16" = 1'-0"

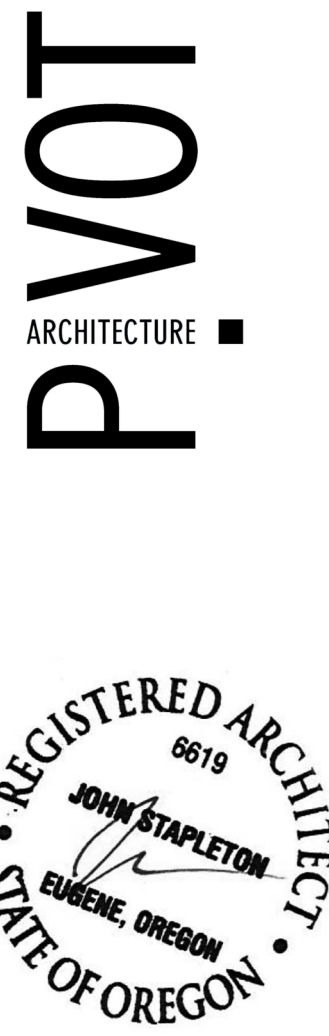

CONSTRUCTION DRAWING SET
4J SECURITY IMPROVEMENTS
PROJECT #: 2207
EUGENE SCHOOL DISTRICT 4J

SHEET TITLE:
SHELDON - RAMP

REVISIONS:

#	DESCRP.	DATE
1	ADD 2	04/04/23

ISSUE DATE: 03.15.23



A06-A

- GENERAL NOTES - FLOOR PLANS**
- A. DIMENSIONS SHOWN ARE TO THE FACE OF STUD, CONCRETE OR MASONRY UNLESS OTHERWISE NOTED. CONTACT THE ARCHITECT FOR ANY ADDITIONAL DIMENSIONS REQUIRED TO LAY OUT THE WORK.
 - B. MASONRY DIMENSIONS ARE THE ACTUAL MASONRY UNIT SIZES UNLESS OTHERWISE NOTED.
 - C. REPAIR PATCHED SURFACES THAT ARE DAMAGED, LIFTED, DISCOLORED, OR SHOWING OTHER IMPERFECTIONS DUE TO PATCHING WORK. IF DEFECTS ARE DUE TO CONDITION OF SUBSTRATE, REPAIR SUBSTRATE PRIOR TO REPAIRING FINISH.
 - D. WHERE (E) FLOOR IS TO REMAIN, PROTECT FROM DAMAGE. PATCH AND REPAIR ANY HOLES IN CONCRETE SLAB CAUSED BY DEMOLITION OF EXISTING WALLS, (I.E. WALL ANCHORS).
 - E. PATCH AND REPAIR ANY WALL AND CEILING LOCATIONS WHERE EXISTING ELECTRICAL AND VOICE/DATA OUTLET, JUNCTION BOXES, AND SIMILAR WALL MOUNTED ITEMS ARE REMOVED OR ABANDONED WITHIN THE WORK AREA.
 - F. PATCH AND REPAIR WALL AND CEILING SURFACES WHERE MODULAR SYSTEMS FURNITURE WAS REMOVED BY SEPARATE CONTRACTOR.
 - G. PATCH AND REPAIR ANY WALL LOCATIONS WHERE EXISTING WALL COVERING HAS BEEN REMOVED WITHIN THE WORK AREA.
 - H. PATCH AND REPAIR ANY WALL LOCATIONS WHERE EXISTING WALL BASE HAS BEEN REMOVED WITHIN THE WORK AREA.
 - I. PATCH AND REPAIR ANY WALL LOCATIONS WHERE EXISTING EQUIPMENT, ACCESSORIES, HARDWARE OR OTHER SURFACE MOUNTED ELEMENTS HAVE BEEN REMOVED WITHIN THE WORK AREA.
 - J. VERIFY LOCATION OF PROX-CARD READERS, AUTOMATIC DOOR OPENERS AND WIRELESS ACTUATORS WITH ARCHITECT DURING ROUGH-IN PHASE OF THE WORK.
 - K. COORDINATE WITH OWNER FOR ANY CEILING/FLOORING DISRUPTION REGARDING ACM

DOOR SCHEDULE - SO

MARK	WIDTH	HEIGHT	DOOR PANEL		FRAME		HARDWARE GROUP	COMMENTS
			TYPE	TYPE	FINISH			
SO1	6'-0"	6'-10"	ALUM	ALUM			01	
SO2	6'-0"	6'-10"	ALUM	ALUM			05	CONTROL ACCESS - SEE HARDWARE SPECIFICATION
SO3	5'-2"	7'-0"	HM	HM	PAINT		03	CONTROL ACCESS - CARD READER, REMOTE LOCK/ UNLOCK
SO4	3'-0"	7'-0"	HM	HM			04	CONTROL ACCESS - SEE HARDWARE SPECIFICATION
SO5	3'-10"	3'-0"	ALUM	ALUM	PER MANUFACTURER		02	HALF HEIGHT ALUMINUM TRAFFIC DOOR - VERIFY OPENING IN FIELD
SO6	3'-0"	7'-0"	WOOD	HM	PAINT		02	OFFICE LOCKSET
SO7	3'-0"	7'-0"	WOOD	HM	PAINT		02	OFFICE LOCKSET
SO8	3'-0"	7'-0"	WOOD	HM	PAINT		02	OFFICE LOCKSET


- WALL FILL PATTERNS:**
- EXISTING WALL ASSEMBLY
 - NON FIRE-RATED WALL ASSEMBLY
 - CARD READER
 - REQUEST TO EXIT
 - CASEWORK TAG- TAG ONLY ON EXISTING CASEWORK TO BE RELOCATED TAG PLACED ON FRONT OF CASEWORK ROTATE ACCORDINGLY

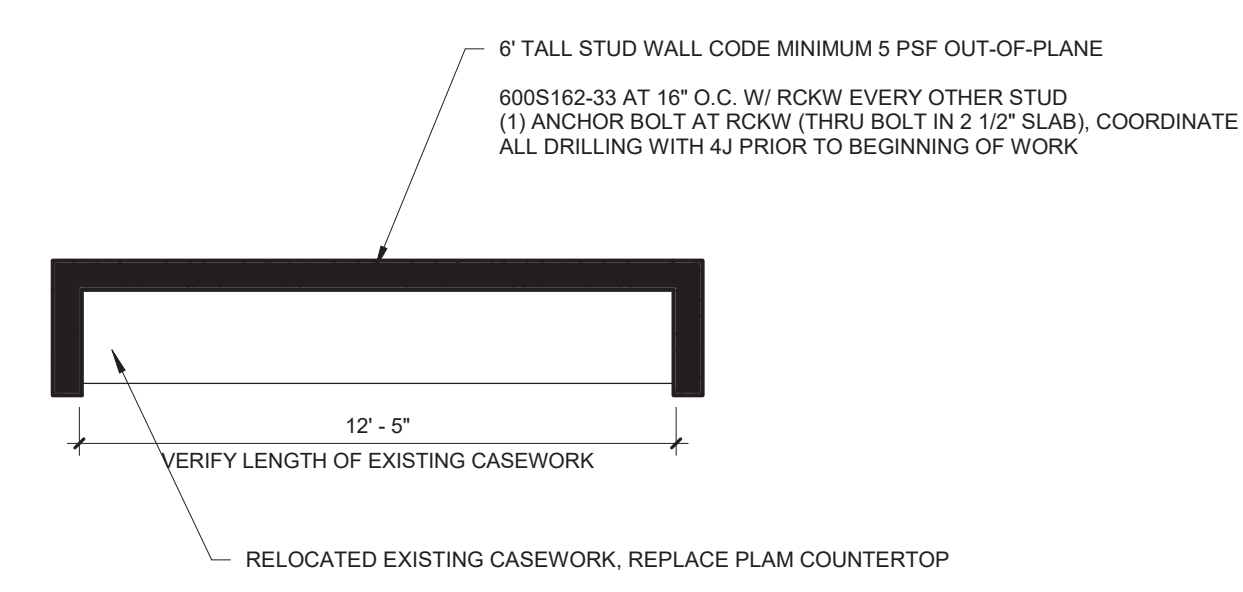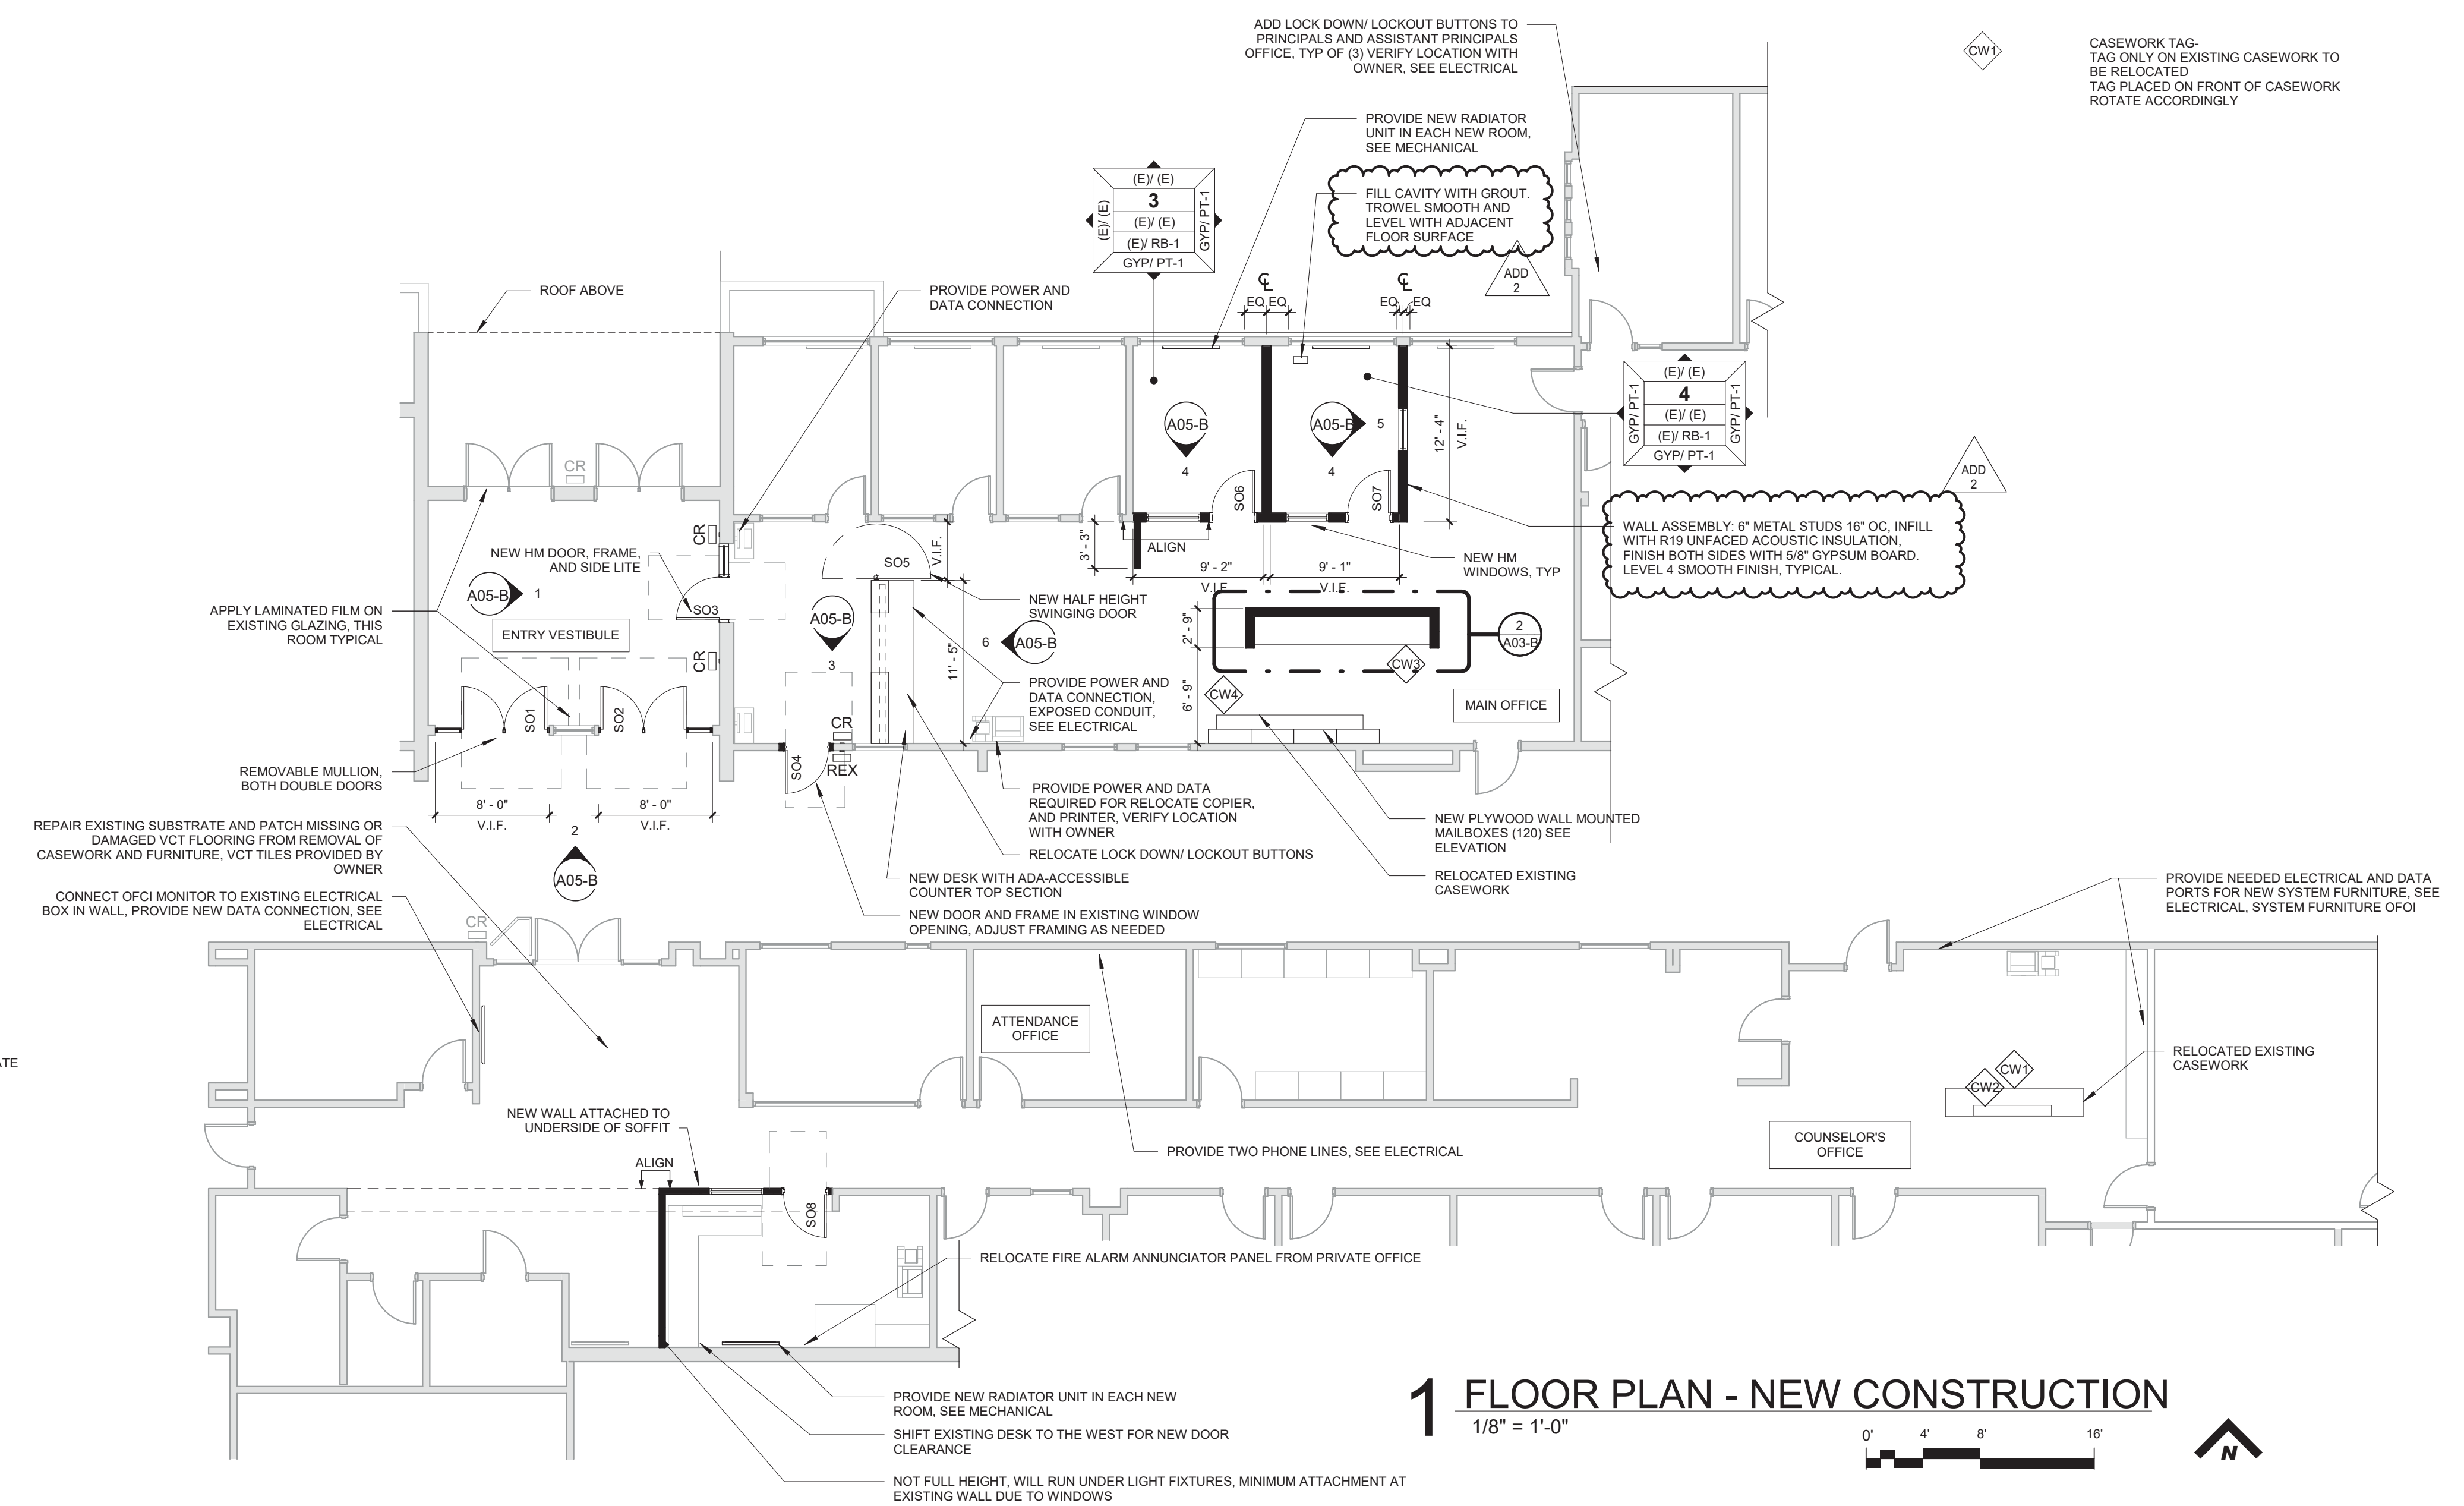


2 WING WALL
1/4" = 1'-0"

1 FLOOR PLAN - NEW CONSTRUCTION
1/8" = 1'-0"




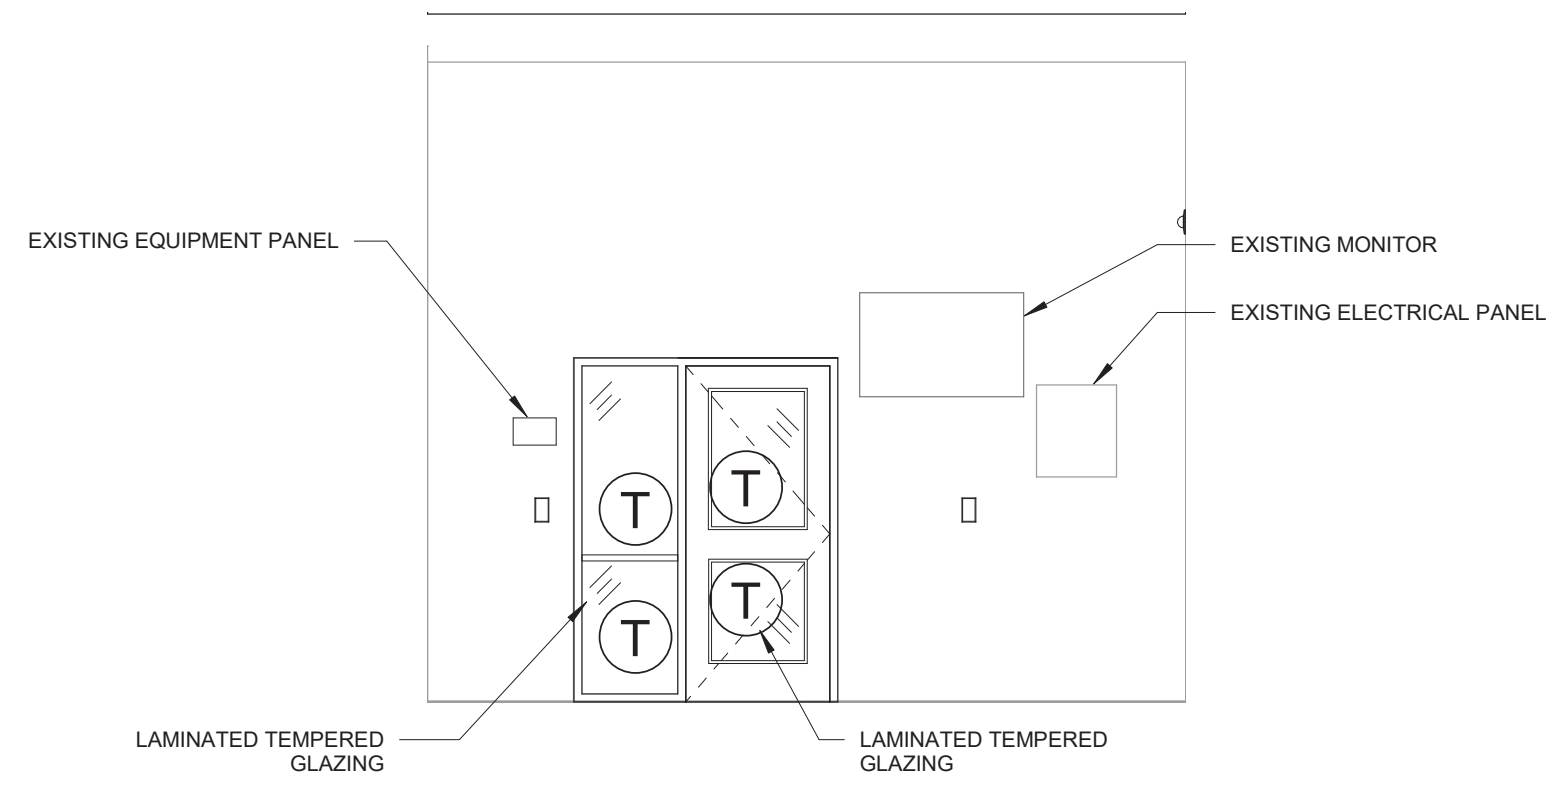


1 HS - SOUTH - VESTIBULE - E
1/4" = 1'-0"

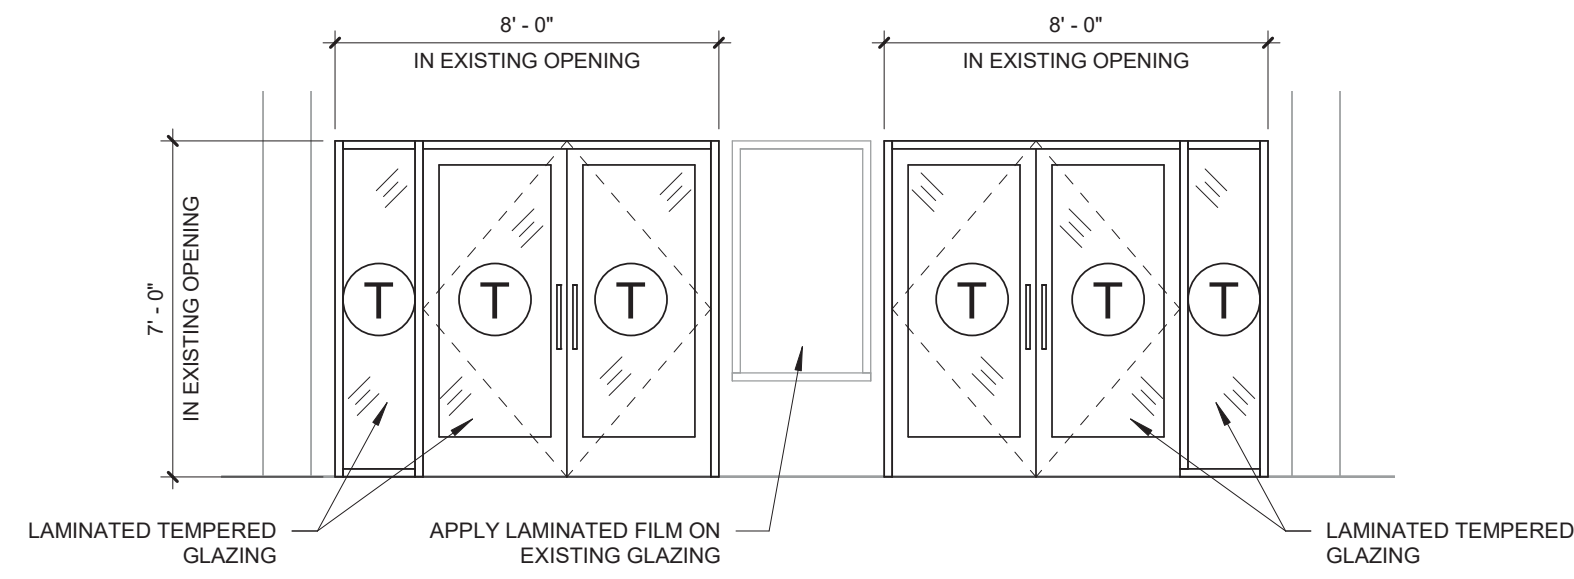


2 HS - SOUTH - VESTIBULE - S
1/4" = 1'-0"

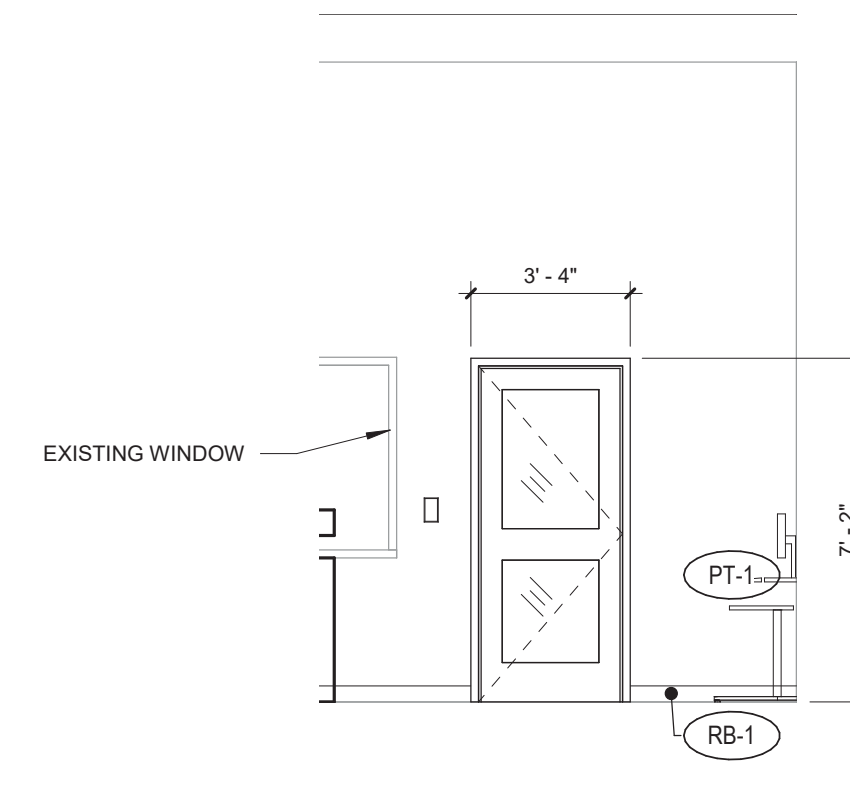


3 HS - SOUTH - MAIN OFFICE - S
1/4" = 1'-0"

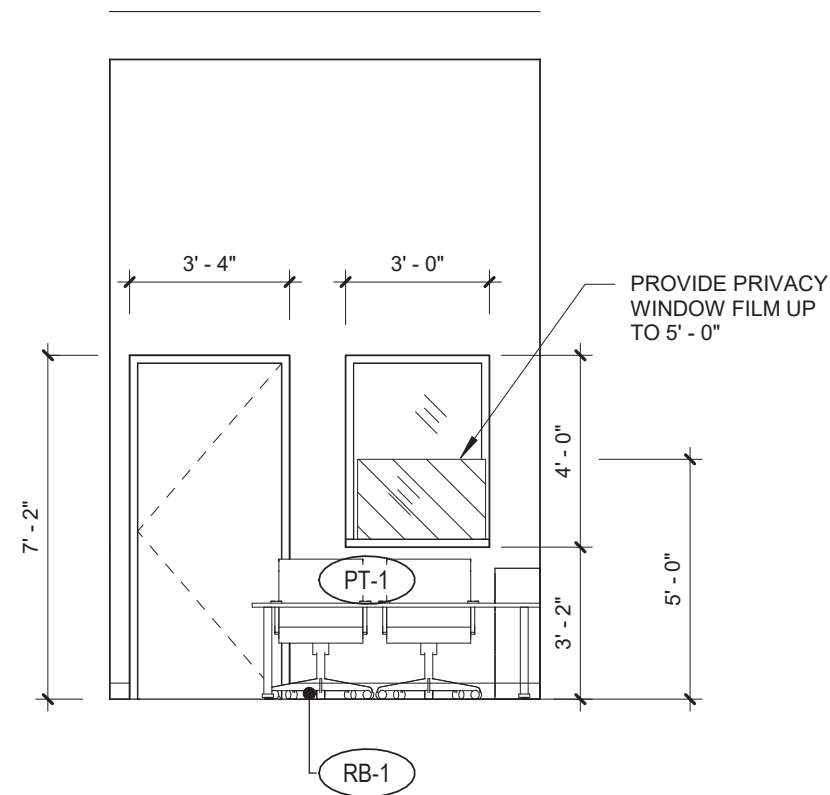


4 HS - SOUTH - OFFICE - S
1/4" = 1'-0"

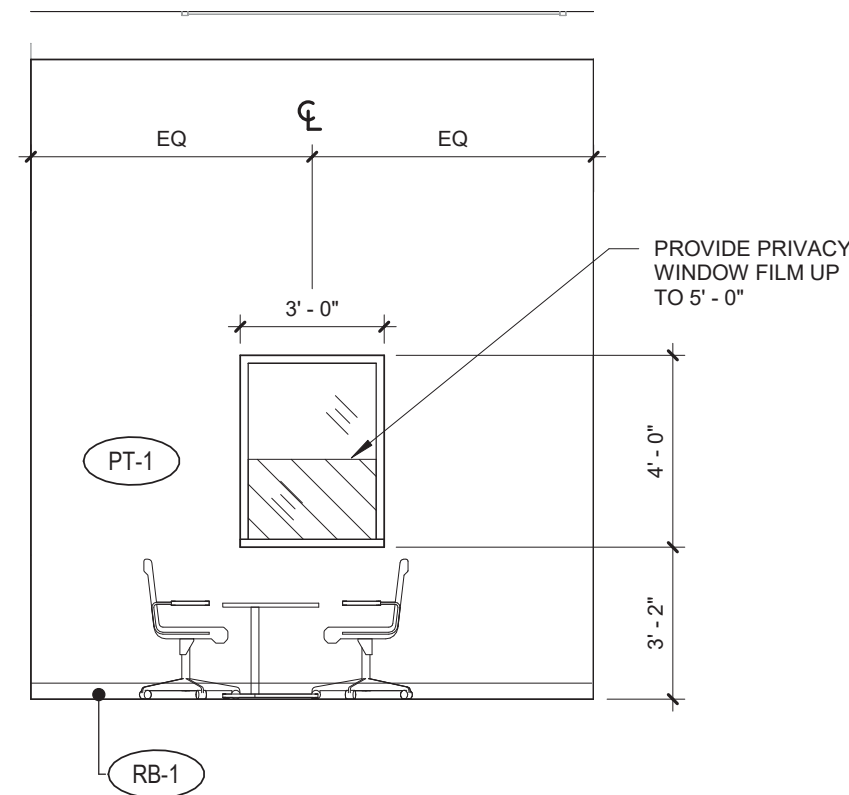


5 HS - SOUTH - OFFICE - W
1/4" = 1'-0"

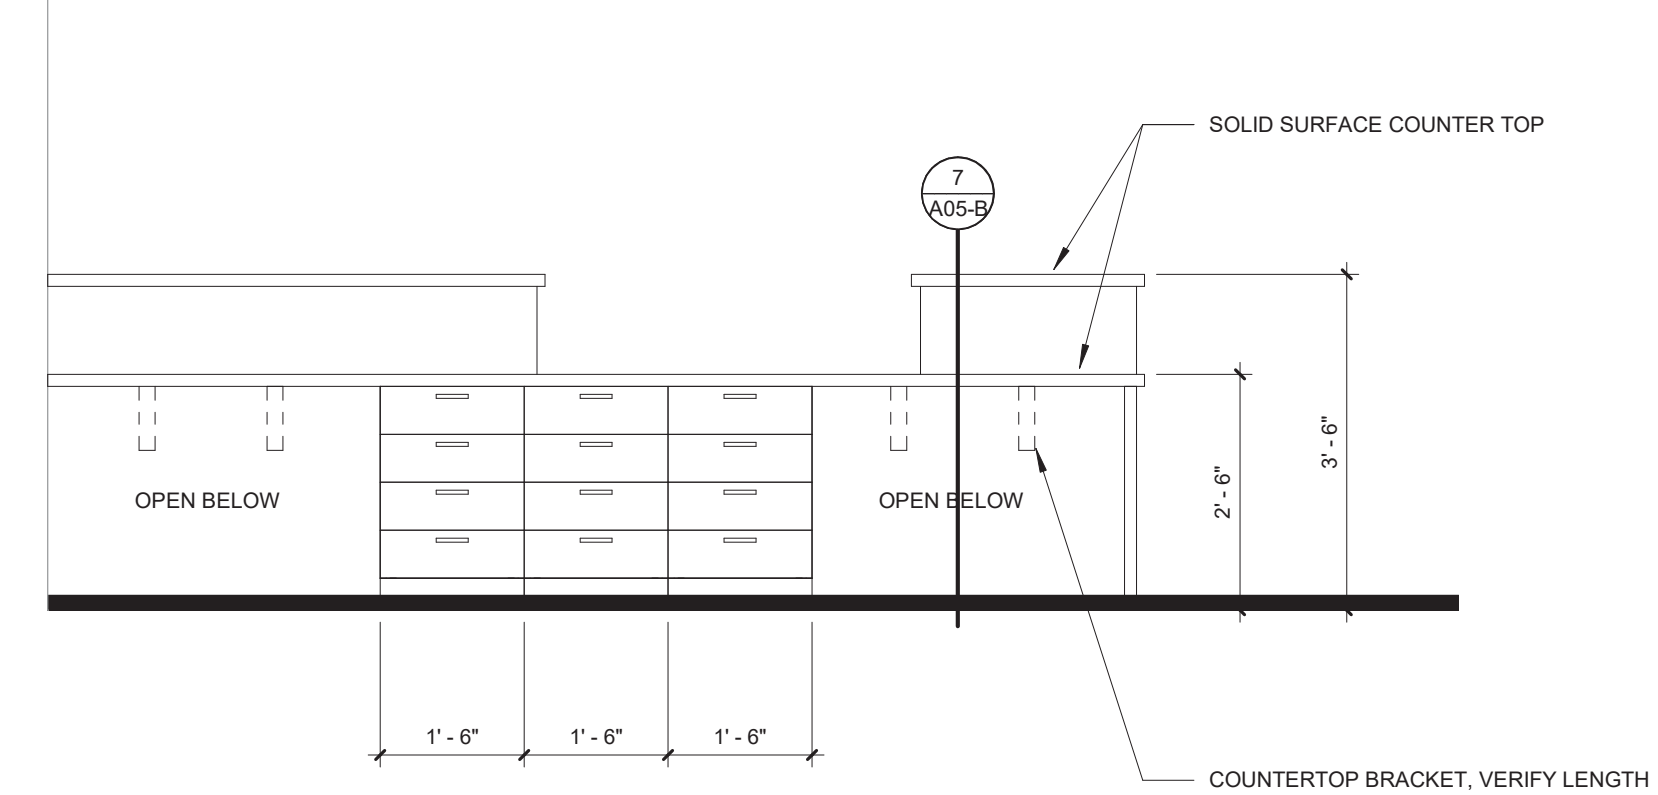


6 CASEWORK
1/2" = 1'-0"

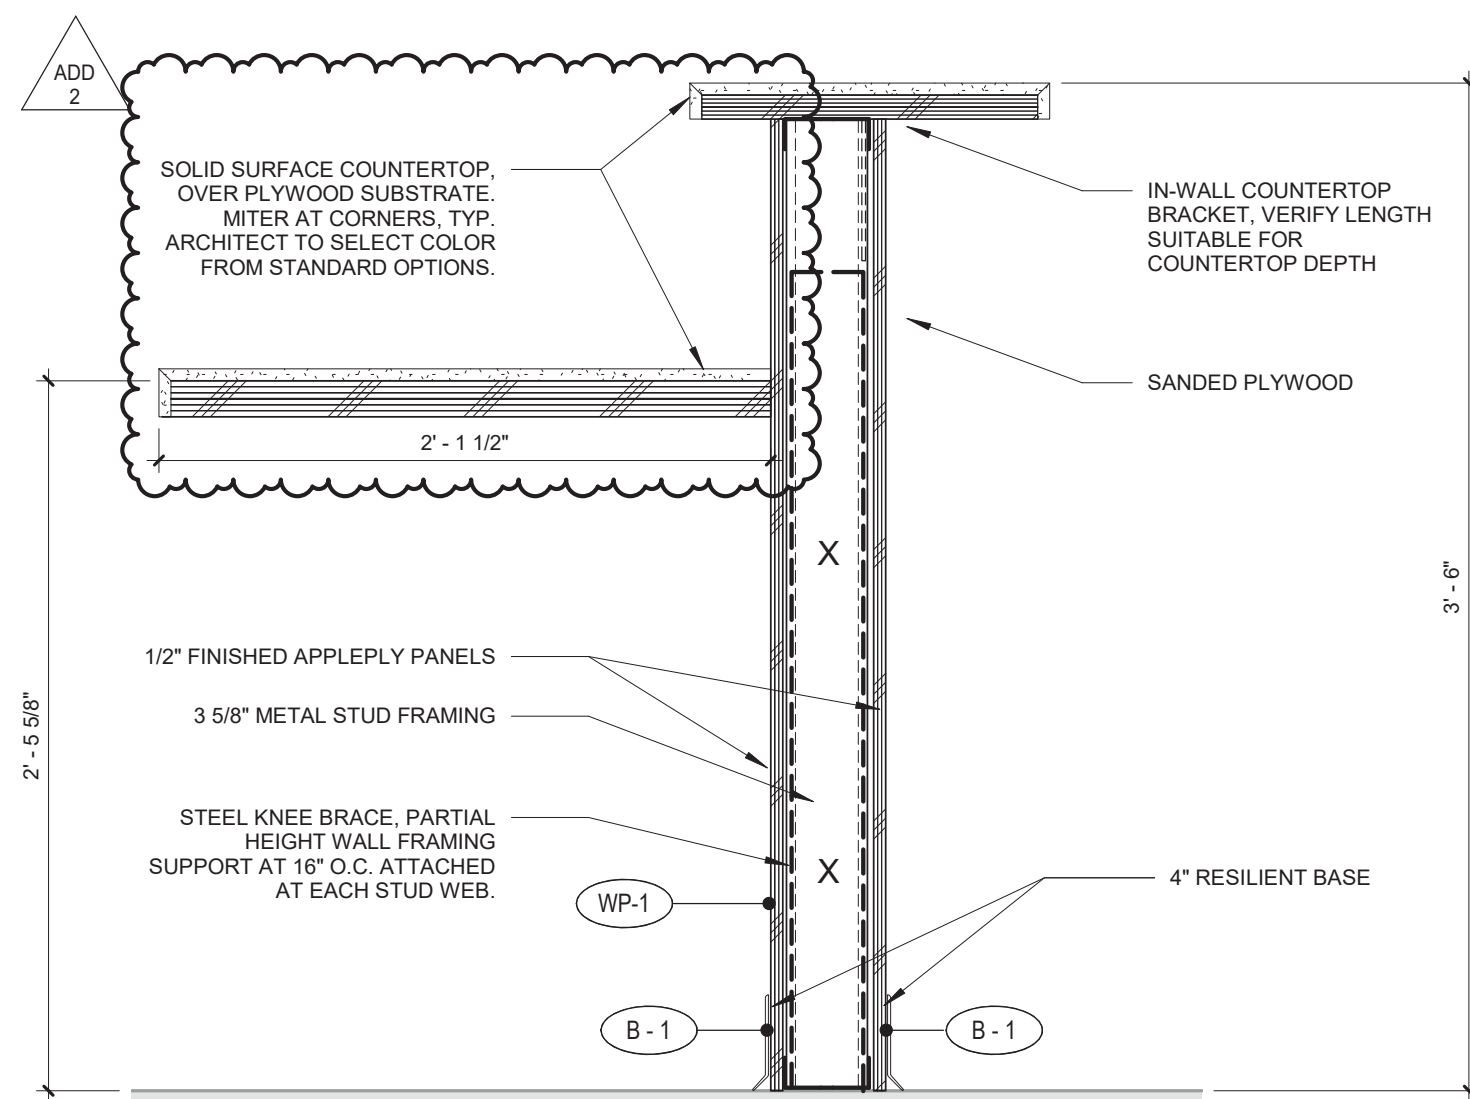


7 CASEWORK
1 1/2" = 1'-0"

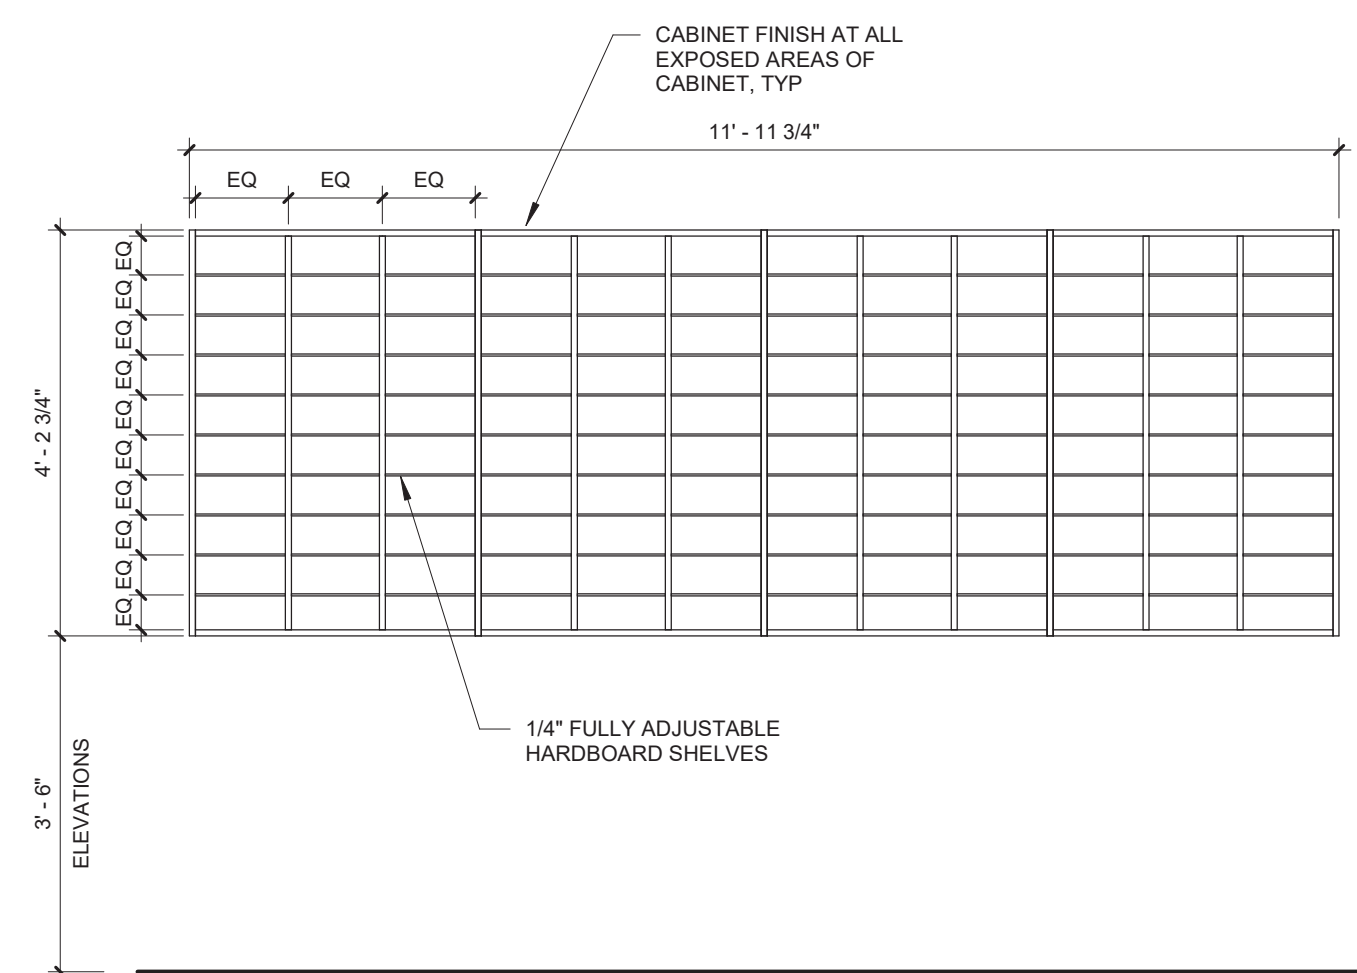

UPPER CABINET
UPPER CABINET WITH MAILBOX SLOTS

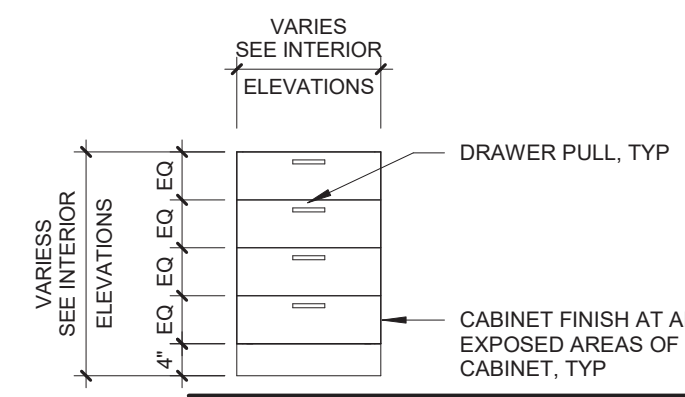

BASE CABINET
BASE CABINET WITH 4 EQUAL SIZED DRAWERS

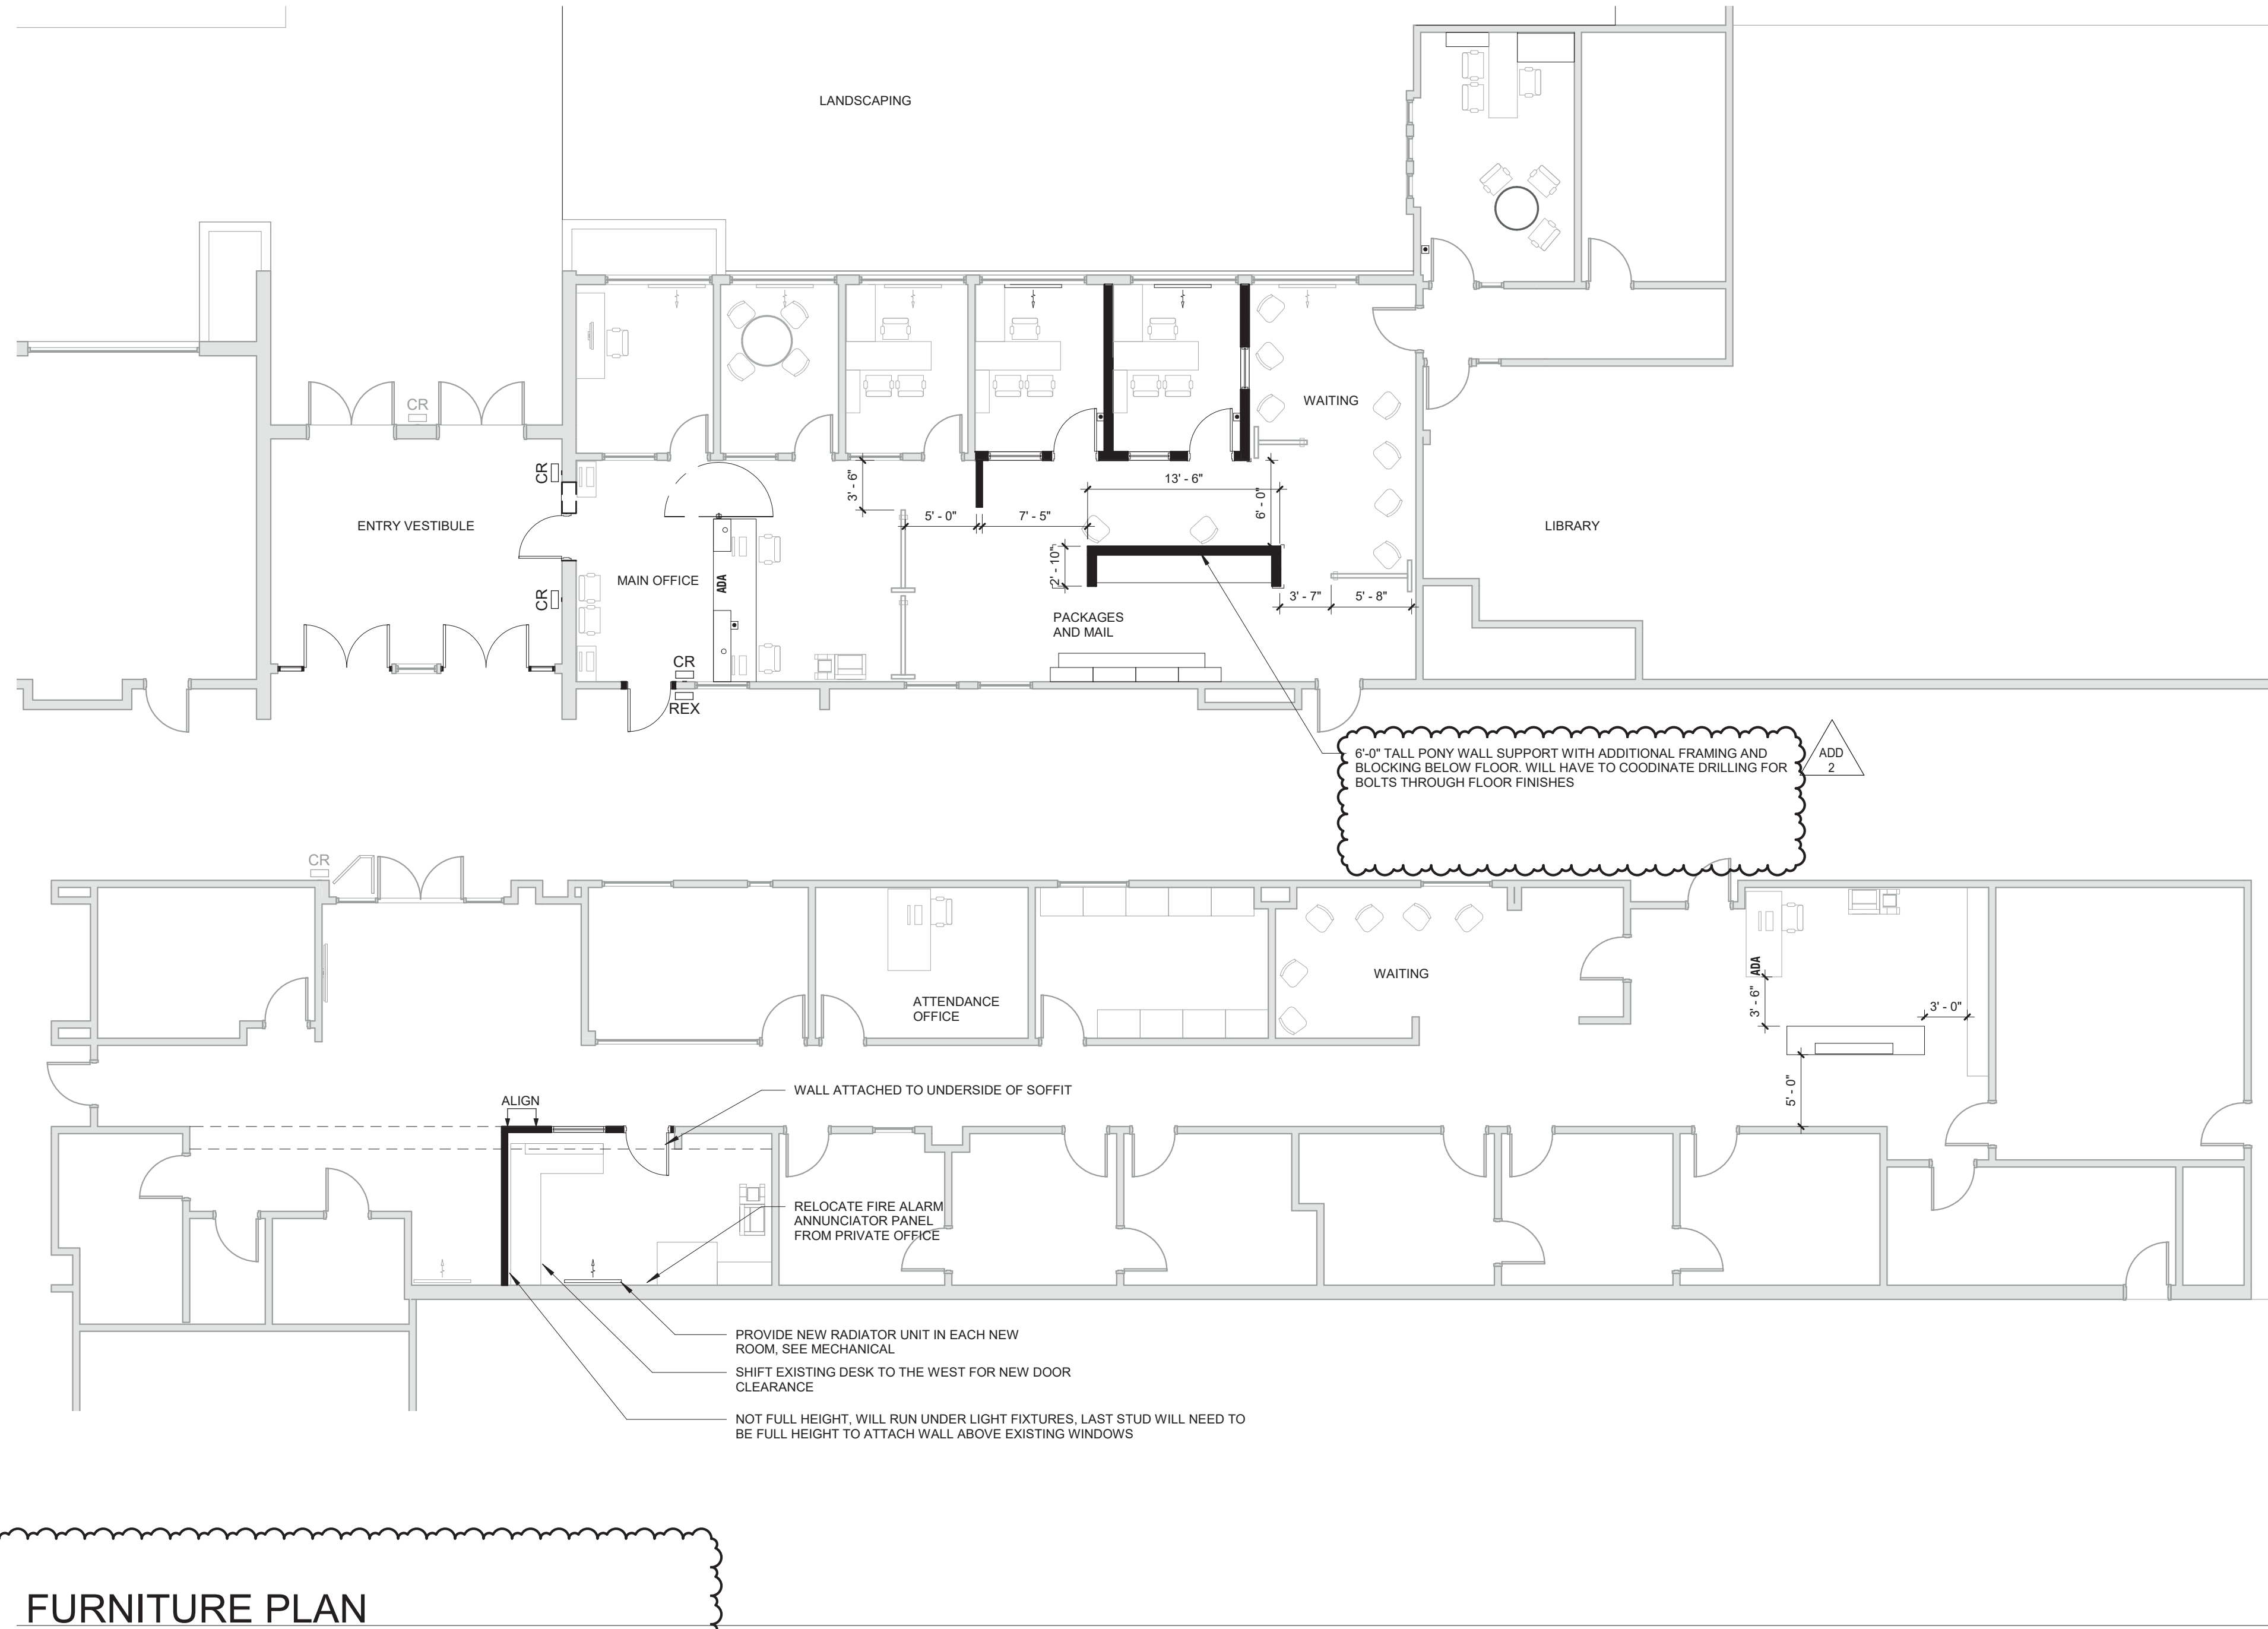

ADD 2

1 FURNITURE PLAN
1/8" = 1'-0"

REVISIONS:

#	DESCRP.	DATE
1	ADD 2	04/04/23

GENERAL NOTES - DEMOLITION

- A. PROTECT ALL EXISTING CONSTRUCTION TO REMAIN.
- B. COORDINATE WITH OWNER FOR REMOVAL AND STORAGE OF (E) EQUIPMENT AND CASEWORK TO BE SALVAGED.
- C. REMOVE EXISTING DOOR WALL STOPS WHERE DOORS NO LONGER EXIST.
- D. PROTECT (E) FLOORS, WALLS, CEILINGS & FINISHES TO REMAIN.
- E. REMOVE AND STORE MATERIAL AND EQUIPMENT WHERE INDICATED TO BE SALVAGED OR RELOCATED.
- F. WHEN REMOVING FLOOR FINISHES REMOVE ALL ADHESIVE, GROUT, RESIDUE AND DEBRIS.
- G. COORDINATE WITH ELECTRICAL FOR ITEMS TO BE DEMOLISHED, REMOVED, AND/OR SALVAGED.
- H. COORDINATE WITH MECHANICAL/PLUMBING FOR ITEMS TO BE DEMOLISHED, AND/OR SALVAGED.
- I. COORDINATE WITH OWNERS MODULAR SYSTEMS FURNITURE CONTRACTOR FOR CHANGES TO FURNITURE AND SYSTEM CASEWORK.
- J. COORDINATE WITH OWNER FOR ANY CEILING/FLOORING DISRUPTION REGARDING ACM.




GENERAL NOTES - FLOOR PLANS


- A. DIMENSIONS SHOWN ARE TO THE FACE OF STUD, CONCRETE OR MASONRY UNLESS OTHERWISE NOTED. CONTACT THE ARCHITECT FOR ANY ADDITIONAL DIMENSIONS REQUIRED TO LAY OUT THE WORK.
- B. MASONRY DIMENSIONS ARE THE ACTUAL MASONRY UNIT SIZES UNLESS OTHERWISE NOTED.
- C. REPAIR PATCHED SURFACES THAT ARE DAMAGED, LIFTED, DISCOLORED, OR SHOWING OTHER IMPERFECTIONS DUE TO PATCHING WORK. IF DEFECTS ARE DUE TO CONDITION OF SUBSTRATE, REPAIR SUBSTRATE PRIOR TO REPAIRING FINISH.
- D. WHERE (E) FLOOR IS TO REMAIN, PROTECT FROM DAMAGE. PATCH AND REPAIR ANY HOLES IN CONCRETE SLAB CAUSED BY DEMOLITION OF EXISTING WALLS, (I.E. WALL ANCHORS).
- E. PATCH AND REPAIR ANY WALL AND CEILING LOCATIONS WHERE EXISTING ELECTRICAL AND VOICEDATA OUTLET, JUNCTION BOXES, AND SIMILAR WALL MOUNTED ITEMS ARE REMOVED OR ABANDONED WITHIN THE WORK AREA.
- F. PATCH AND REPAIR WALL AND CEILING SURFACES WHERE MODULAR SYSTEMS FURNITURE WAS REMOVED BY SEPARATE CONTRACTOR.
- G. PATCH AND REPAIR ANY WALL LOCATIONS WHERE EXISTING WALL COVERING HAS BEEN REMOVED WITHIN THE WORK AREA.
- H. PATCH AND REPAIR ANY WALL LOCATIONS WHERE EXISTING WALL BASE HAS BEEN REMOVED WITHIN THE WORK AREA.
- I. PATCH AND REPAIR ANY WALL LOCATIONS WHERE EXISTING EQUIPMENT, ACCESSORIES, HARDWARE OR OTHER SURFACE MOUNTED ELEMENTS HAVE BEEN REMOVED WITHIN THE WORK AREA.
- J. VERIFY LOCATION OF PROX-CARD READERS, AUTOMATIC DOOR OPENERS AND WIRELESS ACTUATORS WITH ARCHITECT DURING ROUGH-IN PHASE OF THE WORK.
- K. COORDINATE WITH OWNER FOR ANY CEILING/FLOORING DISRUPTION REGARDING ACM.

DOOR SCHEDULE - CH								
MARK	WIDTH	HEIGHT	DOOR PANEL		DOOR FRAME		HARDWARE GROUP	COMMENTS
			TYPE	FINISH	TYPE	FINISH		
CH1	3' - 10"	3' - 6"	ALUM	PER MANUFACTURER	ALUM	PER MANUFACTURER	PER MANUFACTURER	HALF HEIGHT ALUMINUM TRAFFIC DOOR - VERIFY OPENING IN FIELD
CH2	3' - 6"	3' - 0"	ARCH TO SELECT FROM STANDARD OPTIONS	PER MANUFACTURER	ARCH TO SELECT FROM STANDARD OPTIONS	PER MANUFACTURER	PER MANUFACTURER	HALF HEIGHT DOUBLE SWINGING DOOR

ADD 2

DEMOLITION LEGEND

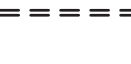-  (E) WALL TO REMAIN
-  WALL TO BE DEMOLISHED
-  DOOR AND FRAME TO BE DEMOLISHED

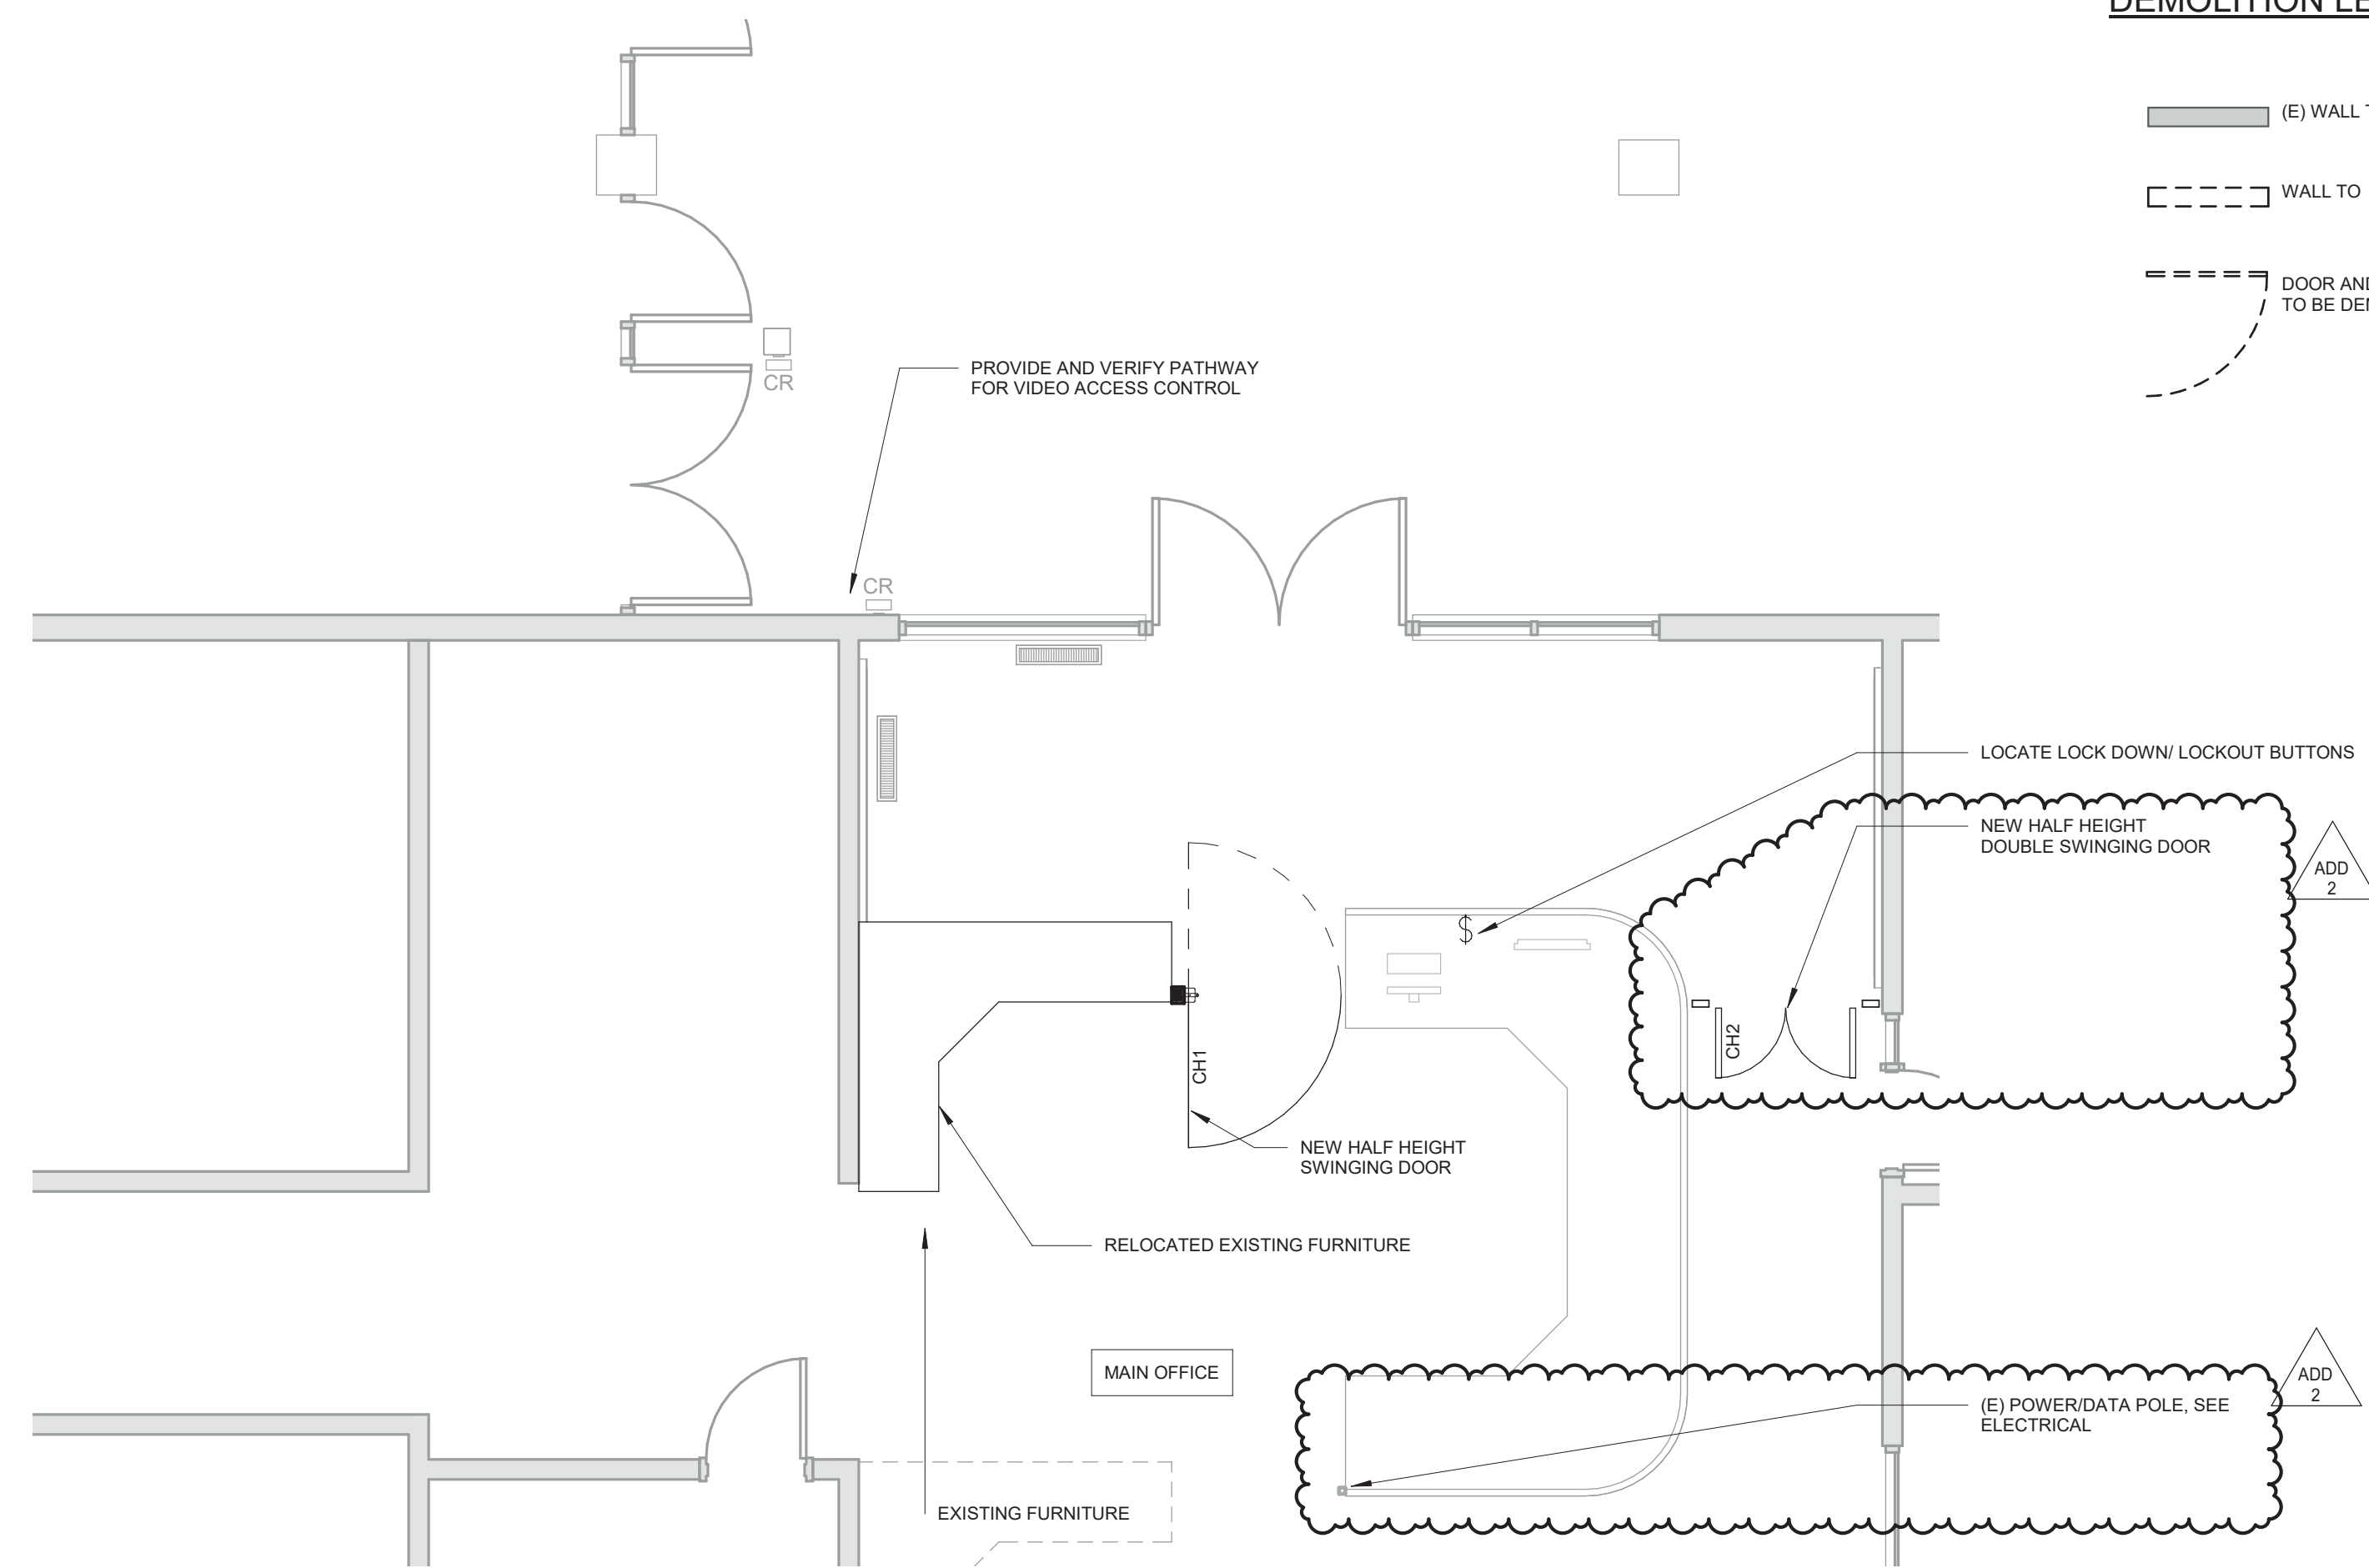

2 FLOOR PLAN - NEW CONSTRUCTION
1/4" = 1'-0"



REVISIONS:		
#	DESCRP.	DATE
1	ADD 2	04/04/23