2022 OREGO
2021 OREGO
2021 OREGO
2019 OREGO
2021 OREG0
2011 OREGO
2019 OREGO
2018 NFPA 1
2016 NFPA 1
ICC 117.1-20

LOCA ROOF, BUILDIN ROOF, 3 CANO PAVING: TOTAL:

COMMERCIAL DRINKING FO FLOOR DRAIN FLOOR SINK JANITORY SI SHOWER URINAL WATER CLOS

PARKING: EXISTING ENTRANCE: EXISTING TELEPHONES: DRINKING FOUNTAINS: STORAGE:

BUILDING CODE INFORMATION

OCCUPANCIES (CHAPTER 3): E – EDUCATIONAL

- X - X

4J SECURITY IMPROVEMENTS EUGENE SCHOOL DISTRICT 4J

SOUTH EUGENE HIGH SCHOOL

CONSTRUCTION DRAWING SET ADDITIONAL DRAWING SET INFO

03.15.2023 2207

PROJECT TEAM

<u>OWNER</u>

EUGENE SCHOOL DISTRICT 4J ADMINISTRATION: 715 WEST FOURTH AVENUE, EUGENE, OREGON 97402 FACILITIES: 200 NORTH MONROE ST, EUGENE OREGON 97402 ADMINISTRATION PHONE: (541) 790-7400 FACILITIES PHONE: (541) 790-7421 CONTACT: RYAN SPAIN, SPAIN_R@4J.LANE.EDU

ARCHITECT

PIVOT ARCHITECTURE PC 44 WEST BROADWAY, SUITE 300 EUGENE, OR 97401 PHONE: (541) 342-7291 CONTACT: JOHN STAPLETON, JSTAPLETON@PIVOTARCHITECTURE.COM

MECHANICAL ENGINEER

KCL ENGINEERS 296 E. 5TH AVE, SUITE 501 EUGENE, OR 97401 PHONE: (503) 212-4612 CONTACT: CHARLIE WHITE

ELECTRICAL ENGINEER

KCL ENGINEERS 296 E. 5TH AVE, SUITE 501 EUGENE, OR 97401 PHONE: (503) 212-4612 CONTACT: SHYLA KEAYS-GOODMAN

APPLICABLE CODE:

SON STRUCTURAL SPECIALTY CODE SON ELECTRICAL SPECIALTY CODE SON ZERO ENERGY READY COMMERCIAL CODE SON MECHANICAL SPECIALTY CODE ON PLUMBING SPECIALTY CODE ON ELEVATOR SPECIALTY CODE ON FIRE CODE 1.10

2009 ACCESSIBILITY CODE

SITE DATA SUMMARY

PROPOSED IMPERVIOUS SURFACE AREA

ATION:	GSF	
ING:	XX GSF	
IOPIES:	XX GSF	
	XX GSF	
	XX GSF	

LAND USE CODE INFORMATION

ADDRESS: 400 East 19th Avenue, Eugene, OR 97401

MAP & TAX LOT #: 18030522 - 06000

SDC INFORMATION - PLUMBING FIXTURE COUNT

REMOVED	ADDED	NET CHANGE
	REMOVED	REMOVED ADDED Image: State

ACCESSIBILITY FOR EXISTING BUILDINGS (3411)

PRIORITY OF IMPROVEMENTS PER ORS 447.241:

ROUTE TO ALTERED AREA: EXISTING

RESTROOMS: EXISTING

DEFERRED SUBMITTALS

-STOREFRONT SYSTEM

SPECIAL INSPECTIONS









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	TITLE: LE SHE	
REVIS	IONS: DESCRP.	DATE
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② 2023 PIVOT ARCHITECTURE




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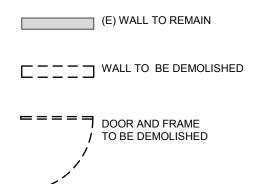


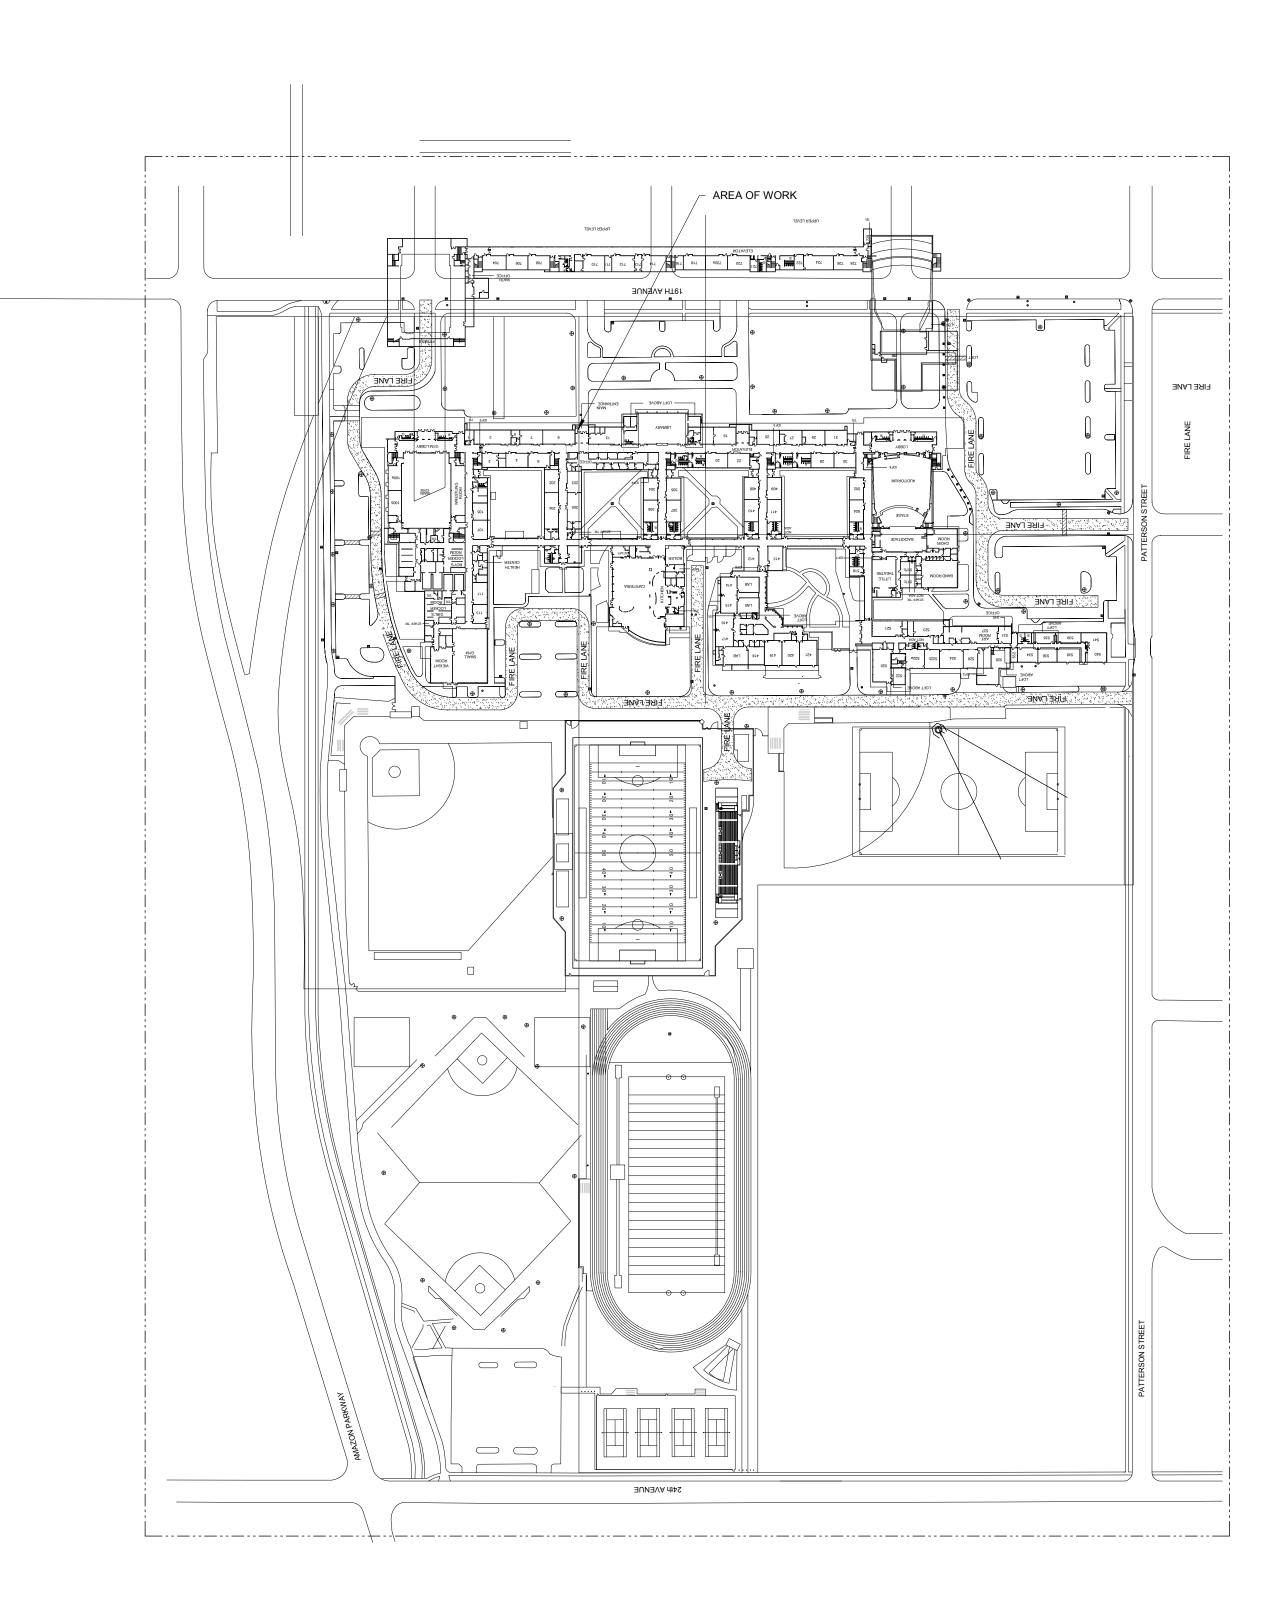

GENERAL NOTES - DEMOLITION

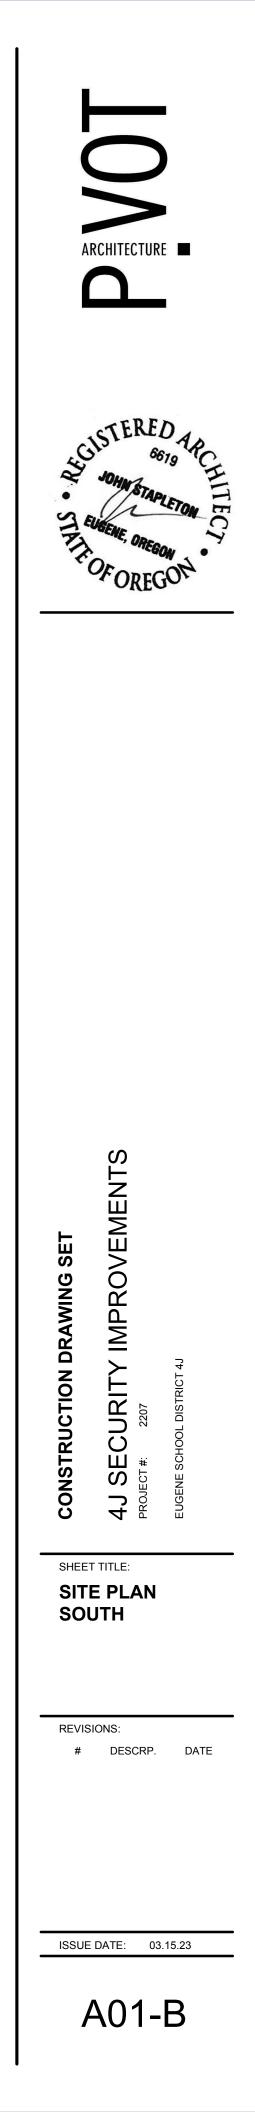- A. PROTECT ALL EXISTING CONSTRUCTION TO REMAIN.
 B. COORDINATE WITH OWNER FOR REMOVAL AND STORAGE OF (E) EQUIPMENT AND CASEWORK TO BE SALVAGED.
- REMOVE EXISTING DOOR WALL STOPS WHERE DOORS NO LONGER EXIST. C.
- PROTECT (E) FLOORS, WALLS, CEILINGS & FINISHES TO REMAIN. D. REMOVE AND STORE MATERIAL AND EQUIPMENT WHERE INDICATED TO BE SALVAGED Ε.
- OR RELOCATED. F. WHEN REMOVING FLOOR FINISHES REMOVE ALL ADHESIVE, GROUT, RESIDUE AND
- DEBRIS. G. COORDINATE WITH ELECTRICAL FOR ITEMS TO BE DEMOLISHED, REMOVED, AND/OR
- SALVAGED. H. COORDINATE WITH MECHANICAL/PLUMBING FOR ITEMS TO BE DEMOLISHED, AND/OR
- SALVAGED.
- I. COORDINATE WITH OWNERS MODULAR SYSTEMS FURNITURE CONTRACTOR FOR CHANGES TO FURNITURE AND SYSTEM CASEWORK.
 J. COORDINATE WITH OWNER FOR ANY CEILING/FLOORING DISRUPTION REGARDING ACM

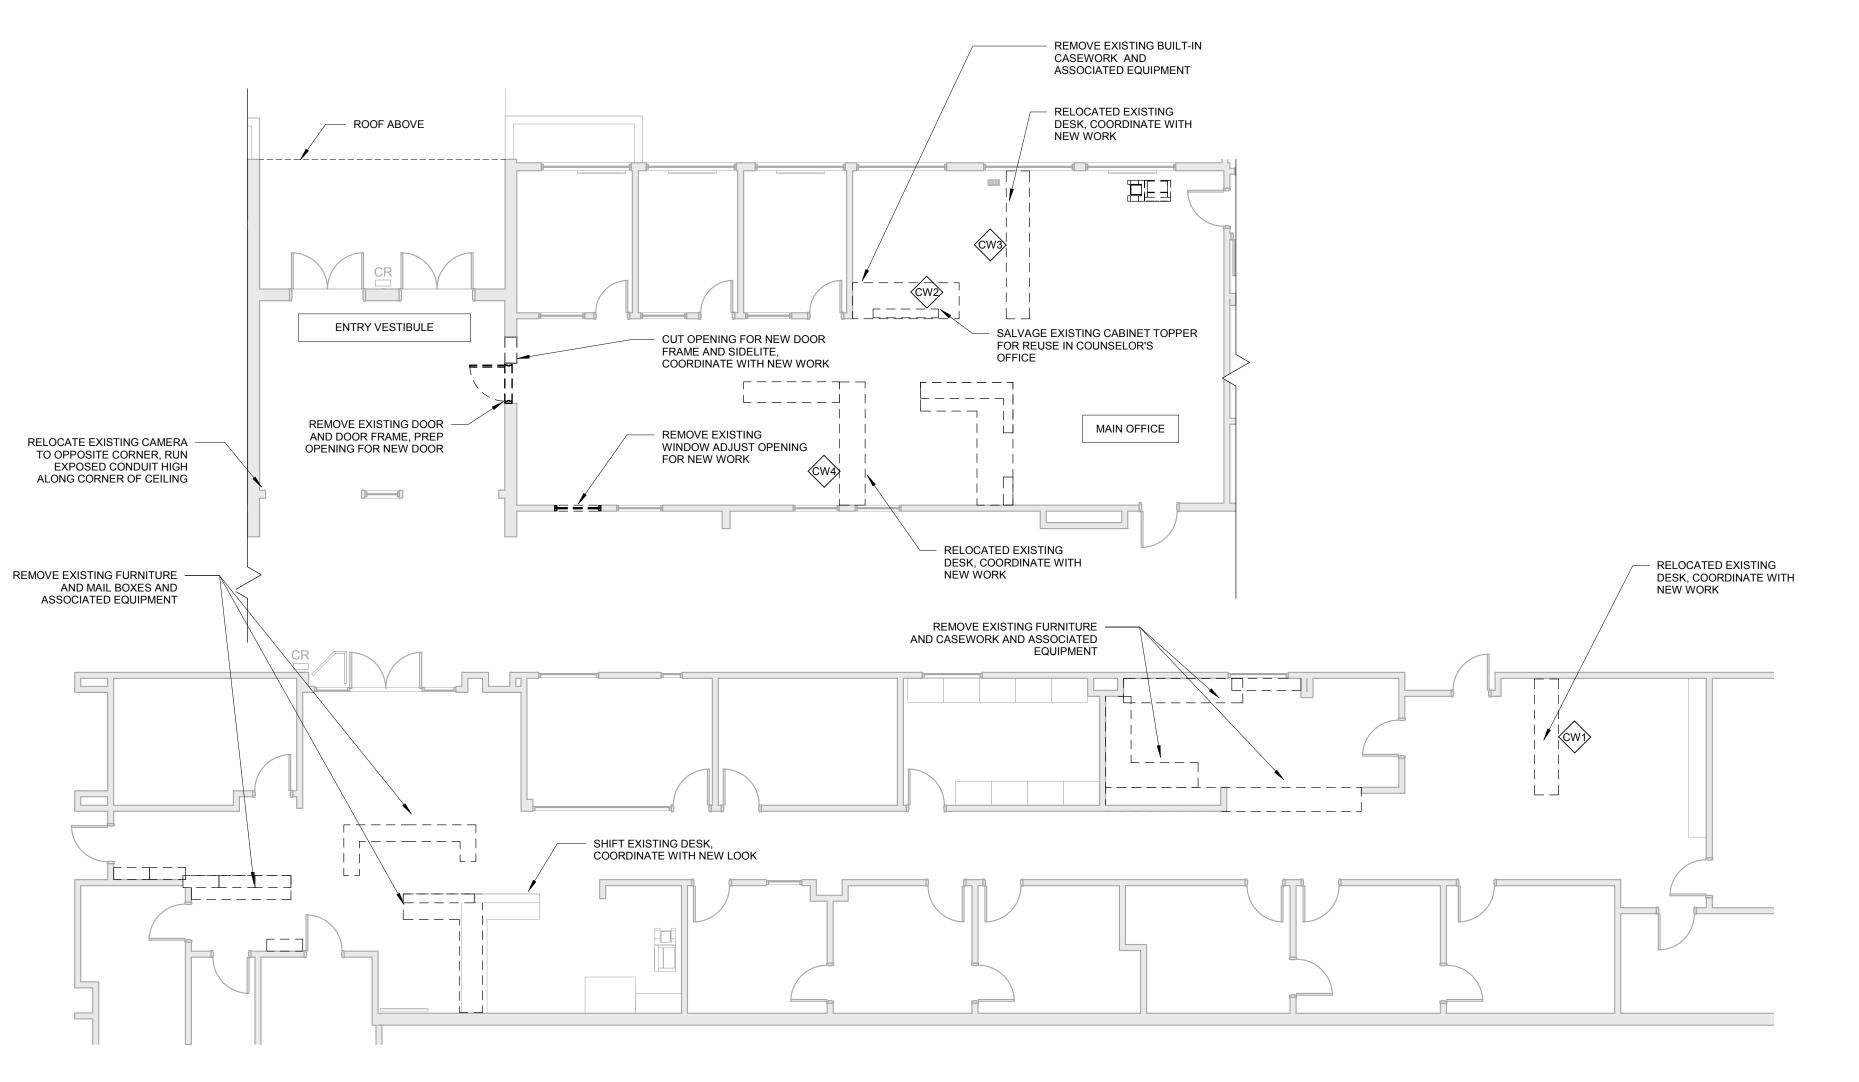
DEMOLITION LEGEND





CONSTRUCTION DRAWING SET	4J SECURITY IMPROVEMENTS PROJECT #: 2207	EUGENE SCHOOL DISTRICT 4J
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REVIS #	IONS: DESCRP.	DATE
	DATE: 03	



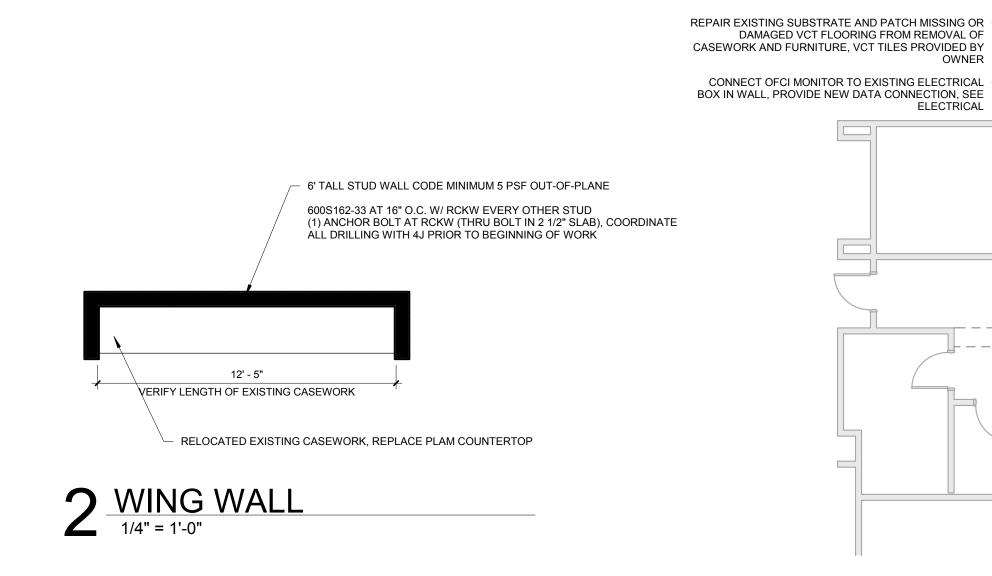

SO5


MARK

APPLY LAMINATED FILM ON EXISTING GLAZING, THIS ROOM TYPICAL

BOTH DOUBLE DOORS

REMOVABLE MULLION,

DOOR SCHEDULE - SO						
		DOOR PANEL		FRAME	HARDWARE	
WIDTH	HEIGHT	TYPE	TYPE	FINISH	GROUP	COMMENTS
6' - 0"	6' - 10"	ALUM	ALUM		01	
6' - 0"	6' - 10"	ALUM	ALUM		05	CONTROL ACCESS SEE HARDWARE SPECIFICATION
5' - 2"	7' - 0"	HM	НМ	PAINT	03	CONTROL ACCESS - CARD READER, REMOTE LOCK/ UNLOCK
3' - 0"	7' - 0"	HM	НМ		04	CONTROL ACCESS SEE HARDWARE SPECIFICATION
3' - 10"	3' - 6"	ALUM	ALUM	PER MANUFACTURER	PER MANUFACTURER	HALF HEIGHT ALUMINUM TRAFFIC DOOR - VERIFY OPENING IN FIELD
3' - 0"	7' - 0"	WOOD	НМ	PAINT	02	OFFICE LOCKSET
3' - 0"	7' - 0"	WOOD	НМ	PAINT	02	OFFICE LOCKSET

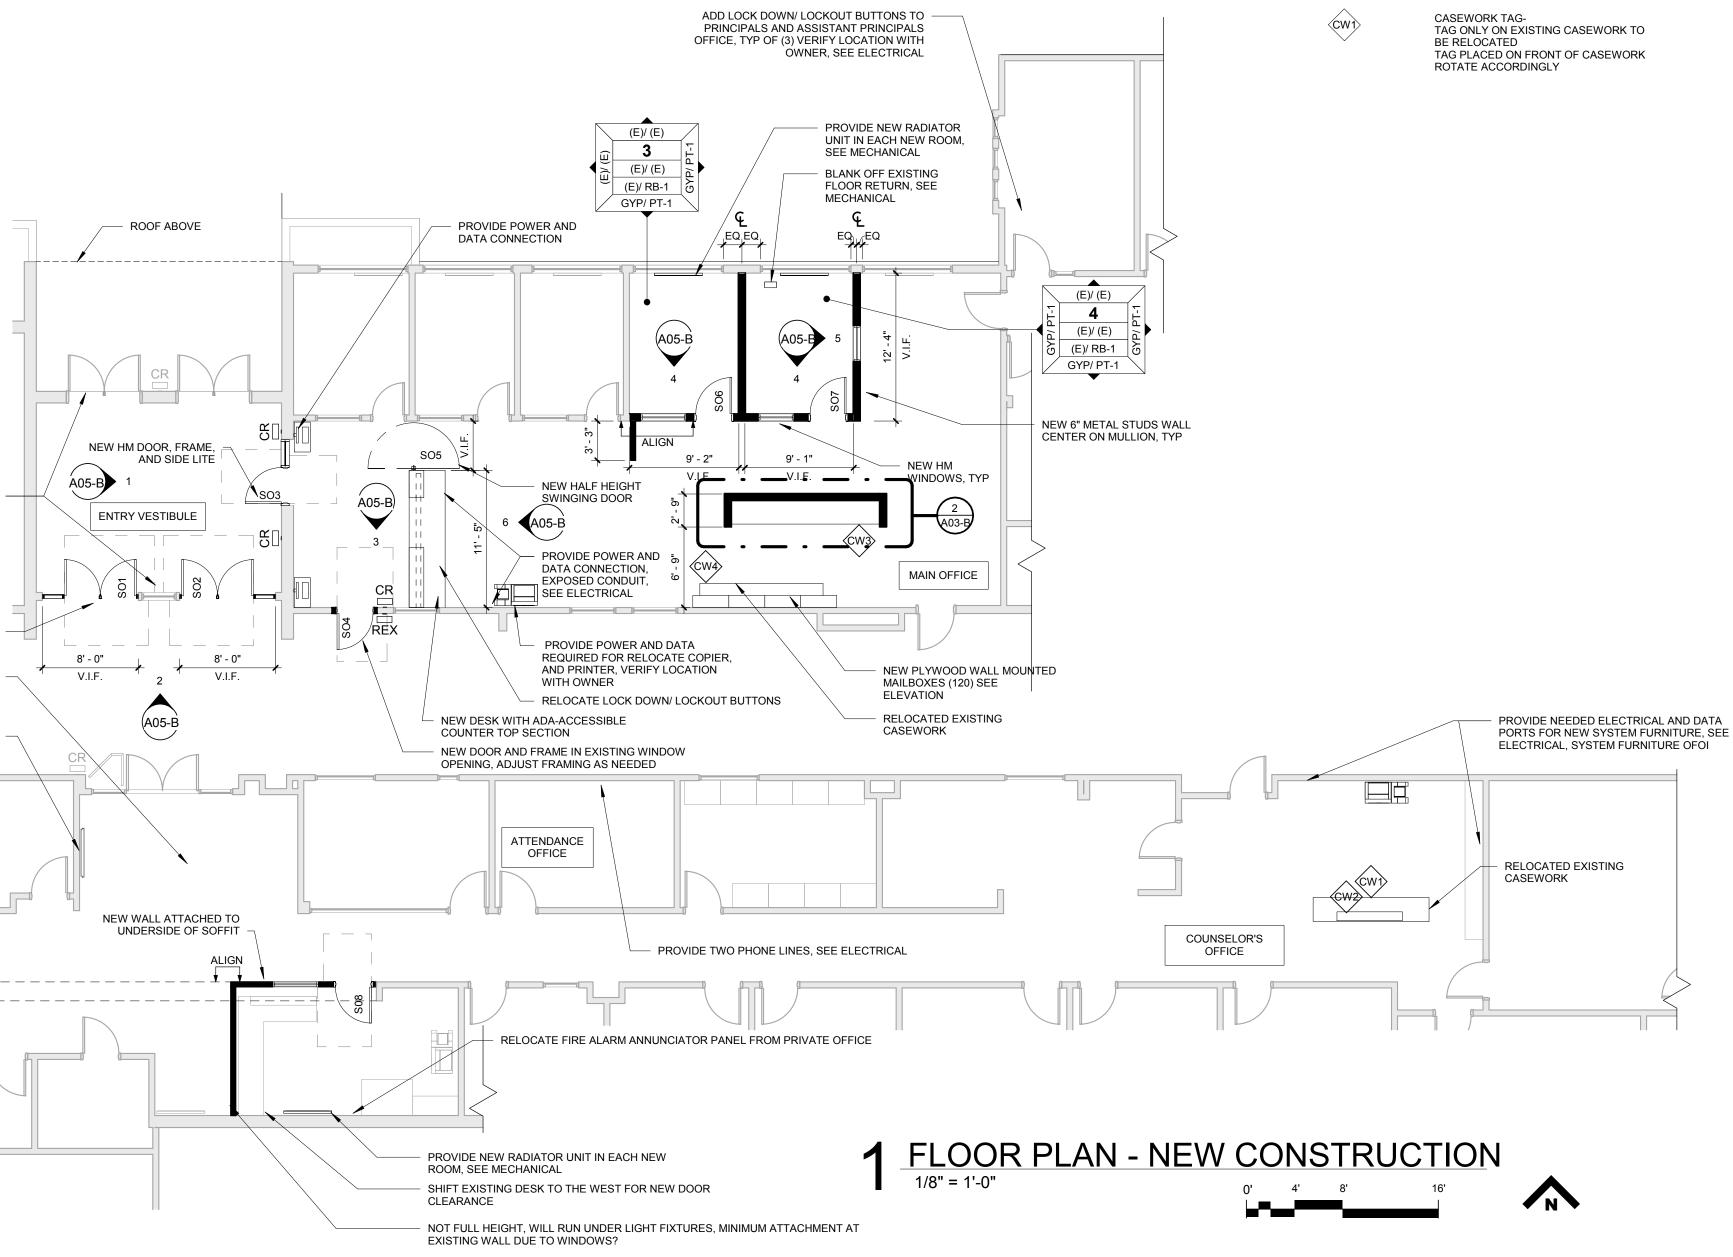

GENERAL NOTES - FLOOR PLANS

- A. DIMENSIONS SHOWN ARE TO THE FACE OF STUD, CONCRETE OR MASONRY UNLESS OTHERWISE NOTED. CONTACT THE ARCHITECT FOR ANY ADDITIONAL DIMENSIONS
- REQUIRED TO LAY OUT THE WORK. MASONRY DIMENSIONS ARE THE ACTUAL MASONRY UNIT SIZES UNLESS OTHERWISE В.
- NOTED C. REFER TO WALL ASSEMBLY INFORMATION FOR WALL CONSTRUCTION AND
- THICKNESS. D. REPAIR PATCHED SURFACES THAT ARE DAMAGED, LIFTED, DISCOLORED, OR SHOWING OTHER IMPERFECTIONS DUE TO PATCHING WORK. IF DEFECTS ARE DUE TO
- CONDITION OF SUBSTRATE, REPAIR SUBSTRATE PRIOR TO REPAIRING FINISH. E. WHERE (E) FLOOR IS TO REMAIN, PROTECT FROM DAMAGE. PATCH AND REPAIR ANY HOLES IN CONCRETE SLAB CAUSED BY DEMOLITION OF EXISTING WALLS, (I.E. WALL ANCHORS).
- F. PATCH AND REPAIR ANY WALL AND CEILING LOCATIONS WHERE EXISTING ELECTRICAL AND VOICE/DATA OUTLET, JUNCTION BOXES, AND SIMILAR WALL MOUNTED ITEMS ARE REMOVED OR ABANDONED WITHIN THE WORK AREA.
- G. PATCH AND REPAIR WALL AND CEILING SURFACES WHERE MODULAR SYSTEMS FURNITURE WAS REMOVED BY SEPARATE CONTRACTOR.
- H. PATCH AND REPAIR ANY WALL LOCATIONS WHERE EXISTING WALL COVERING HAS BEEN REMOVED WITHIN THE WORK AREA.
- PATCH AND REPAIR ANY WALL LOCATIONS WHERE EXISTING WALL BASE HAS BEEN Ι. REMOVED WITHIN THE WORK AREA. J. PATCH AND REPAIR ANY WALL LOCATIONS WHERE EXISTING EQUIPMENT,
- ACCESSORIES, HARDWARE OR OTHER SURFACE MOUNTED ELEMENTS HAVE BEEN REMOVED WITHIN THE WORK AREA K. VERIFY LOCATION OF PROX-CARD READERS, AUTOMATIC DOOR OPENERS AND
- WIRELESS ACTUATORS WITH ARCHITECT DURING ROUGH-IN PHASE OF THE WORK. COORDINATE WITH OWNER FOR ANY CEILING/FLOORING DISRUPTION REGARDING L. ACM

WALL FILL PATTERNS:

CR	
REX]
CW1	

REQUEST TO EXIT
CASEWORK TAG- TAG ONLY ON EXISTING CASEWORK TO BE RELOCATED TAG PLACED ON FRONT OF CASEWORK ROTATE ACCORDINGLY









EXISTING WALL ASSEMBLY

NON FIRE-RATED WALL ASSEMBLY

CARD READER

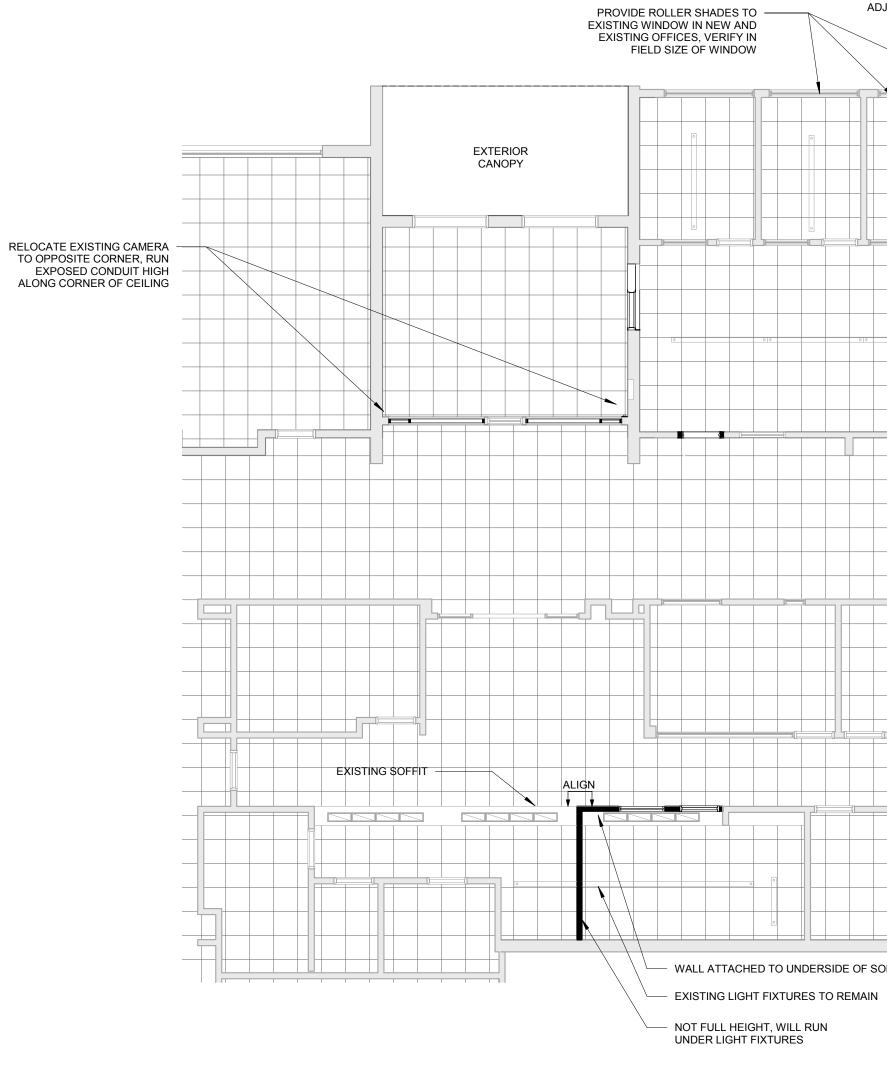


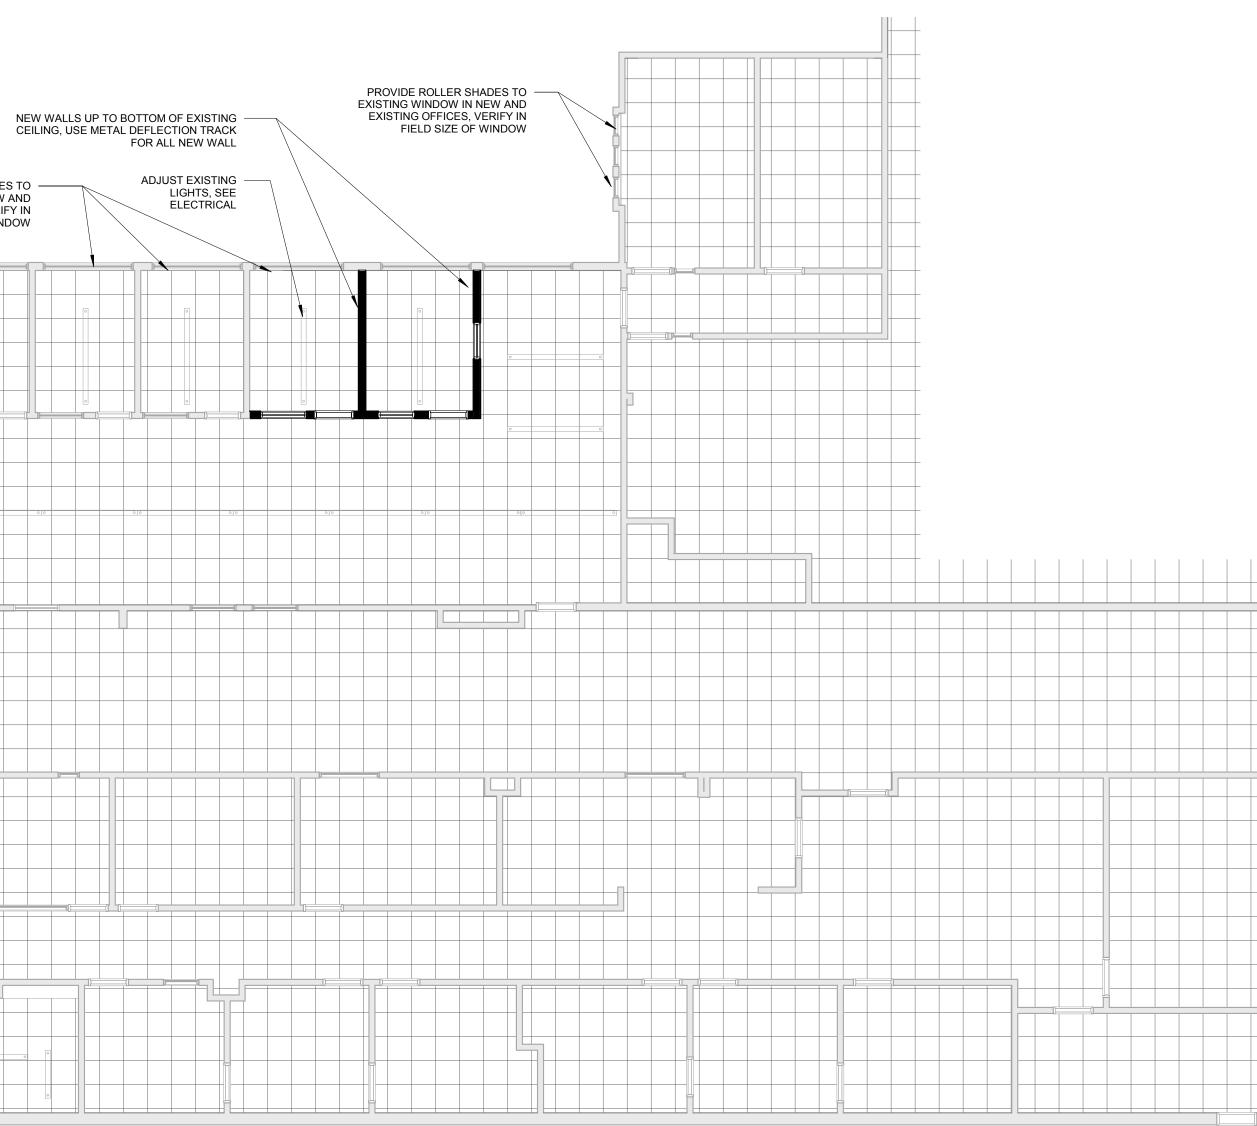


WALL ATTACHED TO UNDERSIDE OF SOFFIT

1 <u>REFLECTED CEILING PLANS</u>


ARCHITECTURE
SISTERED AR SOMN STAPLETON FE EUSENE, OREGON OF OREGON
CONSTRUCTION DRAWING SET 4.J SECURITY IMPROVEMENTS PROJECT #. 2207 EUGENE SCHOOL DISTRICT 4.J
SHEET TITLE: SOUTH - REFLECTED CEILING PLANS
REVISIONS: # DESCRP. DATE ISSUE DATE: 03.15.23
A04-B

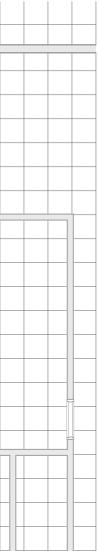



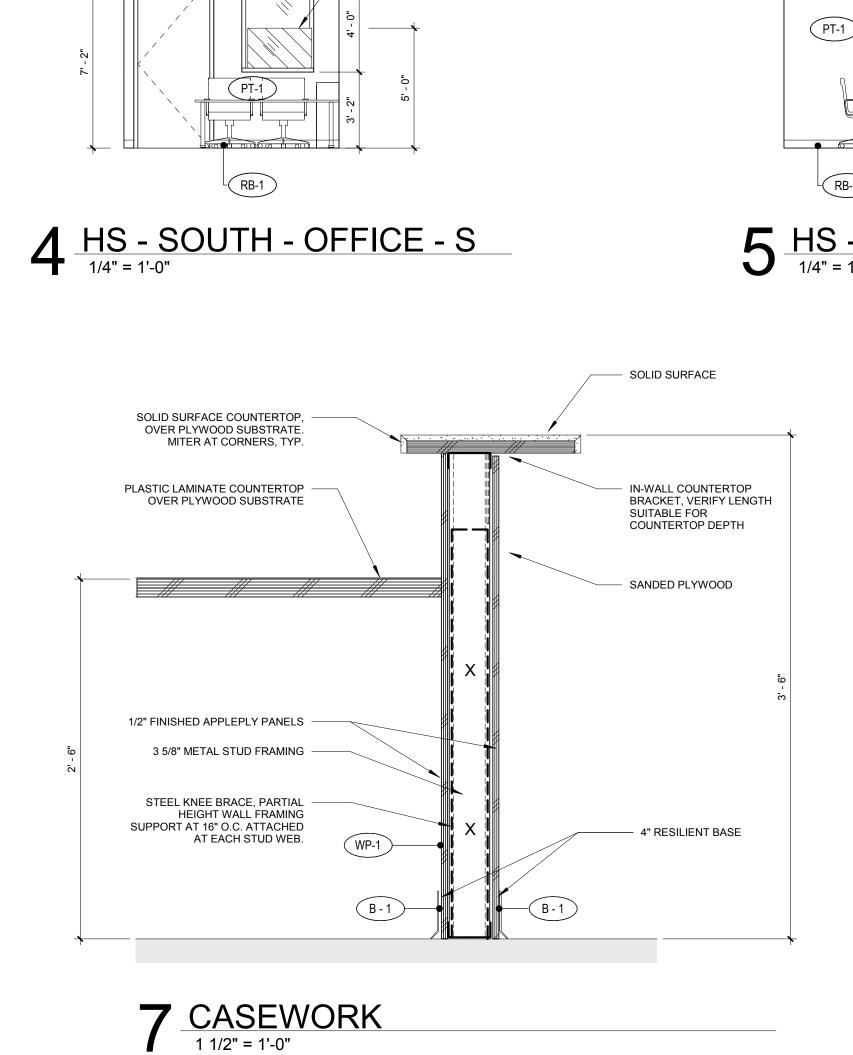



PROVIDE PRIVACY
 WINDOW FILM UP
 TO 5' - 0"

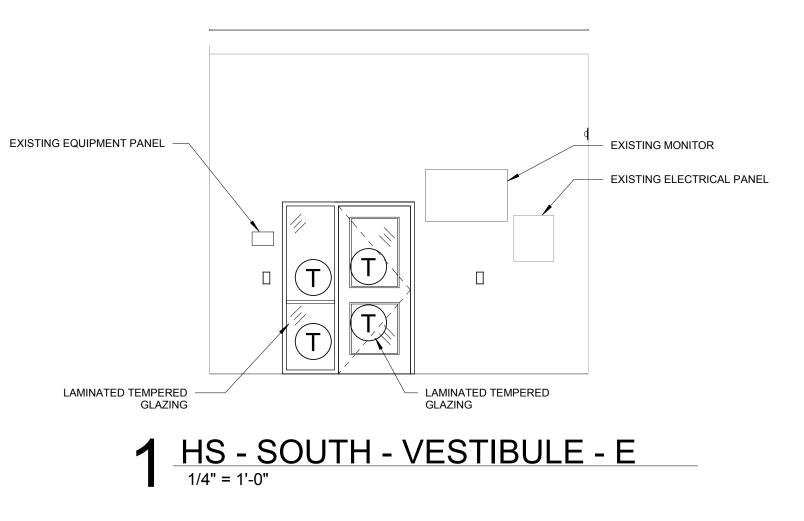


3' - 4"

3' - 0"

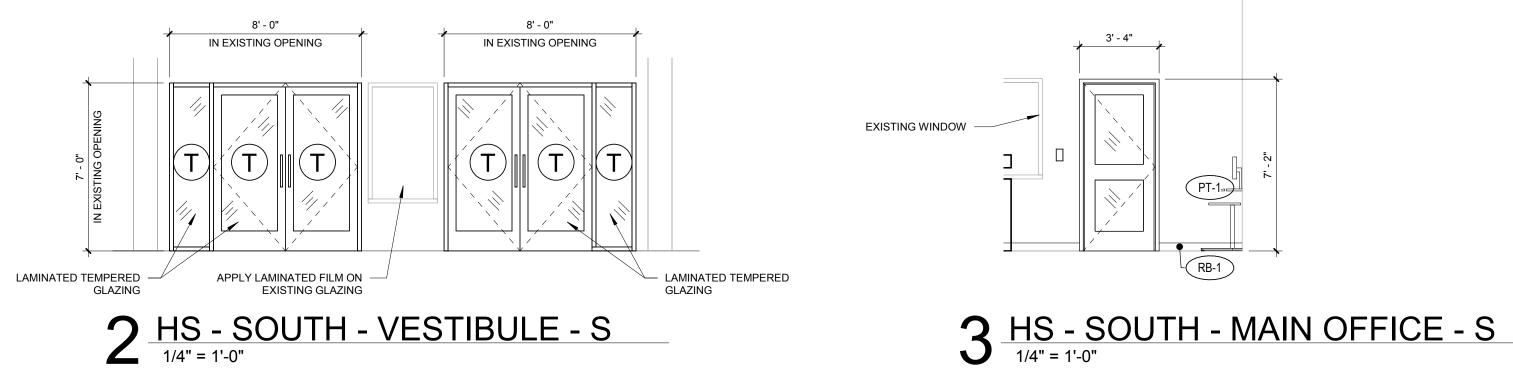


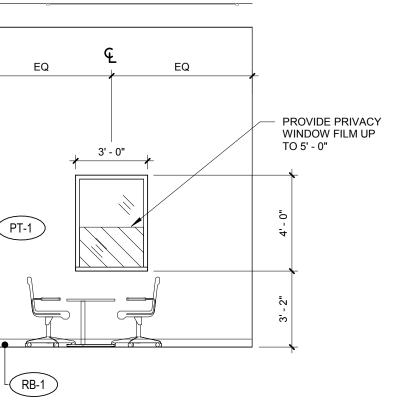

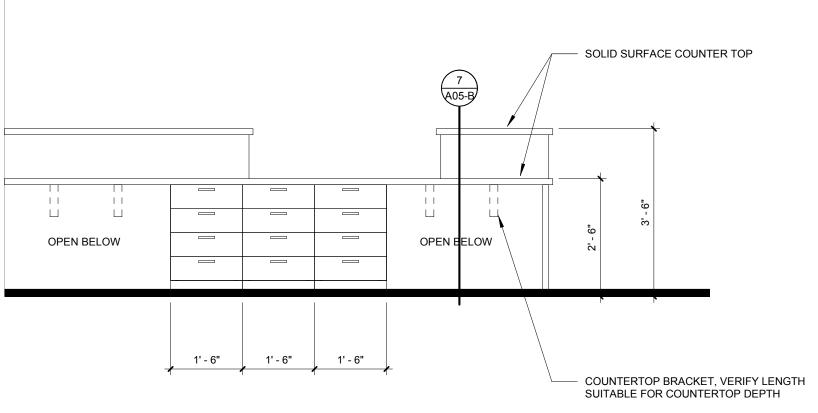


5 <u>HS - SOUTH - OFFICE - W</u> 1/4" = 1'-0"



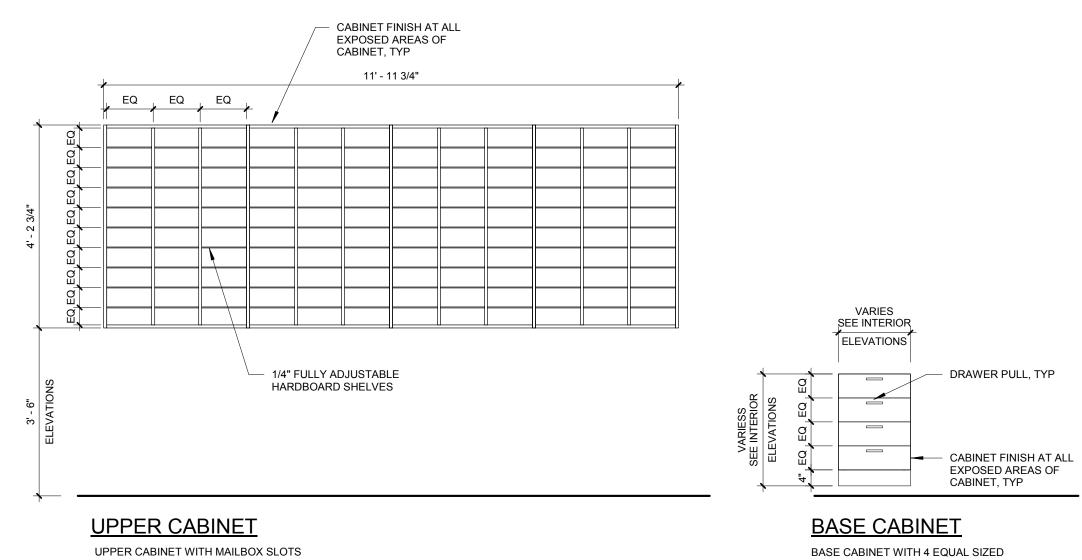


DRAWERS

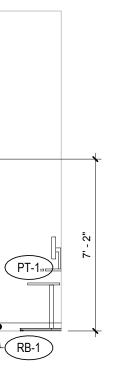




CONSTRUCTION DRAWING SET	4J SECURITY IMPROVEMENTS PROJECT #: 2207	EUGENE SCHOOL DISTRICT 4J
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LANDSCAPING

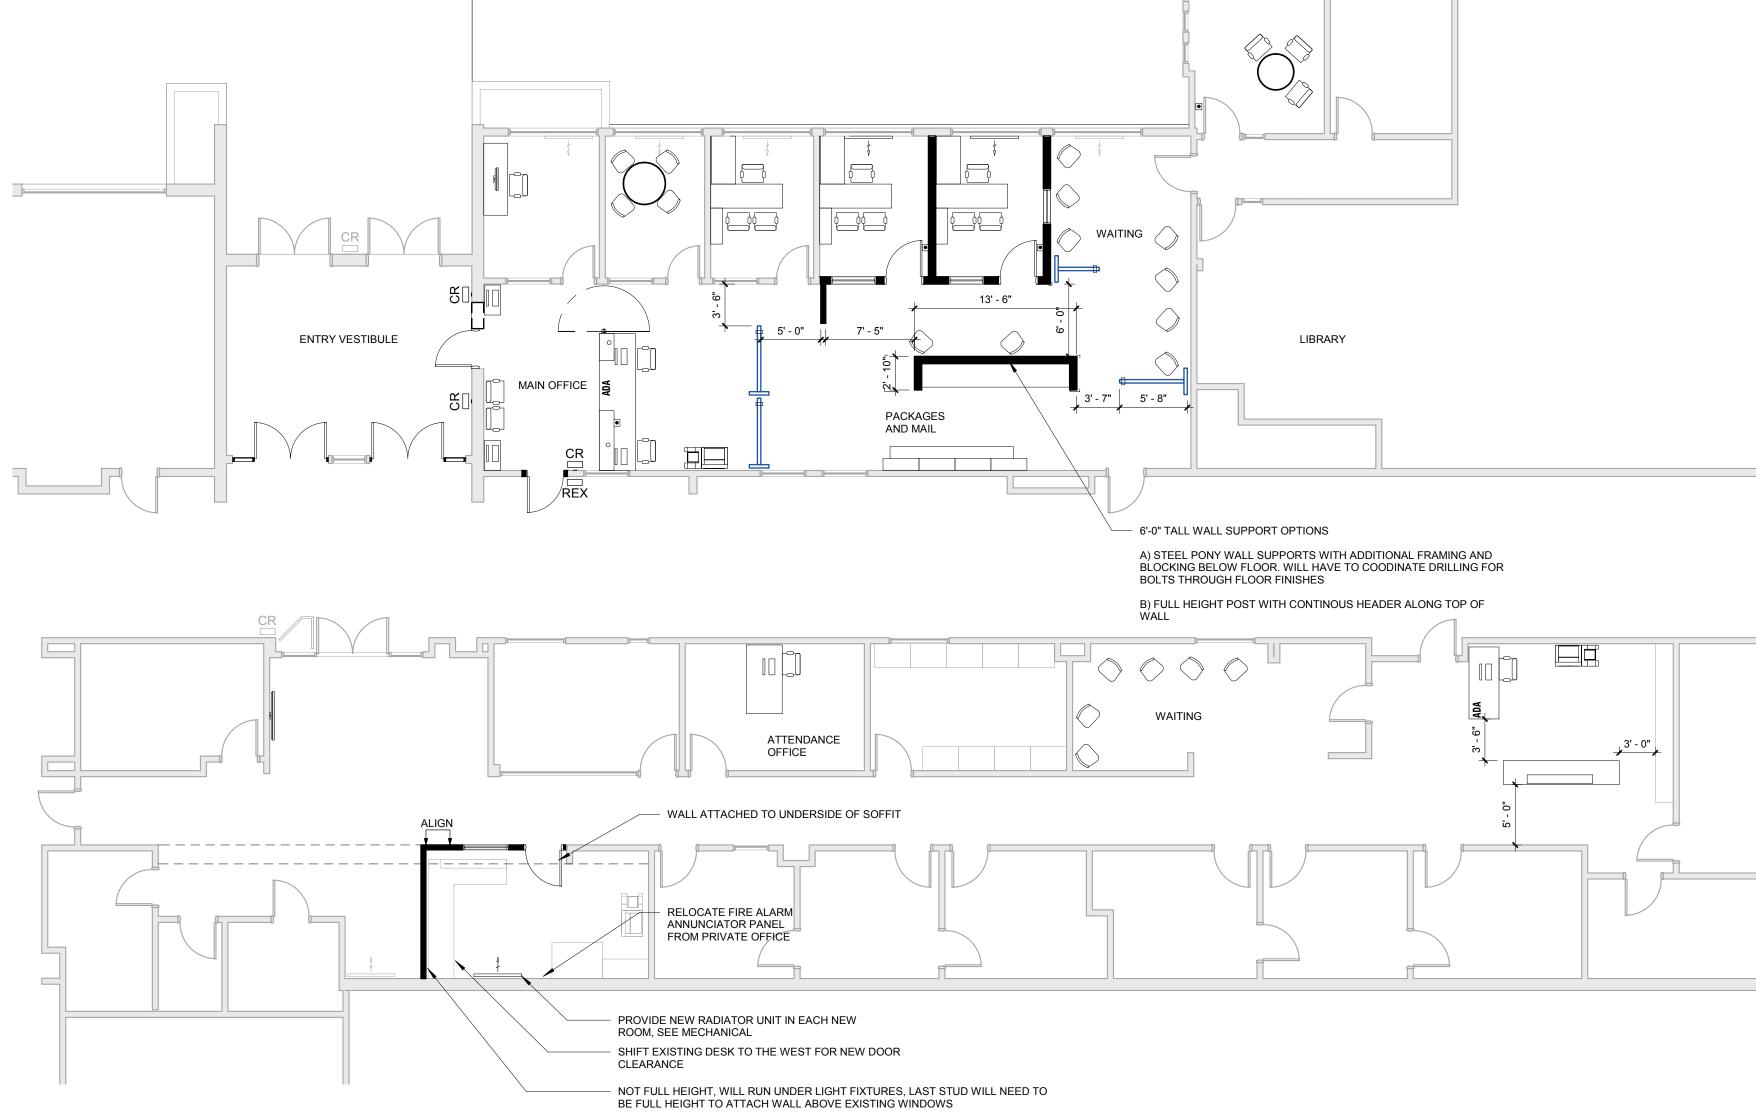1 <u>H</u> <u>SCOPE - SOUTH - OFFICES Copy 1</u>

AR	CHITECTURE
STATE	STERED ARCHIER Sonn STAPLETON EC NEENE, OREGON OF OREGON
CONSTRUCTION DRAWING SET	4J SECURITY IMPROVEMENTS PROJECT #: 2207 EUGENE SCHOOL DISTRICT 4J
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	DATE: 03.15.23



INSTALLATION NOTES - ELECTRICAL

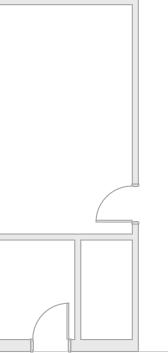 \odot

BECOME FAMILIAR WITH EXISTING CONDITIONS PRIOR TO BID.

- MOUNT SURFACE RACEWAYS USING MECHANICAL MOUNTING SYSTEMS AND
- FASTENERS. MOUNTING THROUGH THE USE OF ADHESIVE IS NOT PERMISSIBLE.
- INCREASE CONDUCTOR SIZES ON 20A 120V-1 PHASE CIRCUITS EXCEEDING 100 FEET TO 5 3. CENTER OF LOAD TO ACCOUNT FOR VOLTAGE DROP.
- RACEWAYS AND BOXES ARE SHOWN DIAGRAMMATICALLY ONLY AND INDICATE GENERAL AND APPROXIMATE LOCATIONS. LAYOUTS DO NOT ALWAYS SHOW THE TOTAL NUMBER OF RACEWAYS OR BOXES FOR THE CIRCUITS REQUIRED, NOR ARE THE LOCATIONS OF INDICATED RUNS INTENDED TO SHOW THE ACTUAL ROUTING OF THE RACEWAYS.
- LIGHT FIXTURES, SWITCHES, DEVICES, ETC. ARE SHOWN IN PREFERRED LOCATION. 5. MODIFY CONDUIT, HANGERS, CIRCUITING, ETC. TO PROVIDE A COMPLETE AND OPERATIONAL SYSTEM.
- PROVIDE A DEDICATED GREEN INSULATED GROUND CONDUCTOR TO ALL DEVICES. DO 6. NOT USE CONDUIT SYSTEM AS THE ONLY EQUIPMENT GROUNDING METHOD.
- DO NOT INSTALL BOXES BACK-TO-BACK ON OPPOSITE SIDES OF THE SAME WALL. MAINTAIN MINIMUM OF 8" DISTANCE BETWEEN BOXES WHEREVER APPLICABLE.
- BALANCE PANEL LOADS DURING INSTALLATION. CIRCUIT NUMBERING SHOWN ON PLANS 8. MAY BE ADJUSTED TO ACCOMODATE.
- PROVIDE TYPED PANEL DIRECTORY AT PROJECT COMPLETION FOR NEW PANELS AND 9. EXISTING PANELS WITH CIRCUITS MODIFIED AS A RESULT OF THIS PROJECT. USE OWNER'S CURRENT ROOM NUMBERS AND EQUIPMENT NAMES.
- CONTRACTOR IS RESPONSIBLE FOR OPENINGS IN WALLS, FLOORS, CEILINGS, AND 10. ROOFS THAT ARE REQUIRED TO COMPLETE THEIR SCOPE OF WORK. SEAL PENETRATIONS IN ACCORDANCE WITH THE RATING OF THE AFFECTED ASSEMBLY. REFER TO ARCHITECTURAL CODE PLAN FOR RATED WALLS, FLOORS, AND CEILINGS.

DEVICE INSTALLATION AND MATERIALS - ELECTRICAL

- PROVIDE NORMAL WIRING DEVICES AS WHITE / ALMOND / GRAY / BLACK UNLESS OTHERWISE 1. NOTED.
- PROVIDE DEVICES COVER PLATES AS PLASTIC / STAINLESS STEEL. MATCH WIRING DEVICES 2. COLOR.
- 3. PROVIDE GFCI TYPE RECEPTACLES AT ALL LOCATIONS REQUIRED BY THE NEC.
- INSTALL WALL MOUNTED RECEPTACLES AT +18" ABOVE FINISHED FLOOR UNLESS OTHERWISE 4. NOTED.
- INSTALL WALL MOUNTED LIGHT SWITCHES AT +46" ABOVE FINISHED FLOOR UNLESS 5. OTHERWISE NOTED. EXCEPTION; INSTALL DEVICES ABOVE AN OBSTRUCTED HIGH FORWARD REACH OBSTACLE GREATER THEN 20 INCHES IN DEPTH AT +42".
- 6. INSTALL ABOVE COUNTERTOP RECEPTACLES +8" ABOVE COUNTERTOP OR AS OTHERWISE INDICATED.
- AT A COMMON COUNTERTOP, INSTALL ALL RECEPTACLES AND SWITCHES AT THE SAME 7. HEIGHT UNLESS OTHERWISE SPECIFICALLY INDICATED.

INSTALLATION NOTES - LIGHTING

- UNLESS NOTED OTHERWISE, CONNECT ALL EMERGENCY BATTERY FIXTURES WITH AN UN-1. SWITCHED LEG OF THE LIGHTING CIRCUIT THAT SERVES THE FIXTURES SPACE. MAINTAIN NORMAL SWITCHING SCHEME OF EMERGENCY FIXTURES UNDER NORMAL OPERATION. INSTALL PER EMERGENCY FIXTURE OR TRANSFER DEVICE INSTRUCTIONS.
- 2. VERIFY CEILING TYPE (IE. GRID, GYP) WITH ARCHITECTURAL REFLECTED CEILING PLANS PRIOR TO RELEASE OF LIGHTING FIXTURE EQUIPMENT PACKAGE. ADJUST FIXTURE TYPE. CONSTRUCTION, FLANGE, OR OTHER COORDINATION DETAILS AS REQUIRED FOR CEILING TYPE.
- LIGHTING CONTROLS SENSORS ARE SHOWN ON PLANS AT SUGGESTED LOCATIONS ONLY. 3. VERIFY LOCATIONS WITH MANUFACTURER GUIDELINES AND INSTALLATION RECOMMENDATIONS. ADJUST LOCATIONS AS REQURIED TO MEET MANUFACTURER GUIDELINES.
- PROVIDE LIGHTING CONTROLS AS A COMPLETE SYSTEM AND INCLUDE MATERIAL AND 4. INSTALLATION FOR ALL POWER PACKS, ACCESSORIES, CONTROLLERS, AND WIRING REQUIRED FOR OPERATION.

BUILDING EQUIPMENT COORDINATION NOTES - ELECTRICAL

REFER TO EQUIPMENT CONNECTION SCHEDULE FOR COORDINATION DETAILS BETWEEN MECHANICAL AND ELECTRICAL SYSTEMS. PROVIDE AND INSTALL ELECTRICAL SYSTEMS UNDER THIS CONTRACT MEETING THE 2 REQUIREMENTS OF THE SPECIFIED MECHANICAL, FIRE PROTECTION, AND PLUMBING SYSTEMS. REFERENCE THE ENTIRE PROJECT DOCUMENTS, MANUALS, SCHEDULES, DETAILS, AND NOTES. PROVIDE ELECTRICAL CONNECTIONS AND ACCESSORIES INCLUDING STARTERS, DISCONNECTS, CONTROL WIRING, ETC. AS REQUIRED FOR THE BUILDING MECHANICAL EQUIPMENT. INFORMATION HEREIN AND ON THE DRAWINGS IS FOR GENERAL DESCRIPTION AND ESTIMATING PURPOSES ONLY. VERIFY VOLTAGE, AMPERAGE, PHASE, INRUSH, ETC. FOR EACH ITEM OF EQUIPMENT BEFORE PROCEEDING WITH INSTALLATION. INSTALL EQUIPMENT PER WIRING DETAILS AND INSTRUCTIONS FURNISHED BY THE SUPPLIERS OF THE EQUIPMENT TO PROVIDE PROPER OPERATION. REVIEW MECHANICAL EQUIPMENT SHOP DRAWINGS FOR COMPLIANCE AND COORDINATION - 4 WITH ELECTRICAL CONNECTIONS. NOTIFY ENGINEER IF CHANGES TO ELECTRICAL CONNECTIONS, WIRING, AND BREAKER REQUIREMENTS ARE NECESSARY TO ACCOMMODATE EQUIPMENT BEING SUPPLIED. DO NOT RELEASE ELECTRICAL DISTRIBUTION EQUIPMENT UNTIL ALL MECHANICAL a. EQUIPMENT REQUIRING ELECTRICAL INFRASTRCTURE HAS BEEN SUBMITTED AND APPROVED. MAKE COORDINATION ADJUSTMENTS TO BREAKER SIZES AND SIMILAR CHANGES TO ELECTRICAL EQUIPMENT PRIOR TO SUBMITTAL RELEASE. COORDINATE SCHEDULING OF SHOP DRAWINGS WITH ALL TRADES. PROVIDE DISCONNECTS RATED FOR EQUIPMENT AS REQUIRED AND AS INDICATED WITHIN EQUIPMENT CONNECTION SCHEDULE. COORDINATE DISCONNECT MOUNTING TO ALLOW EQUIPMENT REMOVAL WITHOUT DISCONNECT REMOVAL AND TO MINIMIZE WIRING WORK REQUIRED. PROVIDE HEAVY DUTY TYPE DISCONNECTS RATED FOR THE INSTALLED ENVIRONMENT. PROVIDE MINIMUM NEMA 3R RATED DISCONNECTS FOR EXTERIOR INSTALLATIONS OR AS NOTED. VERIFY LOCATIONS OF ALL EQUIPMENT. REFER TO MECHANICAL, PLUMBING, AND ARCHITECTURAL DRAWINGS AND COORDINATE WITH THE ASSOCIATED SUB-CONTRACTOR. ADJUST ELECTRICAL INSTALLATION AS REQUIRED. <u>×</u>STALLATION NOTES - SYSTEMS REFER TO TECHNOLOGY SERIES SHEETS FOR ROUGH-IN REQUIREMENTS. REFER TO ELECTRICAL/TECHNOLOGY SCOPE OF RESPONSIBILITY MATRIX.

ELECTRICAL ABBREVIATIONS

ELEC	CTRICAL ABBREVIATIONS			
A AFF ATS C CB CT EC EM ER FACP FSD GND KVA KW MCB MDP MLO N		NIC NM NTS OC OFCI OFOI R RR RN SCCR T TCC TV TYP UPS V VA WG WP WR +24"	NOT IN CONTRACT NONMETALLIC NOT TO SCALE ON CENTER OWNER FURNISHED CONTRACTOR INSTALLED OWNER FURNISHED, OWNER FURNISHED, OWNER INSTALLED EXISTING ITEM TO BE REMOVED EXISTING ITEM TO BE REMOVED AND RELOCATED EXISTING ITEM TO BE REMOVED AND REPLACED WITH NEW SHORT CIRCUIT CURRENT RATING TAMPER PROOF DEVICE TEMPERATURE CONTROL CONTRACTOR TELEVISION TYPICAL UNINTERRUPTIBLE POWER SUPPLY VOLTS VOLT-AMPERES WIREGUARD COVER WEATHER RESISTANT DEVICE INDICATES MOUNTING HEIGHT CENTER LINE OF DEVICE TO FINISHED FLOOR	
<u>GEN</u>	ERAL NOTES - ELECTRICAL			
1.	COORDINATE LOCATION/INSTALLATION OF OTHER TRADES. BEGIN INSTALLATION AND COORDINATION WITH ALL TRADES ASSOCI COORDINATE WITH BUILDING STRUCTURE PIPING SYSTEMS, LIGHT FIXTURES, CONDU ACCESS/CLEARANCE, ETC. REFER TO ALL DRAWINGS AND SPECIFICATIONS FOR THIS REWORK OF INSTALLED EQUIPMENT RESU) ROUG IATED W , ARCHI JITS, CA GENER S PROJE	H-IN ONLY AFTER PROPER AND TIMELY /ITH THE INSTALLATION IS COMPLETE. CTURE, MECHANICAL SHEET METAL, ALL BLE TRAYS, EQUIPMENT AL, MECHANICAL, AND ELECTRICAL ECT. CONTRACTOR IS RESPONSIBLE FOR	
2.	ELECTRICAL DRAWINGS ARE ONLY A PORT CONTRACT DOCUMENTS. THE ELECTRICAL SET OF CONTRACT DOCUMENTS. THIS INC ARCHITECTURAL PLANS FOR DIMENSIONS REQUIREMENTS, MECHANICAL PLANS FOR	L SCOPE LUDES AND DE	E OF WORK IS DEFINED BY THE COMPLETE BUT IS NOT LIMITED TO REFERENCING; ETAILS; EQUIPMENT PLANS FOR ROUGH-IN	
COD	E NOTES - ELECTRICAL			
1.	PROVIDE ELECTRICAL INSTALLATION IN AC NATIONAL CODES.	CORDA	NCE WITH ALL LOCAL, STATE, AND	
2.	THE CURRENT ADOPTED EDITION OF THE ELECTRICAL INSTALLATION. VERIFY WITH I NOTIFY DESIGN TEAM OF ANY DESCREPAN DRAWINGS AND THE GOVERNING CODE.		OFFICIALS WHEN PERMITS ARE OBTAINED.	
3.	INSTALLATION SHALL FOLLOW REQUIREM	ENTS OF	THE ADAAG -AMERICANS WITH	
4.	REFER TO PROJECT MANUAL AND PROJEC	CT CODE	E REVIEW SHEET FOR LIST OF APPLICABLE	
	CODES.			
DEM	OLITION AND RENOVATION NOTES	<u>S - Ele</u>	ECTRICAL	
1.	BASED ON FIELD OBSERVATION AND ORIG CONDITIONS BEFORE WORK BEGINS. ADD	INAL DF	XISTING CONDITIONS HAVE BEEN PREPARED AWINGS. FIELD VERIFY EXISTING COMPONENTS MAY EXIST WHICH ARE NOT 'RICAL SYSTEM WHICH WILL BE AFFECTED	
2.	PROVIDE EQUIPMENT, LABOR, AND MATER CLEAR THE AREA TO RECEIVE THE NEW W			
3.	IN OCCUPIED AREAS BEYOND THE DEMOLI AFFECTED BY PROJECT SCOPE OPERATIO OBTAIN PERMISSION FROM OWNER'S REP WHICH MAY AFFECT OTHER AREAS BEYON OWNER'S REPRESENTATIVE OF THE REAS ENSURE THAT THE SHUTDOWN IS MADE W AS POSSIBLE.	NAL TH RESENT ND THE I	ROUGH THE DURATION OF THE PROJECT. ATIVE TO SHUT OFF SERVICES OR SYSTEMS LIMITS OF THE DEMOLITION AREA. INFORM AND DURATION OF THE SHUTDOWN AND	
4.	REMOVE CONDUITS, BOXES, ETC., AS REQ COMPONENTS DEMOLITION. REMOVE EXIS			
5.	INSTALL NEW CONDUCTORS FOR NEW CIF SPECIFICALLY NOTED OTHERWISE. RETAIN APPROVED BY ENGINEER OR AS INDICATE	N EXISTI	N REMODELED AREAS UNLESS NG CONDUITS IN GOOD CONDITION WHERE	
6.	IDENTIFY DISCONNECTED BRANCH CIRCUI DISCONNECTION. UPDATE PANEL/EQUIPMI			
7.	MAINTAIN CIRCUITS SERVING AREAS BEYO AND BYPASS DEMOLISHED DEVICES TO M			
8.	KEEP EXISTING SYSTEMS OPERATIONAL D CUT EXISTING TELECOMMUNICATION WIRI IN-SERVICE CABLES ARE RESPONSIBLE FO	NG, CAE	BLES OR CONDUIT. CONTRACTORS WHO CUT	
9.	INSTALL BLANK COVER PLATES OVER OPE INCLUDES BUT IS NOT LIMITED TO, CLOCK ETC.			
10.	PROVIDE CUTTING AND PATCHING OF EXIS COMPLETION OF THE DEMOLITION WORK		ATERIALS AS REQUIRED FOR THE PROPER E INSTALLATION OF THE NEW WORK.	
11.	MAINTAIN FULL FUNCTIONAL AND AESTHE REMOVED AND RELOCATED, AND HANDLE REINSTALLATION. REPLACE DEVICES DAM, CONTRACTOR'S EXPENSE.	WITH A	PPROPRIATE CARE TO ALLOW FOR	
12.	EQUIPMENT AND SYSTEM THAT ARE REMO UNLESS OTHERWISE NOTED. DISPOSE OF			
13.			D FOR THE WORK BEING DONE UNDER THIS JRING CONSTRUCTION TO MATCH EXISTING.	
PROJECT DELIVERY NOTES - ELECTRICAL				
1.	CONTRACTOR. THIS CONTRACTOR IS RESI CONTRACTORS TO COORDINATE LOCATIO	PONSIB		

CONTRACTORS TO COORDINATE LOCATIONS AND INSTALLATION OF MECHANICAL AND CONTRACTORS EXPENSE.

ELECTRICAL WORK WITH ALL OTHER TRADES. REWORK OF INSTALLED EQUIPMENT WILL BE AT

LIGITINO	SYMBOLS	GENERA
a	RECESSED LIGHT FIXTURE, LETTER INDICATES SWITCH LEG (TYPICAL), SHADING INDICATES EMERGENCY LIGHT (TYPICAL)	E3
0	ROUND LIGHT FIXTURE - SURFACE MOUNTED	0
	SQUARE LIGHT FIXTURE - SURFACE MOUNTED	•
\odot	PENDANT MOUNTED LIGHT FIXTURE	Ū
\overrightarrow{o}	ROUND APERTURE RECESSED DOWNLIGHT FIXTURE, ARROW INDICATES WALLWASH	Q
$\stackrel{\rightarrow}{\square}$	SQUARE APERTURE RECESSED DOWNLIGHT FIXTURE, ARROW INDICATES WALLWASH	
	SURFACE MOUNTED STRIP FIXTURE	·
••	LINEAR PENDANT MOUNTED FIXTURE	#
⊢∽⊣	INDUSTRIAL STRIP LIGHT FIXTURE	(#)
	WALL MOUNTED STRIP LIGHT FIXTURE.	XXX X
	COVE LIGHT FIXTURE	A101 S
	CONTINUOUS WALL MOUNTED FIXTURE.	s s
	TRACK LIGHTING, ELEVATION AS NOTED.	1 A101
€	EMERGENCY LIGHT FIXTURE, WALL MOUNT, +96" OR AS NOTED	(A101)
p 4	EMERGENCY LIGHT FIXTURE, CEILING MOUNT	
\bigotimes	EXIT SIGN, WALL MOUNT +96", SHADED AREAS INDICATE NUMBER OF FACES, ARROWS INDICATE SIGN ARROWS	
₿	EXIT SIGN, CEILING MOUNT, SHADED AREAS INDICATE NUMBER OF FACES, ARROWS INDICATE SIGN ARROWS	POWER
	COMBINATION EXIT SIGN & EMERGENCY LIGHT, WALL MOUNT +96", SHADED AREAS INDICATE NUMBER OF FACES, ARROWS INDICATE SIGN ARROWS	φ
	COMBINATION EXIT SIGN & EMERGENCY LIGHT, CEILING MOUNT, SHADED AREAS INDICATE NUMBER OF FACES, ARROWS INDICATE SIGN ARROWS	₩
СН	EXTERIOR LIGHT FIXTURE, WALL MOUNT +10', OR AS NOTED	
Ю	INTERIOR LIGHT FIXTURE, WALL MOUNT	@
	EXTERIOR POLE MOUNTED LIGHT FIXTURE, REFER TO LIGHT FIXTURE SCHEDULE	۲
\oplus	BOLLARD LIGHT FIXTURE	۲
P	EXTERIOR FLOOD LIGHT FIXTURE, REFER TO LIGHT FIXTURE SCHEDULE	Ŷ
▶	EMERGENCY REMOTE HEAD LIGHT FIXTURE, REFER TO LIGHT FIXTURE SCHEDULE	
-	CEILING FAN	99
\$ a	SINGLE POLE SWITCH, WALL MOUNT +48", OR AS NOTED, LETTER INDICATES SWITCH LEG	-
\$ ³ b	THREE WAY SWITCH, WALL MOUNT +48", OR AS NOTED, LETTER INDICATES SWITCH LEG	-
\$ ^Р с	PILOT LIGHT SWITCH, WALL MOUNT +48", OR AS NOTED, LETTER INDICATES SWITCH LEG	
\$ ^D d	DIMMER SWITCH, WALL MOUNT +48", OR AS NOTED, LETTER INDICATES SWITCH LEG	LIGHTING
S1 De	LIGHTING CONTROLS LOW VOLTAGE SWITCH, WALL MOUNT +48", OR AS NOTED, LETTER INDICATES SWITCH LEG, REFER TO LIGHTING CONTROLS SCHEDULE	
¹ © _c	OCCUPANCY SENSOR, WALL MOUNT +48" OR AS NOTED, NUMBER INDICATES TYPE, LETTER INDICATES SWITCH LEG, REFER TO LIGHTING CONTROLS SCHEDULE	
263 a	OCCUPANCY SENSOR, CEILING MOUNT, NUMBER INDICATES TYPE, LETTER INDICATES SWITCH LEG, REFER TO LIGHTING CONTROLS SCHEDULE	
	DAYLIGHTING SENSOR, CEILING MOUNT, NUMBER INDICATES TYPE, LETTER INDICATES SWITCH LEG, REFER TO LIGHTING CONTROLS SCHEDULE	
	LIGHTING CONNECTION, REFER TO LIGHTING FIXTURE SCHEDULE FOR FIXTURE DESCRIPTION	
ETD	EMERGENCY TRANSFER DEVICE	
LC	LIGHTING CONTACTOR	
®	RELAY	
PC RC	PHOTOCELL	

GENERAL SYMBOLS

CONDUIT SLEEVE

CONDUIT UP, REFER TO TAG ON DRAWING FOR SIZE

CONDUIT DOWN, REFER TO TAG ON DRAWING FOR SIZE

JUNCTION BOX, CEILING OR FLOOR MOUNTED.

JUNCTION BOX, WALL MOUNTED, ELEVATION AS NOTED.

CIRCUIT HOMERUN, CONCEALED CONDUIT OR CABLE

CIRCUIT HOMERUN, UNDER FLOOR CONDUIT OR CABLE

KITCHEN EQUIPMENT TAG NUMBER, REFER TO KITCHEN EQUIPMENT CONNECTION SCHEDULE KEYNOTE

EQUIPMENT IDENTIFICATION TAG. REFER TO EQUIPMENT CONNECTION SCHEDULE

SIM DETAIL DRAWING REFERENCE TAG, SIM-SIMILAR, TYP-TYPICAL, OPP-OPPOSITE SHEET REFERENCE

SECTION CUT REFERENCE TAG, SIM-SIMILAR, TYP-TYPICAL, OPP-OPPOSITE SHEET REFERENCE

1 INTERIOR ELEVATION DRAWING REFERENCE TAG

SYMBOLS

DUPLEX RECEPTACLE, TAMPER-RESISTANT, WALL MOUNT +18", OR AS NOTED

QUADRAPLEX RECEPTACLE, TAMPER-RESISTANT, WALL MOUNT +18", OR AS NOTED

QUADRAPLEX GFCI RECEPTACLE, TAMPER-RESISTANT, WALL MOUNT +18", OR AS NOTED

SPECIAL RECEPTACLE, WALL MOUNT +18", OR AS NOTED, REFER TO ELECTRICAL EQUIPMENT CONNECTION SCHEDULE FOR RECEPTACLE TYPE

SPECIAL RECEPTACLE, CEILING MOUNT, REFER TO ELECTRICAL EQUIPMENT CONNECTION SCHEDULE FOR RECEPTACLE TYPE

EQUIPMENT CONNECTION, REFER TO ELECTRICAL EQUIPMENT CONNECTION SCHEDULE FOR CONNECTION TYPE

EQUIPMENT CONNECTION, WALL MOUNT +18", OR AS NOTED, REFER TO ELECTRICAL EQUIPMENT CONNECTION SCHEDULE FOR CONNECTION TYPE


DOOR PUSH BUTTON (WEATHERPROOF), +48" OR AS NOTED

POWER / DATA POLE

PANELBOARD - SURFACE MOUNTED

PANELBOARD - RECESSED IN WALL

IG PLANS NOTATION KEY

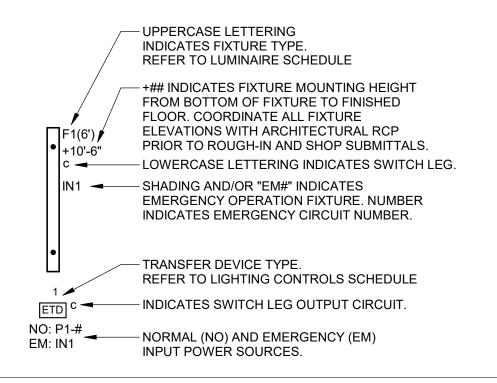

NOTE: ALL SYMBOLS MAY NOT APPLY TO THIS PROJECT







CONSTRUCTION DRAWING SET	4J SECURITY IMPROVEN PROJECT #: 207		
SHEE	SHEET TITLE:		

ELECTRICAL GENERAL **NOTES &** SYMBOLS

REVISIONS: # DESCRP.

DATE

ISSUE DATE: 03.15.23

E00

TELECOMMUNICATIONS DISTRIBUTION NOTES

- PROVIDE PENETRATIONS AND PATHWAYS AS REQUIRED TO ROUTE ALL CABLING Α. INFRASTRUCTURE ILLUSTRATED IN THE DRAWINGS. TREAT EACH NEW PENETRATION AS A 1-HOUR FIRE RATED WALL UNLESS OTHERWISE NOTED. PROVIDE REQUIRED FIRE STOPPING TO MAINTAIN THIS RATING.
- REAM CONDUIT TO REMOVE BURRS AND ROUGH EDGES. PROVIDE A PROTECTIVE BUSHING AT THE END OF ANY CONDUIT STUB TO PROTECT CABLING INFRASTRUCTURE.
- PROVIDE CABLE SUPPORT FOR ROUTING ALL NEW INFRASTRUCTURE. INSIDE OF ABOVE ACCESSIBLE CEILING SPACES, CABLING CAN BE FLOWN FREE-AIR UTILIZING J-HOOKS AND OTHER ACCESSORIES TO SUPPORT CABLING. CABLE SHALL NOT BE ALLOWED TO REST ON TOP OF CEILING TILES OR TO UTILIZE GRID SUPPORT SYSTEM.
- D. ALL OPEN CEILING AREAS SHALL HAVE CABLING CONCEALED IN CONDUIT. EXPOSED CABLING SHALL NOT BE ACCEPTED.
- ROUTE CONDUIT SERVING WORK AREA OUTLET DATA DIRECTLY TO THE CABLE TRAY E. (WHERE APPLICABLE). CONDUIT STUB SHALL BE DIRECTLY OVERHEAD OF THE TRAY TO ALLOW FOR CONVENIENT FUTURE MOVE, ADDS OR CHANGES.
- THE FINAL ROUTING IS AT THE DISCRETION OF THE INSTALLING CONTRACTOR. THE CONTRACTOR IS ENCOURAGED TO INVESTIGATE EXISTING BUILDING CONDITIONS AND UTILIZE ABOVE ACCESSIBLE CEILING, SOFFIT AND BELOW CRAWL SPACES WHERE AVAILABLE TO ROUTE NEW TECHNOLOGY INFRASTRUCTURE. EXPOSED PATHWAYS IN PUBLIC SPACES MUST BE APPROVED BY THE а ARCHITECT OR ENGINEER PRIOR TO INSTALLATION.

FIRE DETECTION & ALARM NOTES

- EXTEND THE EXISTING FIRE DETECTION AND ALARM SYSTEM TO LOCATIONS ILLUSTRATED ON THE DRAWINGS.
- FIRE ALARM ITEMS AND DEVICES ARE SHOWN IN SUGGESTED LOCATIONS. FINAL LAYOUTS, LOCATIONS, AND QUANTITIES SHALL BE IN ACCORDANCE WITH APPLICABLE CODES, MANUFACTURER'S RECOMMENDATIONS, AND EQUIPMENT LISTINGS. COORDINATE LOCATIONS WITH LIGHTING AND AIR HANDLING SYSTEMS.
- C. ALL FIRE ALARM CIRCUITRY IN EXPOSED CEILING SPACES SHALL BE IN 3/4" CONDUIT PER SPECIFICATIONS. EXPOSED CABLING SHALL NOT BE ACCEPTED.
- ALL CONCEALED, ACCESSIBLE CEILING TILE LOCATIONS SHALL BE ALLOWED TO HAVE D. OPEN AIR CABLING INSTALLED. PROVIDE J-HOOKS AND ASSOCIATED CABLE SUPPORTS TO KEEP INFRASTRUCTURE MANAGED AND OFF OF THE CEILING TILE.
- ELECTRICAL CONTRACTOR SHALL PROVIDE FIRESTOPPING AT ALL PENETRATIONS PER F SPECIFICATION.

TECHNOLOGY GENERAL NOTES

- NOTES APPLY TO ALL DIVISION 27 AND 28 SC Α.
- COORDINATION WITH ALL TRADES ASSOCIATED WITH THE INSTALLATION IS COMPLETE. PIPING SYSTEMS, LIGHT FIXTURES, CONDUITS, CABLE TRAYS, EQUIPMENT ACCESS/CLEARANCE, ETC. REFER TO ALL GENERAL, MECHANICAL, AND ELECTRICAL REWORK OF INSTALLED EQUIPMENT RESULTING FROM INSUFFICIENT COORDINATION.
- INCORPORATE THE REQUIREMENTS OF THE SPECIFICATIONS, DRAWINGS, AND STATE AND C. SYSTEMS.

TECHNOLOGY PATHWAY GENERAL NOTES

- Α. CAULK OVERCUT.
- SECURELY FASTEN SURFACE MOUNT RACEWAY AND CONDUIT UTILIZING MECHANICAL В. MEANS OF MOUNTING IS NOT ALLOWED.
- C. PROVIDE A PULL STRING IN ALL NEW CONDUITS FOR EASE OF CABLE INSTALLATION.

COMMUNICATIONS DEMOLITION NOTES

- EXISTING DEVICES AND DEVICE LOCATIONS WERE MADE BY CASUAL FIELD OBSERVATION. CONTRACTOR SHALL BE RESPONSIBLE FOR FIELD VERIFYING SYSTEM COMPONENTS AND DEVICE LOCATIONS.
- PROVIDE LABOR AND MATERIALS TO REMOVE ELECTRICAL FACILITIES AND CLEAR THE Β. AREA TO RECEIVE THE NEW WORK TO BE PROVIDED UNDER THIS CONTRACT.
- SYSTEMS SCHEDULED TO BE REMOVED SHALL BE DONE SO IN THEIR ENTIRETY. C. ABANDONED CABLING SHALL NOT BE ACCEPTED. REMOVE ALL ASSOCIATED FIELD DEVICES AND HEAD END EQUIPMENT.
- D. REMOVED EQUIPMENT AND SYSTEMS SHALL REMAIN THE PROPERTY OF THE OWNER RESPONSIBILITY OF THE CONTRACTOR FOR PROPER DISPOSAL.
- REMOVE AND REINSTALL CEILING TILE REQUIRED FOR THE WORK BEING DONE UNDER F
- DO NOT CUT EXISTING TELECOMMUNICATIONS WIRING, CABLES OR CONDUIT AS EXISTING SYSTEMS SHALL REMAIN OPERATIONAL DURING CONSTRUCTION. AND THE COSTS TO REPAIR.

LIFE SAFETY & SECURITY DEMOLITION NOTES

- EXISTING DEVICES AND DEVICE LOCATIONS WERE MADE BY CASUAL FIELD OBSERVATION. CONTRACTOR SHALL BE RESPONSIBLE FOR FIELD VERIFYING SYSTEM COMPONENTS AND DEVICE LOCATIONS.
- PROVIDE LABOR AND MATERIALS TO REMOVE ELECTRICAL FACILITIES AND CLEAR THE AREA TO RECEIVE THE NEW WORK TO BE PROVIDED UNDER THIS CONTRACT.
- SYSTEMS SCHEDULED TO BE REMOVED SHALL BE DONE SO IN THEIR ENTIRETY. C. ABANDONED CABLING SHALL NOT BE ACCEPTED. REMOVE ALL ASSOCIATED FIELD DEVICES AND HEAD END EQUIPMENT.
- REMOVED EQUIPMENT AND SYSTEMS SHALL REMAIN THE PROPERTY OF THE OWNER D. RESPONSIBILITY OF THE CONTRACTOR FOR PROPER DISPOSAL.
- REMOVE AND REINSTALL CEILING TILE REQUIRED FOR THE WORK BEING DONE UNDER
- DO NOT CUT EXISTING TELECOMMUNICATIONS WIRING, CABLES OR CONDUIT AS EXISTING SYSTEMS SHALL REMAIN OPERATIONAL DURING CONSTRUCTION. CONTRACTOR WHO CUTS IN-SERVICE CABLES SHALL BE RESPONSIBLE FOR DOWNTIME AND THE COSTS TO REPAIR.

ACCESS CONTROL/SECURITY MANAGEMENT NOTES

- EACH SITE HOSTS AN EXISTING LENEL ONGUARD ACCESS CONTROL PLATFORM. THE EXISTING PLATFORM IS TO BE EXTENDED TO ACCOMODATE THE SCHEDULED WORK. THE PROPOSED SCOPE OF WORK INCLUDES: MODIFICATION OF EXISTING ACCESS CONTROL OPENINGS, ADDITION OF NEW ACCESS CONTROL OPENINGS, AND UPGRADING THE HEAD END INTELLIGENT SYSTEM CONTROLLERS AT EACH SITE.
- THE BIDDING CONTRACTOR IS RESPONSIBLE FOR PROGRAMMING IN COORDINATION WITH 4J SCHOOL DISTRICT.
- DETAILS ILLUSTRATED IN THE DRAWINGS ARE DIAGRAMMATIC TO ILLUSTRATE PATHWAY, ROUGH-IN, DEVICE AND CABLING REQUIREMENTS. REVIEW SPECIFICATION SECTION 08 71 00 FOR ALL SPECIFIC ELEMENTS THAT ARE SCHEDULED AT EACH OPENING.
- IT IS THE INTENT THAT ALL PATHWAYS AND ROUGH-IN SERVING ACCESS CONTROL D. SHALL BE RECESSED AND CONCEALED. EXPOSED CABLING OR SURFACE PATHWAYS ARE NOT ACCEPTABLE UNLESS APPROVED BY THE ARCHITECT OR ENGINEER.

INTRUSION DETECTION NOTES

- EXTEND THE EXISTING DMP INTRUSION DETECTION SYSTEM. COORDINATE PLACING
- 2 THE SCOPE OF WORK INCLUDES THE ADDITION OF DOOR POSITION SWITCHES AT NEW AND MODIFIED ACCESS CONTROL OPENINGS. PROVIDE THE REQUIRED RELAYS, EXPANDER MODULES, WIRING AND OTHER ACCESSORIES REQUIRED TO ACCOMODATE THE PROPOSED WORK.
- 3. COORDINATE ZONING AND PROGRAMMING WITH 4J SCHOOL DISTRICT.

CABLING NOTES

- CATEGORY CABLING SERVING DATA AND VOICE APPLICATIONS SHALL BE TESTED TO ENSURE ALL ELECTRICAL CHARACTERISTICS ARE COMPLIANT WITH THE SPECIFIED CLASSIFICATION (6A). UTILIZE FLUKE DSX EQUIPMENT OR EQUIVALENT AND PROVIDE ELECTRONIC RESULTS DURING CLOSEOUT PROCEDURES. ANY INSTANCE OF CABLING FAILING THE PERFORMANCE TEST SHALL BE RECTIFIED BY THE CONTRACTOR THROUGH RE-TERMINATION OR RUNNING NEW CABLING AT NO COST TO THE OWNER.
- PROVIDE A CERTIFIED INSTALLATION BY THE MANUFACTURER. ENSURE THE WARRANTY B IS PROVIDED AS THE SPECIFICATIONS REQUIRE.
- WILD RETURN AIR IS EXPECTED IN THE PLENUM SPACES OF THIS PROJECT. THEREFORE, PROVIDE PLENUM RATED CABLING FOR ALL FLOWN INFRASTRUCTURE IN THE ABOVE ACCESSIBLE CEILING SPACES.

OPE OF WORK ON "E" SERIES SHEETS.	

COORDINATE LOCATION/INSTALLATION OF MECHANICAL AND ELECTRICAL WORK WITH ALL OTHER TRADES. BEGIN INSTALLATION AND ROUGH-IN ONLY AFTER PROPER AND TIMELY COORDINATE WITH BUILDING STRUCTURE, ARCHICTURE, MECHANICAL SHEET METAL, ALL DRAWINGS AND SPECIFICATIONS FOR THIS PROJECT. CONTRACTOR IS RESPONSIBLE FOR

LOCAL CODES INTO THE INSTALLATION OF COMMUNICATIONS AND LIFE SAFETY/SECURITY

EACH TRADE IS RESPONSIBLE FOR MAKING PENETRATIONS WHERE REQUIRED IN EXISTING OR NEW WALLS, FLOORS, CEILINGS, AND ROOFS. MAKE PENETRATIONS NEAT. CONCEAL OR

MOUNTING SYSTEMS AND FASTENERS PER SPECIFICATIONS. THE USE OF ADHESIVES AS A

UNLESS OTHERWISE NOTED. MATERIALS NOT SALVAGED BY THE OWNER SHALL BE THE

THIS CONTRACT. DAMAGED CEILING TILE SHALL BE REPLACED TO MATCH EXISTING.

CONTRACTOR WHO CUTS IN-SERVICE CABLES SHALL BE RESPONSIBLE FOR DOWNTIME

UNLESS OTHERWISE NOTED. MATERIALS NOT SALVAGED BY THE OWNER SHALL BE THE

THIS CONTRACT. DAMAGED CEILING TILE SHALL BE REPLACED TO MATCH EXISTING.

THE EXISTING PANEL IN TEST MODE WITH THE BUILDING OWNER DURING INSTALLATION.

PROVISION RESPONSIBILITIES DEFINED	ofd	<u>کر ج</u>	, ctc) CHC
	640	of	<u> </u>	<u></u>
COMMUNICATIONS - TELECOM SYSTEMS: ROUGH-IN, PATHWAYS AND SLEEVES				
RACKS, FRAMES AND ENCLOSURES	N/A	N/A	N/A	N/A
CABLE MANAGEMENT	N/A	N/A	N/A	N/A
UNINTERRUPTIBLE POWER SUPPLIES (RACK MOUNT)	N/A	N/A	N/A	N/A
PLYWOOD BACKBOARDS	14/7 (14/7 4		14/7 (
COPPER BACKBONE CABLING	N/A	N/A	N/A	N/A
OPTICAL FIBER BACKBONE CABLING	N/A	N/A	N/A	N/A
COAXIAL BACKBONE CABLING	N/A	N/A	N/A	N/A
COPPER HORIZONTAL CABLING				
OPTICAL FIBER HORIZONTAL CABLING	N/A	N/A	N/A	N/A
COAXIAL BACKBONE CABLING	N/A	N/A	N/A	N/A
DATA COMMUNICATIONS SWITCHES AND HUBS	N/A	N/A	N/A	N/A
DATA COMMUNICATIONS WIRELESS ACCESS POINTS	N/A	N/A	N/A	N/A
VOICE COMMUNICATIONS SWITCHING AND ROUTING EQUIPMENT	N/A	N/A	N/A	N/A
COMMUNICATIONS - AUDIO-VISUAL SYSTEMS:				
ROUGH-IN, PATHWAYS AND SLEEVES	N/A	N/A	N/A	N/A
PROJECTOR(S)	N/A	N/A	N/A	N/A
FLAT PANEL DISPLAY(S)	N/A	N/A	N/A	N/A
MULTI-TOUCH DISPLAY(S)	N/A	N/A	N/A	N/A
DISPLAY TECHNOLOGY MOUNTING HARDWARE	N/A	N/A	N/A	N/A
MEDIA PLAYER(S)	N/A	N/A	N/A	N/A
HEAD-END EQUIPMENT	N/A	N/A	N/A	N/A
COMMUNICATIONS - DISTRIBUTED SYSTEMS:				
ROUGH-IN, PATHWAYS AND SLEEVES	N/A	N/A	N/A	N/A
MASTER ANTENNA / COMMUNITY ANTENNA TELEVISION DISTRIBUTION	N/A	N/A	N/A	N/A
PUBLIC ADDRESS SYSTEM	N/A	N/A	N/A	N/A
SOUND MASKING / SPEECH PRIVACY SYSTEM	N/A	N/A	N/A	N/A
INTERCOMMUNICATIONS SYSTEM	N/A	N/A	N/A	N/A
WIRED / WIRELESS CLOCK SYSTEM	N/A	N/A	N/A	N/A
NURSE CALL / CODE BLUE SYSTEM	N/A	N/A	N/A	N/A
DISTRIBUTED ANTENNA SYSTEM	N/A	N/A	N/A	N/A
SECURITY - ACCESS CONTROL:	I	I		
ROUGH-IN, PATHWAYS AND SLEEVES				
SECURITY MANAGEMENT SYSTEM - HEAD END COMPONENTS				
SECURITY MANAGEMENT SYSTEM - FIELD DEVICES ①				
SECURITY MANAGEMENT SYSTEM - ELECTRIFIED DOOR HARDWARE				
SECURITY MANAGEMENT SYSTEM - ALL CABLING				
SECURITY - AIPHONE VIDEO INTERCOM:				
ROUGH-IN, PATHWAYS AND SLEEVES				
DOOR STATION(S)				
HEAD END EQUIPMENT AND COMPONENTS				
SECURITY - VIDEO SURVEILLANCE:				
ROUGH-IN, PATHWAYS AND SLEEVES				
CAMERA(S)	N/A	N/A	N/A	N/A
HEAD END EQUIPMENT AND COMPONENTS	N/A	N/A	N/A	N/A
SECURITY - INTRUSION DETECTION:	1	1		1
ROUGH-IN, PATHWAYS AND SLEEVES				
FIELD DEVICES (MOTION DETECTORS, GLASS BREAKS, DOOR SWITCHES)				
HEAD END EQUIPMENT AND COMPONENTS				
SAFETY - FIRE DETECTION AND ALARM:				
ROUGH-IN, PATHWAYS AND SLEEVES				
INITIATING FIELD DEVICES (SMOKE, MANUAL PULL, MONITOR MODULES)				
NOTIFICATION APPLIANCES (HORNS, STROBES, SPEAKERS)				
MISCELLANEOUS DEVICES (RELAYS, TEST STATION, ANNUNCIATOR)				
OFOI OWNER FURNISHED & OWNER INSTALLED				
OFCI <u>o</u> WNER <u>F</u> URNISHED & <u>C</u> ONTRACTOR <u>I</u> NSTALLED				
CFCI <u>c</u> ontractor <u>F</u> URNISHED & <u>c</u> ontractor <u>I</u> NSTAL	LED			
 CFCI <u>c</u>ONTRACTOR <u>F</u>URNISHED & <u>c</u>ONTRACTOR <u>INSTAL</u> CFOI <u>c</u>ONTRACTOR <u>F</u>URNISHED & <u>O</u>WNER <u>INSTALLED</u> 	LED			
CFCI <u>c</u> ontractor <u>F</u> URNISHED & <u>c</u> ontractor <u>I</u> NSTAL	RIALS NE			R

CORDAGE CONNECTIVITY, SOFTWARE, PROGRAMMING, AND THE LABOR TO INSTALL. REFER TO COVER SHEET GENERAL NOTES FOR ADDITIONAL SYSTEM DESCRIPTIONS AND В. ANTICIPATED SCOPE OF WORK.

NECESSARY FOR A COMPLETE SYSTEM. THIS SHALL INCLUDE BUT NOT BE LIMITED TO,

EQUIPMENT, ACCESSORIES, TERMINATIONS, TERMINATION COMPONENTS, ALL FINAL

KEYNOTES: HID CARD READERS ARE OFCI. ALL OTHER FIELD DEVICES ARE CFCI UNLESS NOTED OTHERWISE.

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NAC
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CR CP D1 D2 ES EL PB LO

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GENERAL SYMBOLS E ____ CONDUIT SLEEVE Ο

FIRE DETECTION AND ALARM SYMBOLS

- MANUAL FIRE ALARM PULL STATION
- SMOKE DETECTOR
- COMBINATION SPEAKER WITH STROBE WALL MOUNTED
- COMBINATION SPEAKER WITH STROBE CEILING MOUNTED
- STROBE WALL MOUNTED
- STROBE CEILING MOUNTED
- FIRE ALARM ANNUNCIATOR PANEL
- FIRE ALARM NAC PANEL
- FIRE ALARM CONTROL PANEL + EMERGENCY COMMUNICATIONS PANEL

VIDEO SURVEILLANCE SYMBOLS

VIDEO SURVEILLANCE CAMERA

ACCESS CONTROL & INTRUSION DETECTION SYMBOLS

- PROXIMITY CARD READER, +44" OR AS NOTED (OFCI)
- COMBINATION PROXIMITY CARD READER WITH PINPAD, +44" OR AS NOTED (OFCI)
- DOOR POSITION SWITCH FLUSH MOUNTED, DOUBLE POLE DOUBLE THROW (DPDT)
- DOOR POSITION SWITCH SURFACE MOUNTED, DOUBLE POLE DOUBLE THROW (DPDT)
- ELECTRIC STRIKE FLUSH OR SURFACE MOUNTED
- ELECTRIFIED EXIT DEVICE (PANIC HARDWARE)
- REQUEST TO EXIT PUSHBUTTON, +44" OR AS NOTED
- MOMENTARY DOOR RELEASE PUSHBUTTON (OFCI)
- LOCKOUT TOGGLE SWITCH, +46" OR AS NOTED
- LOCKDOWN TOGGLE SWITCH, +46" OR AS NOTED

REFER TO ACCESS CONTROL DETAILS FOR ADDITIONAL DEVICE REQUIREMENTS

TELECOMMUNICATIONS INFRASTRUCTURE SYMBOLS

DATA OUTLET - CATEGORY 6A: PROVIDE NUMBER OF CABLES INDICATED BY '#' SHOWN AT EACH SYMBOL.

- CONDUIT UP, REFER TO TAG ON DRAWING FOR SIZE
- CONDUIT DOWN, REFER TO TAG ON DRAWING FOR SIZE
- JUNCTION BOX, CEILING OR FLOOR MOUNTED.
- JUNCTION BOX, WALL MOUNTED, ELEVATION AS NOTED.
- KEYNOTE
- DETAIL DRAWING REFERENCE TAG, SIM-SIMILAR, TYP-TYPICAL, OPP-OPPOSITE SHEET REFERENCE

1 INTERIOR ELEVATION DRAWING REFERENCE TAG








CONSTRUCTION DRAWING SET	4J SECURITY IMPROVEMENTS PROJECT # 207	EUGENE SCHOOL DISTRICT 4J
TEC GEI NO	TTITLE: CHNOLO NERAL TES & MBOLS	OGY
REVIS #	DESCRP	. DATE

SSUE DATE:	03.15.2
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E01





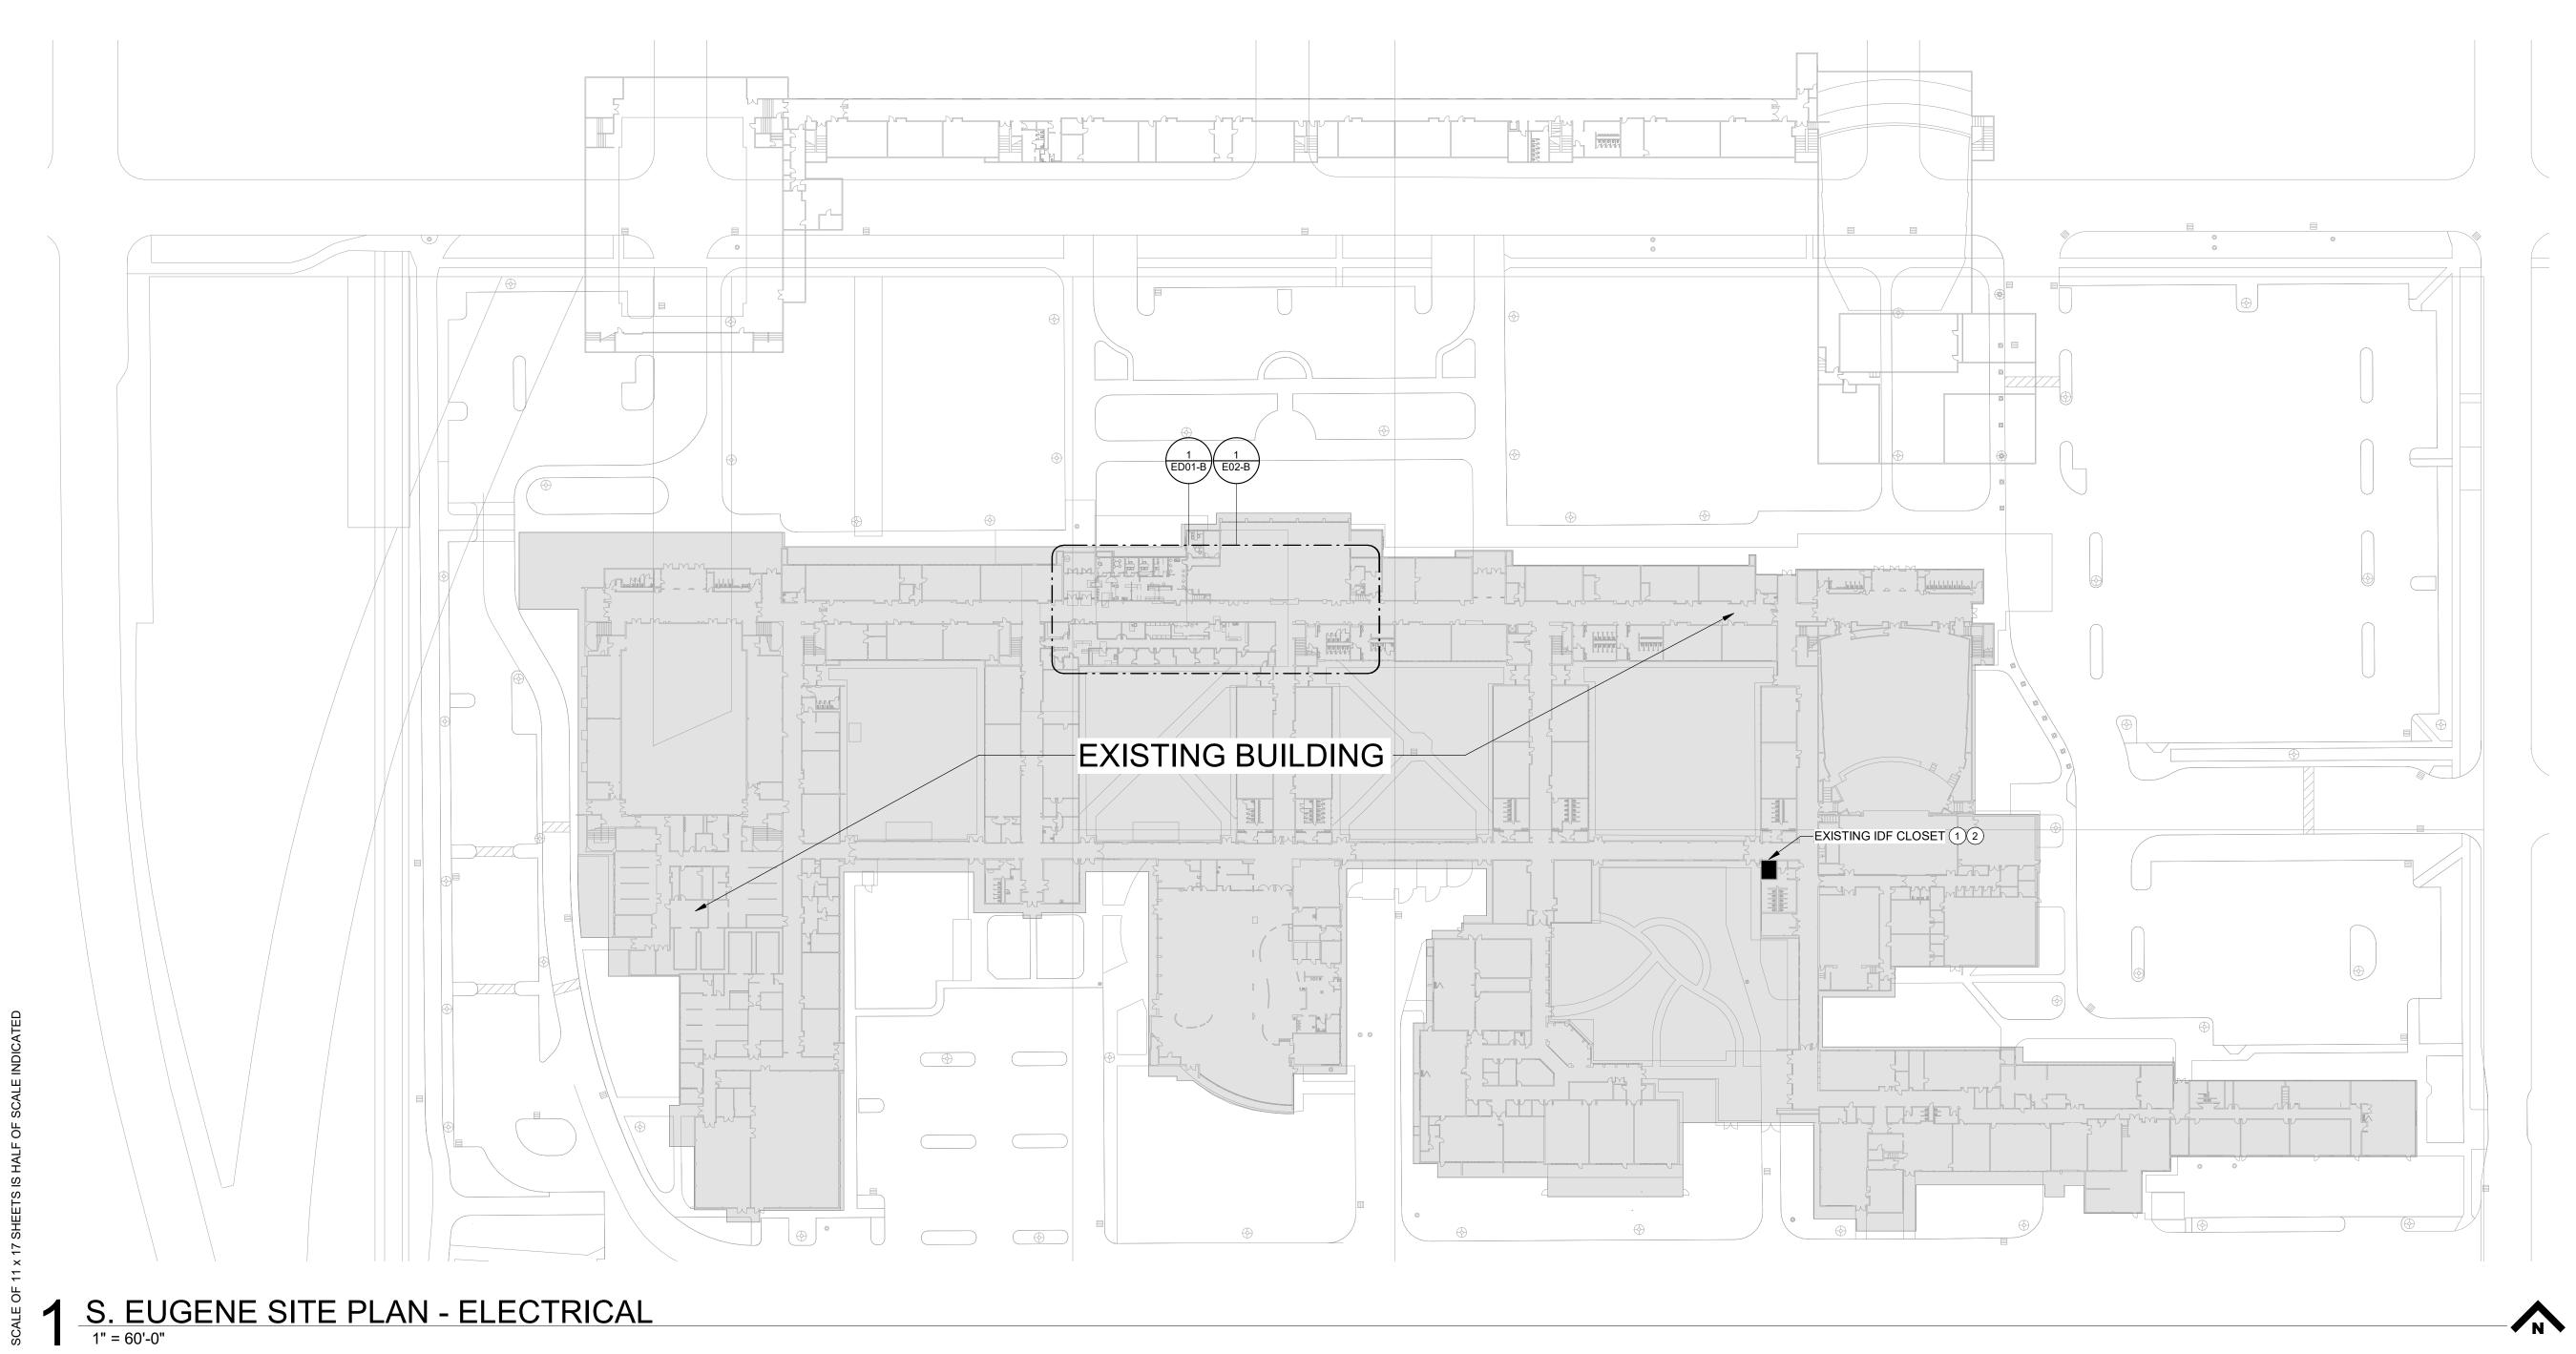

SITE GENERAL NOTES

- A. REFER TO SHEET E00 AND E01 FOR PROJECT GENERAL NOTES.
- B. CONDUIT ROUTING AND LOCATIONS SHOWN ARE SCHEMATIC.
 COORDINATE THE FINAL PROPOSED ROUTING WITH GENERAL
 CONTRACTOR AND OWNER'S REPRESENTATIVE.
- C. PROVIDE SAWCUTTING AND PATCHING OF EXISTING PAVEMENT WHERE REQUIRED TO ACCOMODATE NEW UNDERGROUND WORK.

D. ABBREVIATIONS:

- (E) EXISTING ITEM TO REMAIN (ER) - NEW LOCATION OF EXISTING ITEM
- (N) NEW ITEM IN EXISTING LOCATION
- (D) DEMOLISHED ITEM, PATCH AND/OR COVER (RN) - REPLACE EXISTING WITH NEW
- (RR) EXISTING ITEM TO BE REMOVED AND RELOCATED

<u>KEYNOTES</u>


- LOCATION OF EXISTING LENEL ACCESS CONTROL LNL2000 INTELLIGENT SYSTEM CONTROLLER, 1320 READER CARDS AND POWER SUPPLIES.
- 2 REFER TO RISER DIAGRAM DETAILS ON FOR NEW ACCESS CONTROL SYSTEM EQUIPMENT AND REQUIREMENTS.







CONSTRUCTION DRAWING SET	4J SECURITY IMPROVEMENTS PROJECT # 2207	EUGENE SCHOOL DISTRICT 4J			
S. E H.S.	SHEET TITLE: S. EUGENE H.S. SITE PLAN - ELECTRICAL				
REVIS #	IONS: DESCRP.	DATE			
ISSUE	DATE: 03	.15.23			
E01-B					

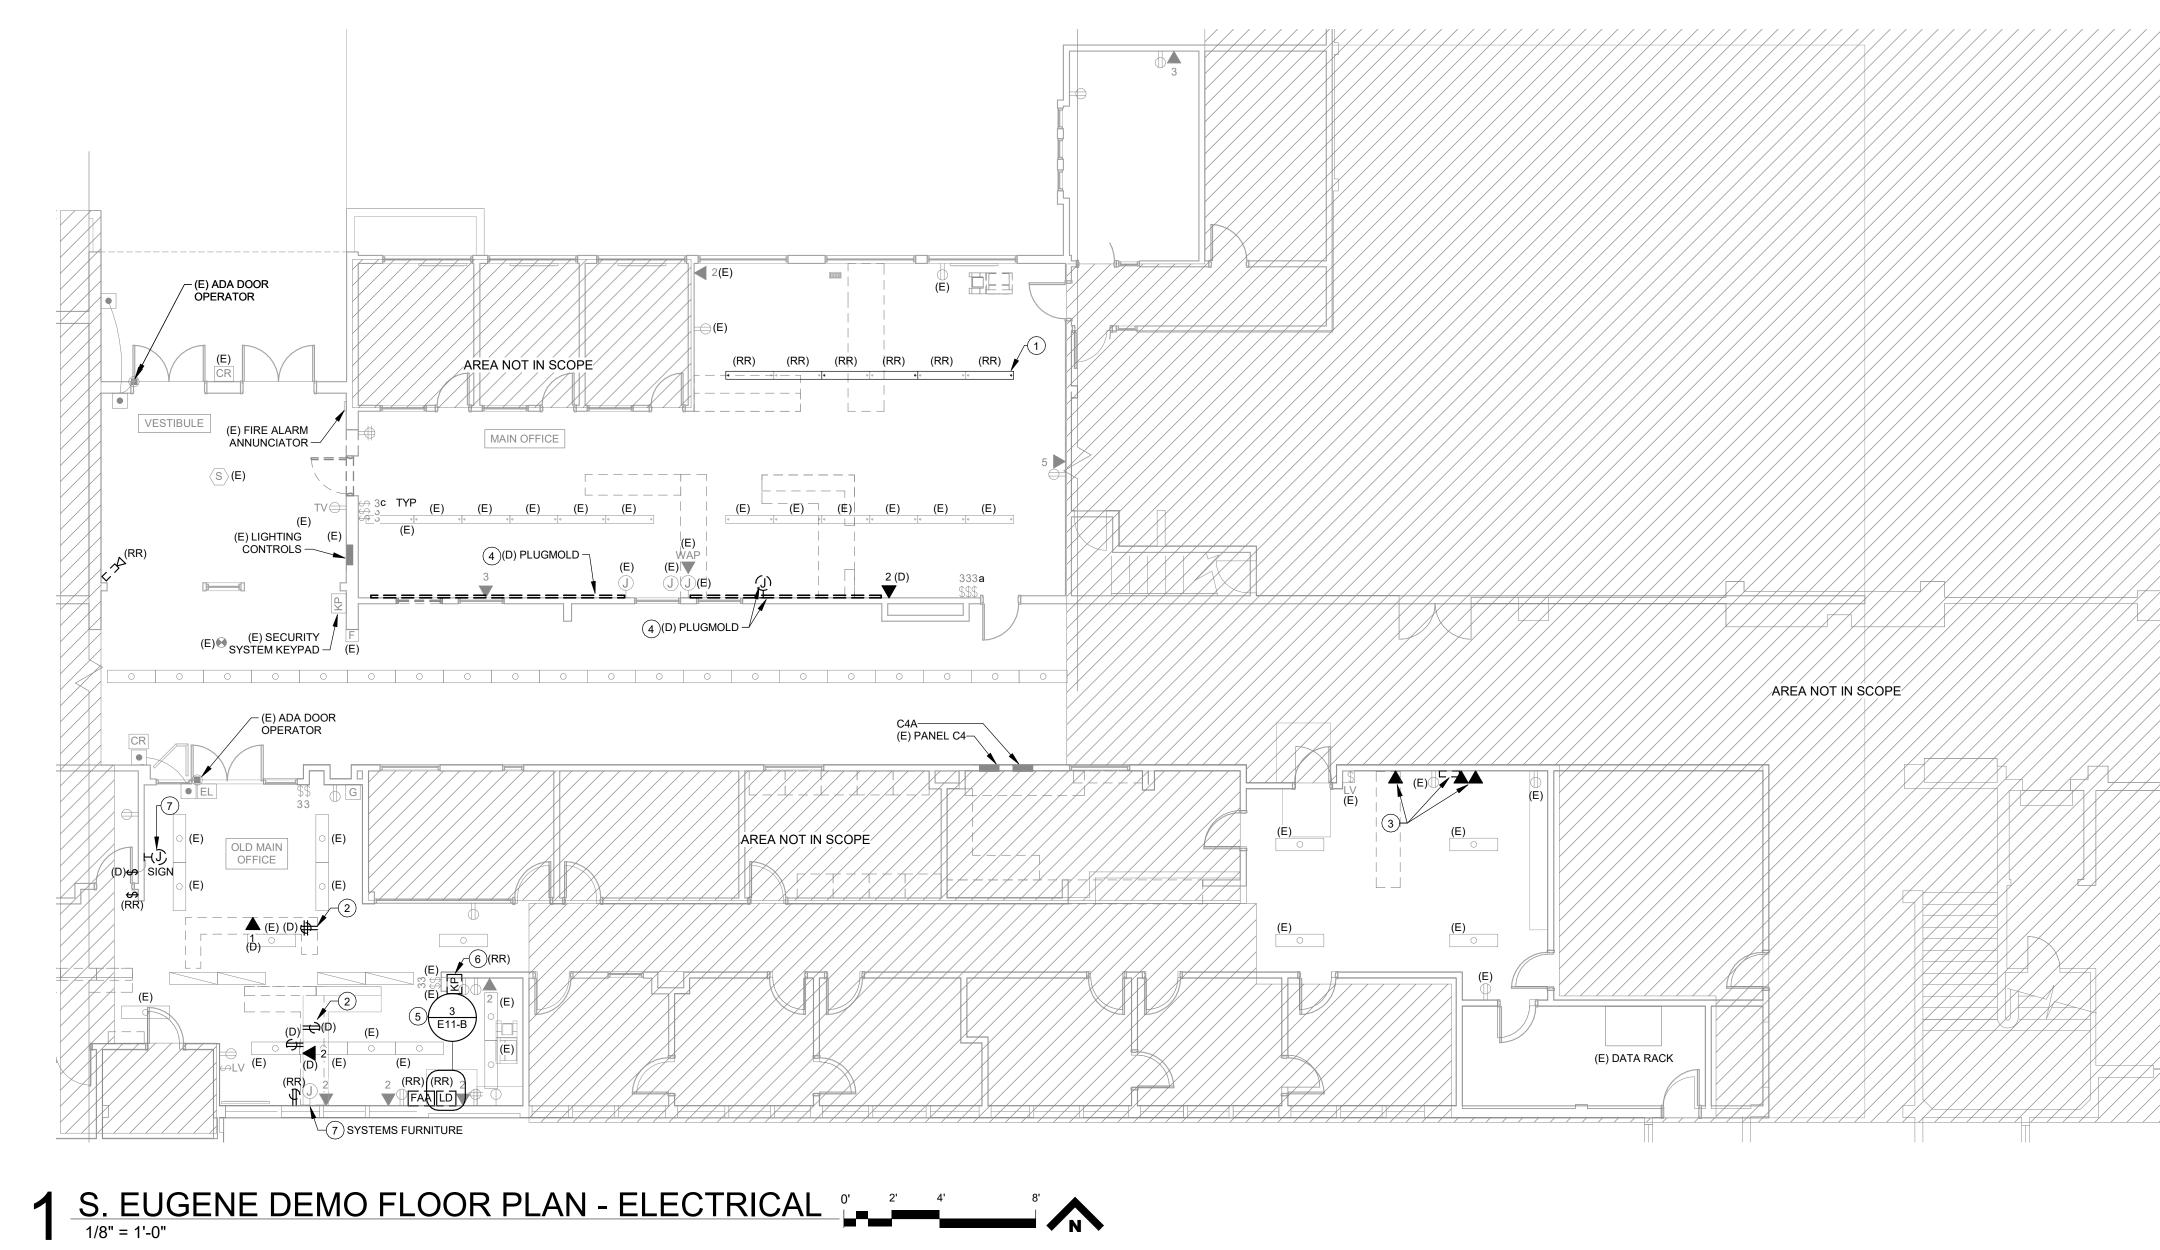

GENERAL NOTES


REFER TO SHEET E00 AND E01 FOR PROJECT GENERAL NOTES. Α.


- в ABBREVIATIONS:
 - (E) EXISTING ITEM TO REMAIN (ER) NEW LOCATION OF EXISTING ITEM
 - (N) NEW ITEM IN EXISTING LOCATION


 - (D) DEMOLISHED EXISTING ITEM, PATCH AND/OR COVER (RN) REPLACE EXISTING WITH NEW (RR) EXISTING ITEM TO BE REMOVED AND RELOCATED

KEYNOTES

- 1 EXISTING LIGHTING FIXTURE TO BE CONFIGURED AS MULTIPLE SEPARATE LUMINAIRES. SEE 1/E101 FOR NEW CONFIGURATION. PROVIDE LUMINAIRE ENDCAPS AND APPURTENANCES TO MATCH EXISTING.
- REMOVE ALL DEVICES MOUNTED IN CASEWORK TO BE 2 DEMOLISHED. REMOVE DATA CABLING ENTIRELY BACK TO DATA RACK. REMOVE BRANCH CIRCUITS BACK TO NEAREST HOMERUN JUNCTION BOX. PATCH AND REPAIR FLOOR ANY ASSOCIATED FLOOR PENETRATIONS.
- REMOVE ABANDONED DEVICES, CABLING, SURFACE 3 RACEWAY, AND EQUIPMENT ENCLOSURES FROM THIS WALL. PATCH AND REPAIR SURFACES TO MATCH EXISTING FINISHES.
- REMOVE EXISTING PLUGMOLD AND WIRING BACK TO 4 JUNCTION BOX. MAINTAIN AND PROTECT BRANCH CIRCUIT FOR EXTENSION TO NEW DEVICES.
- REFER TO THE CALLOUT VIEW FOR THE SCOPE OF WORK. REMOVE EXISTING PINPAD AND RELOCATE TO NEW OFFICE.
- DISCONNECT AND PULL BACK EXISTING CABLING TO ABOVE CEILING, SPLICE/EXTEND TO REINSTALLED LOCATION.
- DISCONNECT EXISTING EQUIPMENT CONNECTION. MAINTAIN AND PROTECT EXISTING BRANCH CIRCUIT FOR EXTENSION TO NEW POWER DEVICE. REFER TO NEW WORK PLAN FOR RECONNECTION.

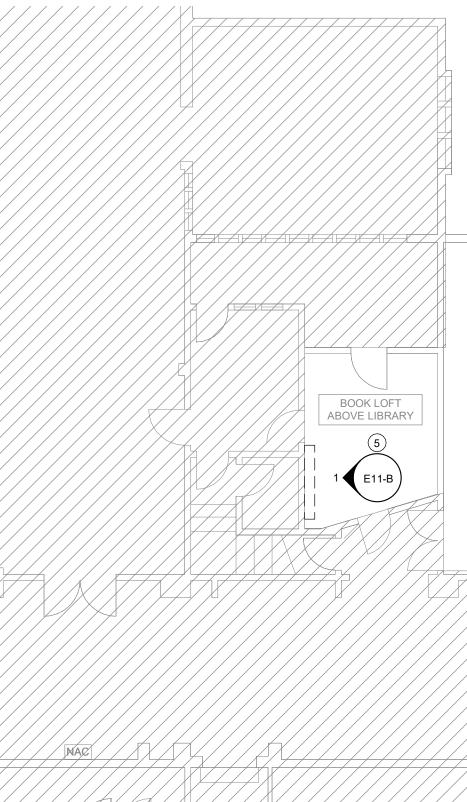


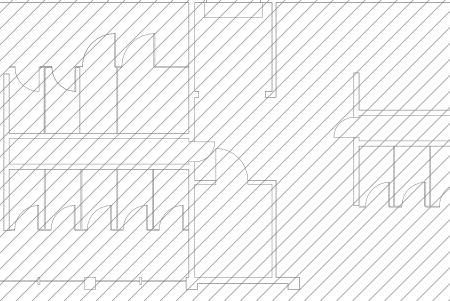

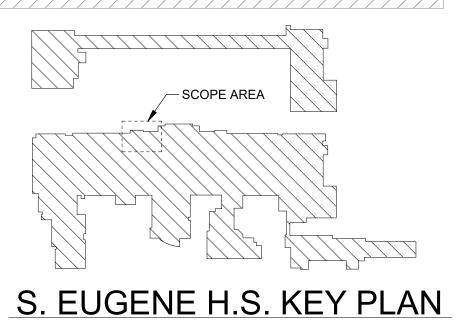

ARCHITECTURE ARCHITECTURE				
shyla Keaup Swaman OREGON THE STAR SCOOL THE STAR S				
Suite 35 Eugene OR 97401 503-212-4612				
CONSTRUCTION DRAWING SET 4.J SECURITY IMPROVEMENTS PROJECT # 207 EUGENE SCHOOL DISTRICT 4J				
SHEET TITLE: S. EUGENE H.S. DEMO FLOOR PLANS - ELECTRICAL				
REVISIONS: # DESCRP. DATE ISSUE DATE: 03.15.23				
ED01-B				



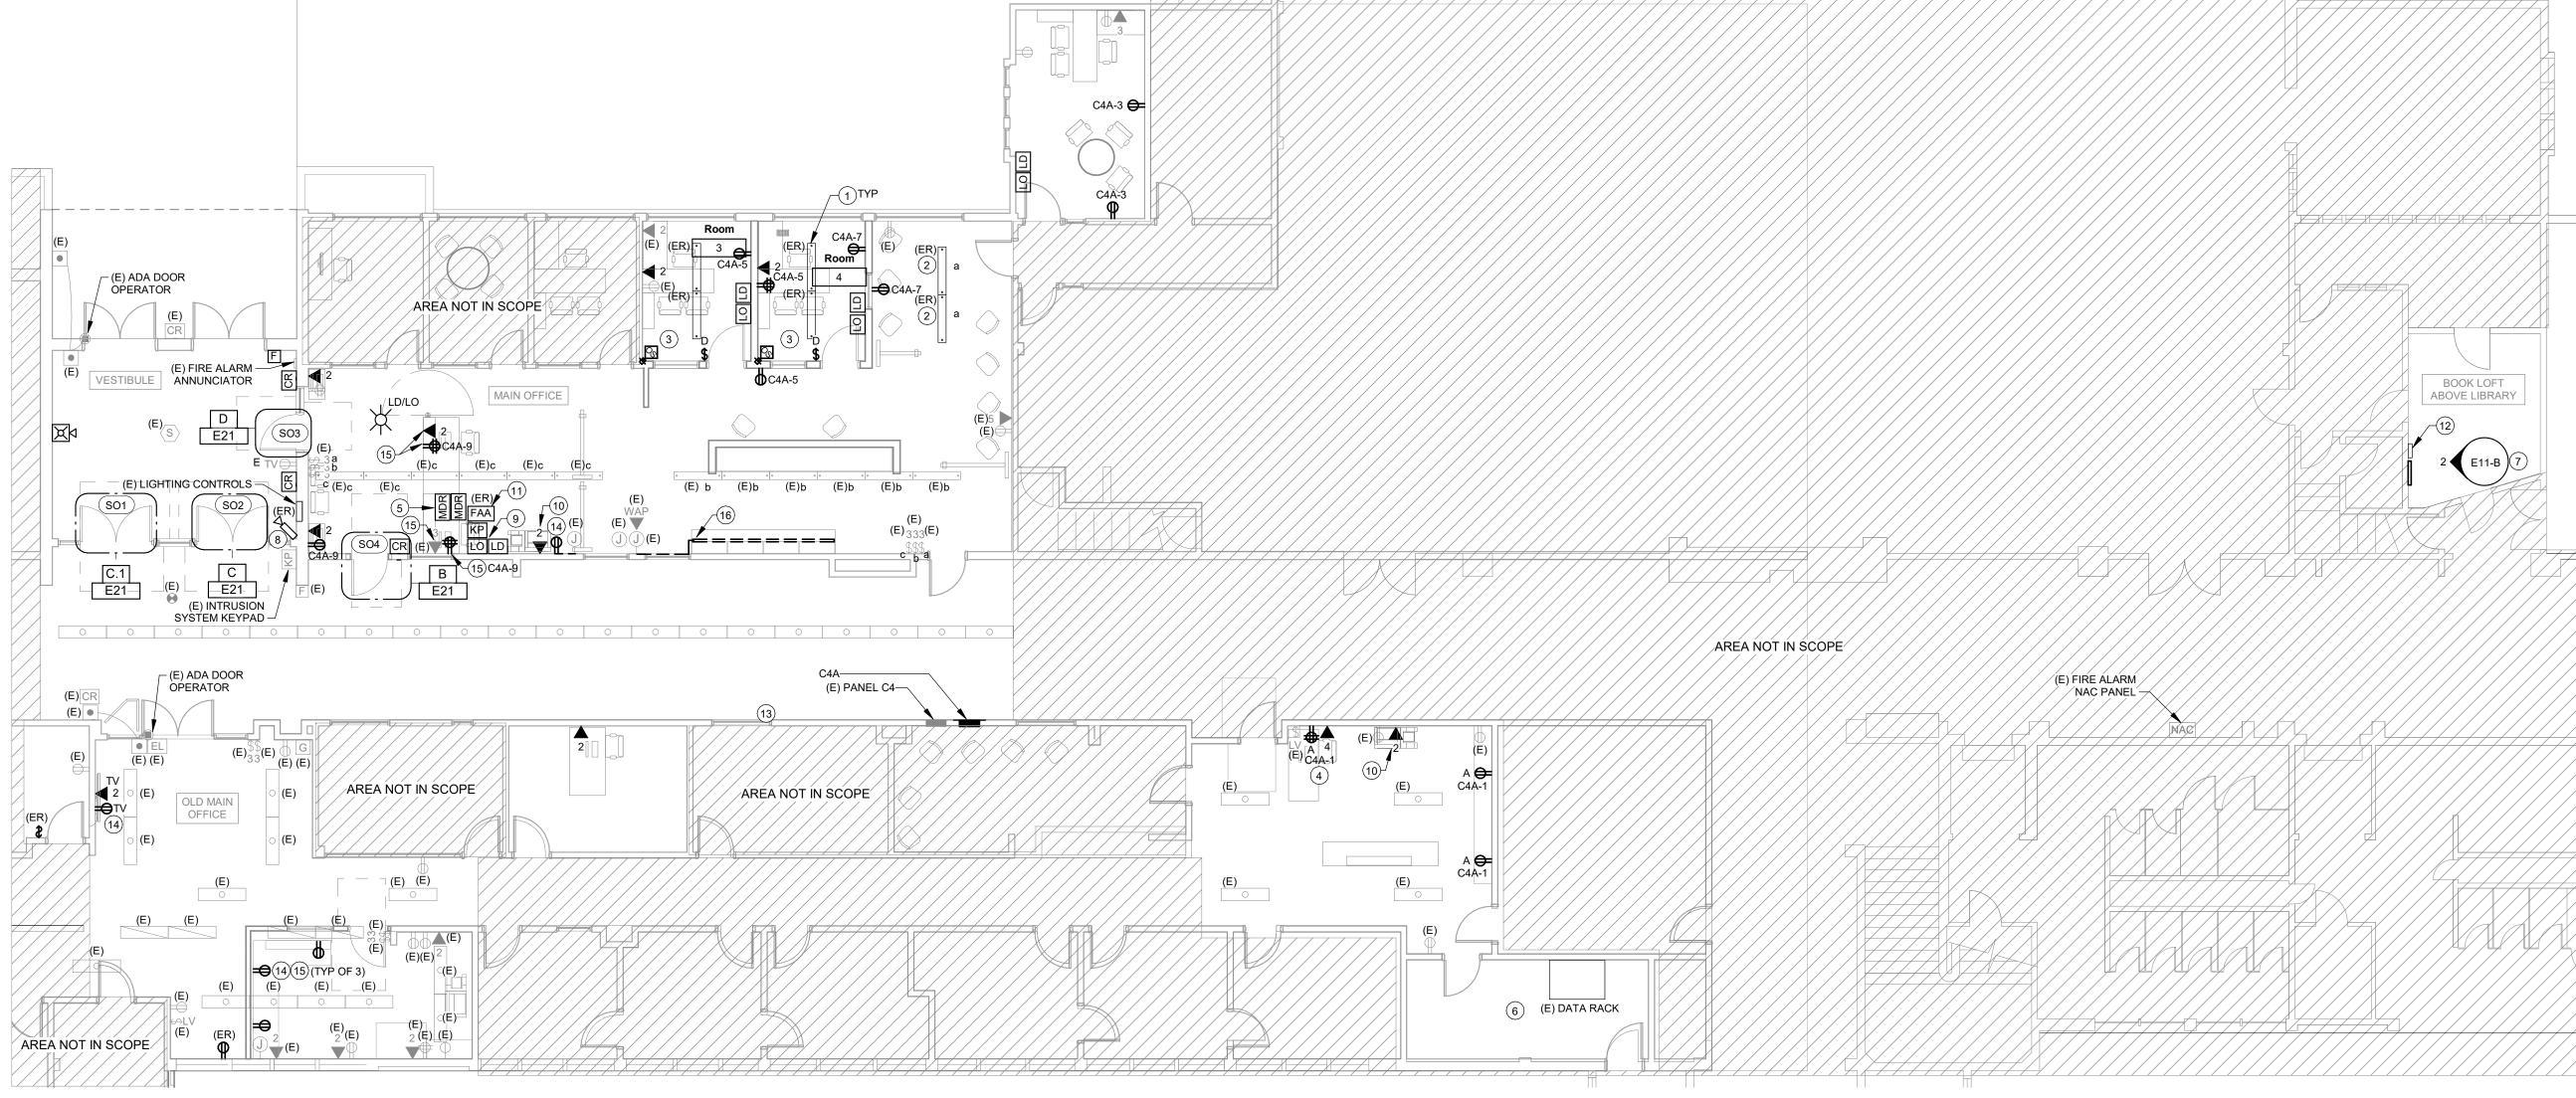

GENERAL NOTES

C.


- A. REFER TO SHEET E00 AND E01 FOR PROJECT GENERAL NOTES.
- CIRCUIT ALL NEW DEVICES TO PANEL C4A AND ROUTE BRANCH Β. CIRCUITS IN BASEMENT BELOW, UNLESS OTHERWISE NOTED.
- ABBREVIATIONS:
- (E) EXISTING ITEM TO REMAIN (ER) NEW LOCATION OF EXISTING ITEM
- (N) NEW ITEM IN EXISTING LOCATION
- DEMOLISHED EXISTING ITEM, PATCH AND/OR COVER (D)
- (RN) REPLACE EXISTING WITH NEW (RR) EXISTING ITEM TO BE REMOVED AND RELOCATED


KEYNOTES


- REMOVE EXISTING LUMINAIRE BALLAST AND RECONNECT LUMINAIRE LAMP 1
- BASE TERMINALS FOR LINE VOLTAGE CONNECTION TO NEW LED LAMP. INTERCEPT AND EXTEND EXISTING LIGHTING CIRCUIT AND SWITCH LEGS TO
- RECONNECT RELOCATED LIGHTING TO EXISTING SWITCH. INTERCEPT AND EXTEND EXISTING UNSWITCHED HOT OF EXISTING LIGHTING CIRCUIT TO SERVE RELOCATED LUMINAIRES. ROUTE THROUGH NEW WALL
- SWITCH FOR LOCAL CONTROL OF LIGHTING. DEVICES TO SERVE NEW CASEWORK. COORDINATE FINAL LOCATIONS WITH 4
- OWNER PRIOR TO ROUGH-IN. SURFACE MOUNT MOMENTARY DOOR RELEASE BUTTONS SERVING DOORS 5 SO3 AND SO4 BELOW DESK COUNTERTOP. UTILIZE SURFACE RACEWAY CONCEALED BENEATH COUNTERTOP FROM SOUTH WALL TO A SINGLE GANG JUNCTION BOX MOUNTED BELOW COUNTERTOP. INSTALL OWNER-FURNISHED MOMENTARY DOOR RELEASE BUTTON AND CABLING
- WHIP. COORDINATE INSTALLATION REQUIREMENTS WITH OWNER SUPPLIED EQUIPMENT. ROUTE NEW TELECOMMUNICATIONS CABLING TO EXISTING IDF RACK AND 6
- TERMINATE TO EXISTING PATCH PANELS.
- REFER TO THE CALLOUT VIEW FOR THE SCOPE OF WORK. 7
- REPULL NEW CATEGORY 6A CABLING FROM EXISTING IDF AND CONNECT, 8 MATCH EXISTING CONDITIONS.


KEYNOTES

- LOCATION OF EXISTING-REINSTALLED DEVICES AS ILLUSTRATED ON 9 #3/E11-B, EXISTING-REINSTALLED PINPAD AND NEW LOCKOUT SWITCH. COORDINATE PLACEMENT WITH EXISTING CONDITIONS.
- PROVIDE (1) CATEGORY 6A CABLE AND (1) POTS LINE TO COPIER. 10
- 11 RELOCATE FIRE ALARM ANNUNCIATOR TO NEW MAIN OFFICE. CONFIRM LOCATION WITH OWNER PRIOR TO ROUGH-IN.
- PROVIDE NEW DMP 714-18T INTRUSION SYSTEM EXPANDER MODULE. REFER 12 TO ELEVATION AND RISER DIAGRAM FOR ADDITIONAL REQUIREMENTS.
- 13 INTERCEPT AND EXTEND DISCONNECTED BRANCH CIRCUIT MADE AVAILABLE 14
- DURING DEMOLITION TO SERVE NEW RECEPTACLE.
- 15 DEVICE MOUNTED IN CASEWORK. COORDINATE LOCATIONS AND INSTALLATION DETAILS WITH ARCHITECT PRIOR TO ROUGH-IN.
- 16 PROVIDE NEW PLUGMOLD MOUNTED TO CASEWORK, WIREMOLD 20GB606 OR APPROVED EQUIVALENT. INTERCEPT AND EXTEND SALVAGED CIRCUIT TO SERVE NEW PLUGMOLD. COORDINATE INSTALLATION LOCATION AND DETAILS WITH ARCHITECT PRIOR TO PROCUREMENT AND ROUGH-IN. PROVIDE MECHANICAL MOUNTING HARDWARE AND APPURTENANCES AS REQUIRED BY THE MANUFACTURE AND INSTALLATION CONDITIONS FOR A COMPLETE AND OPERABLE SYSTEM.

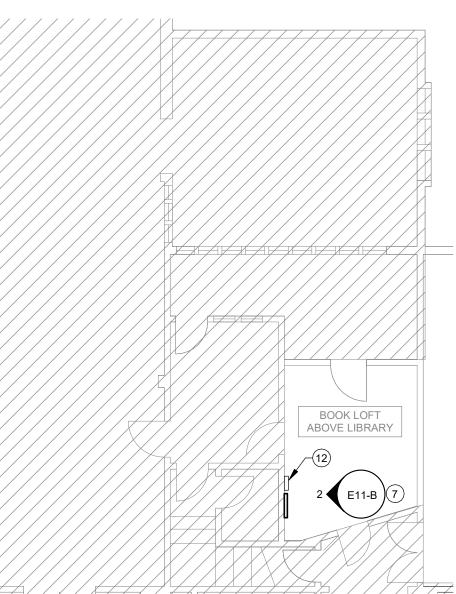

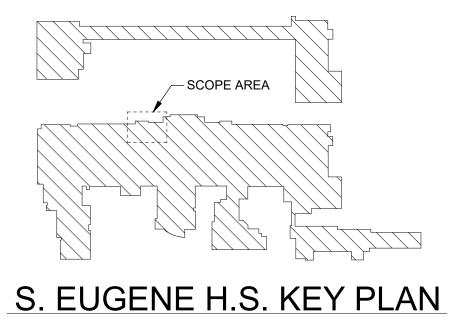

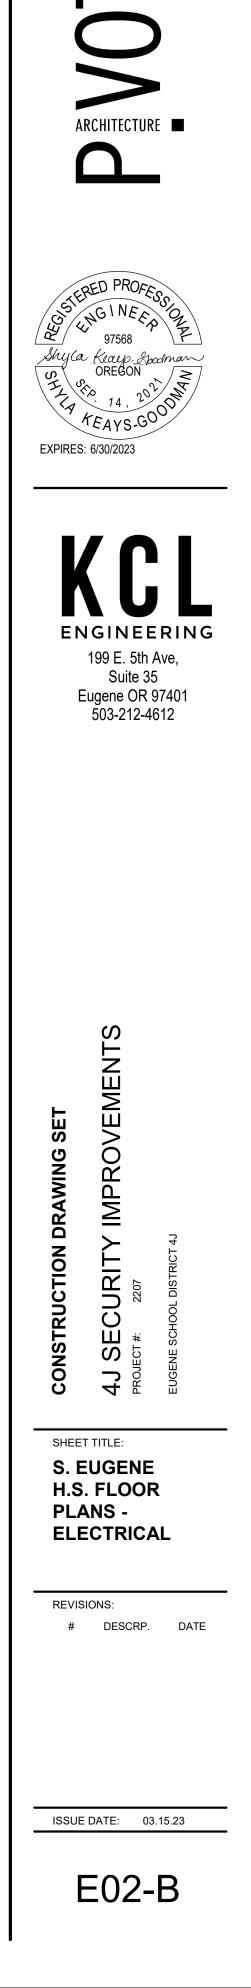

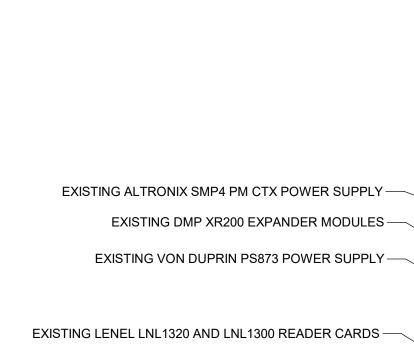

ΓĒ EXISTING LENEL LNL1320 READER CARD -EXISTING SURFACE RACEWAY (TYP.) -

1 S. EUGENE BOOK LOFT ELEVATION - DEMOLITION 3/4" = 1'-0"



BUILDING NOTIFICATION SWITCH BANK -EMERGENCY LOCKDOWN TOGGLE SWITCH -

3 SOUTH EUGENE EXISTING CLOSET DEVICES

- EXISTING BOOK SHELF, TO REMAIN

- EXISTING SPEAKER, TO REMAIN - EXISTING FIRE ALARM NOTIFICATION DEVICE, TO REMAIN

WALL SPACE RESERVED FOR NEW DMP 714-18T EXPANDER MODULE – EXISTING DMP 714-16 EXPANDER MODULE -- EXISTING SURFACE RACEWAY, TO REMAIN

– EXISTING SWITCHES, TO REMAIN (TYP. OF 4)

NEW LIFESAFETY POWER #FP0150/250-2C82D8PE4M1 CABINET PROVIDE NEW PLYWOOD BACKBOARD ON EXISTING WALL TO SUPPORT NEW CABINETS -

NEW BATTERY CABINET -



-DISCONNECT, REMOVE AND RELOCATE EXISTING DEVICES TO NEW LOCATION. REFER TO SHEET E02-B.

PULL BACK EXISTING CABLING TO ABOVE ACCESSIBLE CEILING AND SPLICE/EXTEND TO NEW LOCATION. MATCH EXISTING CONDITIONS.

- EXISTING BOOK SHELF, TO REMAIN

- EXISTING SPEAKER, TO REMAIN - EXISTING FIRE ALARM NOTIFICATION DEVICE, TO REMAIN

- EXISTING SURFACE RACEWAY, TO REMAIN

- EXISTING SWITCHES, TO REMAIN (TYP. OF 4)

--- NEW SURFACE PATHWAYS WHERE REQUIRED, TYP.









CONSTRUCTION DRAWING SET	4J SECURITY IMPROVEMENTS PROJECT #: 207	EUGENE SCHOOL DISTRICT 4J
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REVISI #	IONS: DESCRP	. DATE
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1 TYPICAL DMP EXPANDER DIAGRAM - S. EUGENE

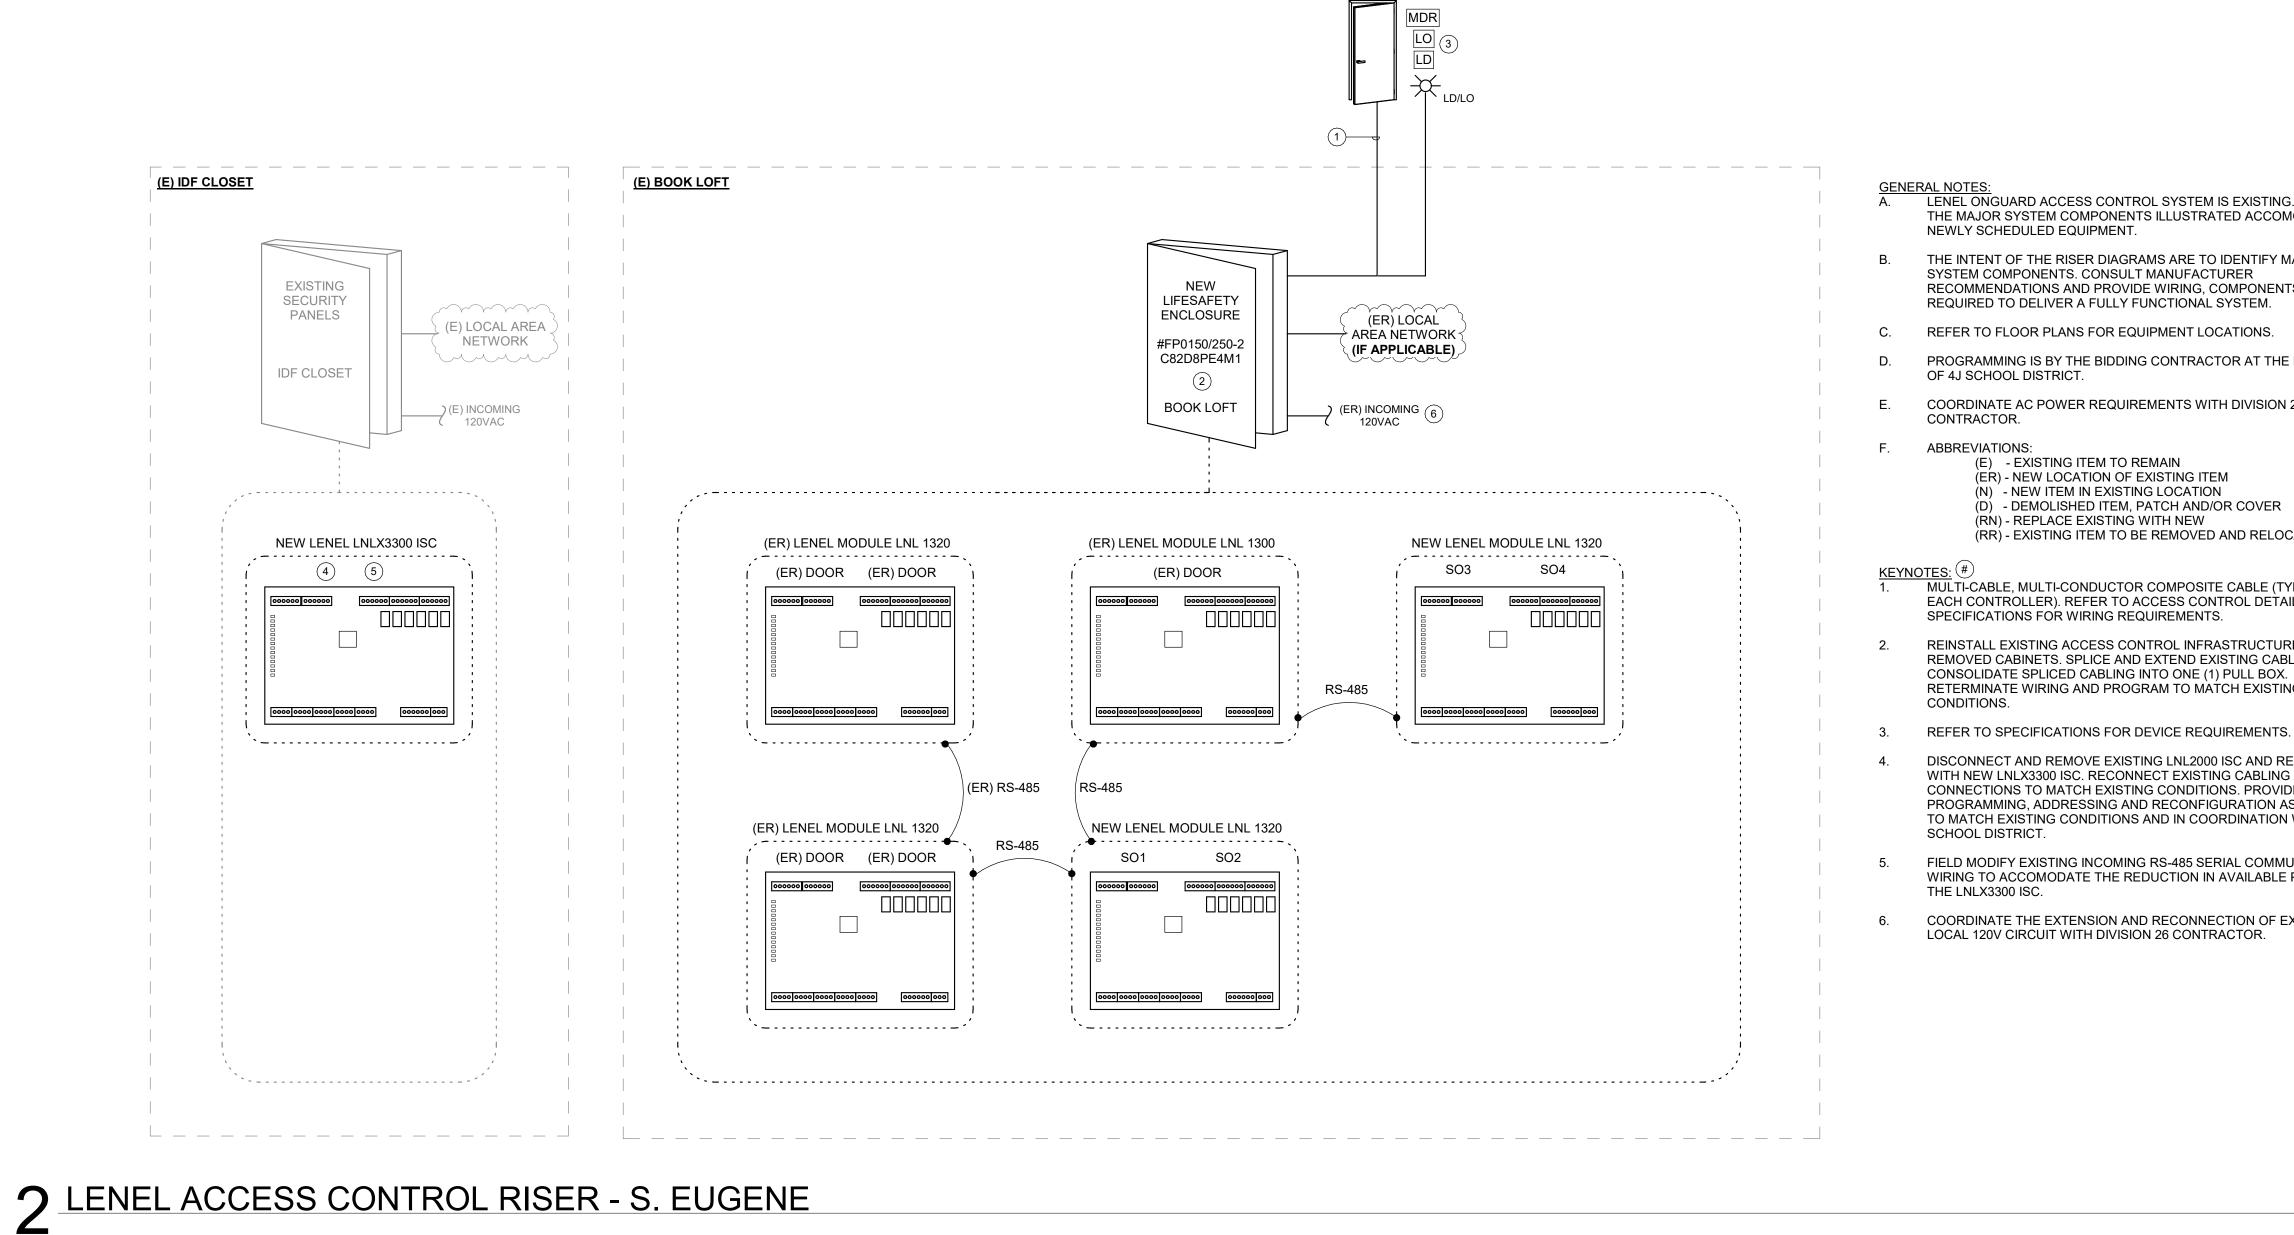

GENERAL NOTES: Α. NEWLY SCHEDULED EQUIPMENT. THE INTENT OF THE RISER DIAGRAMS ARE TO IDENTIFY MAJOR SYSTEM COMPONENTS. CONSULT MANUFACTURER RECOMMENDATIONS AND PROVIDE WIRING, COMPONENTS, ETC

C.

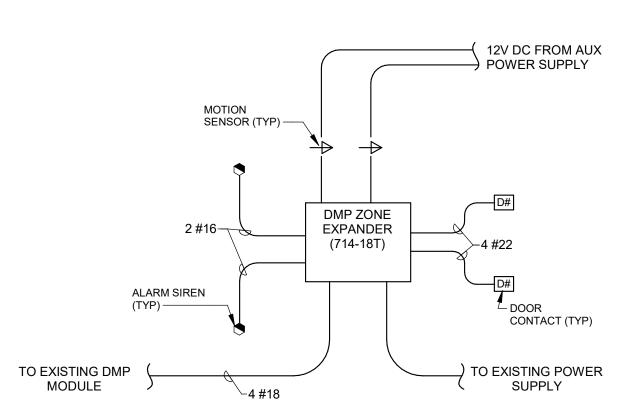D.

AS REQUIRED TO DELIVER A FULLY FUNCTIONAL SYSTEM. REFER TO FLOOR PLANS FOR EQUIPMENT LOCATIONS.

PROGRAMMING IS BY THE BIDDING CONTRACTOR AT THE

SCHEDULED ACCESS CONTROL OPENINGS, PUSHBUTTONS, ETC

DIRECTION OF 4J SCHOOL DISTRICT.

NOT ALL SYMBOLS MAY APPLY TO THIS PROJECT

DMP INTRUSION DETECTION SYSTEM IS EXISTING. PROVIDE THE MAJOR SYSTEM COMPONENTS ILLUSTRATED ACCOMODATE

> LENEL ONGUARD ACCESS CONTROL SYSTEM IS EXISTING. PROVIDE THE MAJOR SYSTEM COMPONENTS ILLUSTRATED ACCOMODATE

THE INTENT OF THE RISER DIAGRAMS ARE TO IDENTIFY MAJOR RECOMMENDATIONS AND PROVIDE WIRING, COMPONENTS, ETC AS

PROGRAMMING IS BY THE BIDDING CONTRACTOR AT THE DIRECTION

COORDINATE AC POWER REQUIREMENTS WITH DIVISION 26

(D) - DEMOLISHED ITEM, PATCH AND/OR COVER (RR) - EXISTING ITEM TO BE REMOVED AND RELOCATED

MULTI-CABLE, MULTI-CONDUCTOR COMPOSITE CABLE (TYP. FOR EACH CONTROLLER). REFER TO ACCESS CONTROL DETAILS AND

REINSTALL EXISTING ACCESS CONTROL INFRASTRUCTURE FROM REMOVED CABINETS. SPLICE AND EXTEND EXISTING CABLING. CONSOLIDATE SPLICED CABLING INTO ONE (1) PULL BOX. RETERMINATE WIRING AND PROGRAM TO MATCH EXISTING

DISCONNECT AND REMOVE EXISTING LNL2000 ISC AND REPLACE WITH NEW LNLX3300 ISC. RECONNECT EXISTING CABLING AND CONNECTIONS TO MATCH EXISTING CONDITIONS. PROVIDE PROGRAMMING, ADDRESSING AND RECONFIGURATION AS REQUIRED TO MATCH EXISTING CONDITIONS AND IN COORDINATION WITH 4J

FIELD MODIFY EXISTING INCOMING RS-485 SERIAL COMMUNICATION WIRING TO ACCOMODATE THE REDUCTION IN AVAILABLE PORTS ON

COORDINATE THE EXTENSION AND RECONNECTION OF EXISTING







4J SECURITY IMPROVEMENTS PROJECT #. 207	EUGENE SCHOOL DISTRICT 4J			
SHEET TITLE: TECHNOLOGY RISER DIAGRAMS S. EUGENE				
ONS:				
DESCRP.	DATE			

ISSUE DATE:	03.15.23

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BRANCH PANEL: C4A

MOUNTING: RECESSED ENCLOSURE: NEMA 1

RECESSED

NOTES:

CIRCUIT DESCRIPTION	Р	AMP	CKT NO		A		в	0	2	CKT NO	AMP	Р	CIRCUIT DESCRIPTION
(E) OFFICE RM### RECEPTACLES	1	20 A	1	720	0					2	20 A	1	(E) SPARE
(E) REC PRINCIPAL'S OFFICE	1	20 A	3			360	0			4	20 A	1	(E) SPARE
(E) REC MAIN OFFICE RM #3,4	1	20 A	5					720		6			
REC MAIN OFFICE RM #7, WAITING	1	20 A	7	360						8			
REC MAIN OFFICE - FRONT DESK	1	20 A	9			900				10			
			11							12			
			13							14			
			15							16			
			17							18			
			19							20			
			21							22			
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			29							30			
			31							32			
			33							34			
			35							36			
			37							38			
			39							40			
			41							42			
				108	0 VA	126	0 VA	720	VA				
			L	c	A	1.	I A	6	Δ				

"(E)" INDICATES EXISTING CIRCUIT BREAKER. CONNECT NEW LOADS AS INDICATED,

LOAD CLASSIFICATION	CONNECTED LOAD	DEMAND FACTOR	ESTIMATED	PANEL	TOTALS
RECEPTACLE	3060 VA	100.00%	3060 VA		
				TOTAL CONN. LOAD:	3060 VA
				TOTAL EST. DEMAND:	3060 VA
				TOTAL CONN.:	8 A
				TOTAL EST. DEMAND:	8 A
NOTES					I

NOTES:

VOLTAGE:	120/208 WYE
PHASES:	3
WIRES:	4

SCCR RATING: 10,000 A MAINS TYPE: MLO MAINS RATING: 125 A MCB RATING: 1 A










CONSTRUCTION DRAWING SET	4J SECURITY IMPROVEMENTS PROJECT #: 2207 EUGENE SCHOOL DISTRICT 4J	
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REVIS #	IONS: DESCRP. DATE	
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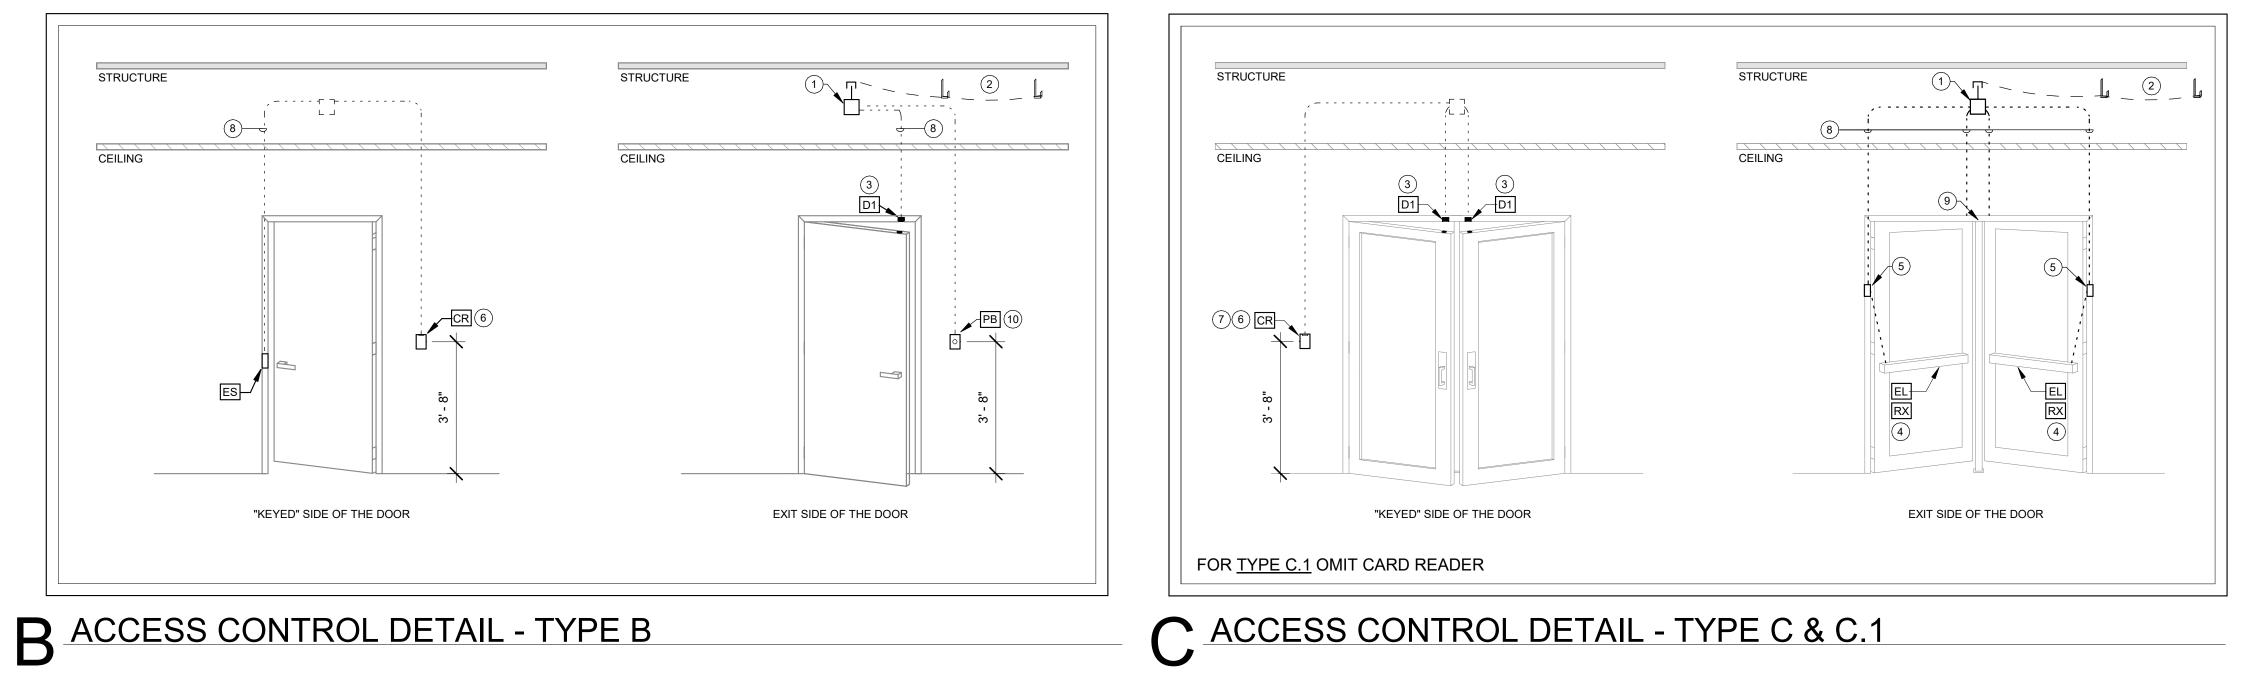
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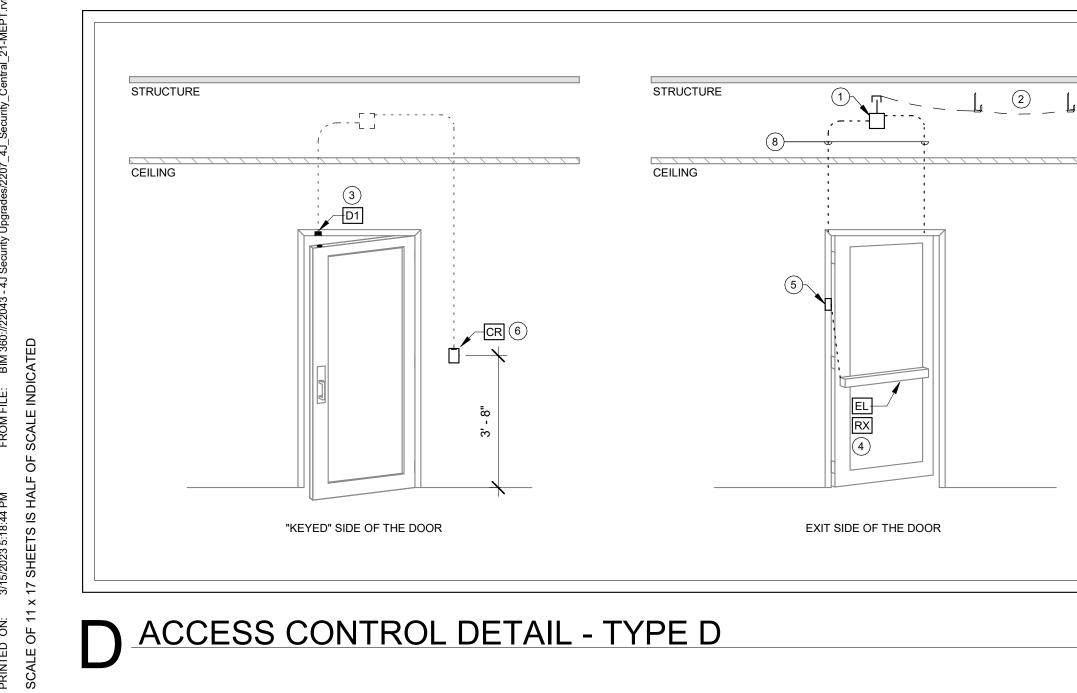





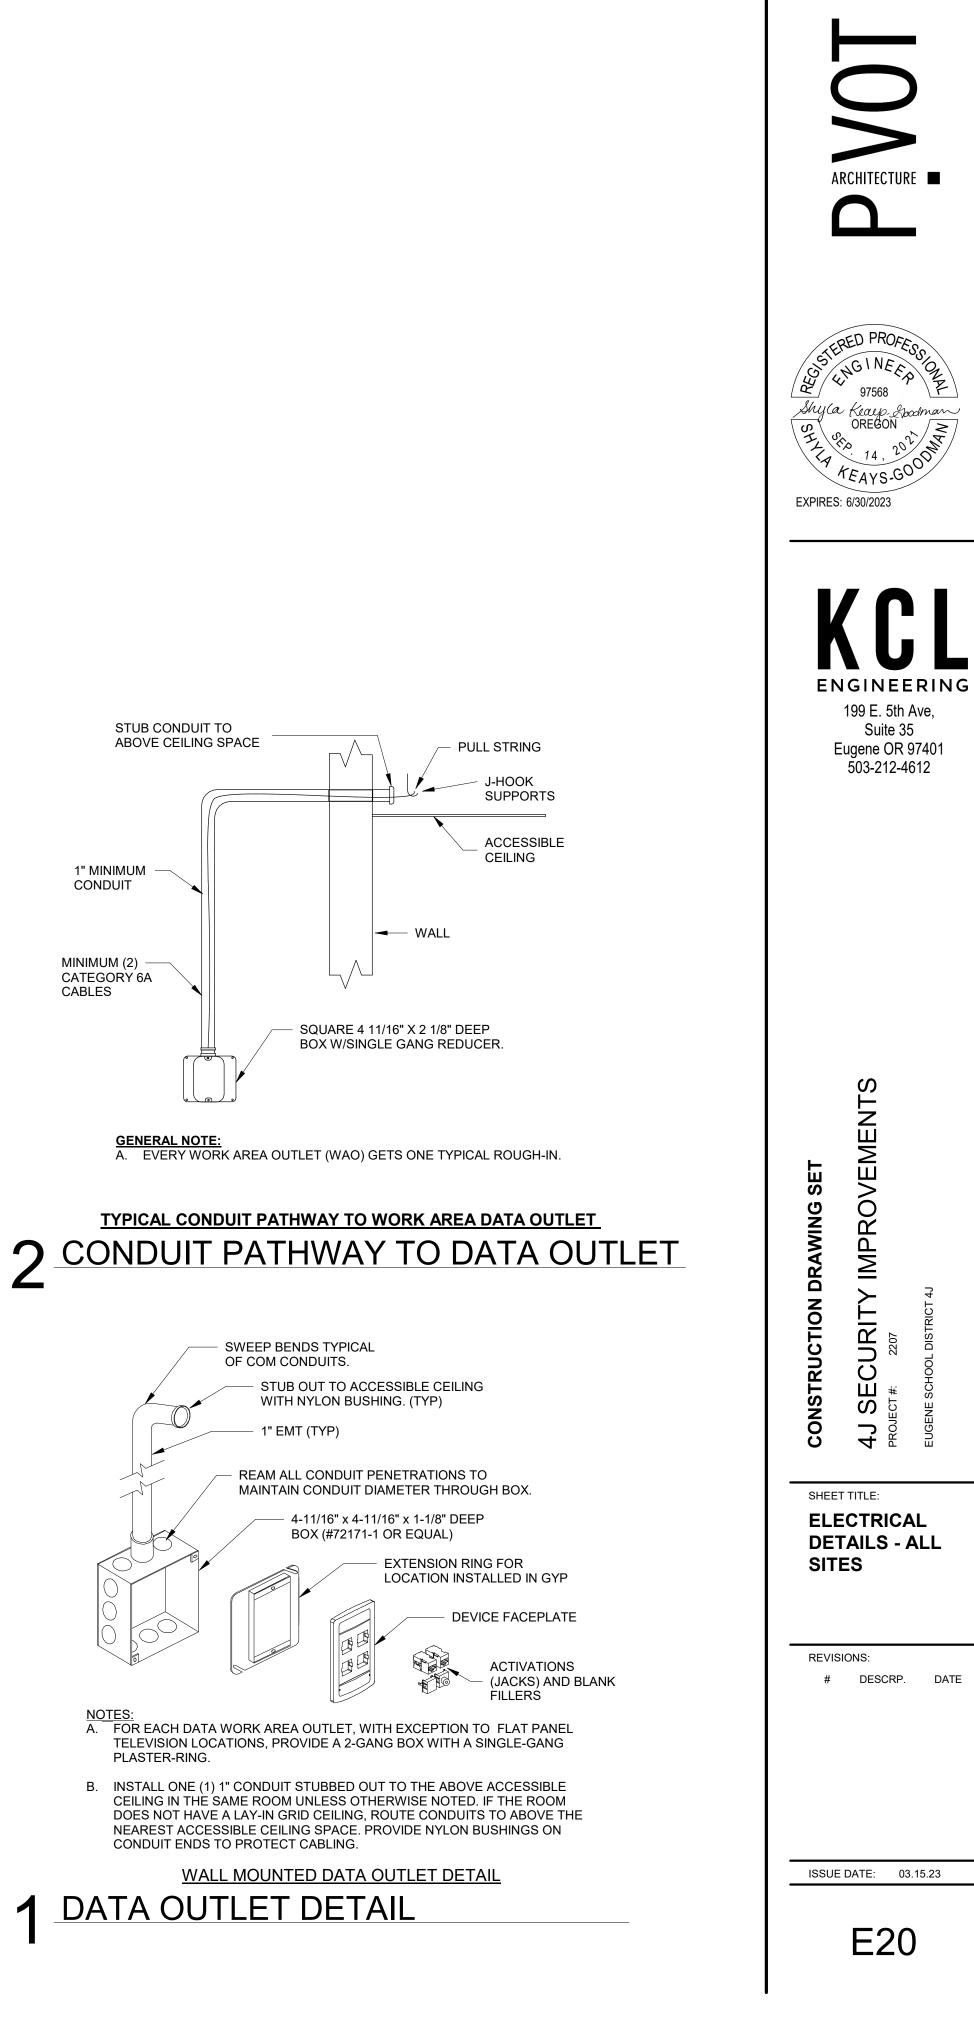

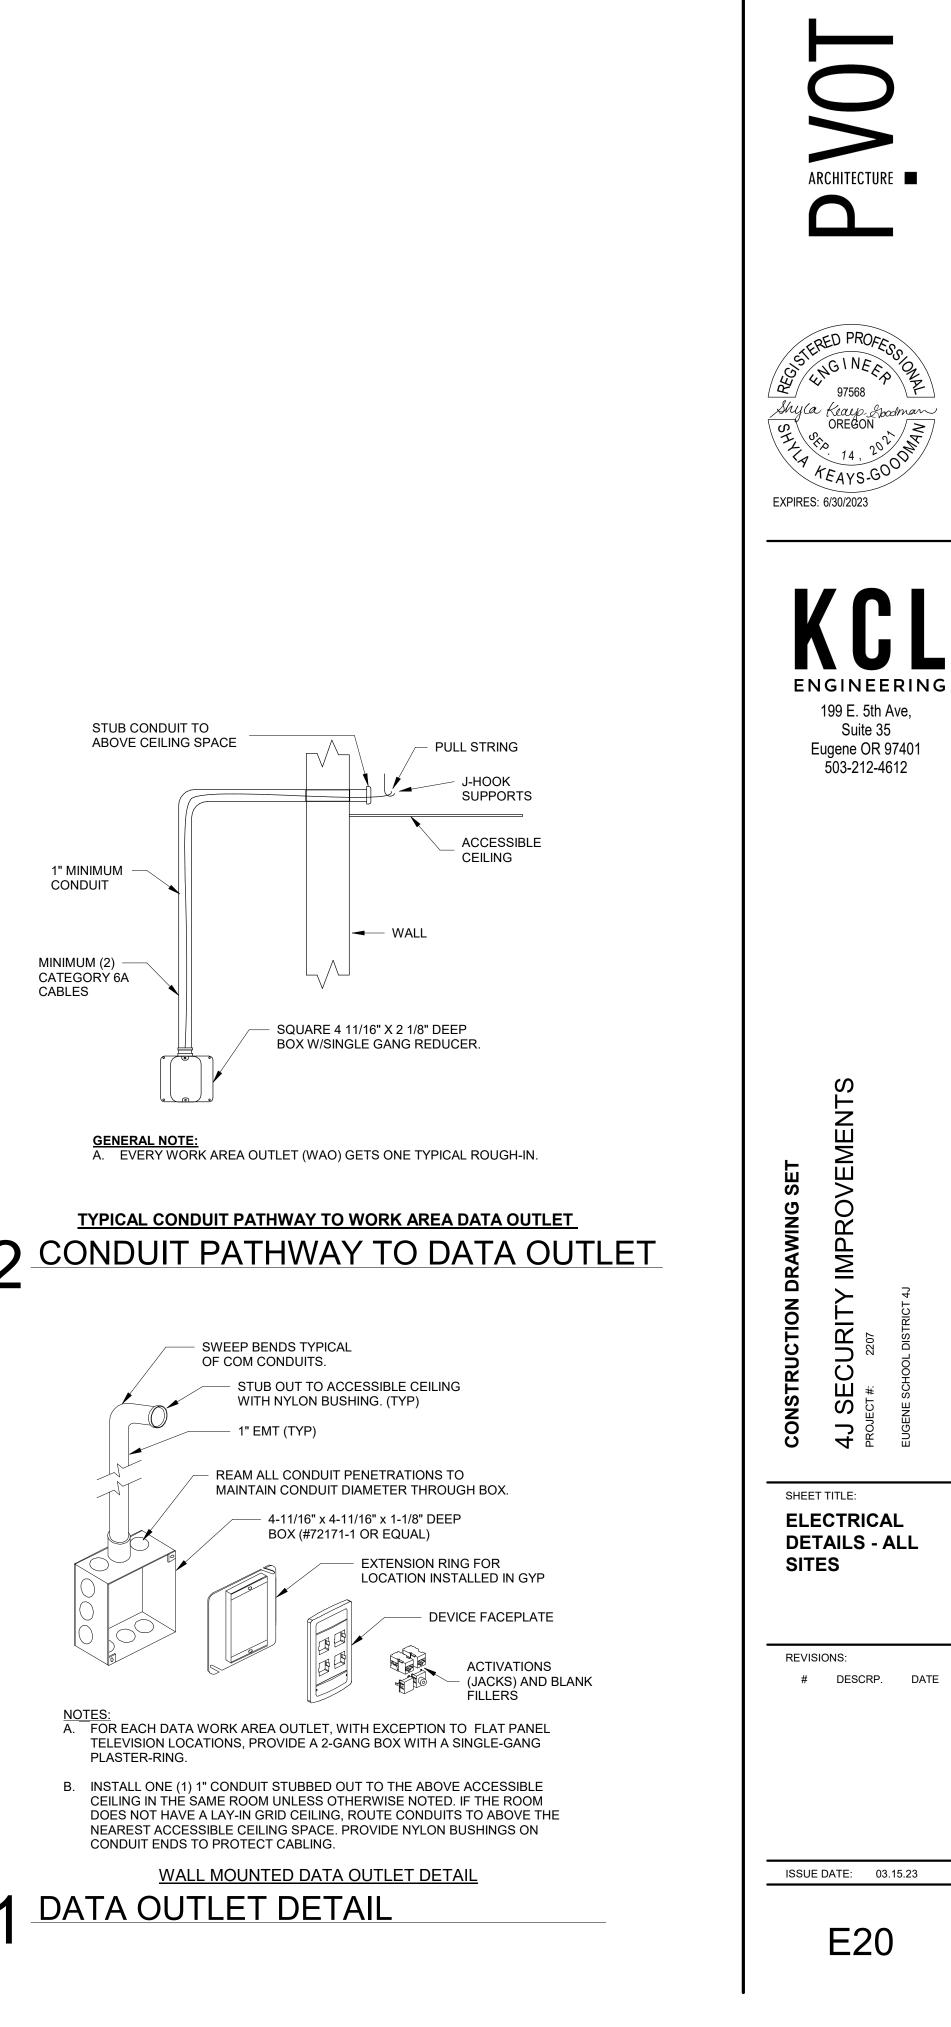A ACCESS CONTROL DETAIL - TYPE A

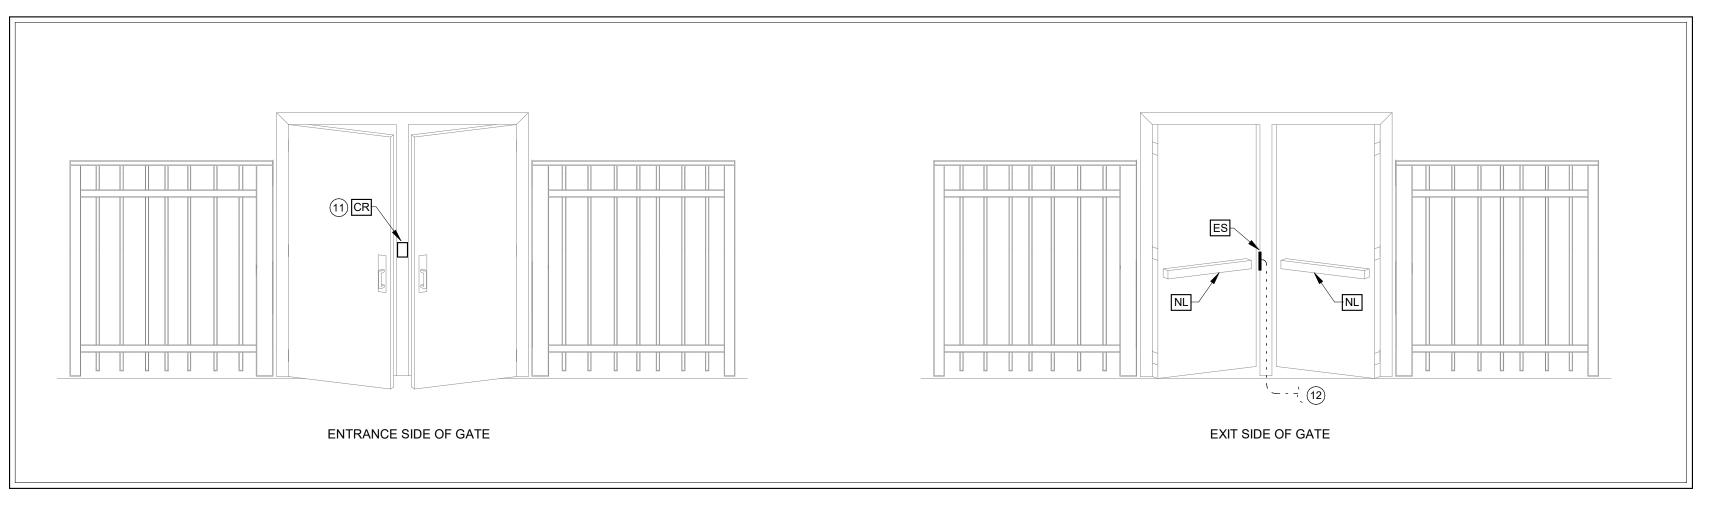



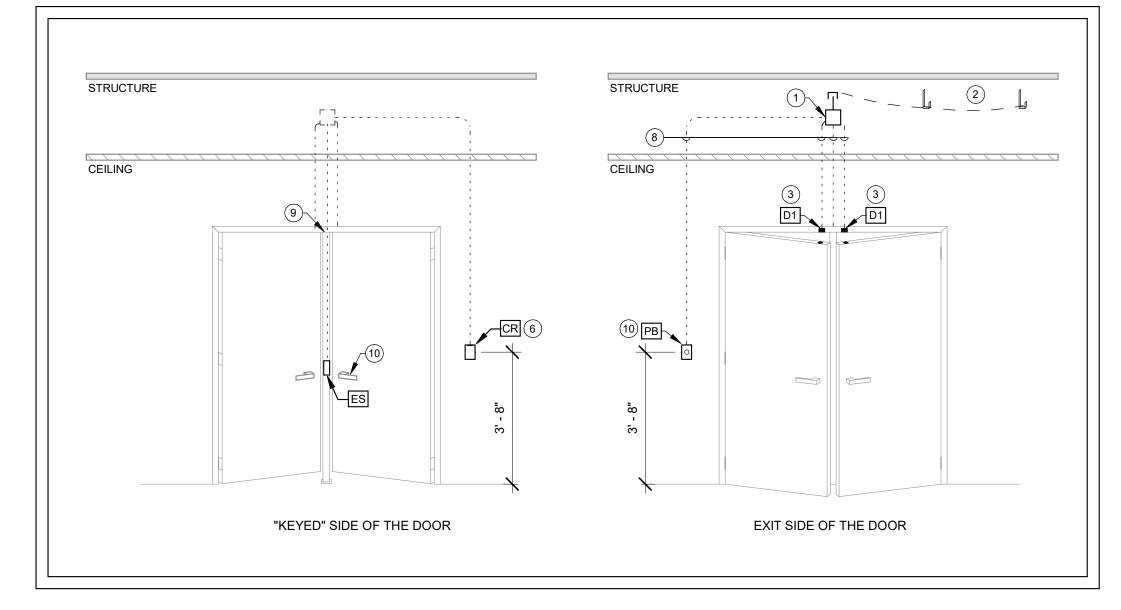

ACCESS CONTROL DETAIL - TYPE E

GENERAL NOTES:

- ACCESS CONTROL SYSTEM SHALL BE PROVIDED BY THE BIDDING Α. CONTRACTOR. DETAILS ILLUSTRATED HERE ARE INTENDED TO ILLUSTRATE PATHWAY, ROUGH-IN DEVICE AND CABLING REQUIREMENTS. REVIEW SPECIFICATION 08 71 00 FOR SPECIFIC ELEMENTS SCHEDULED AT EACH OPENING.
- LENEL ONGAURD ACCESS CONTROL SYSTEM IS EXISTING. THE CONTRACTOR IS RESPONSIBLE FOR COORDINATING PROGRAMMING WITH 4J SCHOOL DISTRICT SECURITY DEPARTMENT.
- PROVIDE ELECTRIFIED LOCKSETS WITH CENTRALIZED LOW VOLTAGE C. POWER. INDIVIDUAL POWER SUPPLIES INSTALLED AT EACH OPENING IS NOT ACCEPTABLE. COORDINATE FINAL VOLTAGE AND AMPERAGE REQUIREMENTS WITH THE SPECIFIED DOOR HARDWARE.
- D IT IS THE INTENT THAT PATHWAYS AND ROUGH-IN SERVING ACCESS CONTROL DEVICES ARE RECESSED AND CONCEALED. EXPOSED CABLING SHALL NOT BE ACCEPTED UNLESS APPROVED BY THE ARCHITECT. WHERE SURFACE MOUNT IS REQUIRED, ENSURE PATHWAYS ARE PROVIDED IN ACCORDANCE WITH SPECIFICATIONS AND PAINTED TO MATCH SURROUNDING FINISHES. DEVICES INCLUDING CARD READERS MAY BE LOCATED ON A
- DIFFERENT WALL. REFER TO THE DRAWING SET AND ELEVATIONS FOR WHICH SIDE COMPONENTS ARE LOCATED. DETAILS NOT INTENDED TO ACCURATELY ILLUSTRATE CEILING TYPES,
- CEILING AND DECK HEIGHTS, DOOR SWING OR DOOR FINISHES. COORDINATE EACH OPENING'S SPECIFIC ROUGH-IN AND PATHWAY NEEDS WITH ARCHITECTURAL PLANS AND ELEVATIONS.
- ALL CONDUIT SHALL BE PROVIDED A PULL STRING TO ALLOW EASE OF G. CABLING INSTALLATION.

KEYNOTES:


- ACCESS CONTROL JUNCTION BOX, PROVIDE ONE (1) 4-SQUARE BOX ABOVE THE NEAREST CONCEALED, ACCESSIBLE CEILING SPACE. THIS BOX SHALL BE USED AS A JUNCTION POINT FOR ALL DOOR DEVICE WIRING.
- 2. PROVIDE SECURITY MANAGEMENT SYSTEM CABLING BACK TO THE HEAD END /CONTROL CABINET USING ITS OWN DEDICATED PATHWAYS. PROVIDE SUPPORTS PER SPECIFICATIONS TO SERVE THIS INFRASTRUCTURE.
- PREPARE FRAME FOR THE INSTALLATION OF DOOR CONTACT. 3 CONTACT SHALL BE CONNECTED TO THE INTRUSION DETECTION SYSTEM. COORDINATE ZONING WITH 4J SCHOOL DISTRICT.
- THE SCHEDULED DOOR HARDWARE HOSTS BUILT-IN MOMENTARY SWITCHES TO INTERFACE THE REQUST TO EXIT FUNCTION FOR ACCESS CONTROL.
- ELECTRONIC POWER TRANSFER. PROVIDE A 1/2" PATHWAY TO THE 5. FRAME TO SERVE THE ELECTRIFIED EXIT DEVICE.
- PROVIDE SINGLE GANG JUNCTION BOX AND (1) 1" CONDUIT PATHWAY 6 TO SERVE NEW CARD READER AND CABLING. CARD READER IS OWNER-FURNISHED, CONTRACTOR-INSTALLED.
- 7 CARD READER AND CABLING IS EXISTING TO REMAIN AT DOOR "SH3", PROTECT IN PLACE.
- PROVIDE A 1/2" CONDUIT PATHWAY TO THE FRAME. 8.
- CENTER MULLION. 9.
- PROVIDE SINGLE GANG JUNCTION BOX TO SERVE PUSHBUTTON 10. REQUEST TO EXIT, CAMDEN #CM-353.
- SURFACE MOUNT CARD READER ON CENTER POST. PROVIDE DEVICE 11. WITH HID IP65GSKT GASKET KIT. CARD READER IS OWNER-FURNISHED, CONTRACTOR-INSTALLED.
- ROUTE SECURITY MANAGEMENT SYSTEM CABLING UNDERGROUND 12. TO MDF/IDF LOCATION, REFER TO DRAWINGS FOR ROUTING REQUIREMENTS AT EACH INSTANCE.

DEVICE AND CABLING LEGEND:

- D1 FLUSH-MOUNT DOOR POSITION SWITCH 22 AWG / 4 CONDUCTOR
- D2 SURFACE-MOUNT DOOR POSITION SWITCH- 22 AWG / 4 CONDUCTOR
- CR CARD READER (OFCI) 22 AWG / 8 CONDUCTOR
- EL ELECTRIFIED EXIT DEVICE 12 AWG / 2 CONDUCTOR
- ES ELECTRIFIED STRIKE 16 AWG / 2 CONDUCTOR
- NL NON-ELECTRIFIED LATCH (MECHANICAL EXIT) NO WIRING NECESSARY

CABLING NOTES:


- CABLING DEFINITIONS ARE BASED ON DISTRICT STANDARD WIRING APPROACH. COORDINATE WIRE GAUGE WITH VOLTAGE, AMPERAGE, AND DISTANCE REQUIREMENTS.
- CABLING SHALL BE STRANDED TYPE WITH ORANGE JACKET. R
- REFER TO SPECIFICATIONS FOR ADDITIONAL CABLING С

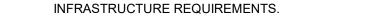







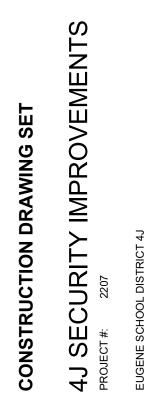

SHEET TITLE: ACCESS CONTROL DOOR DETAILS - ALL SITES

REVISIONS: # DESCRP. DATE

ISSUE DATE: 03.15.23

MECHANICAL - GENERAL NOTES

- COORDINATE MECHANICAL AND ELECTRICAL WORK WITH ALL OTHER TRADES. BEGIN ASSEMBLIES, SHEET METAL, ALL PIPING SYSTEMS, LIGHT FIXTURES, CONDUITS, CABLE SPECIFICATIONS FOR THIS PROJECT. CONTRACTOR IS RESPONSIBLE FOR REWORK ASSOCIATED WITH FAILURE TO COORDINATE.
- OWNER STANDARDS INTO WORK.
- WARNING CALL 48 HOURS BEFORE YOU DIG: LAW REQUIRES ANYONE DOING ANY 3. WITHIN 18 INCHES OF ANY LOCATE MARK OR FLAG. ONE CALL 811.
- 4. TRADE IS RESPONSIBLE TO FIRESTOP PENETRATIONS THROUGH RATED ASSEMBLIES.
- EACH TRADE IS RESPONSIBLE FOR MAKING PENETRATIONS WHERE REQUIRED IN EXISTING 5. CAULK OVERCUT.
- COVER EXPOSED WALL PENETRATIONS WITH ESCUTCHEONS OR SHEET METAL AS 6. APPROPRIATE.
- NOISE TRANSFER BETWEEN SPACES.
- 8. TO BRING IN NEW EQUIPMENT. PATCH ALL OPENINGS CREATED AND FINISHED WITH MATERIALS TO MATCH EXISTING CONDITIONS. INCLUDE THIS WORK IN BID.
- [ON COMPLETION OF THE INSTALLATION, COOPERATE WITH THE OWNER TO PROVIDE g AND SYSTEMS. PROVIDE ALL FACILITIES AND EQUIPMENT AND COMPLETE ALL TESTS REQUIRED FOR ADJUSTMENTS AND BALANCING TO ESTABLISH THE PROPER PERFORMANCE OF EQUIPMENT.]
- [PROVIDE WARRANTIES FOR ALL EQUIPMENT AND INSTALLATION PER THE CONTRACT 10. DOCUMENTS.]

MECHANICAL – DEMOLITION NOTES

- MECHANICAL DEMOLITION DRAWINGS SHOWING EXISTING CONDITIONS HAVE BEEN THOSE SHOWN ON THE PLANS.
- BE FAMILIAR WITH EXISTING MECHANICAL SYSTEMS THAT WILL BE AFFECTED BY THE 2 SHUT-DOWN AFTER PERMISSION FROM THE OWNER IS GRANTED.
- REMOVE PIPING, HANGERS, DUCTWORK, GRILLES, REGISTERS, DIFFUSERS, ETC. THAT ARE 3.
- UNLESS EQUIPMENT TO BE REMOVED IS NOTED AS OWNER'S SALVAGE, DISPOSE OF 4. EQUIPMENT AND/OR MATERIALS INDICATED TO BE REMOVED PROMPTLY.
- REMOVE ALL ABANDONED PIPING AND DUCTWORK THAT IS EXPOSED OR ACCESSIBLE WITHOUT WALL OR CEILING DEMOLITION. REFER TO ARCH PLANS FOR CEILINGS TO BE REMOVED.
- REPAIR OR REPLACE TELECOMMUNICATIONS FACILITIES OR EQUIPMENT FOUND TO BE 6. DAMAGED OR NON-FUNCTIONAL AFTER SUBSTANTIAL COMPLETION.

<u>HVAC - NOTES</u>

- NOTE #1.
- PROVIDE A COMPLETE HVAC SYSTEM, INCLUDING SUPPLY, RETURN, EXHAUST, AND 2. GRILLES, REGISTERS, AND ALL APPURTENANCES. INSTALL ALL EQUIPMENT PER CODES AND REQUIREMENTS.
- DRAWING PLANS, SCHEMATICS, AND DIAGRAMS INDICATE GENERAL LOCATION AND SYSTEMS AS INDICATED UNLESS DEVIATIONS TO LAYOUT ARE APPROVED BY ARCHITECT/ENGINEER.
- 4 NOT INCLUDE INSULATION REQUIREMENTS.
- 5 ASSEMBLY RATINGS.
- CONTINUE DUCT AND PIPE INSULATION THROUGH WALLS, FLOORS, AND CEILING 6. IN DUCTWORK. SEAL AROUND DUCT INSULATION AT WALL PENETRATIONS.

INSTALLATION AND ROUGH-IN AFTER COORDINATION WITH ALL TRADES ASSOCIATED WITH THE INSTALLATION IS COMPLETE. COORDINATE BUILDING STRUCTURE, ARCHITECTURAL TRAYS, ETC. REFER TO ALL GENERAL, MECHANICAL, AND ELECTRICAL DRAWINGS AND

INCORPORATE MECHANICAL SPECIFICATIONS, DRAWINGS, STATE AND LOCAL CODES, AND

EXCAVATION, FENCING, PLANTING OR DRILLING TO CALL 48 HOURS IN ADVANCE. HAND DIG

REFER TO ARCHITECTURAL SPECIFICATIONS FOR THROUGH-PENETRATION FIRESTOPPING AND TO ARCHITECTURAL CODE PLAN FOR FIRE RATED WALLS, FLOORS, AND CEILINGS. EACH

WALLS, FLOORS, CEILINGS, AND ROOFS. MAKE PENETRATIONS NEAT. PATCH, CONCEAL, OR

CAULK ALL CONCEALED AND EXPOSED PIPING AND DUCT WALL PENETRATIONS TO PREVENT

CREATE OPENINGS IN THE BUILDING THAT ARE REQUIRED TO REMOVE EXISTING ITEMS AND

TESTING, ADJUSTING, AND BALANCING TO OBTAIN PROPER OPERATION OF ALL EQUIPMENT

PREPARED BASED ON NON-DESTRUCTIVE FIELD OBSERVATION AND AS-BUILT DRAWINGS PROVIDED BY THE OWNER. FIELD VERIFY EXISTING SYSTEMS BEFORE BEGINNING WORK. NOTIFY ARCHITECT/ENGINEER IF EXISTING CONDITIONS ARE MATERIALLY DIFFERENT THAN

DEMOLITION WORK. OBTAIN PERMISSION FROM THE OWNER'S REPRESENTATIVE TO SHUT OFF SERVICES OR SYSTEMS THAT AFFECT AREAS BEYOND THE LIMITS OF THE IMMEDIATE DEMOLITION AREA. INFORM THE OWNER'S REPRESENTATIVE OF THE REASON FOR AND DURATION OF THE SHUTDOWN. MINIMIZE IMPACT TO OTHER AREAS. PROCEED WITH THE

INDICATED TO BE REMOVED IN A TIMELY MANNER IN ACCORDANCE WITH THE GENERAL DEMOLITION SPECIFICATIONS. COORDINATE WITH THE OWNER AND OTHER CONTRACTORS.

COORDINATE WORK WITH ALL OTHER TRADES AS DESCRIBED IN MECHANICAL GENERAL

VENTILATION DUCTWORK; MECHANICAL EQUIPMENT, SUPPORTS, HANGERS, DIFFUSERS, MANUFACTURER'S RECOMMENDATIONS. INSTALL SYSTEM TO MEET ALL CITY AND STATE

ARRANGEMENT OF DUCT SYSTEM, INDICATED DUCT LOCATIONS, CONFIGURATIONS, AND ARRANGEMENTS WERE USED TO SIZE DUCTS AND CALCULATE FRICTION LOSS FOR AIR-HANDLING EQUIPMENT SIZING AND FOR OTHER DESIGN CONSIDERATIONS. INSTALL DUCT

ALL DUCT DIMENSIONS INDICATED ARE INTERIOR FREE AREA DUCT DIMENSIONS AND DO

SEAL ALL WALL AND FLOOR DUCT PENETRATIONS. PROVIDE FIRE CAULKING ASSEMBLIES FOR PENETRATIONS OF RATED ASSEMBLIES. REFER TO ARCHITECTURAL DRAWINGS FOR

PENETRATIONS UNBROKEN, EXCEPT WHERE FIRE OR FIRE/SMOKE DAMPERS ARE INSTALLED


PIPE FITTINGS					
SINGLE LINE		DOUBLE LIN	DOUBLE LINE		
ር	ELBOW	₽	ELBOW		
Ч	ELBOW - DOUBLE BRANCH	ц.	ELBOW - DOUBLE BRANCH		
— Э	ELBOW - OUTLET DOWN		ELBOW - OUTLET DOWN		
— 0	ELBOW - OUTLET UP		ELBOW - OUTLET UP		
ſ	ELBOW - LONG RADIUS	ſ	ELBOW - LONG RADIUS		
ר	ELBOW - SHORT RADIUS	æ	ELBOW - SHORT RADIUS		
Ч	45° ELBOW	Ď	45° ELBOW		
Ч	TEE - VENT	ψ	TEE - VENT		
ידי	TEE - SANITARY	ф	TEE - SANITARY		
	TEE - OUTLET DOWN		TEE - OUTLET DOWN		
0	TEE - OUTLET UP		TEE - OUTLET UP		
	TEE - SIDE OUTLET DOWN		TEE - SIDE OUTLET DOWN		
	TEE - SIDE OUTLET UP		TEE - SIDE OUTLET UP		
Ψ	CROSS - VENT	ф.	CROSS - VENT		
\mathbf{F}	CROSS - SANITARY	÷	CROSS - SANITARY		
¥	LATERAL	₽	LATERAL		
\overline{Z}	TEE - SINGLE SWEEP "COMBO WYE"	F	TEE - SINGLE SWEEP "COMBO WYE"		
4	REDUCER - CONCENTRIC	0¤	REDUCER - CONCENTRIC		
- 7 -	REDUCER - ECCENTRIC	œ	REDUCER - ECCENTRIC		
3	CAPPED CONNECTION		CAPPED CONNECTION		
-1	FLANGED CONNECTION		FLANGED CONNECTION		

PIPING LEGEND - MECHANICAL

LOW PRESSURE STEAM LPS LPC LOW PRESSURE STEAM CONDENSATE

MECHANICAL ABBREVIATIONS

ABSOR	ABSORPTION	FT	FINTUBE
ACU	AIR CONDITIONING UNIT	FTG	FOOTING
AD	ACCESS DOOR OR AREA DRAIN	GA	GAGE
AFF	ABOVE FINISHED FLOOR	GAL	GAULON
AFF	ABOVE FINISHED FLOOR	GALV	GALUON GALVANIZED
		GALV GC	
AHU			GENERAL CONTRACTOR
AV	AIR VENT BOTTOM	GW	GREASE WASTE
BOT BTU		GPH	GALLONS PER HOUR
-	BRITISH THERMAL UNIT	GPM	GALLONS PER MINUTE
BTUH	BTU PER HOUR	HR	HOUR
BV	BALL VALVE	HTG	HEATING
CA		HB	HOSE BIBB
CB	CATCH BASIN	ISP	INTERNAL STATIC PRESSURE
CENT	CENTRIFUGAL	JR	JANITOR RECEPTOR
CFM	CUBIC FEET PER MINUTE	LAV	
CI	CAST IRON	LDBT	LEAVING DRY BULB
CL	CENTER LINE		TEMPERATURE
COND	CONDENSATE	LWT	LEAVING WATER
CO	CLEAN OUT		TEMPERATURE
CONC	CONCRETE	LWBT	LEAVING WET BULB
CONTR	CONTRACTOR		TEMPERATURE
CP	CONDENSATE PUMP/CIRC. PUMP	MB	MOP BASIN
CU	COPPER	MBH	1000 BTUH
CUH	CABINET UNIT HEATER	MC	MECHANICAL CONTRACTOR
CWP	CIRCULATING WATER PUMP	MECH	MECHANICAL
DDC	DIRECT DIGITAL CONTROLS	MH	MANHOLE
DN	DOWN	NTS	NOT TO SCALE
DR	DRAIN	OA	OUTSIDE AIR
DS	DOWNSPOUT	OD	OVERFLOW ROOF DRAIN
EA	EXHAUST AIR	PC	PLUMBING CONTRACTOR
EAT	EXHAUST AIR TEMPERATURE	PSI	POUNDS PER SQUARE INCH
EC	ELECTRICAL CONTRACTOR	PRV	POWER ROOF VENTILATOR
EDBT	ENTERING DRY BULB	PRV	PRESSURE REDUCING VALVE
	TEMPERATURE	PV	PRESSURE VENT
EEW	EMERGENCY EYE WASH	PVC	POLYVINYL CHLORIDE
EF	EXHAUST FAN	RA	RETURN AIR
EJ	EXPANSION JOINT	RD	ROOF DRAIN
EQUIP	EQUIPMENT	RH	RELATIVE HUMIDITY
ESE	EMERGENCY SHOWER/EYEWASH	RTU	ROOF TOP UNIT
EST	EXTERNAL STATIC PRESSURE	RV	RELIEF VALVE
EWBT	ENTERING WET BULB	RVT	ROOF VENT TERMINATION
LIVEI	TEMPERATURE	SK	SINK
EWC	ELECTRIC WATER COOLER	SA	SUPPLY AIR
EWT	ENTERING WATER	SH	SHOWER
	TEMPERATURE	SO	STORM OVERFLOW
EX	EXISTING	ST	STORM
EXH	EXHAUST	TCC	TEMPERATURE CONTROL
EXP	EXPANSION	100	CONTRACTOR
FAI	FRESH AIR INTAKE	TYP	TYPICAL
FCU	FAN COIL UNIT	UH	UNIT HEATER
FD	FLOOR DRAIN		
FDC	FIRE DEPARTMENT CONNECTION	UR UV	URINAL UNIT VENTILATOR
FLEX	FLEXIBLE	VA	
FLR		VTR	VENT THROUGH ROOF
FPM	FEET PER MINUTE	WB	WALL BOX - CONDENSATE
FPS	FEET PER SECOND	WC	WATER CLOSET
FS	FLOOR SINK	WHA	
FSEC	FOOD SERVICE EQUIPMENT CONSULTANT	WH	WATER HEATER

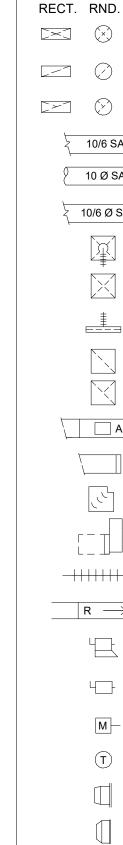

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GENERAL

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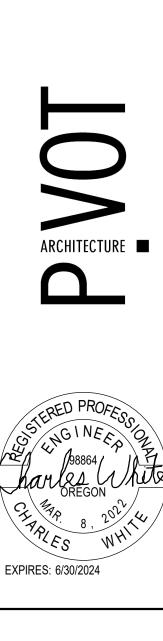
_ ;	SYMBOLS	
		EXISTING = HALFTONE LINEWORK
		NEW = DARK LINEWORK
		DEMO = DASHED DARK LINEWORK
		BELOW GRADE = LONG DASHED DARK LINEWORK
	NEW CONNECT	
	POINT OF DISC	ONNECT
	KEYNOTE	
	EQUIPMENT IDE	ENTIFICATION TAG
М		IG REFERENCE TAG, SIM-SIMILAR, TYP-TYPICAL, OPP-OPPOSITE
	SHEET REFERE	NCE
4		

SECTION CUT REFERENCE TAG, SIM-SIMILAR, TYP-TYPICAL, OPP-OPPOSITE SHEET REFERENCE

INTERIOR ELEVATION DRAWING REFERENCE TAG

H.V.A.C. / DUCTWORK SYMBOLS

. RND. OVAL	
(\mathbf{x})	SUPPLY (SA), OUTSIDE (OA), VENTILATION (VA) AIR DUCT (UP / DOWN / SECTION)
	RETURN (RA) AIR DUCT (UP / DOWN / SECTION)
(EXHAUST (EA) AIR DUCT (UP / DOWN / SECTION)
10/6 SA	RECTANGULAR DUCT (WIDTH / HEIGHT / SYSTEM)
10 Ø SA	ROUND DUCT (DIAMETER / SYSTEM)
10/6 Ø SA	FLAT OVAL DUCT (WIDTH / HEIGHT / SYSTEM)
	SUPPLY DIFFUSER
	SUPPLY REGISTER OR GRILLE
	LINEAR SLOT DIFFUSER
	RETURN REGISTER OR GRILLE
	EXHAUST REGISTER OR GRILLE
	DUCT ACCESS DOOR
	DUCT END CAP
	TURNING VANES
	VAV TERMINAL UNIT
++++++++	FLEXIBLE DUCTWORK
$R \longrightarrow$	ELEVATION CHANGE (RISE OR DROP)
4	HIGH EFF. TAKE OFF FITTING w/ VOLUME DAMPER
4	VOLUME DAMPER
M	MOTORIZED ACTUATOR
T	THERMOSTAT
	SIDE WALL DIFFUSER
	EXTERIOR LOUVER
X-# #x#/CFM	FIXTURE IDENTIFICATION TAG NECK SIZE / CFM





CONSTRUCTION DRAWING SET	4J SECURITY IMPROVEMENTS	PROJECT #: 2207	EUGENE SCHOOL DISTRICT 4J	
SHEET	SHEET TITLE:			

MECHANICAL GENERAL NOTES & SYMBOLS


REVISIO	ONS:
#	

DESCRP. DATE

ISSUE DATE: 03.15.23

M00



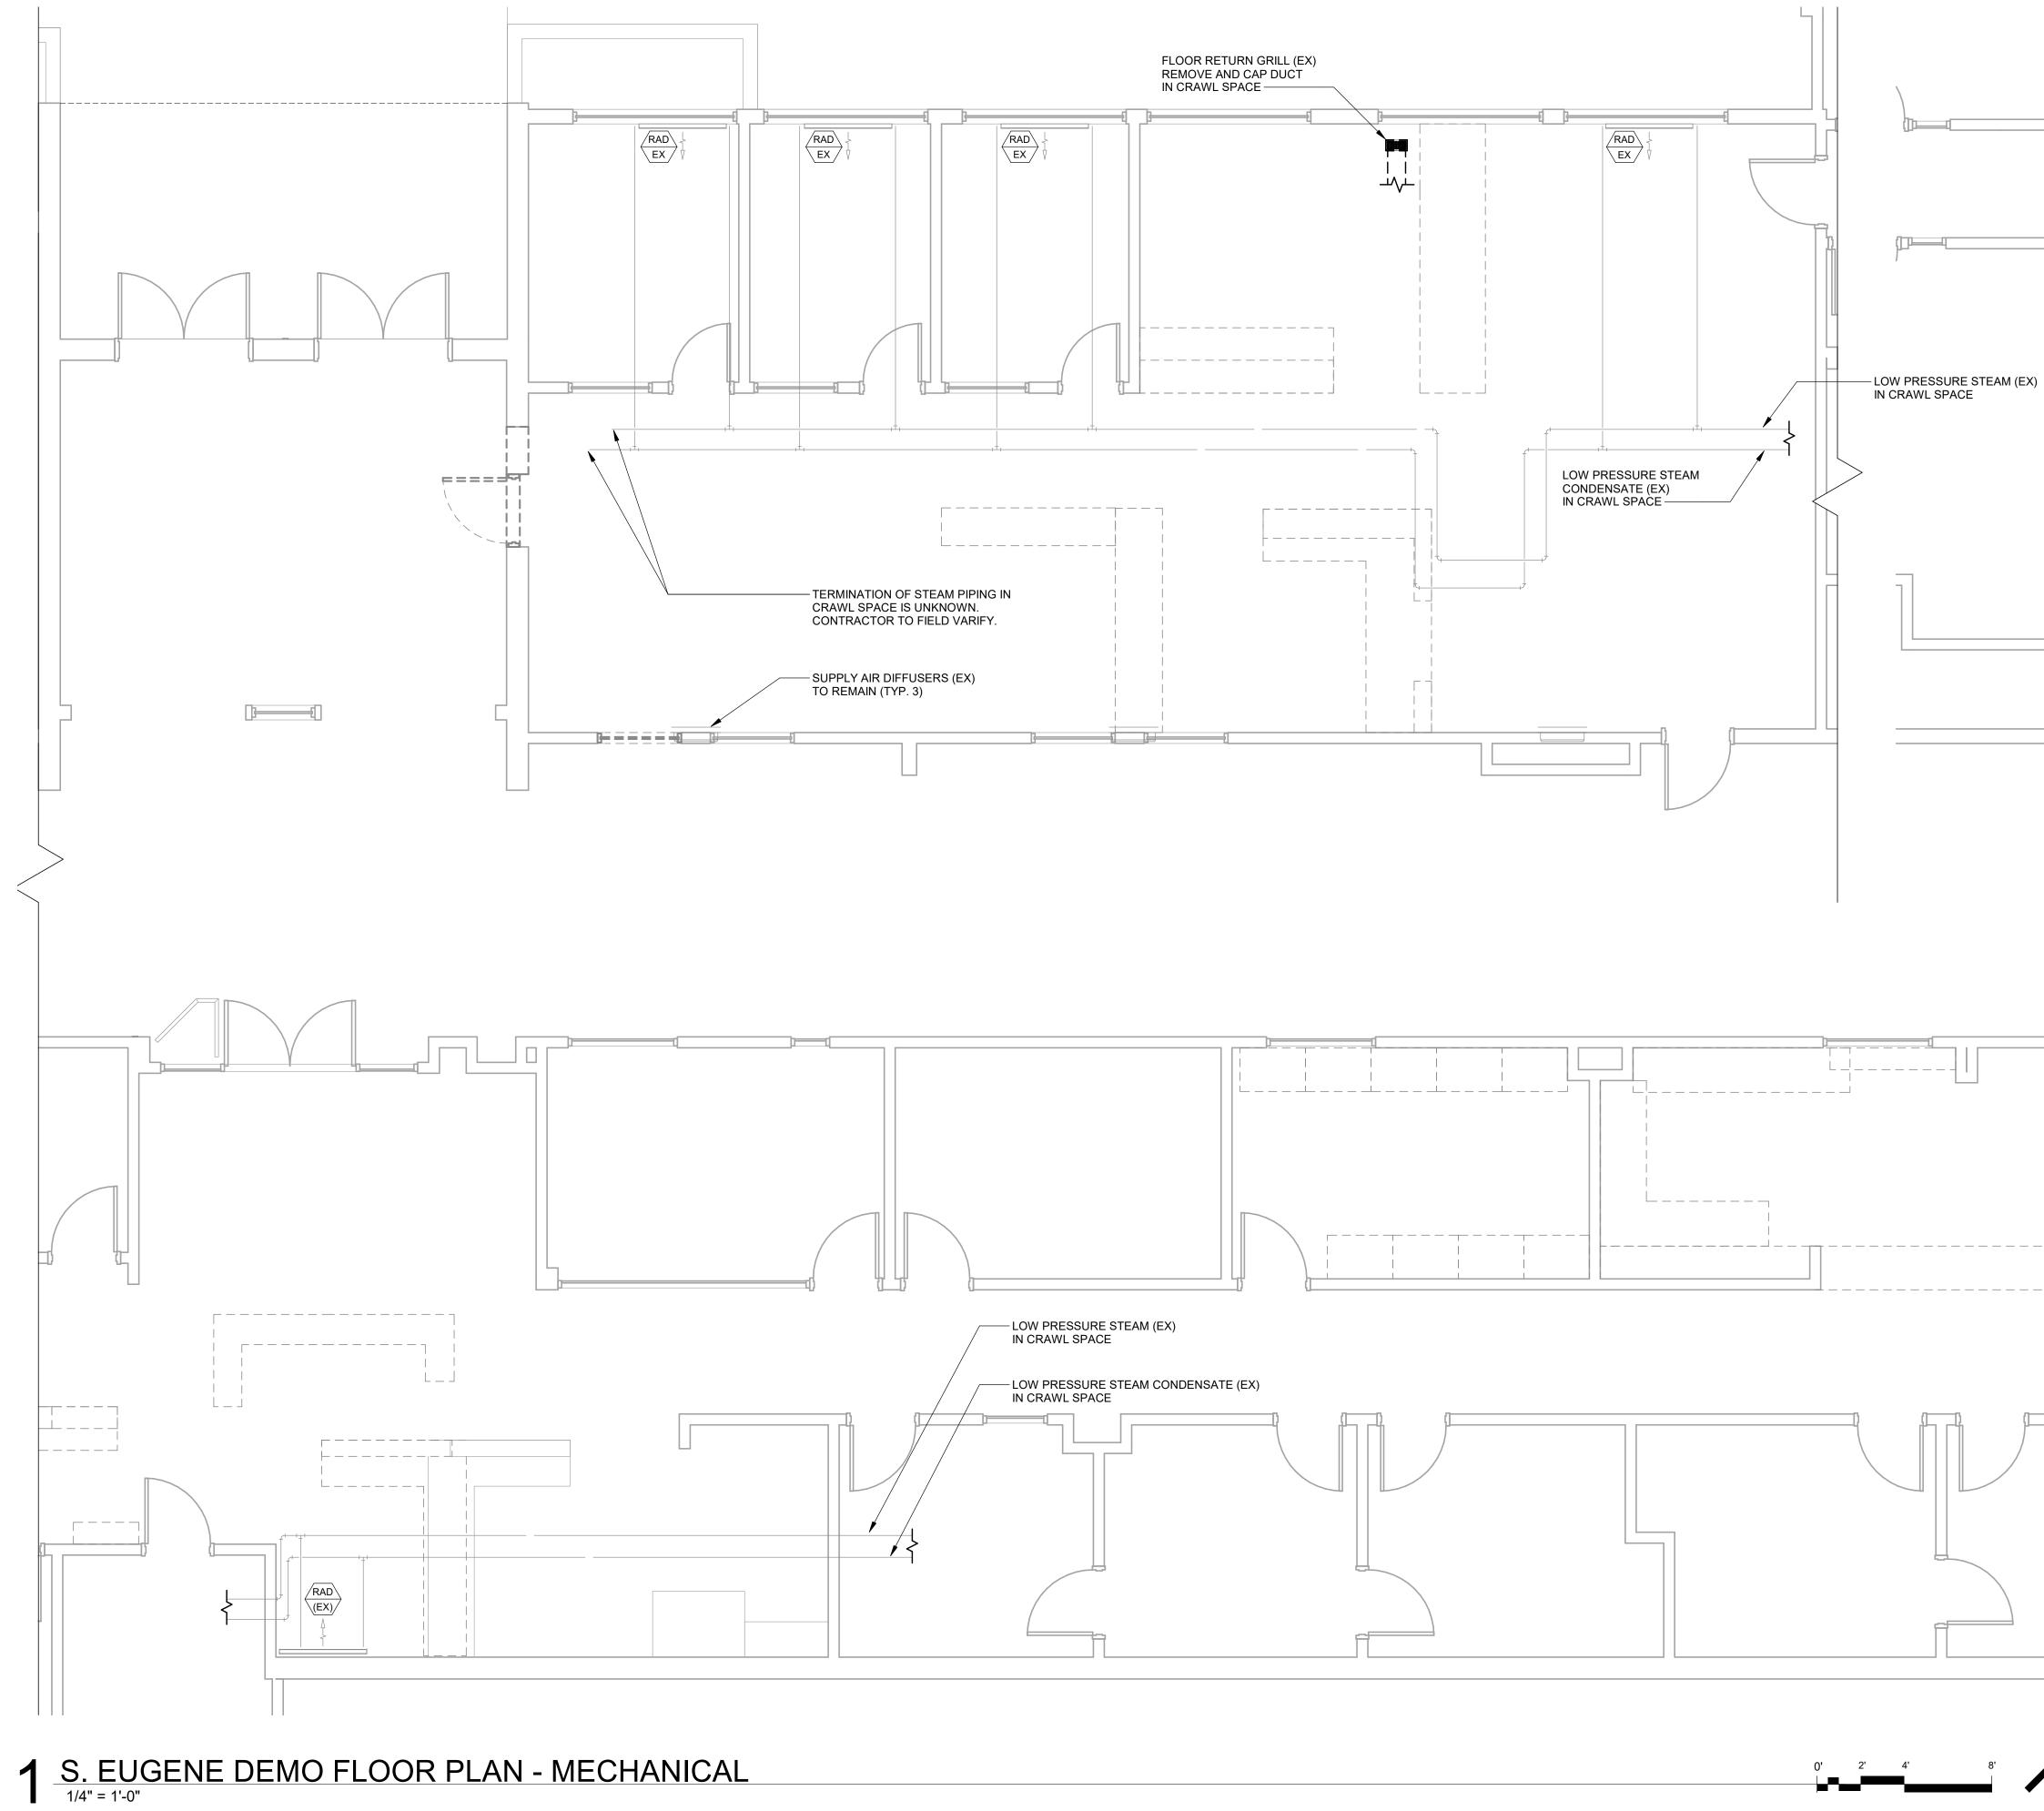

GENERAL NOTES:

- A. REFER TO M00 FOR GENERAL NOTES & SYMBOLS.
- PATCH WALLS, ROOFS, AND/OR FLOOR WHERE DUCTS, GRILLES, PIPES, OR EQUIPMENT ARE REMOVED. PAINT OR В. FINISH TO MATCH ORIGINAL CONSTRUCTION.
- C. COORDINATE WITH OWNER AND ASBESTOS ABATEMENT CONTRACTOR FOR WORK IN AREAS CONTAINING ASBESTOS (EXISTING FLOORING MATERIAL CONTAINS ASBESTOS).
- D. WHERE DUCTWORK IS REMOVED, REMOVE ALL ASSOCIATED SUPPORTS.
- WHERE EQUIPMENT IS REMOVED, REMOVE ALL ASSOCIATED E. SUPPORTS, DUCTWORK, PIPING, AND CONTROLS.
- WHERE CONTROLS ARE REMOVED, REMOVE ALL ASSOCIATED F. WIRING AND/OR PNEUMATIC TUBING. PATCH WALL OPENINGS AND PAINT OR FINISH TO MATCH ORIGINAL CONSTRUCTION. IN WALLS THAT CANNOT BE PATCHED, INSTALL STAINLESS STEEL COVER PLATE. ABANDON PNEUMATIC TUBING IN WALLS.
- REMOVE ALL EXPOSED ABANDONED STEAM AND CONDENSATE PIPING. PATCH WALL AND FLOOR OPENINGS TO MATCH ORIGINAL CONSTRUCTION. G.









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	CONSTRUCTION DRAWING SET 4. SECURITY IMPROVEMENT PROJECT # 207 EUGENE SCHOOL DISTRICT 4J
	SHEET TITLE: S. EUGENE H.S. DEMO FLOOR PLANS - MECHANICAL
	REVISIONS: # DESCRP. DATE
	# DESCRP. DATE
	ISSUE DATE: 03.15.23
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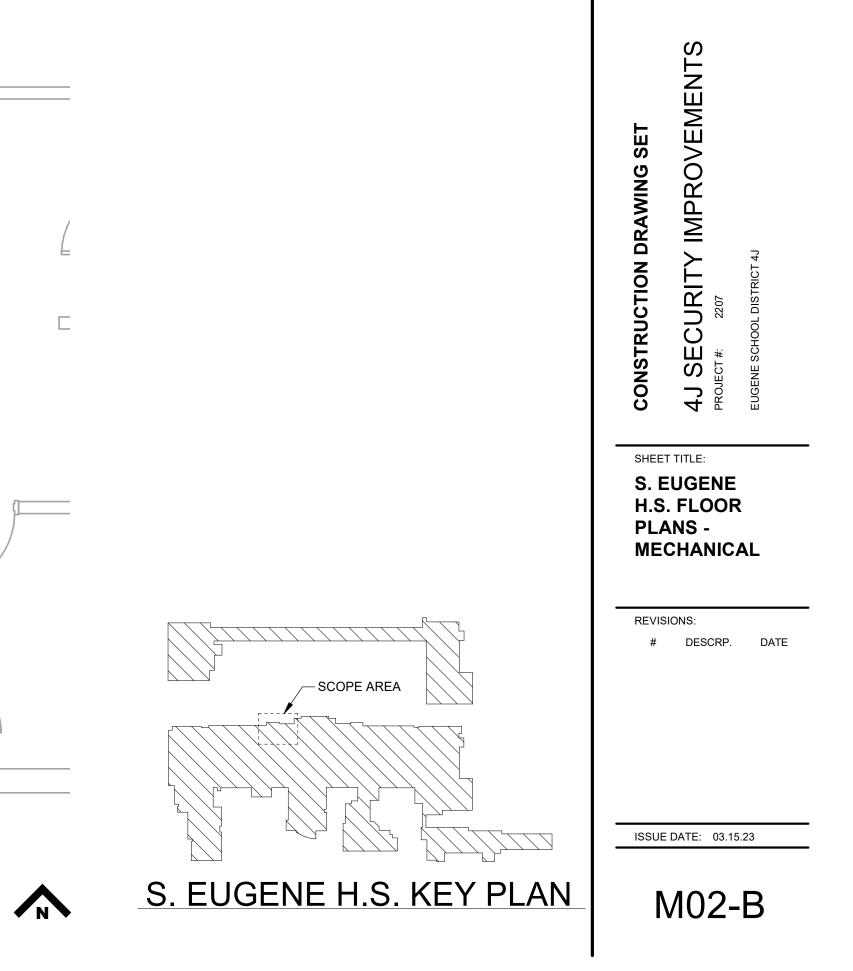
GENERAL NOTES:

- A. REFER TO M00 FOR GENERAL NOTES & SYMBOLS.
- REFER TO M11-B FOR PIPING DETAILS, PIPING SCHEDULES, AND EQUIPMENT SCHEDULES.
- NEW STEAM AND STEAM CONDENSATE PIPING TO BE C. PROVIDED WITH PROTECTIVE ALUMINUM JACKET.
- COORDINATE WITH OWNER AND ASBESTOS ABATEMENT D CONTRACTOR FOR NEW FLOOR PENETRATIONS (EXISTING FLOORING MATERIAL CONTAINS ASBESTOS).

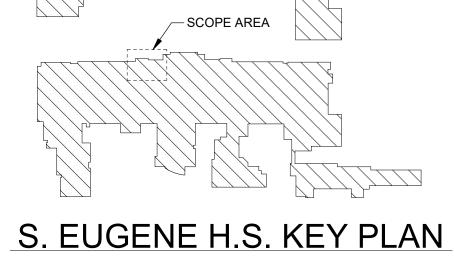ARCHITECTURE \bigcap






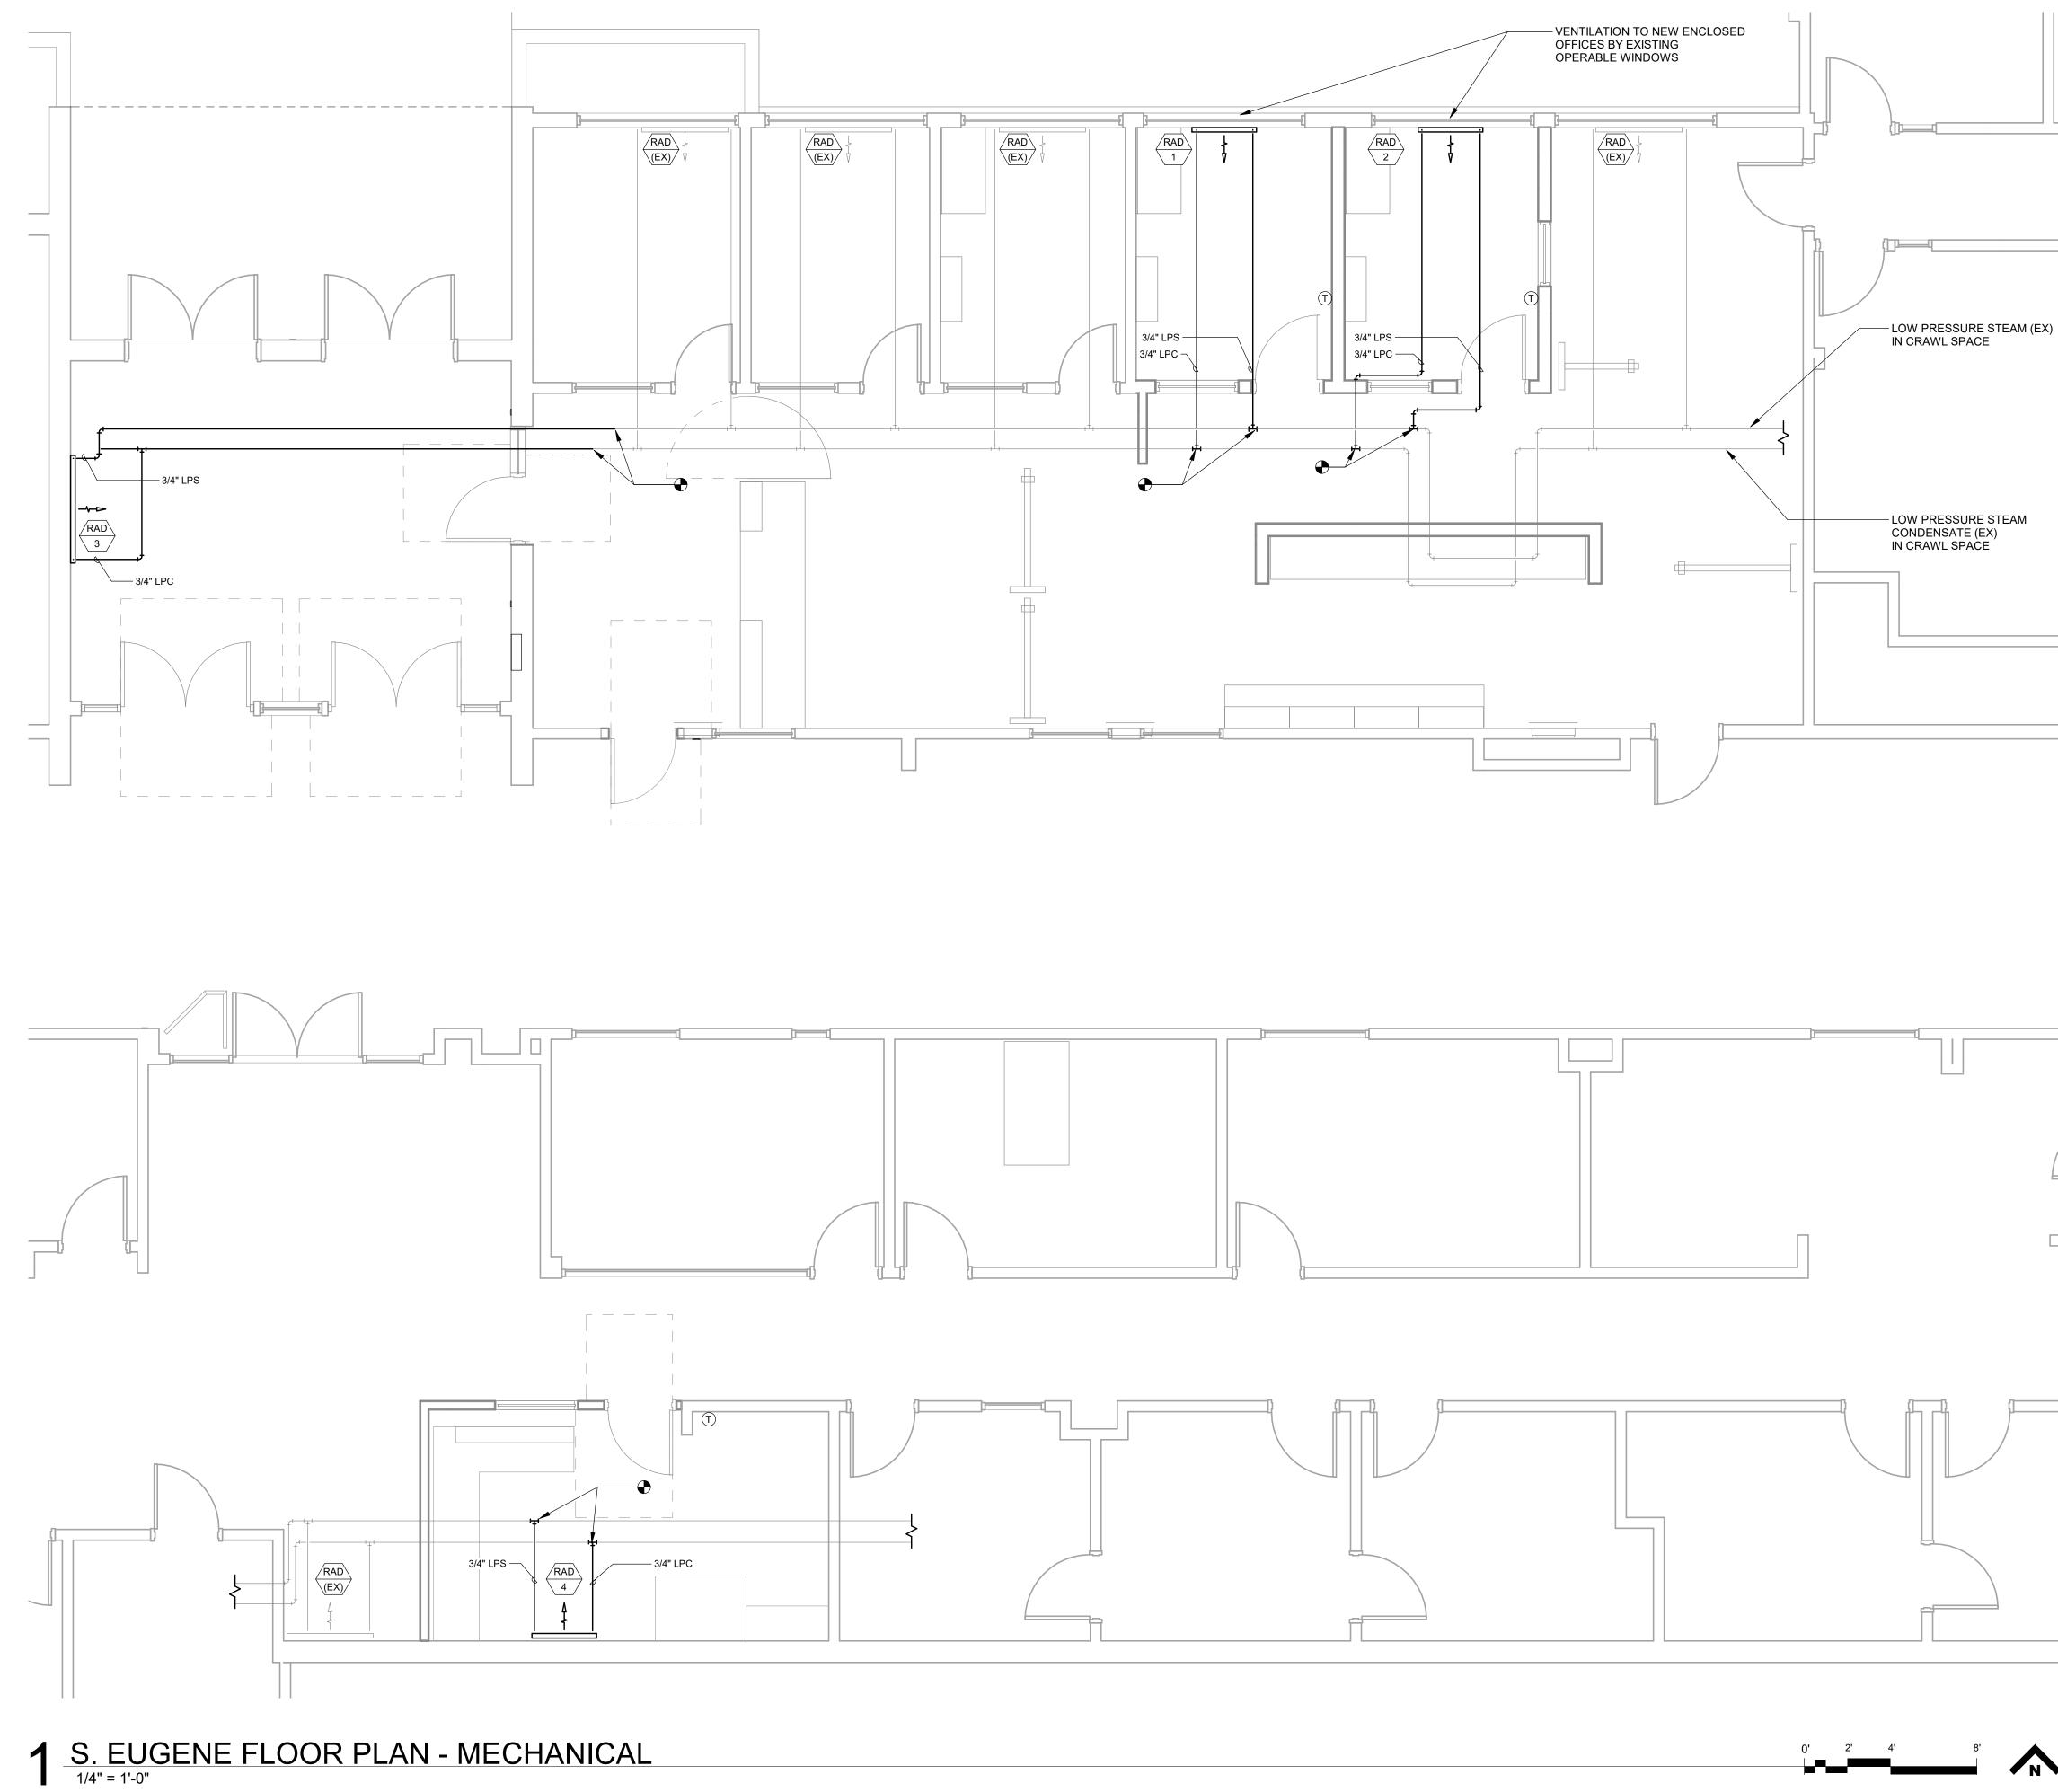

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② 2018 PIVOT ARCHITECTURE

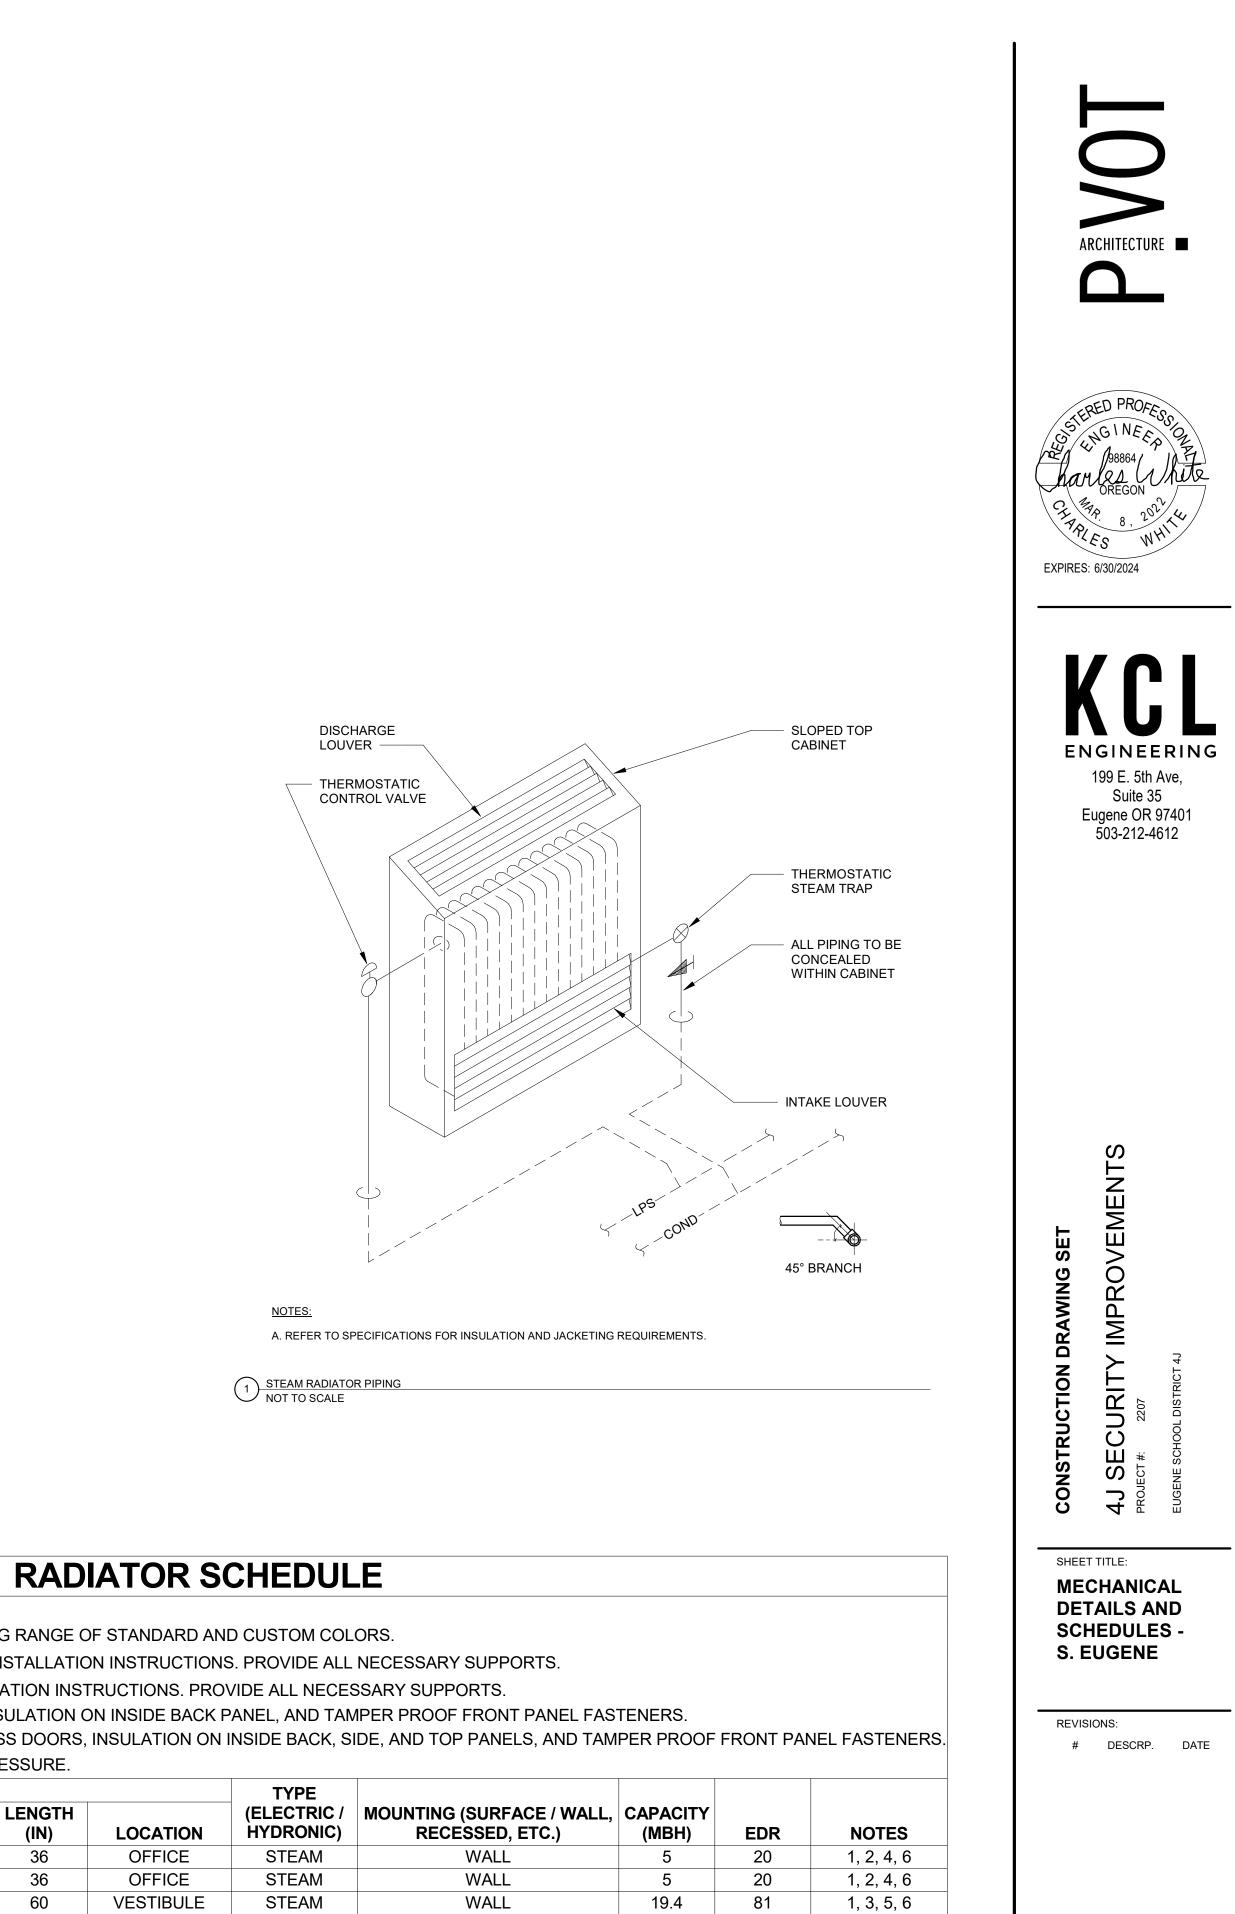

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1, 2, 4, 6

WALL

	NADIATOR SCHEDULL									
NOTES:										
1. REFER	ER TO ARCH FOR FINAL COLOR SELECTION FROM FULL MFG RANGE OF STANDARD AND CUSTOM COLORS.									
2. UNIT TO	D BE FLOOR MOUNT	ED - REFER T	O MANUFA	CTURER'S I	NSTALLATIC	ON INSTRUCTIONS	6. PROVIDE ALL	NECESS		
3. UNIT TO) BE RECESSED - RI	EFER TO MAN	IUFACTURE	R'S INSTAL	LATION INS	RUCTIONS. PRO	/IDE ALL NECES	SSARY SL		
4. PROVID	E WITH OPTIONAL I	KNOB DAMPE	R, ACCESS	DOORS, IN	ISULATION (ON INSIDE BACK P	ANEL, AND TAM	IPER PRO		
5. PROVID	E WITH OPTIONAL	TAMPER RESI	STANT DAM	IPER, ACCE	ESS DOORS,	INSULATION ON I	NSIDE BACK, S	IDE, AND		
6. ELEMEN	NT HEATING BASED	ON 65°F EAT	, AND 2 PSIC	S STEAM PI	RESSURE.					
	REFERENCE						TYPE			
ID TAG	MANUFACTURER	# MODEL	HEIGHT (IN)	DEPTH (IN)	LENGTH (IN)	LOCATION	(ELECTRIC / HYDRONIC)	MOUNT R		
RAD-1	TRANE	SFG	24	4	36	OFFICE	STEAM			
RAD-2	TRANE	SFG	24	4	36	OFFICE	STEAM			
RAD-3	TRANE	RFG	26	8	60	VESTIBULE	STEAM			
RAD-4	TRANE	SFG	24	4	36	OFFICE	STEAM			

ISSUE DATE: 03.15.23

M11-B