4J SECURITY IMPROVEMENTS **EUGENE SCHOOL DISTRICT 4J**

CHURCHILL HIGH SCHOOL

APPLICABLE CODE:

2022 OREGON STRUCTURAL SPECIALTY CODE 2021 OREGON ELECTRICAL SPECIALTY CODE 2021 OREGON ZERO ENERGY READY COMMERCIAL CODE 2019 OREGON MECHANICAL SPECIALTY CODE 2021 OREGON PLUMBING SPECIALTY CODE 2011 OREGON ELEVATOR SPECIALTY CODE 2019 OREGON FIRE CODE ICC 117.1- 2009 ACCESSIBILITY CODE

SITE DATA SUMMARY

PROPOSED IMPERVIOUS SURFACE AREA

LOCATION:	GSF
ROOF, BUILDING:	XX GSF
ROOF, 3 CANOPIES:	XX GSF
PAVING:	XX GSF
TOTAL:	XX GSF

LAND USE CODE INFORMATION

ADDRESS: 1850 Bailey Hill Road, Eugene, OR 97405

MAP & TAX LOT #: 18040310 - 00100

SDC INFORMATION - PLUMBING FIXTURE COUNT

FIXTURE	REMOVED	ADDED	NET CHANGE
COMMERCIAL WASHER			
DRINKING FOUNTAIN			
FLOOR DRAIN			
FLOOR SINK			
JANITORY SINK			
LAVATORY (RESTROOM)			
SHOWER			
SINK			
URINAL			
WATER CLOSET			

ACCESSIBILITY FOR EXISTING BUILDINGS (3411)

PRIORITY OF IMPROVEMENTS PER ORS 447.241: PARKING: EXISTING **ENTRANCE:** EXISTING **ROUTE TO ALTERED AREA:** EXISTING RESTROOMS: EXISTING TELEPHONES: **DRINKING FOUNTAINS:**

BUILDING CODE INFORMATION

OCCUPANCIES (CHAPTER 3): E – EDUCATIONAL

STORAGE:

DEFERRED SUBMITTALS

SPECIAL INSPECTIONS

CONSTRUCTION DRAWING SET ADDITIONAL DRAWING SET INFO 03.15.2023

PROJECT TEAM

<u>OWNER</u>

2207

EUGENE SCHOOL DISTRICT 4J ADMINISTRATION: 715 WEST FOURTH AVENUE, EUGENE, OREGON 97402 FACILITIES: 200 NORTH MONROE ST, EUGENE OREGON 97402 ADMINISTRATION PHONE: (541) 790-7400 FACILITIES PHONE: (541) 790-7421 CONTACT: RYAN SPAIN, SPAIN_R@4J.LANE.EDU

<u>ARCHITECT</u>

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MECHANICAL ENGINEER

KCL ENGINEERS 296 E. 5TH AVE, SUITE 501 CONTACT: CHARLIE WHITE

ELECTRICAL ENGINEER

KCL ENGINEERS 296 E. 5TH AVE, SUITE 501 EUGENE, OR 97401 PHONE: (503) 212-4612 CONTACT: SHYLA KEAYS-GOODMAN





ECURITY IMPROVEM

SHEET TITLE: TITLE SHEET

REVISIONS:

DESCRP. DATE

ISSUE DATE: 01.01.2018

TITLE



CONSTRUCTION DRAWING SET
4J SECURITY IMPROVEMEN
PROJECT #: 2207


SHEET TITLE:
SITE PLAN
CHURCHILL

REVISIONS: # DESCRP. DATE

ISSUE DATE: 03.15.23

A01-C

	DOOR SCHEDULE - CH								
			DOOR PANEL	DOOR FRAME		HARDWARE			
MARK	WIDTH	HEIGHT	TYPE	TYPE	FINISH	GROUP	COMMENTS		
0114									
CH1	3' - 10"	3' - 6"	ALUM	_	PER MANUFACTURER	PER MANUFACTURER	HALF HEIGHT ALUMINUM TRAFFIC DOOR - VERIFY OPENING IN FIELD		

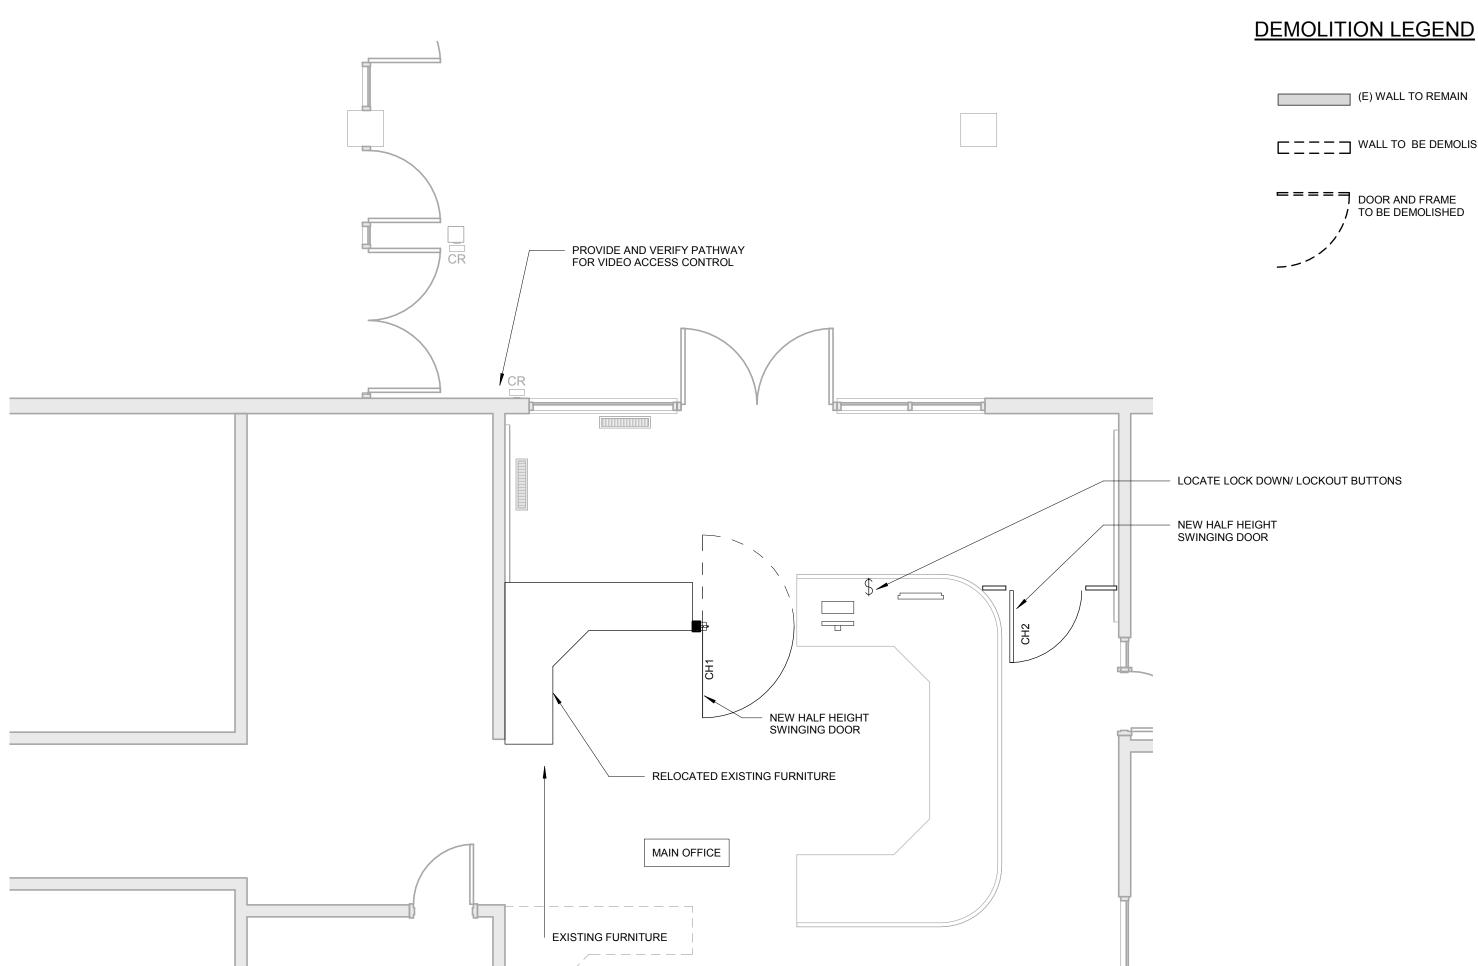

2 FLOOR PLAN - NEW CONSTRUCTION
1/4" = 1'-0"



GENERAL NOTES - DEMOLITION

- A. PROTECT ALL EXISTING CONSTRUCTION TO REMAIN. B. COORDINATE WITH OWNER FOR REMOVAL AND STORAGE OF (E) EQUIPMENT AND CASEWORK TO BE SALVAGED.
- REMOVE EXISTING DOOR WALL STOPS WHERE DOORS NO LONGER EXIST. PROTECT (E) FLOORS, WALLS, CEILINGS & FINISHES TO REMAIN.
- REMOVE AND STORE MATERIAL AND EQUIPMENT WHERE INDICATED TO BE SALVAGED OR RELOCATED.
- WHEN REMOVING FLOOR FINISHES REMOVE ALL ADHESIVE, GROUT, RESIDUE AND
- G. COORDINATE WITH ELECTRICAL FOR ITEMS TO BE DEMOLISHED, REMOVED, AND/OR
- H. COORDINATE WITH MECHANICAL/PLUMBING FOR ITEMS TO BE DEMOLISHED, AND/OR SALVAGED.

COORDINATE WITH OWNERS MODULAR SYSTEMS FURNITURE CONTRACTOR FOR

- CHANGES TO FURNITURE AND SYSTEM CASEWORK.
- COORDINATE WITH OWNER FOR ANY CEILING/FLOORING DISRUPTION REGARDING

GENERAL NOTES - FLOOR PLANS

- A. DIMENSIONS SHOWN ARE TO THE FACE OF STUD, CONCRETE OR MASONRY UNLESS OTHERWISE NOTED. CONTACT THE ARCHITECT FOR ANY ADDITIONAL DIMENSIONS REQUIRED TO LAY OUT THE WORK.
- B. MASONRY DIMENSIONS ARE THE ACTUAL MASONRY UNIT SIZES UNLESS OTHERWISE
- C. REFER TO WALL ASSEMBLY INFORMATION FOR WALL CONSTRUCTION AND
- D. REPAIR PATCHED SURFACES THAT ARE DAMAGED, LIFTED, DISCOLORED, OR SHOWING OTHER IMPERFECTIONS DUE TO PATCHING WORK. IF DEFECTS ARE DUE TO CONDITION OF SUBSTRATE, REPAIR SUBSTRATE PRIOR TO REPAIRING FINISH.
- WHERE (E) FLOOR IS TO REMAIN, PROTECT FROM DAMAGE. PATCH AND REPAIR ANY HOLES IN CONCRETE SLAB CAUSED BY DEMOLITION OF EXISTING WALLS, (I.E. WALL
- F. PATCH AND REPAIR ANY WALL AND CEILING LOCATIONS WHERE EXISTING ELECTRICAL AND VOICE/DATA OUTLET, JUNCTION BOXES, AND SIMILAR WALL
- MOUNTED ITEMS ARE REMOVED OR ABANDONED WITHIN THE WORK AREA. G. PATCH AND REPAIR WALL AND CEILING SURFACES WHERE MODULAR SYSTEMS
- FURNITURE WAS REMOVED BY SEPARATE CONTRACTOR. H. PATCH AND REPAIR ANY WALL LOCATIONS WHERE EXISTING WALL COVERING HAS
- BEEN REMOVED WITHIN THE WORK AREA. I. PATCH AND REPAIR ANY WALL LOCATIONS WHERE EXISTING WALL BASE HAS BEEN
- REMOVED WITHIN THE WORK AREA. J. PATCH AND REPAIR ANY WALL LOCATIONS WHERE EXISTING EQUIPMENT, ACCESSORIES, HARDWARE OR OTHER SURFACE MOUNTED ELEMENTS HAVE BEEN REMOVED WITHIN THE WORK AREA
- K. VERIFY LOCATION OF PROX-CARD READERS, AUTOMATIC DOOR OPENERS AND
- WIRELESS ACTUATORS WITH ARCHITECT DURING ROUGH-IN PHASE OF THE WORK. COORDINATE WITH OWNER FOR ANY CEILING/FLOORING DISRUPTION REGARDING

(E) WALL TO REMAIN WALL TO BE DEMOLISHED ==== DOOR AND FRAME TO BE DEMOLISHED

SHEET TITLE:

CHURCHILL **FLOOR PLAN**

4J SECURITY IMPROVEME

REVISIONS:

DESCRP. DATE

ISSUE DATE: 03.15.23

A02-C

MOUNT SURFACE RACEWAYS USING MECHANICAL MOUNTING SYSTEMS AND

BECOME FAMILIAR WITH EXISTING CONDITIONS PRIOR TO BID.

INCREASE CONDUCTOR SIZES ON 20A 120V-1 PHASE CIRCUITS EXCEEDING 100 FEET TO CENTER OF LOAD TO ACCOUNT FOR VOLTAGE DROP.

FASTENERS. MOUNTING THROUGH THE USE OF ADHESIVE IS NOT PERMISSIBLE.

- RACEWAYS AND BOXES ARE SHOWN DIAGRAMMATICALLY ONLY AND INDICATE GENERAL
- AND APPROXIMATE LOCATIONS. LAYOUTS DO NOT ALWAYS SHOW THE TOTAL NUMBER OF RACEWAYS OR BOXES FOR THE CIRCUITS REQUIRED, NOR ARE THE LOCATIONS OF INDICATED RUNS INTENDED TO SHOW THE ACTUAL ROUTING OF THE RACEWAYS.
- LIGHT FIXTURES. SWITCHES. DEVICES. ETC. ARE SHOWN IN PREFERRED LOCATION. MODIFY CONDUIT, HANGERS, CIRCUITING, ETC. TO PROVIDE A COMPLETE AND
- PROVIDE A DEDICATED GREEN INSULATED GROUND CONDUCTOR TO ALL DEVICES. DO NOT USE CONDUIT SYSTEM AS THE ONLY EQUIPMENT GROUNDING METHOD.
- DO NOT INSTALL BOXES BACK-TO-BACK ON OPPOSITE SIDES OF THE SAME WALL. MAINTAIN MINIMUM OF 8" DISTANCE BETWEEN BOXES WHEREVER APPLICABLE.
- BALANCE PANEL LOADS DURING INSTALLATION. CIRCUIT NUMBERING SHOWN ON PLANS MAY BE ADJUSTED TO ACCOMODATE.
- PROVIDE TYPED PANEL DIRECTORY AT PROJECT COMPLETION FOR NEW PANELS AND EXISTING PANELS WITH CIRCUITS MODIFIED AS A RESULT OF THIS PROJECT. USE OWNER'S CURRENT ROOM NUMBERS AND EQUIPMENT NAMES.
- CONTRACTOR IS RESPONSIBLE FOR OPENINGS IN WALLS, FLOORS, CEILINGS, AND ROOFS THAT ARE REQUIRED TO COMPLETE THEIR SCOPE OF WORK. SEAL PENETRATIONS IN ACCORDANCE WITH THE RATING OF THE AFFECTED ASSEMBLY REFER TO ARCHITECTURAL CODE PLAN FOR RATED WALLS, FLOORS, AND CEILINGS.

DEVICE INSTALLATION AND MATERIALS - ELECTRICAL

- PROVIDE NORMAL WIRING DEVICES AS WHITE / ALMOND / GRAY / BLACK UNLESS OTHERWISE
- PROVIDE DEVICES COVER PLATES AS PLASTIC / STAINLESS STEEL. MATCH WIRING DEVICES
- PROVIDE GFCI TYPE RECEPTACLES AT ALL LOCATIONS REQUIRED BY THE NEC.
- INSTALL WALL MOUNTED RECEPTACLES AT +18" ABOVE FINISHED FLOOR UNLESS OTHERWISE NOTED.
- INSTALL WALL MOUNTED LIGHT SWITCHES AT +46" ABOVE FINISHED FLOOR UNLESS OTHERWISE NOTED. EXCEPTION; INSTALL DEVICES ABOVE AN OBSTRUCTED HIGH FORWARD REACH OBSTACLE GREATER THEN 20 INCHES IN DEPTH AT +42".
- INSTALL ABOVE COUNTERTOP RECEPTACLES +8" ABOVE COUNTERTOP OR AS OTHERWISE INDICATED.
- AT A COMMON COUNTERTOP, INSTALL ALL RECEPTACLES AND SWITCHES AT THE SAME HEIGHT UNLESS OTHERWISE SPECIFICALLY INDICATED.

INSTALLATION NOTES - LIGHTING

- UNLESS NOTED OTHERWISE, CONNECT ALL EMERGENCY BATTERY FIXTURES WITH AN UN-SWITCHED LEG OF THE LIGHTING CIRCUIT THAT SERVES THE FIXTURES SPACE. MAINTAIN NORMAL SWITCHING SCHEME OF EMERGENCY FIXTURES UNDER NORMAL OPERATION. INSTALL PER EMERGENCY FIXTURE OR TRANSFER DEVICE INSTRUCTIONS.
- VERIFY CEILING TYPE (IE. GRID, GYP) WITH ARCHITECTURAL REFLECTED CEILING PLANS PRIOR TO RELEASE OF LIGHTING FIXTURE EQUIPMENT PACKAGE. ADJUST FIXTURE TYPE CONSTRUCTION, FLANGE, OR OTHER COORDINATION DETAILS AS REQUIRED FOR CEILING
- LIGHTING CONTROLS SENSORS ARE SHOWN ON PLANS AT SUGGESTED LOCATIONS ONLY. VERIFY LOCATIONS WITH MANUFACTURER GUIDELINES AND INSTALLATION RECOMMENDATIONS. ADJUST LOCATIONS AS REQURIED TO MEET MANUFACTURER GUIDELINES.
- PROVIDE LIGHTING CONTROLS AS A COMPLETE SYSTEM AND INCLUDE MATERIAL AND INSTALLATION FOR ALL POWER PACKS, ACCESSORIES, CONTROLLERS, AND WIRING REQUIRED FOR OPERATION.

BUILDING EQUIPMENT COORDINATION NOTES - ELECTRICAL

- REFER TO EQUIPMENT CONNECTION SCHEDULE FOR COORDINATION DETAILS BETWEEN MECHANICAL AND ELECTRICAL SYSTEMS.
- PROVIDE AND INSTALL ELECTRICAL SYSTEMS UNDER THIS CONTRACT MEETING THE REQUIREMENTS OF THE SPECIFIED MECHANICAL, FIRE PROTECTION, AND PLUMBING SYSTEMS. REFERENCE THE ENTIRE PROJECT DOCUMENTS, MANUALS, SCHEDULES, DETAILS,
- PROVIDE ELECTRICAL CONNECTIONS AND ACCESSORIES INCLUDING STARTERS, DISCONNECTS, CONTROL WIRING, ETC. AS REQUIRED FOR THE BUILDING MECHANICAL EQUIPMENT. INFORMATION HEREIN AND ON THE DRAWINGS IS FOR GENERAL DESCRIPTION AND ESTIMATING PURPOSES ONLY. VERIFY VOLTAGE, AMPERAGE, PHASE, INRUSH, ETC. FOR EACH ITEM OF EQUIPMENT BEFORE PROCEEDING WITH INSTALLATION. INSTALL EQUIPMENT PER WIRING DETAILS AND INSTRUCTIONS FURNISHED BY THE SUPPLIERS OF THE EQUIPMENT TO PROVIDE PROPER OPERATION.
- REVIEW MECHANICAL EQUIPMENT SHOP DRAWINGS FOR COMPLIANCE AND COORDINATION WITH ELECTRICAL CONNECTIONS. NOTIFY ENGINEER IF CHANGES TO ELECTRICAL CONNECTIONS, WIRING, AND BREAKER REQUIREMENTS ARE NECESSARY TO ACCOMMODATE EQUIPMENT BEING SUPPLIED.
 - DO NOT RELEASE ELECTRICAL DISTRIBUTION EQUIPMENT UNTIL ALL MECHANICAL EQUIPMENT REQUIRING ELECTRICAL INFRASTRCTURE HAS BEEN SUBMITTED AND APPROVED. MAKE COORDINATION ADJUSTMENTS TO BREAKER SIZES AND SIMILAR CHANGES TO ELECTRICAL EQUIPMENT PRIOR TO SUBMITTAL RELEASE. COORDINATE SCHEDULING OF SHOP DRAWINGS WITH ALL TRADES.

PROVIDE DISCONNECTS RATED FOR EQUIPMENT AS REQUIRED AND AS INDICATED WITHIN EQUIPMENT CONNECTION SCHEDULE. COORDINATE DISCONNECT MOUNTING TO ALLOW EQUIPMENT REMOVAL WITHOUT DISCONNECT REMOVAL AND TO MINIMIZE WIRING WORK

PROVIDE HEAVY DUTY TYPE DISCONNECTS RATED FOR THE INSTALLED ENVIRONMENT. PROVIDE MINIMUM NEMA 3R RATED DISCONNECTS FOR EXTERIOR INSTALLATIONS OR AS

VERIFY LOCATIONS OF ALL EQUIPMENT. REFER TO MECHANICAL, PLUMBING, AND ARCHITECTURAL DRAWINGS AND COORDINATE WITH THE ASSOCIATED SUB-CONTRACTOR. ADJUST ELECTRICAL INSTALLATION AS REQUIRED.

$ar{ imes}$ STALLATION NOTES - SYSTEMS

REFER TO TECHNOLOGY SERIES SHEETS FOR ROUGH-IN REQUIREMENTS

REFER TO ELECTRICAL/TECHNOLOGY SCOPE OF RESPONSIBILITY MATRIX.

ELECTRICAL ABBREVIATIONS

DEVICE MOUNTED +8" ABOVE NIC NOT IN CONTRACT COUNTER TOP (VERIFY LOCATION) NM NONMETALLIC ABOVE FINISHED FLOOR NTS NOT TO SCALE AUTOMATIC TRANSFER SWITCH ON CENTER OC OFCI OWNER FURNISHED CEILING CONTRACTOR INSTALLED CIRCUIT BREAKER **CURRENT TRANSFORMER** OFOI OWNER FURNISHED. EXISTING ITEM TO REMAIN OWNER INSTALLED EXISTING ITEM TO BE REMOVED ELECTRICAL CONTRACTOR EMERGENCY LIGHT FIXTURE NEW LOCATION OF EXISTING ITEM RELOCATED ROUGH IN FOR FUTURE DEVICE REPLACED WITH NEW FAAP FIRE ALARM ANNUNCIATOR PANEL SCCR SHORT CIRCUIT CURRENT RATING FACP FIRE ALARM CONTROL PANEL TAMPER PROOF DEVICE FSD FIRE SMOKE DAMPER GROUND FAULT CIRCUIT INTERRUPTER GND GROUND TELEVISION KVA KILO-VOLT-AMPERES TYP TYPICAL **KILOWATTS** MECHANICAL CONTRACTOR VOLTS MCB MAIN CIRCUIT BREAKER VOLT-AMPERES

MAIN DISTRIBUTION PANEL

GENERAL NOTES - ELECTRICAL

MAIN LUGS ONLY

COORDINATE LOCATION/INSTALLATION OF MECHANICAL AND ELECTRICAL WORK WITH ALL OTHER TRADES. BEGIN INSTALLATION AND ROUGH-IN ONLY AFTER PROPER AND TIMELY COORDINATION WITH ALL TRADES ASSOCIATED WITH THE INSTALLATION IS COMPLETE. COORDINATE WITH BUILDING STRUCTURE, ARCHICTURE, MECHANICAL SHEET METAL, ALL PIPING SYSTEMS, LIGHT FIXTURES, CONDUITS, CABLE TRAYS, EQUIPMENT ACCESS/CLEARANCE, ETC. REFER TO ALL GENERAL, MECHANICAL, AND ELECTRICAL DRAWINGS AND SPECIFICATIONS FOR THIS PROJECT. CONTRACTOR IS RESPONSIBLE FOR REWORK OF INSTALLED EQUIPMENT RESULTING FROM INSUFFICIENT COORDINATION.

WIREGUARD COVER

WEATHERPROOF DEVICE

WEATHER RESISTANT DEVICE

LINE OF DEVICE TO FINISHED FLOOR

ELECTRICAL DRAWINGS ARE ONLY A PORTION OF THE COMPLETE SET OF PLANS AND SET OF CONTRACT DOCUMENTS. THIS INCLUDES BUT IS NOT LIMITED TO REFERENCING; REQUIREMENTS, MECHANICAL PLANS FOR EQUIPMENT SIZES AND LOCATIONS.

CODE NOTES - ELECTRICAL

- PROVIDE ELECTRICAL INSTALLATION IN ACCORDANCE WITH ALL LOCAL, STATE, AND NATIONAL CODES.
- THE CURRENT ADOPTED EDITION OF THE ELECTRICAL CODE IS THE STANDARD FOR THE ELECTRICAL INSTALLATION. VERIFY WITH LOCAL OFFICIALS WHEN PERMITS ARE OBTAINED. NOTIFY DESIGN TEAM OF ANY DESCREPANCIES BETWEEN THE PROJECT MANUAL OR DRAWINGS AND THE GOVERNING CODE.
- INSTALLATION SHALL FOLLOW REQUIREMENTS OF THE ADAAG -AMERICANS WITH DISABILITIES ACT.
- REFER TO PROJECT MANUAL AND PROJECT CODE REVIEW SHEET FOR LIST OF APPLICABLE CODES.

- ELECTRICAL DEMOLITION DRAWINGS SHOWING EXISTING CONDITIONS HAVE BEEN PREPARED BASED ON FIELD OBSERVATION AND ORIGINAL DRAWINGS. FIELD VERIFY EXISTING CONDITIONS BEFORE WORK BEGINS. ADDITIONAL COMPONENTS MAY EXIST WHICH ARE NOT SHOWN. BECOME FAMILIAR WITH EXISTING ELECTRICAL SYSTEM WHICH WILL BE AFFECTED BY THE DEMOLITION WORK.
- PROVIDE EQUIPMENT, LABOR, AND MATERIALS TO REMOVE ELECTRICAL FACILITIES AND CLEAR THE AREA TO RECEIVE THE NEW WORK PROVIDED UNDER THIS CONTRACT.
- IN OCCUPIED AREAS BEYOND THE DEMOLITION SCOPE, KEEP EXISTING SYSTEMS NOT AFFECTED BY PROJECT SCOPE OPERATIONAL THROUGH THE DURATION OF THE PROJECT. OBTAIN PERMISSION FROM OWNER'S REPRESENTATIVE TO SHUT OFF SERVICES OR SYSTEMS WHICH MAY AFFECT OTHER AREAS BEYOND THE LIMITS OF THE DEMOLITION AREA. INFORM OWNER'S REPRESENTATIVE OF THE REASON FOR AND DURATION OF THE SHUTDOWN AND ENSURE THAT THE SHUTDOWN IS MADE WITH AS LITTLE INCONVENIENCE TO OTHER AREAS AS POSSIBLE.
- REMOVE CONDUITS, BOXES, ETC., AS REQUIRED BY WALL, CEILING, AND ADJACENT COMPONENTS DEMOLITION. REMOVE EXISTING WIRE UNLESS OTHERWISE NOTED.
- APPROVED BY ENGINEER OR AS INDICATED.
- AND BYPASS DEMOLISHED DEVICES TO MAINTAIN EXISTING CIRCUITS.
- KEEP EXISTING SYSTEMS OPERATIONAL DURING ALL PHASES OF CONSTRUCTION. DO NOT IN-SERVICE CABLES ARE RESPONSIBLE FOR ALL DOWNTIME AND COSTS TO REPAIR.
- INSTALL BLANK COVER PLATES OVER OPENING AT REMOVED DEVICE LOCATIONS. THIS INCLUDES BUT IS NOT LIMITED TO, CLOCKS, RECEPTACLES, SWITCHES, JUNCTION BOXES,
- COMPLETION OF THE DEMOLITION WORK AND THE INSTALLATION OF THE NEW WORK.
- REMOVED AND RELOCATED, AND HANDLE WITH APPROPRIATE CARE TO ALLOW FOR REINSTALLATION. REPLACE DEVICES DAMAGED DURING DEMOLITION WITH NEW AT
- REMOVE AND REINSTALL CEILING TILES REQUIRED FOR THE WORK BEING DONE UNDER THIS CONTRACT. REPLACE CEILING TILES DAMAGED DURING CONSTRUCTION TO MATCH EXISTING.

CONTRACTOR. THIS CONTRACTOR IS RESPONSIBLE FOR MEETING WITH ALL SUB-CONTRACTORS TO COORDINATE LOCATIONS AND INSTALLATION OF MECHANICAL AND CONTRACTORS EXPENSE.

LIGHTING SYMBOLS

EXISTING ITEM TO BE REMOVED AND EXISTING ITEM TO BE REMOVED AND TEMPERATURE CONTROL CONTRACTOR UNINTERRUPTIBLE POWER SUPPLY INDICATES MOUNTING HEIGHT CENTER

NEW DEVICE IN EXISTING LOCATION

- CONTRACT DOCUMENTS. THE ELECTRICAL SCOPE OF WORK IS DEFINED BY THE COMPLETE ARCHITECTURAL PLANS FOR DIMENSIONS AND DETAILS; EQUIPMENT PLANS FOR ROUGH-IN

DEMOLITION AND RENOVATION NOTES - ELECTRICAL

- INSTALL NEW CONDUCTORS FOR NEW CIRCUITS IN REMODELED AREAS UNLESS SPECIFICALLY NOTED OTHERWISE. RETAIN EXISTING CONDUITS IN GOOD CONDITION WHERE
- IDENTIFY DISCONNECTED BRANCH CIRCUIT LOCATION OR ITEM SERVED BEFORE DISCONNECTION. UPDATE PANEL/EQUIPMENT DIRECTORY ACCORDINGLY.
- MAINTAIN CIRCUITS SERVING AREAS BEYOND THE DEMOLITION AREA. EXTEND NEW WIRING
- CUT EXISTING TELECOMMUNICATION WIRING, CABLES OR CONDUIT. CONTRACTORS WHO CUT
- PROVIDE CUTTING AND PATCHING OF EXISTING MATERIALS AS REQUIRED FOR THE PROPER
- MAINTAIN FULL FUNCTIONAL AND AESTHETIC INTEGRITY OF DEVICES IDENTIFIED TO BE CONTRACTOR'S EXPENSE.
- EQUIPMENT AND SYSTEM THAT ARE REMOVED REMAIN THE PROPERTY OF THE OWNER UNLESS OTHERWISE NOTED. DISPOSE OF ALL MATERIALS NOT SALVAGED BY THE OWNER.

PROJECT DELIVERY NOTES - ELECTRICAL

THE DELIVERY METHOD FOR THIS PROJECT IS INDIVIDUAL SUB-CONTRACTS TO ONE GENERAL ELECTRICAL WORK WITH ALL OTHER TRADES. REWORK OF INSTALLED EQUIPMENT WILL BE AT

RECESSED LIGHT FIXTURE, LETTER INDICATES SWITCH LEG (TYPICAL), SHADING INDICATES EMERGENCY LIGHT (TYPICAL) **ROUND LIGHT FIXTURE - SURFACE MOUNTED**

PENDANT MOUNTED LIGHT FIXTURE

ROUND APERTURE RECESSED DOWNLIGHT FIXTURE, ARROW INDICATES WALLWASH

SQUARE LIGHT FIXTURE - SURFACE MOUNTED

SQUARE APERTURE RECESSED DOWNLIGHT FIXTURE. ARROW INDICATES WALLWASH

SURFACE MOUNTED STRIP FIXTURE

LINEAR PENDANT MOUNTED FIXTURE

INDUSTRIAL STRIP LIGHT FIXTURE

WALL MOUNTED STRIP LIGHT FIXTURE

COVE LIGHT FIXTURE

CONTINUOUS WALL MOUNTED FIXTURE

TRACK LIGHTING, ELEVATION AS NOTED.

4_ EMERGENCY LIGHT FIXTURE, WALL MOUNT, +96" OR AS NOTED

EMERGENCY LIGHT FIXTURE, CEILING MOUNT

EXIT SIGN, WALL MOUNT +96", SHADED AREAS INDICATE NUMBER OF FACES, ARROWS INDICATE SIGN ARROWS

EXIT SIGN, CEILING MOUNT, SHADED AREAS INDICATE NUMBER OF FACES, ARROWS INDICATE SIGN ARROWS

EXTERIOR LIGHT FIXTURE, WALL MOUNT +10', OR AS NOTED

COMBINATION EXIT SIGN & EMERGENCY LIGHT, WALL MOUNT +96", SHADED AREAS INDICATE NUMBER OF FACES, ARROWS INDICATE SIGN ARROWS

COMBINATION EXIT SIGN & EMERGENCY LIGHT, CEILING MOUNT, SHADED AREAS INDICATE NUMBER OF FACES, ARROWS INDICATE SIGN ARROWS

INTERIOR LIGHT FIXTURE, WALL MOUNT

EXTERIOR POLE MOUNTED LIGHT FIXTURE, REFER TO LIGHT FIXTURE SCHEDULE

BOLLARD LIGHT FIXTURE

EXTERIOR FLOOD LIGHT FIXTURE, REFER TO LIGHT FIXTURE SCHEDULE

EMERGENCY REMOTE HEAD LIGHT FIXTURE, REFER TO LIGHT FIXTURE SCHEDULE

CEILING FAN

SINGLE POLE SWITCH, WALL MOUNT +48", OR AS NOTED. LETTER INDICATES SWITCH LEG

THREE WAY SWITCH, WALL MOUNT +48", OR AS NOTED. LETTER INDICATES SWITCH LEG

PILOT LIGHT SWITCH, WALL MOUNT +48", OR AS NOTED, LETTER INDICATES SWITCH LEG

DIMMER SWITCH, WALL MOUNT +48", OR AS NOTED, LETTER INDICATES SWITCH LEG

LIGHTING CONTROLS LOW VOLTAGE SWITCH, WALL MOUNT +48", OR AS NOTED. LETTER INDICATES SWITCH LEG, REFER TO LIGHTING CONTROLS SCHEDULE OCCUPANCY SENSOR, WALL MOUNT +48" OR AS NOTED, NUMBER INDICATES TYPE.

LETTER INDICATES SWITCH LEG, REFER TO LIGHTING CONTROLS SCHEDULE OCCUPANCY SENSOR, CEILING MOUNT, NUMBER INDICATES TYPE, LETTER

INDICATES SWITCH LEG, REFER TO LIGHTING CONTROLS SCHEDULE DAYLIGHTING SENSOR, CEILING MOUNT, NUMBER INDICATES TYPE, LETTER INDICATES SWITCH LEG, REFER TO LIGHTING CONTROLS SCHEDULE

LIGHTING CONNECTION, REFER TO LIGHTING FIXTURE SCHEDULE FOR FIXTURE DESCRIPTION

EMERGENCY TRANSFER DEVICE

LIGHTING CONTACTOR

PHOTOCELL

RELAY

ROOM/ZONE CONTROLLER, MOUNT ABOVE ACCESSIBLE CEILING

GENERAL SYMBOLS

CONDUIT SLEEVE CONDUIT UP, REFER TO TAG ON DRAWING FOR SIZE

CONDUIT DOWN, REFER TO TAG ON DRAWING FOR SIZE

JUNCTION BOX, CEILING OR FLOOR MOUNTED.


CIRCUIT HOMERUN, CONCEALED CONDUIT OR CABLE

CIRCUIT HOMERUN, UNDER FLOOR CONDUIT OR CABLE

JUNCTION BOX, WALL MOUNTED, ELEVATION AS NOTED


KITCHEN EQUIPMENT TAG NUMBER, REFER TO KITCHEN EQUIPMENT CONNECTION SCHEDULE

EQUIPMENT IDENTIFICATION TAG. REFER TO EQUIPMENT CONNECTION SCHEDULE

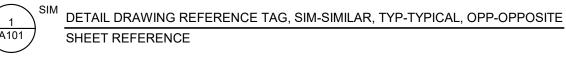

SHEET REFERENCE

SECTION CUT REFERENCE TAG, SIM-SIMILAR, TYP-TYPICAL, OPP-OPPOSITE

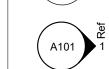

INTERIOR ELEVATION DRAWING REFERENCE TAG

POWER SYMBOLS

DUPLEX RECEPTACLE, TAMPER-RESISTANT, WALL MOUNT +18", OR AS NOTED

QUADRAPLEX RECEPTACLE, TAMPER-RESISTANT, WALL MOUNT +18", OR AS NOTED

QUADRAPLEX GFCI RECEPTACLE, TAMPER-RESISTANT, WALL MOUNT +18", OR AS NOTED

SPECIAL RECEPTACLE, WALL MOUNT +18", OR AS NOTED, REFER TO ELECTRICAL EQUIPMENT CONNECTION SCHEDULE FOR RECEPTACLE TYPE

SPECIAL RECEPTACLE, CEILING MOUNT, REFER TO ELECTRICAL EQUIPMENT CONNECTION SCHEDULE FOR RECEPTACLE TYPE

SCHEDULE FOR CONNECTION TYPE EQUIPMENT CONNECTION, WALL MOUNT +18", OR AS NOTED, REFER TO ELECTRICAL EQUIPMENT CONNECTION SCHEDULE FOR CONNECTION TYPE

EQUIPMENT CONNECTION, REFER TO ELECTRICAL EQUIPMENT CONNECTION

DOOR PUSH BUTTON (WEATHERPROOF), +48" OR AS NOTED

POWER / DATA POLE

PANELBOARD - SURFACE MOUNTED

PANELBOARD - RECESSED IN WALL

LIGHTING PLANS NOTATION KEY

- UPPERCASE LETTERING INDICATES FIXTURE TYPE. REFER TO LUMINAIRE SCHEDULE - +## INDICATES FIXTURE MOUNTING HEIGHT FROM BOTTOM OF FIXTURE TO FINISHED FLOOR. COORDINATE ALL FIXTURE ELEVATIONS WITH ARCHITECTURAL RCP ∏F1(6') 🌶 PRIOR TO ROUGH-IN AND SHOP SUBMITTALS. +10'-6" - LOWERCASE LETTERING INDICATES SWITCH LEG. | C - --IN1 🚤 - SHADING AND/OR "EM#" INDICATES **EMERGENCY OPERATION FIXTURE. NUMBER** INDICATES EMERGENCY CIRCUIT NUMBER. - TRANSFER DEVICE TYPE. REFER TO LIGHTING CONTROLS SCHEDULE NO: P1-# NORMAL (NO) AND EMERGENCY (EM)

NOTE: ALL SYMBOLS MAY NOT APPLY TO THIS PROJECT

INPUT POWER SOURCES.

97568 OREGON KEAYS-GO EXPIRES: 6/30/2023

> ENGINEERING 199 E. 5th Ave, Suite 35 Eugene OR 97401 503-212-4612

CURI. S

SHEET TITLE: **ELECTRICAL GENERAL NOTES &**

SYMBOLS

REVISIONS: # DESCRP. DATE

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TELECOMMUNICATIONS DISTRIBUTION NOTES

- REAM CONDUIT TO REMOVE BURRS AND ROUGH EDGES. PROVIDE A PROTECTIVE BUSHING AT THE END OF ANY CONDUIT STUB TO PROTECT CABLING INFRASTRUCTURE.
- PROVIDE CABLE SUPPORT FOR ROUTING ALL NEW INFRASTRUCTURE. INSIDE OF ABOVE ACCESSIBLE CEILING SPACES, CABLING CAN BE FLOWN FREE-AIR UTILIZING J-HOOKS AND OTHER ACCESSORIES TO SUPPORT CABLING. CABLE SHALL NOT BE ALLOWED TO REST ON TOP OF CEILING TILES OR TO UTILIZE GRID SUPPORT SYSTEM.
- ALL OPEN CEILING AREAS SHALL HAVE CABLING CONCEALED IN CONDUIT. EXPOSED CABLING SHALL NOT BE ACCEPTED.
- ROUTE CONDUIT SERVING WORK AREA OUTLET DATA DIRECTLY TO THE CABLE TRAY (WHERE APPLICABLE). CONDUIT STUB SHALL BE DIRECTLY OVERHEAD OF THE TRAY TO ALLOW FOR CONVENIENT FUTURE MOVE, ADDS OR CHANGES.
- THE FINAL ROUTING IS AT THE DISCRETION OF THE INSTALLING CONTRACTOR. THE CONTRACTOR IS ENCOURAGED TO INVESTIGATE EXISTING BUILDING CONDITIONS AND UTILIZE ABOVE ACCESSIBLE CEILING, SOFFIT AND BELOW CRAWL SPACES WHERE AVAILABLE TO ROUTE NEW TECHNOLOGY INFRASTRUCTURE. EXPOSED PATHWAYS IN PUBLIC SPACES MUST BE APPROVED BY THE
 - ARCHITECT OR ENGINEER PRIOR TO INSTALLATION.

FIRE DETECTION & ALARM NOTES

- EXTEND THE EXISTING FIRE DETECTION AND ALARM SYSTEM TO LOCATIONS ILLUSTRATED ON THE DRAWINGS.
- FIRE ALARM ITEMS AND DEVICES ARE SHOWN IN SUGGESTED LOCATIONS. FINAL LAYOUTS, LOCATIONS, AND QUANTITIES SHALL BE IN ACCORDANCE WITH APPLICABLE CODES, MANUFACTURER'S RECOMMENDATIONS, AND EQUIPMENT LISTINGS. COORDINATE LOCATIONS WITH LIGHTING AND AIR HANDLING SYSTEMS.
- ALL FIRE ALARM CIRCUITRY IN EXPOSED CEILING SPACES SHALL BE IN 3/2" CONDUIT PER SPECIFICATIONS. EXPOSED CABLING SHALL NOT BE ACCEPTED.
- ALL CONCEALED, ACCESSIBLE CEILING TILE LOCATIONS SHALL BE ALLOWED TO HAVE OPEN AIR CABLING INSTALLED. PROVIDE J-HOOKS AND ASSOCIATED CABLE SUPPORTS TO KEEP INFRASTRUCTURE MANAGED AND OFF OF THE CEILING TILE.
- ELECTRICAL CONTRACTOR SHALL PROVIDE FIRESTOPPING AT ALL PENETRATIONS PER SPECIFICATION.

TECHNOLOGY GENERAL NOTES

- NOTES APPLY TO ALL DIVISION 27 AND 28 SCOPE OF WORK ON "E" SERIES SHEETS.
- COORDINATE LOCATION/INSTALLATION OF MECHANICAL AND ELECTRICAL WORK WITH ALL OTHER TRADES. BEGIN INSTALLATION AND ROUGH-IN ONLY AFTER PROPER AND TIMELY COORDINATION WITH ALL TRADES ASSOCIATED WITH THE INSTALLATION IS COMPLETE. COORDINATE WITH BUILDING STRUCTURE, ARCHICTURE, MECHANICAL SHEET METAL, ALL PIPING SYSTEMS, LIGHT FIXTURES, CONDUITS, CABLE TRAYS, EQUIPMENT ACCESS/CLEARANCE, ETC. REFER TO ALL GENERAL, MECHANICAL, AND ELECTRICAL DRAWINGS AND SPECIFICATIONS FOR THIS PROJECT. CONTRACTOR IS RESPONSIBLE FOR REWORK OF INSTALLED EQUIPMENT RESULTING FROM INSUFFICIENT COORDINATION.
- INCORPORATE THE REQUIREMENTS OF THE SPECIFICATIONS, DRAWINGS, AND STATE AND LOCAL CODES INTO THE INSTALLATION OF COMMUNICATIONS AND LIFE SAFETY/SECURITY SYSTEMS.

TECHNOLOGY PATHWAY GENERAL NOTES

- EACH TRADE IS RESPONSIBLE FOR MAKING PENETRATIONS WHERE REQUIRED IN EXISTING OR NEW WALLS, FLOORS, CEILINGS, AND ROOFS. MAKE PENETRATIONS NEAT. CONCEAL OR
- SECURELY FASTEN SURFACE MOUNT RACEWAY AND CONDUIT UTILIZING MECHANICAL MOUNTING SYSTEMS AND FASTENERS PER SPECIFICATIONS. THE USE OF ADHESIVES AS A MEANS OF MOUNTING IS NOT ALLOWED.
- PROVIDE A PULL STRING IN ALL NEW CONDUITS FOR EASE OF CABLE INSTALLATION.

COMMUNICATIONS DEMOLITION NOTES

- EXISTING DEVICES AND DEVICE LOCATIONS WERE MADE BY CASUAL FIELD OBSERVATION. CONTRACTOR SHALL BE RESPONSIBLE FOR FIELD VERIFYING SYSTEM COMPONENTS AND DEVICE LOCATIONS.
- PROVIDE LABOR AND MATERIALS TO REMOVE ELECTRICAL FACILITIES AND CLEAR THE AREA TO RECEIVE THE NEW WORK TO BE PROVIDED UNDER THIS CONTRACT.
- SYSTEMS SCHEDULED TO BE REMOVED SHALL BE DONE SO IN THEIR ENTIRETY. ABANDONED CABLING SHALL NOT BE ACCEPTED. REMOVE ALL ASSOCIATED FIELD DEVICES AND HEAD END EQUIPMENT.
- REMOVED EQUIPMENT AND SYSTEMS SHALL REMAIN THE PROPERTY OF THE OWNER UNLESS OTHERWISE NOTED. MATERIALS NOT SALVAGED BY THE OWNER SHALL BE THE RESPONSIBILITY OF THE CONTRACTOR FOR PROPER DISPOSAL.
- REMOVE AND REINSTALL CEILING TILE REQUIRED FOR THE WORK BEING DONE UNDER THIS CONTRACT. DAMAGED CEILING TILE SHALL BE REPLACED TO MATCH EXISTING.
- DO NOT CUT EXISTING TELECOMMUNICATIONS WIRING, CABLES OR CONDUIT AS EXISTING SYSTEMS SHALL REMAIN OPERATIONAL DURING CONSTRUCTION. CONTRACTOR WHO CUTS IN-SERVICE CABLES SHALL BE RESPONSIBLE FOR DOWNTIME AND THE COSTS TO REPAIR.

LIFE SAFETY & SECURITY DEMOLITION NOTES

- EXISTING DEVICES AND DEVICE LOCATIONS WERE MADE BY CASUAL FIELD OBSERVATION. CONTRACTOR SHALL BE RESPONSIBLE FOR FIELD VERIFYING SYSTEM COMPONENTS AND DEVICE LOCATIONS.
- PROVIDE LABOR AND MATERIALS TO REMOVE ELECTRICAL FACILITIES AND CLEAR THE AREA TO RECEIVE THE NEW WORK TO BE PROVIDED UNDER THIS CONTRACT.
- SYSTEMS SCHEDULED TO BE REMOVED SHALL BE DONE SO IN THEIR ENTIRETY. ABANDONED CABLING SHALL NOT BE ACCEPTED. REMOVE ALL ASSOCIATED FIELD DEVICES AND HEAD END EQUIPMENT.
- REMOVED EQUIPMENT AND SYSTEMS SHALL REMAIN THE PROPERTY OF THE OWNER UNLESS OTHERWISE NOTED. MATERIALS NOT SALVAGED BY THE OWNER SHALL BE THE RESPONSIBILITY OF THE CONTRACTOR FOR PROPER DISPOSAL.
- REMOVE AND REINSTALL CEILING TILE REQUIRED FOR THE WORK BEING DONE UNDER THIS CONTRACT. DAMAGED CEILING TILE SHALL BE REPLACED TO MATCH EXISTING.
- DO NOT CUT EXISTING TELECOMMUNICATIONS WIRING, CABLES OR CONDUIT AS EXISTING SYSTEMS SHALL REMAIN OPERATIONAL DURING CONSTRUCTION. CONTRACTOR WHO CUTS IN-SERVICE CABLES SHALL BE RESPONSIBLE FOR DOWNTIME AND THE COSTS TO REPAIR.

ACCESS CONTROL/SECURITY MANAGEMENT NOTES

- EACH SITE HOSTS AN EXISTING LENEL ONGUARD ACCESS CONTROL PLATFORM. THE EXISTING PLATFORM IS TO BE EXTENDED TO ACCOMODATE THE SCHEDULED WORK. THE PROPOSED SCOPE OF WORK INCLUDES: MODIFICATION OF EXISTING ACCESS CONTROL OPENINGS, ADDITION OF NEW ACCESS CONTROL OPENINGS, AND UPGRADING THE HEAD END INTELLIGENT SYSTEM CONTROLLERS AT EACH SITE.
- THE BIDDING CONTRACTOR IS RESPONSIBLE FOR PROGRAMMING IN COORDINATION WITH 4J SCHOOL DISTRICT.
- DETAILS ILLUSTRATED IN THE DRAWINGS ARE DIAGRAMMATIC TO ILLUSTRATE PATHWAY, ROUGH-IN, DEVICE AND CABLING REQUIREMENTS. REVIEW SPECIFICATION SECTION 08 71 00 FOR ALL SPECIFIC ELEMENTS THAT ARE SCHEDULED AT EACH OPENING.
- IT IS THE INTENT THAT ALL PATHWAYS AND ROUGH-IN SERVING ACCESS CONTROL SHALL BE RECESSED AND CONCEALED. EXPOSED CABLING OR SURFACE PATHWAYS ARE NOT ACCEPTABLE UNLESS APPROVED BY THE ARCHITECT OR ENGINEER.

INTRUSION DETECTION NOTES

- EXTEND THE EXISTING DMP INTRUSION DETECTION SYSTEM. COORDINATE PLACING THE EXISTING PANEL IN TEST MODE WITH THE BUILDING OWNER DURING INSTALLATION.
- THE SCOPE OF WORK INCLUDES THE ADDITION OF DOOR POSITION SWITCHES AT NEW AND MODIFIED ACCESS CONTROL OPENINGS. PROVIDE THE REQUIRED RELAYS. EXPANDER MODULES, WIRING AND OTHER ACCESSORIES REQUIRED TO ACCOMODATE THE PROPOSED WORK.
- 3. COORDINATE ZONING AND PROGRAMMING WITH 4J SCHOOL DISTRICT.

CABLING NOTES

- CATEGORY CABLING SERVING DATA AND VOICE APPLICATIONS SHALL BE TESTED TO ENSURE ALL ELECTRICAL CHARACTERISTICS ARE COMPLIANT WITH THE SPECIFIED CLASSIFICATION (6A). UTILIZE FLUKE DSX EQUIPMENT OR EQUIVALENT AND PROVIDE ELECTRONIC RESULTS DURING CLOSEOUT PROCEDURES. ANY INSTANCE OF CABLING FAILING THE PERFORMANCE TEST SHALL BE RECTIFIED BY THE CONTRACTOR THROUGH RE-TERMINATION OR RUNNING NEW CABLING AT NO COST TO THE OWNER.
- PROVIDE A CERTIFIED INSTALLATION BY THE MANUFACTURER. ENSURE THE WARRANTY IS PROVIDED AS THE SPECIFICATIONS REQUIRE.
- WILD RETURN AIR IS EXPECTED IN THE PLENUM SPACES OF THIS PROJECT. THEREFORE, PROVIDE PLENUM RATED CABLING FOR ALL FLOWN INFRASTRUCTURE IN THE ABOVE ACCESSIBLE CEILING SPACES.

TECHNOLOGY RESPONSIBILITY MATRIX PROVISION RESPONSIBILITIES DEFINED **COMMUNICATIONS - TELECOM SYSTEMS:** POLICH IN DATHWAYS AND SLEEVES

ROUGH-IN, PATHWAYS AND SLEEVES				
RACKS, FRAMES AND ENCLOSURES	N/A	N/A	N/A	
CABLE MANAGEMENT	N/A	N/A	N/A	
UNINTERRUPTIBLE POWER SUPPLIES (RACK MOUNT)	N/A	N/A	N/A	
PLYWOOD BACKBOARDS			•	
COPPER BACKBONE CABLING	N/A	N/A	N/A	
OPTICAL FIBER BACKBONE CABLING	N/A	N/A	N/A	
COAXIAL BACKBONE CABLING	N/A	N/A	N/A	
COPPER HORIZONTAL CABLING			•	
OPTICAL FIBER HORIZONTAL CABLING	N/A	N/A	N/A	
COAXIAL BACKBONE CABLING	N/A	N/A	N/A	
DATA COMMUNICATIONS SWITCHES AND HUBS	N/A	N/A	N/A	
DATA COMMUNICATIONS WIRELESS ACCESS POINTS	N/A	N/A	N/A	
	N/A	N/A	N/A	

VOICE COMMUNICATIONS SWITCHING AND ROUTING EQUIPMENT	N/A	N/A	N/A	N/A
COMMUNICATIONS - AUDIO-VISUAL SYSTEMS:				
ROUGH-IN, PATHWAYS AND SLEEVES	N/A	N/A	N/A	N/A
PROJECTOR(S)	N/A	N/A	N/A	N/A
FLAT PANEL DISPLAY(S)	N/A	N/A	N/A	N/A
MULTI-TOUCH DISPLAY(S)	N/A	N/A	N/A	N/A
DISPLAY TECHNOLOGY MOUNTING HARDWARE	N/A	N/A	N/A	N/A
MEDIA PLAYER(S)	N/A	N/A	N/A	N/A
HEAD-END EQUIPMENT	N/A	N/A	N/A	N/A

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COMMUNICATIONS - DISTRIBUTED SYSTEMS:									
ROUGH-IN, PATHWAYS AND SLEEVES	N/A	N/A	N/A	N/A					
MASTER ANTENNA / COMMUNITY ANTENNA TELEVISION DISTRIBUTION	N/A	N/A	N/A	N/A					
PUBLIC ADDRESS SYSTEM	N/A	N/A	N/A	N/A					
SOUND MASKING / SPEECH PRIVACY SYSTEM	N/A	N/A	N/A	N/A					
INTERCOMMUNICATIONS SYSTEM	N/A	N/A	N/A	N/A					
WIRED / WIRELESS CLOCK SYSTEM	N/A	N/A	N/A	N/A					
NURSE CALL / CODE BLUE SYSTEM	N/A	N/A	N/A	N/A					

	,							
SECURITY - ACCESS CONTROL:								
ROUGH-IN, PATHWAYS AND SLEEVES								
SECURITY MANAGEMENT SYSTEM - HEAD END COMPONENTS			•					
SECURITY MANAGEMENT SYSTEM - FIELD DEVICES (1)			•					
SECURITY MANAGEMENT SYSTEM - ELECTRIFIED DOOR HARDWARE			•					
SECURITY MANAGEMENT SYSTEM - ALL CABLING			•					
SECURITY - AIPHONE VIDEO INTERCOM:								
ROUGH-IN, PATHWAYS AND SLEEVES								

N/A N/A N/A N/A

DOOR STATION(S)				
HEAD END EQUIPMENT AND COMPONENTS				
SECURITY - VIDEO SURVEILLANCE:		•		ı
ROUGH-IN, PATHWAYS AND SLEEVES				
CAMERA(S)	N/A	N/A	N/A	N/A
HEAD END EQUIPMENT AND COMPONENTS	N/A	N/A	N/A	N/A

SECURITY - INTRUSION DETECTION:			
ROUGH-IN, PATHWAYS AND SLEEVES			
FIELD DEVICES (MOTION DETECTORS, GLASS BREAKS, DOOR SWITCHES)			
HEAD END EQUIPMENT AND COMPONENTS			
SAFETY - FIRE DETECTION AND ALARM:		·	
ROUGH-IN, PATHWAYS AND SLEEVES			
INITIATING FIELD DEVICES (SMOKE, MANUAL PULL, MONITOR MODULES)			
NOTIFICATION APPLIANCES (HORNS, STROBES, SPEAKERS)			
MISCELLANEOUS DEVICES (RELAYS, TEST STATION, ANNUNCIATOR)			

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CFOI **C**ONTRACTOR **F**URNISHED & **O**WNER **I**NSTALLED

DISTRIBUTED ANTENNA SYSTEM

MATRIX IS NOT INTENDED TO BE EXHAUSTIVE TO COVER ALL MATERIALS NECESSARY FOR SCOPE AND SHOULD ONLY BE USED TO QUICKLY IDENTIFY SYSTEMS AND RELATED INFRASTRUCTURE INSIDE AND OUTSIDE THE BID OF THIS PROJECT. ANY ITEMS FURNISHED OR INSTALLED BY THE BIDDING CONTRACTOR SHALL COVER ALL REQUIRED APPERTUNANCES NECESSARY FOR A COMPLETE SYSTEM. THIS SHALL INCLUDE BUT NOT BE LIMITED TO, EQUIPMENT, ACCESSORIES, TERMINATIONS, TERMINATION COMPONENTS, ALL FINAL CORDAGE CONNECTIVITY, SOFTWARE, PROGRAMMING, AND THE LABOR TO INSTALL.

REFER TO COVER SHEET GENERAL NOTES FOR ADDITIONAL SYSTEM DESCRIPTIONS AND ANTICIPATED SCOPE OF WORK.

HID CARD READERS ARE OFCI. ALL OTHER FIELD DEVICES ARE CFCI UNLESS NOTED OTHERWISE.

FIRE DETECTION AND ALARM SYMBOLS

MANUAL FIRE ALARM PULL STATION

SMOKE DETECTOR

COMBINATION SPEAKER WITH STROBE - WALL MOUNTED

COMBINATION SPEAKER WITH STROBE - CEILING MOUNTED

STROBE - WALL MOUNTED

STROBE - CEILING MOUNTED

FIRE ALARM ANNUNCIATOR PANEL

FIRE ALARM NAC PANEL

FIRE ALARM CONTROL PANEL + EMERGENCY COMMUNICATIONS PANEL

VIDEO SURVEILLANCE SYMBOLS

VIDEO SURVEILLANCE CAMERA

ACCESS CONTROL & INTRUSION DETECTION SYMBOLS

PROXIMITY CARD READER, +44" OR AS NOTED (OFCI)

COMBINATION PROXIMITY CARD READER WITH PINPAD, +44" OR AS NOTED (OFCI)

DOOR POSITION SWITCH - SURFACE MOUNTED, DOUBLE POLE DOUBLE THROW (DPDT)

DOOR POSITION SWITCH - FLUSH MOUNTED, DOUBLE POLE DOUBLE THROW (DPDT)

ELECTRIC STRIKE - FLUSH OR SURFACE MOUNTED

ELECTRIFIED EXIT DEVICE (PANIC HARDWARE)

REQUEST TO EXIT PUSHBUTTON, +44" OR AS NOTED

MOMENTARY DOOR RELEASE PUSHBUTTON (OFCI)

LOCKOUT TOGGLE SWITCH, +46" OR AS NOTED

LOCKDOWN TOGGLE SWITCH, +46" OR AS NOTED

REFER TO ACCESS CONTROL DETAILS FOR ADDITIONAL DEVICE REQUIREMENTS

TELECOMMUNICATIONS INFRASTRUCTURE SYMBOLS

DATA OUTLET - CATEGORY 6A: PROVIDE NUMBER OF CABLES INDICATED BY '#' SHOWN AT EACH SYMBOL.

GENERAL SYMBOLS

E CONDUIT SLEEVE


CONDUIT UP, REFER TO TAG ON DRAWING FOR SIZE

CONDUIT DOWN, REFER TO TAG ON DRAWING FOR SIZE

JUNCTION BOX, CEILING OR FLOOR MOUNTED.

JUNCTION BOX, WALL MOUNTED, ELEVATION AS NOTED.

KEYNOTE

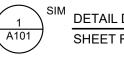

DETAIL DRAWING REFERENCE TAG, SIM-SIMILAR, TYP-TYPICAL, OPP-OPPOSITE SHEET REFERENCE



NOTE: ALL SYMBOLS MAY NOT APPLY TO THIS PROJECT

EXPIRES: 6/30/2023

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CURIT S

SHEET TITLE: **TECHNOLOGY GENERAL** NOTES &

REVISIONS:

DESCRP. DATE

SYMBOLS

ISSUE DATE: 03.15.23

E01

6.6.

VOLLEYBALL

COURT

1 2 EXISTING GYM CLOSET -

1 E02-C

18TH AVENUE

FIRE LANE

1)(2)EXISTING OUTBUILDING CLOSET

FIRE LANE

SITE GENERAL NOTES

- REFER TO SHEET E00 AND E01 FOR PROJECT GENERAL NOTES.
- CONDUIT ROUTING AND LOCATIONS SHOWN ARE SCHEMATIC. COORDINATE THE FINAL PROPOSED ROUTING WITH GENERAL CONTRACTOR AND OWNER'S REPRESENTATIVE.
- PROVIDE SAWCUTTING AND PATCHING OF EXISTING PAVEMENT WHERE REQUIRED TO ACCOMODATE NEW UNDERGROUND
- D. ABBREVIATIONS:
 - (E) EXISTING ITEM TO REMAIN (ER) - NEW LOCATION OF EXISTING ITEM (N) - NEW ITEM IN EXISTING LOCATION
 - (D) DEMOLISHED ITEM, PATCH AND/OR COVER (RN) - REPLACE EXISTING WITH NEW (RR) - EXISTING ITEM TO BE REMOVED AND RELOCATED

KEYNOTES

- LOCATION OF EXISTING LENEL ACCESS CONTROL LNL2000 INTELLIGENT SYSTEM CONTROLLER, 1320 READER CARDS AND POWER SUPPLIES.
- REFER TO RISER DIAGRAM DETAILS ON FOR NEW ACCESS CONTROL SYSTEM EQUIPMENT AND REQUIREMENTS.





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4J SECURITY IMPROVEM

SHEET TITLE: CHURCHILL H.S. SITE PLAN - ELECTRICAL

REVISIONS:

DESCRP. DATE

ISSUE DATE: 03.15.23

E01-C

A. REFER TO SHEET E00 AND E01 FOR PROJECT GENERAL NOTES.

B. ABBREVIATIONS:

(E) EXISTING ITEM TO REMAIN

(ER) NEW LOCATION OF EXISTING ITEM

(N) NEW ITEM IN EXISTING LOCATION

DEMOLISHED EXISTING ITEM, PATCH AND/OR COVER

(RN) REPLACE EXISTING WITH NEW
(RR) EXISTING ITEM TO BE REMOVED AND RELOCATED

KEYNOTES

AIPHONE DESKTOP MASTER CONTROL STATION, VERIFY FINAL LOCATION WITH OWNER PRIOR TO INSTALLATION. PROVIDE SYSTEM PATHWAYS AND CABLING FROM EXTERIOR DEVICE. WHERE PATHWAYS ARE EXPOSED, PROVIDE DECORATIVE SURFACE MOUNT RACEWAY PER SPECIFICATIONS AND PAINT AS DIRECTED BY THE ARCHITECT. PROVIDE CABLING INTERCONNECTED WITH THE EXISTING LENEL ACCESS CONTROL SYSTEM TO ALLOW MOMENTARY DOOR OVERRIDE FUNCTIONALITY FROM THE MASTER CONTROL UNIT TO DOOR G51. PROVIDE RELAYS, WIRING AND PROGRAMMING AS REQUIRED FOR A FULLY FUNCTIONAL SYSTEM.

AIPHONE VIDEO INTERCOM, INSTALL PER SPECIFICATIONS AND MANUFACURER'S RECOMMENDATIONS.

POWER SUPPLIES AND DMP INTRUSION SYSTEM CABINETS.

DISCONNECT AND REMOVE EXISTING AIPHONE EQUIPMENT AND PREPARE SURFACE FOR NEW DEVICE. REMOVE ANY ASSOCIATED INTERIOR DEVICES AND CABLING. EXISTING LENEL ACCESS CONTROL SYSTEM CABINETS,

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4J SECURITY IMPROVEME PROJECT#: 2207


SHEET TITLE: CHURCHILL H.S. FLOOR PLAN -**ELECTRICAL**

REVISIONS:

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ISSUE DATE: 03.15.23

E02-C

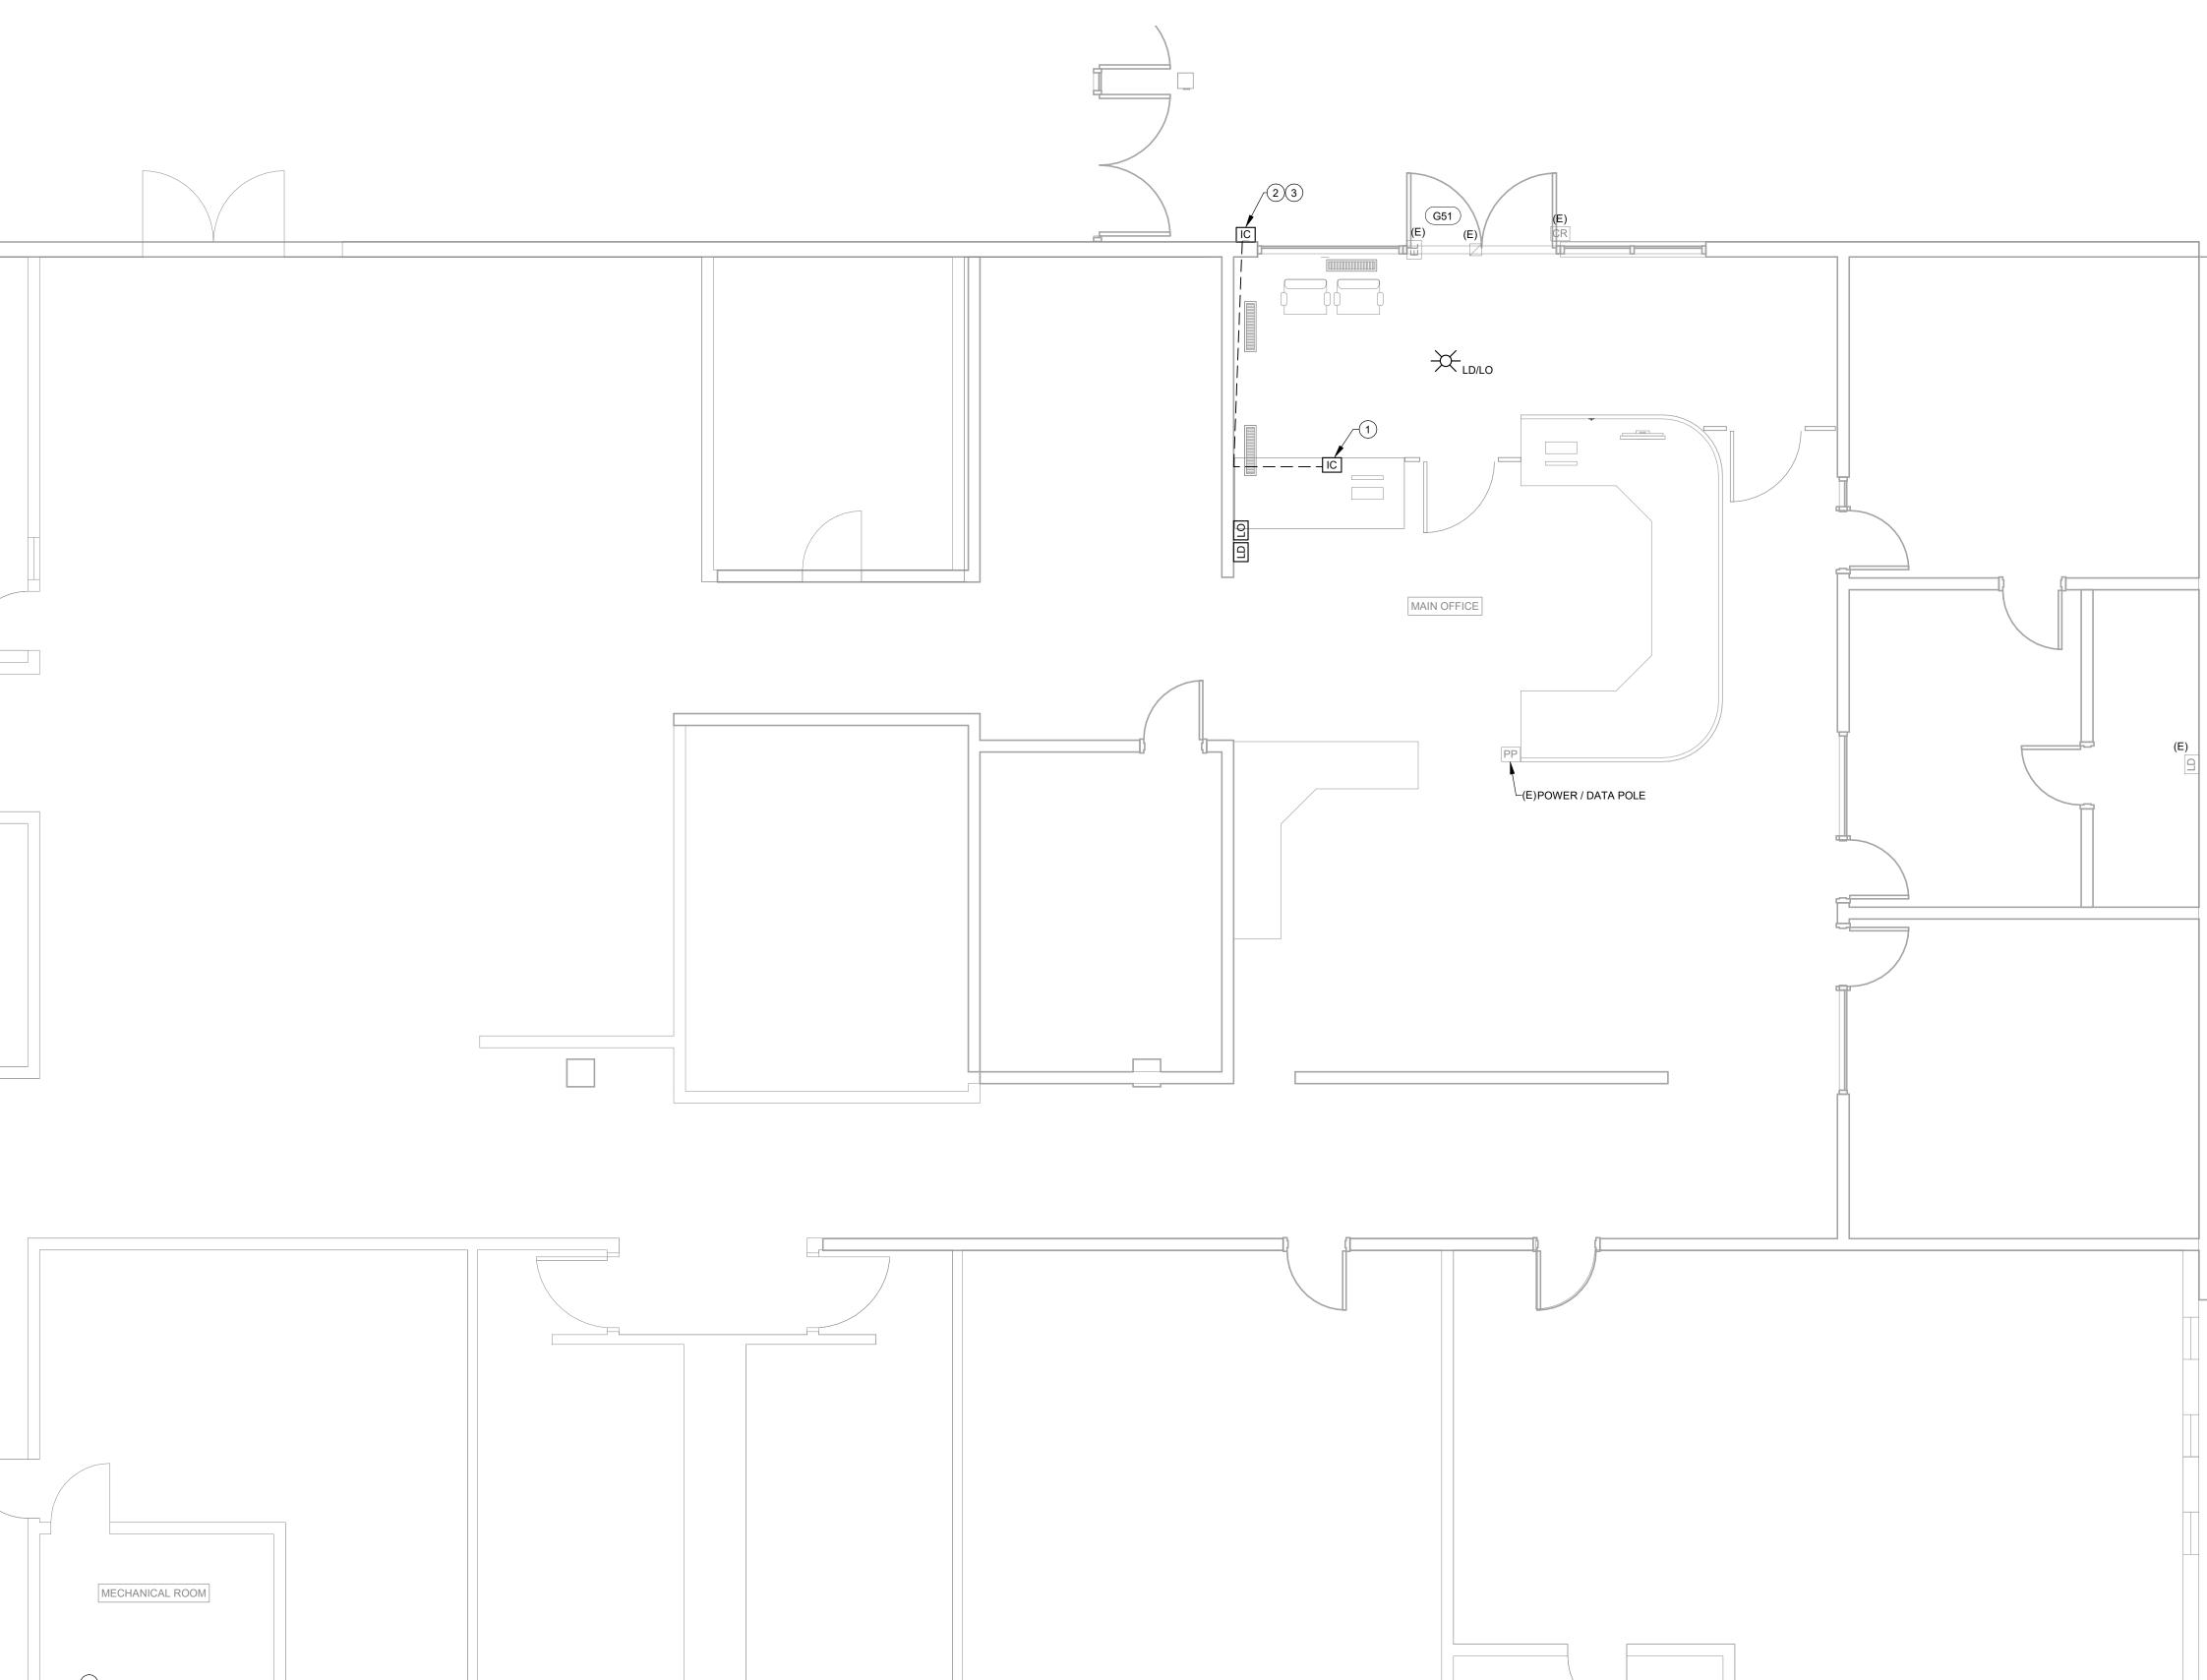

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SECURITY |

SHEET TITLE: **TECHNOLOGY** RISER **DIAGRAMS** -CHURCHILL


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E12-C



SCHEDULED ACCESS CONTROL OPENINGS,

PUSHBUTTONS, ETC

A. LENEL ONGUARD ACCESS CONTROL SYSTEM IS EXISTING. PROVIDE THE MAJOR SYSTEM COMPONENTS ILLUSTRATED ACCOMODATE NEWLY SCHEDULED EQUIPMENT.

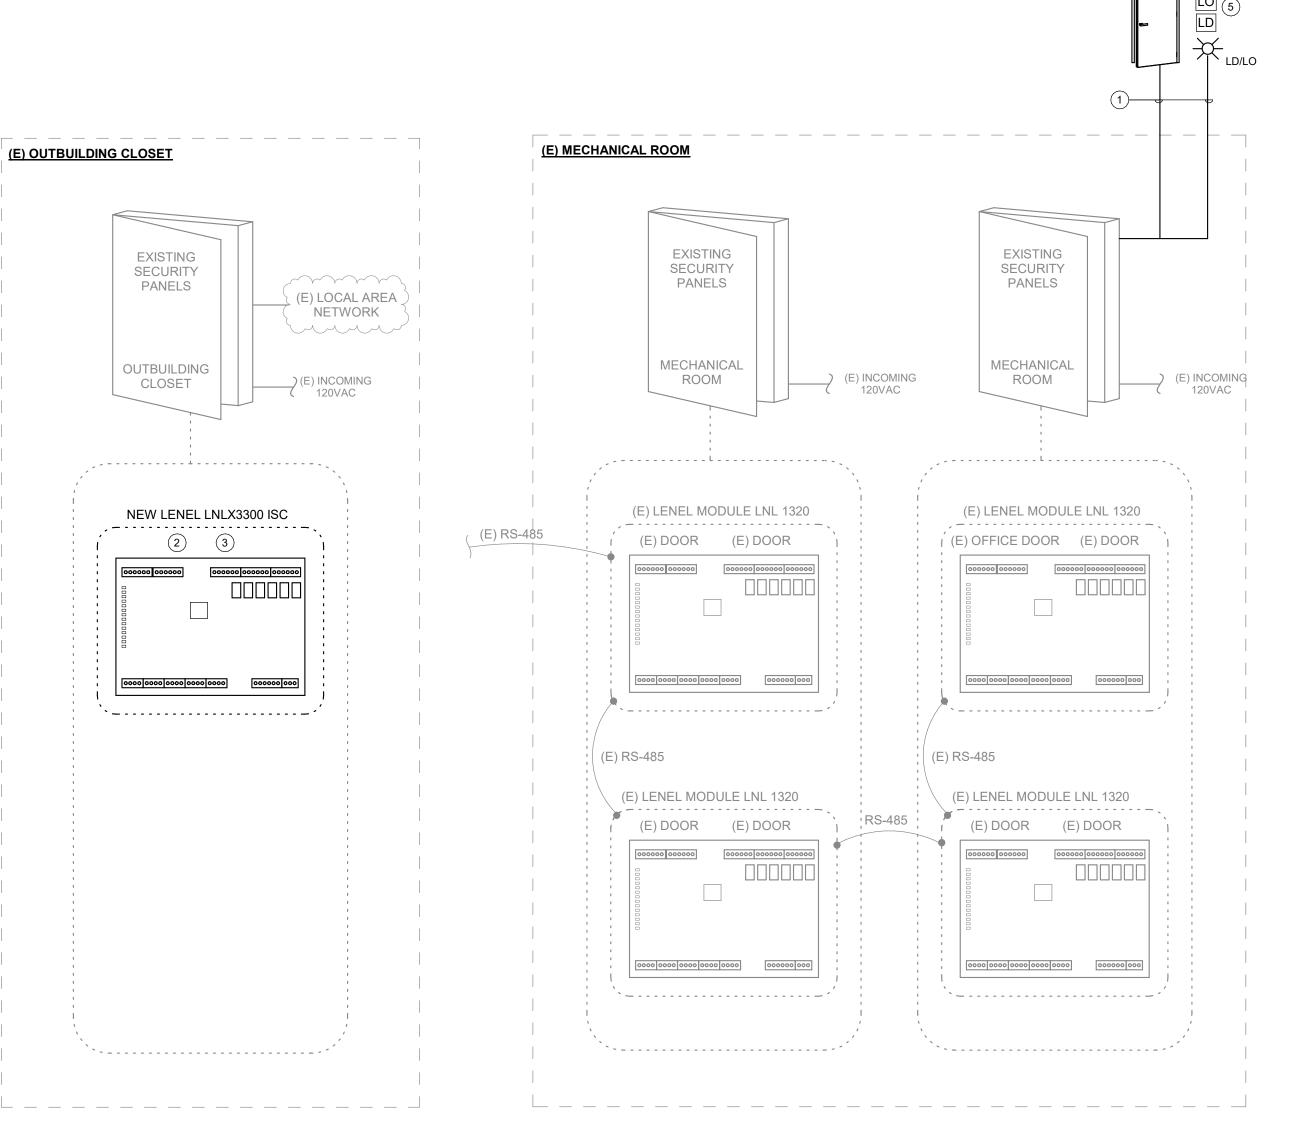THE INTENT OF THE RISER DIAGRAMS ARE TO IDENTIFY MAJOR SYSTEM COMPONENTS. CONSULT MANUFACTURER RECOMMENDATIONS AND PROVIDE WIRING, COMPONENTS, ETC AS REQUIRED TO DELIVER A FULLY FUNCTIONAL SYSTEM.

C. REFER TO FLOOR PLANS FOR EQUIPMENT LOCATIONS.

PROGRAMMING IS BY THE BIDDING CONTRACTOR AT THE DIRECTION

COORDINATE AC POWER REQUIREMENTS WITH DIVISION 26 CONTRACTOR.

F. ABBREVIATIONS:

(E) - EXISTING ITEM TO REMAIN (ER) - NEW LOCATION OF EXISTING ITEM (N) - NEW ITEM IN EXISTING LOCATION

(D) - DEMOLISHED ITEM, PATCH AND/OR COVER (RN) - REPLACE EXISTING WITH NEW (RR) - EXISTING ITEM TO BE REMOVED AND RELOCATED

MULTI-CABLE, MULTI-CONDUCTOR COMPOSITE CABLE (TYP. FOR EACH CONTROLLER). REFER TO ACCESS CONTROL DETAILS AND SPECIFICATIONS FOR WIRING REQUIREMENTS.

DISCONNECT AND REMOVE EXISTING LNL2000 ISC AND REPLACE WITH NEW LNLX3300 ISC. RECONNECT EXISTING CABLING AND CONNECTIONS TO MATCH EXISTING CONDITIONS. PROVIDE PROGRAMMING, ADDRESSING AND RECONFIGURATION AS REQUIRED TO MATCH EXISTING CONDITIONS IN COORDINATION WITH 4J SCHOOL DISTRICT.

FIELD MODIFY EXISTING INCOMING RS-485 SERIAL COMMUNICATION WIRING TO ACCOMODATE THE REDUCTION IN AVAILABLE PORTS ON THE LNLX3300 ISC.

(E) GYM CLOSET

EXISTING

SECURITY

PANELS

GYM CLOSET

NEW LENEL LNLX3300 ISC

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2 3

(E) LOCAL AREA

NETWORK



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SECURITY IMPROVEM

4J SHEET TITLE: **ELECTRICAL**

DETAILS - ALL

SITES

REVISIONS: # DESCRP. DATE

ISSUE DATE: 03.15.23


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STUB CONDUIT TO ABOVE CEILING SPACE - PULL STRING SUPPORTS ACCESSIBLE CEILING 1" MINIMUM -CONDUIT MINIMUM (2) —— CATEGORY 6A CABLES SQUARE 4 11/16" X 2 1/8" DEEP BOX W/SINGLE GANG REDUCER.

GENERAL NOTE:

A. EVERY WORK AREA OUTLET (WAO) GETS ONE TYPICAL ROUGH-IN.

TYPICAL CONDUIT PATHWAY TO WORK AREA DATA OUTLET 2 CONDUIT PATHWAY TO DATA OUTLET

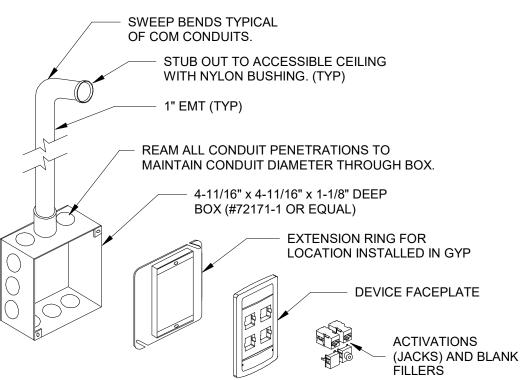


NOTES:
A. FOR EACH DATA WORK AREA OUTLET, WITH EXCEPTION TO FLAT PANEL TELEVISION LOCATIONS, PROVIDE A 2-GANG BOX WITH A SINGLE-GANG

B. INSTALL ONE (1) 1" CONDUIT STUBBED OUT TO THE ABOVE ACCESSIBLE CEILING IN THE SAME ROOM UNLESS OTHERWISE NOTED. IF THE ROOM DOES NOT HAVE A LAY-IN GRID CEILING, ROUTE CONDUITS TO ABOVE THE NEAREST ACCESSIBLE CEILING SPACE. PROVIDE NYLON BUSHINGS ON CONDUIT ENDS TO PROTECT CABLING.

WALL MOUNTED DATA OUTLET DETAIL

1 DATA OUTLET DETAIL

ACCESS CONTROL DETAIL - TYPE A

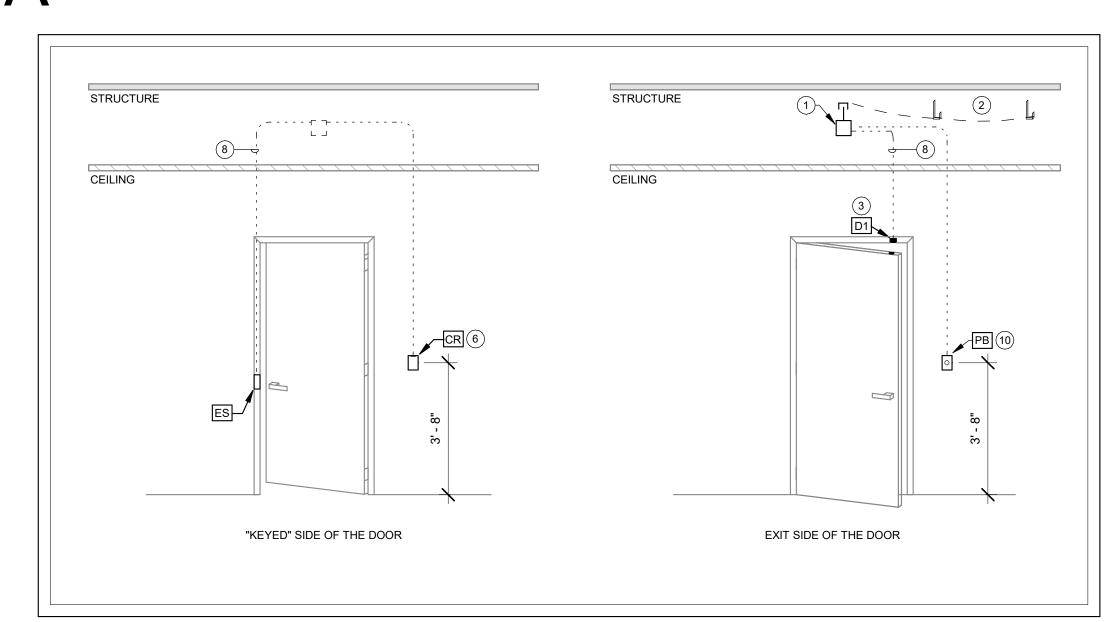


FOR TYPE C.1 OMIT CARD READER

"KEYED" SIDE OF THE DOOR

STRUCTURE


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ACCESS CONTROL DETAIL - TYPE D

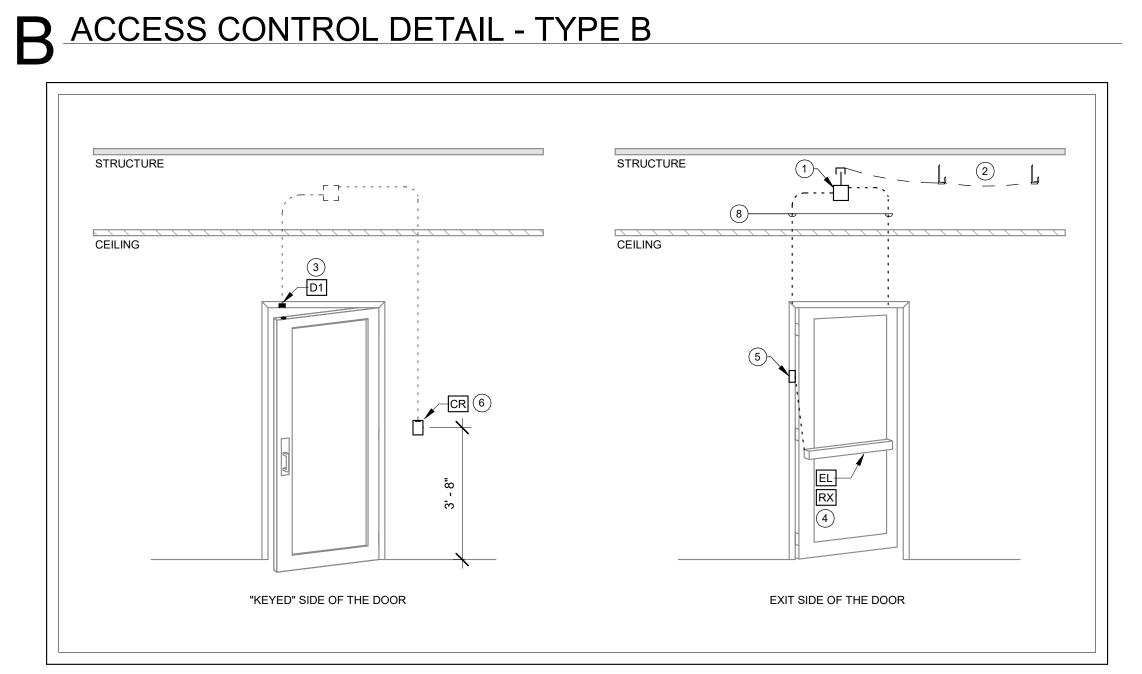ACCESS CONTROL DETAIL - TYPE E

ACCESS CONTROL DETAIL - TYPE C & C.1



STRUCTURE

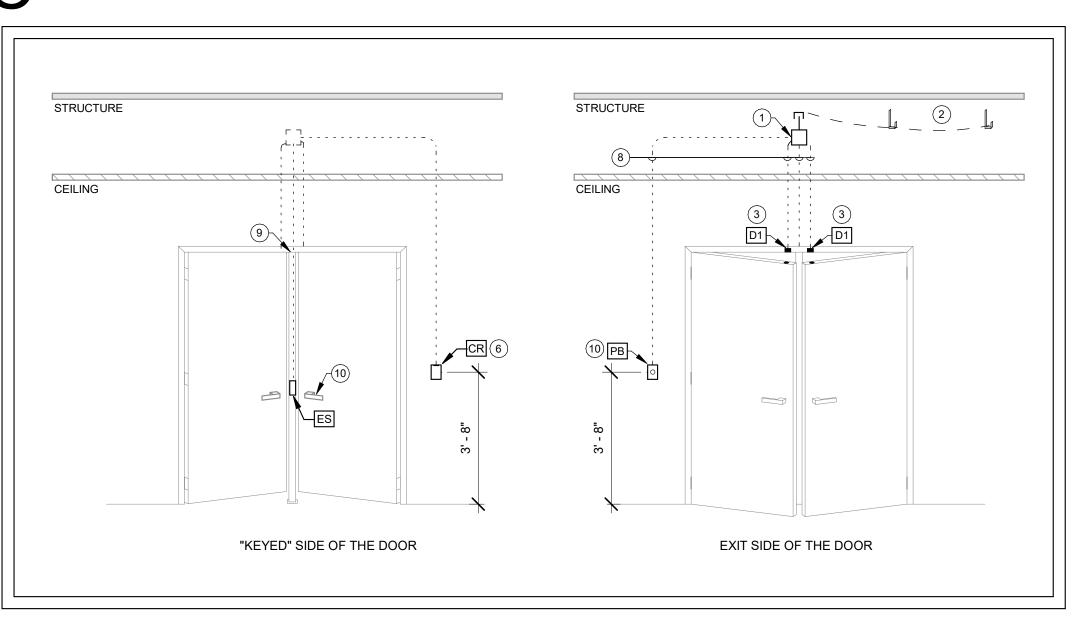CEILING

EXIT SIDE OF THE DOOR

GENERAL NOTES:

- ACCESS CONTROL SYSTEM SHALL BE PROVIDED BY THE BIDDING CONTRACTOR. DETAILS ILLUSTRATED HERE ARE INTENDED TO ILLUSTRATE PATHWAY, ROUGH-IN DEVICE AND CABLING REQUIREMENTS. REVIEW SPECIFICATION 08 71 00 FOR SPECIFIC ELEMENTS SCHEDULED AT EACH OPENING.
- LENEL ONGAURD ACCESS CONTROL SYSTEM IS EXISTING. THE CONTRACTOR IS RESPONSIBLE FOR COORDINATING PROGRAMMING WITH 4J SCHOOL DISTRICT SECURITY DEPARTMENT.
- PROVIDE ELECTRIFIED LOCKSETS WITH CENTRALIZED LOW VOLTAGE POWER. INDIVIDUAL POWER SUPPLIES INSTALLED AT EACH OPENING IS NOT ACCEPTABLE. COORDINATE FINAL VOLTAGE AND AMPERAGE REQUIREMENTS WITH THE SPECIFIED DOOR HARDWARE.
- IT IS THE INTENT THAT PATHWAYS AND ROUGH-IN SERVING ACCESS CONTROL DEVICES ARE RECESSED AND CONCEALED. EXPOSED CABLING SHALL NOT BE ACCEPTED UNLESS APPROVED BY THE ARCHITECT. WHERE SURFACE MOUNT IS REQUIRED, ENSURE PATHWAYS ARE PROVIDED IN ACCORDANCE WITH SPECIFICATIONS AND PAINTED TO MATCH SURROUNDING FINISHES.
- DEVICES INCLUDING CARD READERS MAY BE LOCATED ON A DIFFERENT WALL. REFER TO THE DRAWING SET AND ELEVATIONS FOR WHICH SIDE COMPONENTS ARE LOCATED.
- DETAILS NOT INTENDED TO ACCURATELY ILLUSTRATE CEILING TYPES, CEILING AND DECK HEIGHTS, DOOR SWING OR DOOR FINISHES. COORDINATE EACH OPENING'S SPECIFIC ROUGH-IN AND PATHWAY NEEDS WITH ARCHITECTURAL PLANS AND ELEVATIONS.
- ALL CONDUIT SHALL BE PROVIDED A PULL STRING TO ALLOW EASE OF CABLING INSTALLATION.

KEYNOTES:

- ACCESS CONTROL JUNCTION BOX, PROVIDE ONE (1) 4-SQUARE BOX ABOVE THE NEAREST CONCEALED, ACCESSIBLE CEILING SPACE. THIS BOX SHALL BE USED AS A JUNCTION POINT FOR ALL DOOR DEVICE
- PROVIDE SECURITY MANAGEMENT SYSTEM CABLING BACK TO THE HEAD END /CONTROL CABINET USING ITS OWN DEDICATED PATHWAYS. PROVIDE SUPPORTS PER SPECIFICATIONS TO SERVE THIS INFRASTRUCTURE.
- PREPARE FRAME FOR THE INSTALLATION OF DOOR CONTACT. CONTACT SHALL BE CONNECTED TO THE INTRUSION DETECTION SYSTEM. COORDINATE ZONING WITH 4J SCHOOL DISTRICT.
- THE SCHEDULED DOOR HARDWARE HOSTS BUILT-IN MOMENTARY SWITCHES TO INTERFACE THE REQUST TO EXIT FUNCTION FOR
- ELECTRONIC POWER TRANSFER. PROVIDE A 1/2" PATHWAY TO THE FRAME TO SERVE THE ELECTRIFIED EXIT DEVICE.
- PROVIDE SINGLE GANG JUNCTION BOX AND (1) 1" CONDUIT PATHWAY TO SERVE NEW CARD READER AND CABLING. CARD READER IS OWNER-FURNISHED, CONTRACTOR-INSTALLED.
- CARD READER AND CABLING IS EXISTING TO REMAIN AT DOOR "SH3", PROTECT IN PLACE.
- PROVIDE A 1/2" CONDUIT PATHWAY TO THE FRAME.
- CENTER MULLION.
- PROVIDE SINGLE GANG JUNCTION BOX TO SERVE PUSHBUTTON REQUEST TO EXIT, CAMDEN #CM-353.
- SURFACE MOUNT CARD READER ON CENTER POST. PROVIDE DEVICE WITH HID IP65GSKT GASKET KIT. CARD READER IS OWNER-FURNISHED, CONTRACTOR-INSTALLED.
- ROUTE SECURITY MANAGEMENT SYSTEM CABLING UNDERGROUND TO MDF/IDF LOCATION, REFER TO DRAWINGS FOR ROUTING REQUIREMENTS AT EACH INSTANCE.

DEVICE AND CABLING LEGEND:

- D1 FLUSH-MOUNT DOOR POSITION SWITCH 22 AWG / 4 CONDUCTOR
- D2 SURFACE-MOUNT DOOR POSITION SWITCH- 22 AWG / 4 CONDUCTOR
- CR CARD READER (OFCI) 22 AWG / 8 CONDUCTOR
- EL ELECTRIFIED EXIT DEVICE 12 AWG / 2 CONDUCTOR
- ES ELECTRIFIED STRIKE 16 AWG / 2 CONDUCTOR
- NL NON-ELECTRIFIED LATCH (MECHANICAL EXIT) NO WIRING NECESSARY

CABLING NOTES:

- CABLING DEFINITIONS ARE BASED ON DISTRICT STANDARD WIRING APPROACH. COORDINATE WIRE GAUGE WITH VOLTAGE, AMPERAGE, AND DISTANCE REQUIREMENTS.
- CABLING SHALL BE STRANDED TYPE WITH ORANGE JACKET.
- REFER TO SPECIFICATIONS FOR ADDITIONAL CABLING INFRASTRUCTURE REQUIREMENTS.



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SECURITY I

SHEET TITLE: **ACCESS** CONTROL **DOOR DETAILS**

REVISIONS:

- ALL SITES

DESCRP. DATE

ISSUE DATE: 03.15.23

E21