

SHEET TITLE: _____

GENERAL INFORMATION

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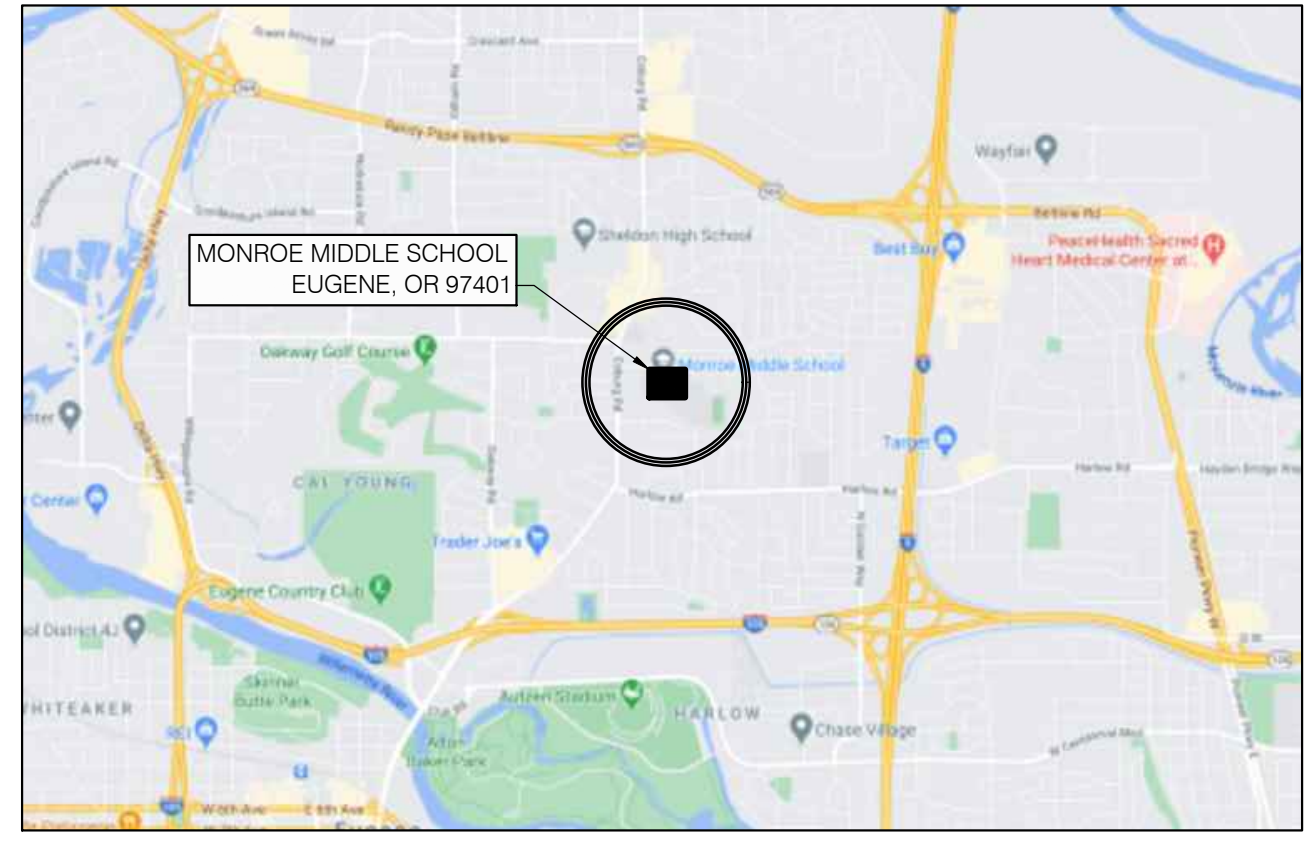
Date:	OCTOBER 29, 2021
Revisions:	
Drawn:	TWB
Checked:	BAR
File:	GHGen_Info
Job:	R3282.07

SHEET NUMBER:
GI-1

EUGENE SCHOOL DISTRICT 4J

MONROE MIDDLE SCHOOL ROOF REPLACEMENT PROJECT

SITE MAPS



1 LOCATION MAP
GI-1 SCALE: NTS



2 VICINITY MAP
GI-1 SCALE: NTS



3 AERIAL VIEW
GI-1 SCALE: NTS

DRAWING SCHEDULE

GI-1	GENERAL INFORMATION
GI-2	SYSTEM ASSEMBLIES
R100	DEMOLITION PLAN
R101	ROOF PLAN
R200	DETAILS - BASE BID
R201	DETAILS - ALTERNATE NO. 1
S100	GENERAL STRUCTURAL NOTES AND FALL PROTECTION STRUCTURAL NOTES
S101	ROOF PLAN WIND LOAD DIAGRAM
S102	STRUCTURAL DETAILS

GENERAL NOTES

1. CONTRACTOR IS RESPONSIBLE FOR VERIFYING ALL DIMENSIONS AND CONDITIONS OF THE PROJECT, INCLUDING VERIFICATION OF EXISTING ROOF SYSTEM CONSTRUCTION AND MATERIALS.
2. EXISTING MATERIALS AND CONSTRUCTION ARE NOTED ON THE DRAWINGS AS EXISTING. ALL OTHER NOTATIONS INDICATE NEW MATERIALS, PRODUCTS, AND CONSTRUCTION UNLESS OTHERWISE STATED OR INDICATED.
3. ALL PERMITTING, INCLUDING ROAD CLOSURES, PARKING STALLS, SIDEWALK CLOSURES, SCAFFOLD ERECTION, ETC. SHALL BE COORDINATED, OBTAINED, AND PAID FOR BY CONTRACTOR.
4. CONTRACTOR STAGING AND STORAGE AREAS SHALL BE AS DIRECTED BY THE OWNER'S REPRESENTATIVE AT THE PRE-CONSTRUCTION MEETING. CONTRACTOR SHALL ASSUME A REASONABLE AMOUNT OF STORAGE, AND STAGING SPACE WILL BE MADE AVAILABLE.
5. IT IS THE RESPONSIBILITY OF THE CONTRACTOR TO PROTECT BUILDING OCCUPANTS AND PASSERS-BY FROM FALLING DEBRIS OR EQUIPMENT AT ALL TIMES DURING THE COURSE OF CONSTRUCTION. DO NOT THROW MATERIALS FROM THE ROOF.
6. CONTRACTOR SHALL BE RESPONSIBLE FOR PROTECTING BUILDING SURFACES, FINISHES, AND SYSTEMS FROM DAMAGE, DISCOLORATION, ETC. DURING THE COURSE OF ALL CONSTRUCTION ACTIVITIES.
7. PERSONAL FALL PROTECTION DEVICES ARE NOT, NOR WILL BE, PROVIDED BY THE OWNER ON ANY ROOF AREA DESIGNATED TO RECEIVE WORK. PERSONAL FALL PROTECTION IS THE RESPONSIBILITY OF THE CONTRACTOR.
8. ALL CONSTRUCTION SHALL CONFORM TO THE 2019 OREGON STRUCTURAL SPECIALTY CODE (2019 OSSC), AND ALL LOCAL GOVERNING BUILDING CODES AND ORDINANCES.
9. IT SHALL BE THE RESPONSIBILITY OF THE CONTRACTOR TO LOCATE ALL EXISTING UTILITIES WHETHER SHOWN HEREIN OR NOT, AND TO PROTECT UTILITIES FROM DAMAGE. THE CONTRACTOR SHALL BEAR ALL EXPENSES OF REPAIR OR REPLACEMENT OF UTILITIES OR OTHER PROPERTY DAMAGED BY OPERATIONS IN CONJUNCTION WITH THE EXECUTION OF THE WORK.
10. ROOF ACCESS BY MEANS OF EXTERNAL LIFT OF OTHER DEVICE UNLESS SPECIFICALLY APPROVED BY THE OWNER.
11. ALL ITEMS TRANSPORTED TO ROOF SHALL BE TRANSPORTED USING APPROVED AND SAFE METHODS OF LOADING.
12. SCOPE OF WORK CONSISTS OF THIS DRAWINGS SET AND THE ASSOCIATED PROJECT MANUAL.
13. EXISTING ROOF SYSTEMS HAVE BEEN TESTED FOR ASBESTOS CONTAINING MATERIALS (ACM). NO ASBESTOS WAS IDENTIFIED WITHIN ROOFING SAMPLES TAKEN FROM ROOF AREAS TO BE REPLACED AS PART OF THIS SCOPE OF WORK.
14. WHILE NOT TESTED FOR ASBESTOS CONTAINING MATERIALS (ACM), ALL REPAIR MASTICS/SEALANTS ARE ASSUMED TO BE ACM. ADDITIONAL TESTING MAY BE REQUIRED BY THE CONTRACTOR TO ENSURE ALL MATERIALS TO BE DEMOLISHED ARE HANDLED APPROPRIATELY WITH REGARD TO OROSHA, DEQ AND THE OWNER.
15. THIS PROJECT INCLUDES A BASE BID AND AN ALTERNATE. BID WORK DOES NOT INCLUDE ANY INCREASE IN AREA OR CHANGES IN OCCUPANCY.

BASE BID: INCLUDES, BUT IS NOT LIMITED TO: COMPLETE REMOVAL OF EXISTING BUILT-UP ROOF MEMBRANE ASSEMBLY AT ROOF AREA E DOWN TO THE SEISMIC SHEATHING OVERLAY ABOVE THE STRUCTURAL DECK. REMOVAL OF EXISTING ASSOCIATED FLASHING ASSEMBLIES AND ROOF DRAINS. INSTALLATION OF BUILT-UP ROOF MEMBRANE ASSEMBLY, FLASHINGS, WALL PANELS, SCUPPERS, AND COPING. REFERENCE SHEET GI-2 FOR ADDITIONAL INFORMATION REGARDING THE BASE BID MEMBRANE ASSEMBLY.

ALTERNATE NO. 1: INCLUDES, BUT IS NOT LIMITED TO: COMPLETE REMOVAL OF EXISTING BUILT-UP ROOF MEMBRANE ASSEMBLIES AT ROOF AREAS B, D, F & H DOWN TO THE SEISMIC SHEATHING OVERLAY ABOVE THE STRUCTURAL DECK. REMOVAL OF EXISTING ASSOCIATED FLASHING ASSEMBLIES, CURBED EDGE METAL AND ROOF DRAINS. INSTALLATION OF DECK INFILL AT REMOVED ROOF DRAINS. INSTALLATION OF BUILT-UP ROOF MEMBRANE ASSEMBLY, FLASHINGS, WALL PANELS, GUTTERS, AND COPING. REFERENCE SHEET GI-2 FOR ADDITIONAL INFORMATION REGARDING THE BASE BID MEMBRANE ASSEMBLY. REPAIRS AT ROOF AREAS C & G CONSISTING OF PATCHING AND COATING WHERE INDICATED.


BUILDING DATA

MAXIMUM TOP OF ROOF DECK HEIGHT (OF AREAS TO BE RE-ROOFED):	26-FEET
EXPOSURE:	B
RISK CATEGORY:	III
BASIC WIND SPEED:	105 MPH

PROJECT TEAM


<p>OWNER</p> <p>Eugene School District 4J 200 N. Monroe St. Eugene, OR 97402 tel: (541) 790-7700 fax: (541) 790-7711 Contact: Kirk Gebb, Capital Improvement Program</p>	<p>ROOF CONSULTANT</p> <p>Professional Roof Consultants, Inc. 1108 SE Grand Ave., Suite 300 Portland, Oregon 97214 tel: (503) 280-8759 fax: (503) 280-8866 Contact: Thomas Bertrand, RRO, AHERA</p>	<p>STRUCTURAL CONSULTANT</p> <p>TM Rippey Consulting Engineers 7650 SW Beveland St. Suite 100 Tigard, Oregon 97223 tel: (503) 443-3900 fax: (503) 443-3700 Contact: Ralph Turnbaugh, P.E.</p>
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DRAWING SYMBOLS

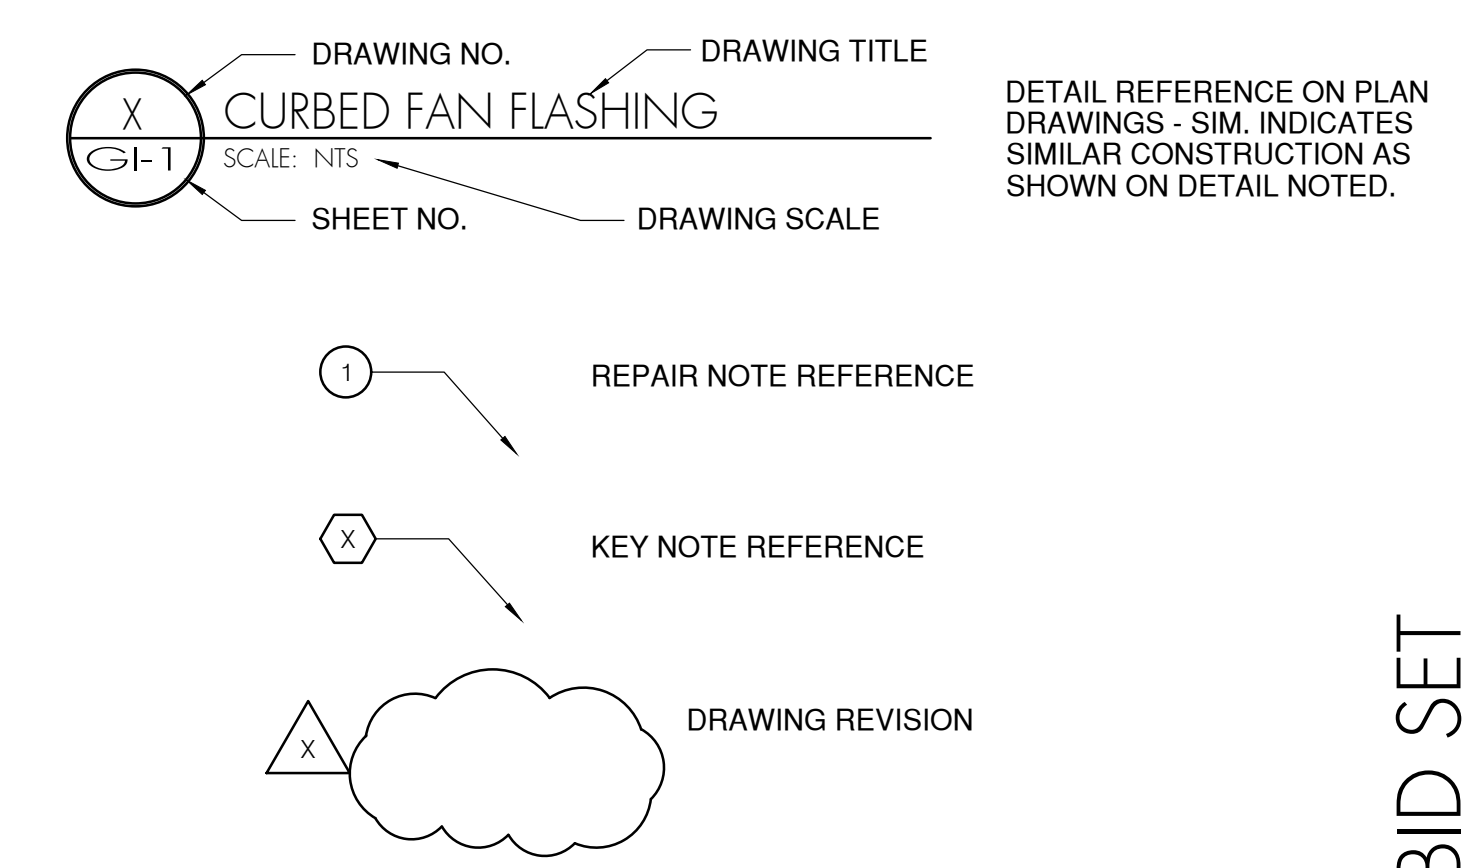


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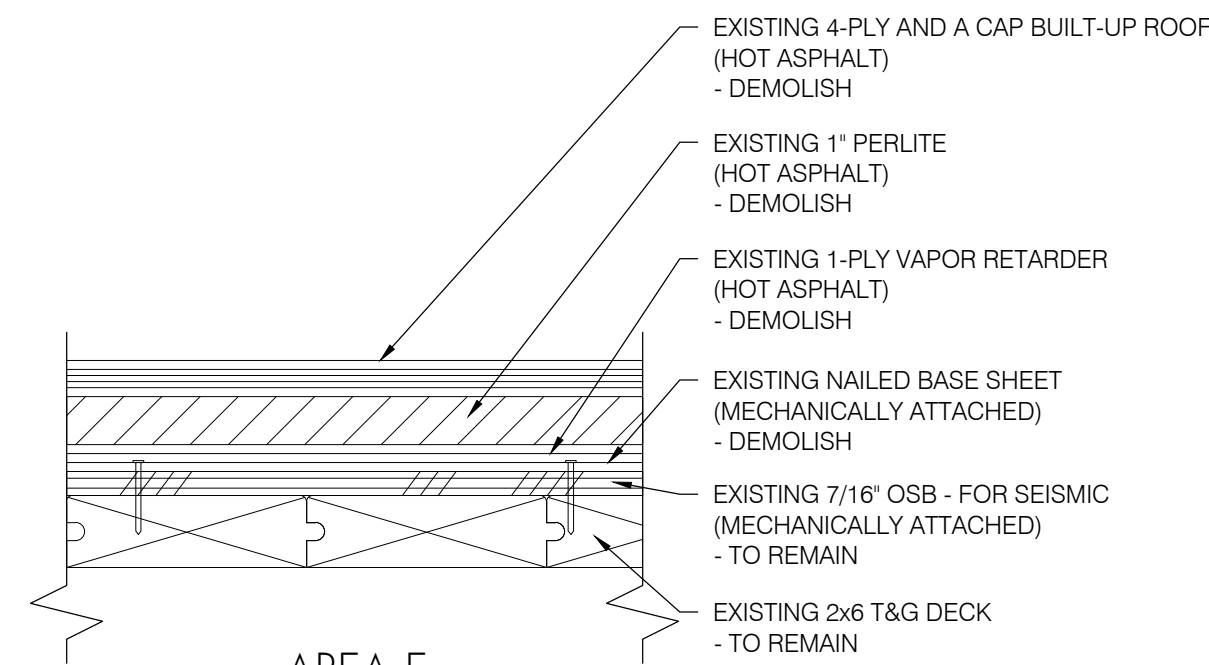
EXISTING ROOF SYSTEMS




1
GI-2
AREA B
EXISTING ROOF ASSEMBLY
 SCALE: 3" = 1'-0"

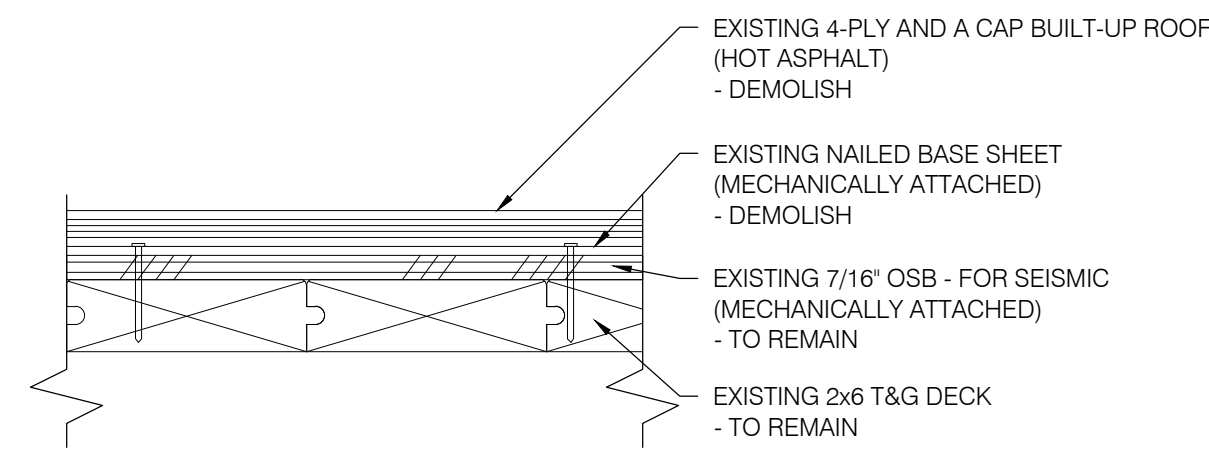

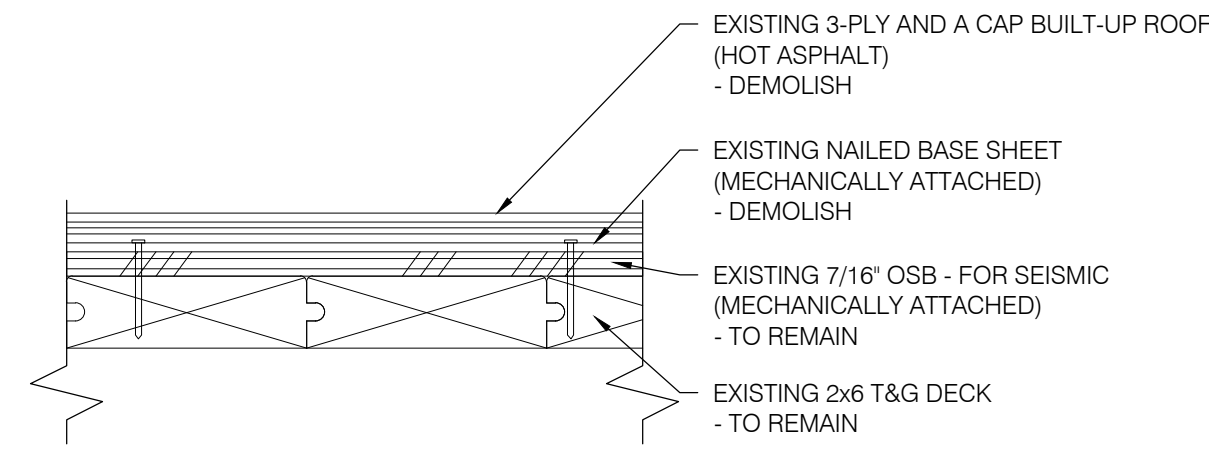2
GI-2
AREAS D & H
EXISTING ROOF ASSEMBLY
 SCALE: 3" = 1'-0"




3
GI-2
AREA E
EXISTING ROOF ASSEMBLY
 SCALE: 3" = 1'-0"

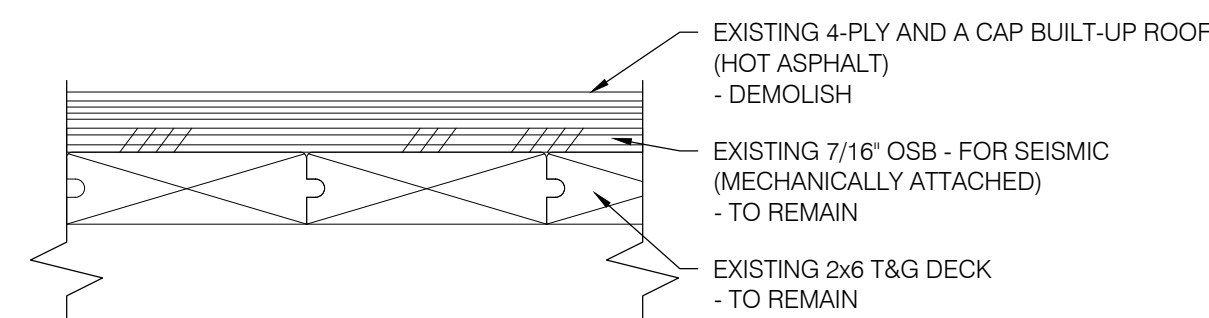


4
GI-2
AREA F
EXISTING ROOF ASSEMBLY
 SCALE: 3" = 1'-0"

NEW ROOF SYSTEMS

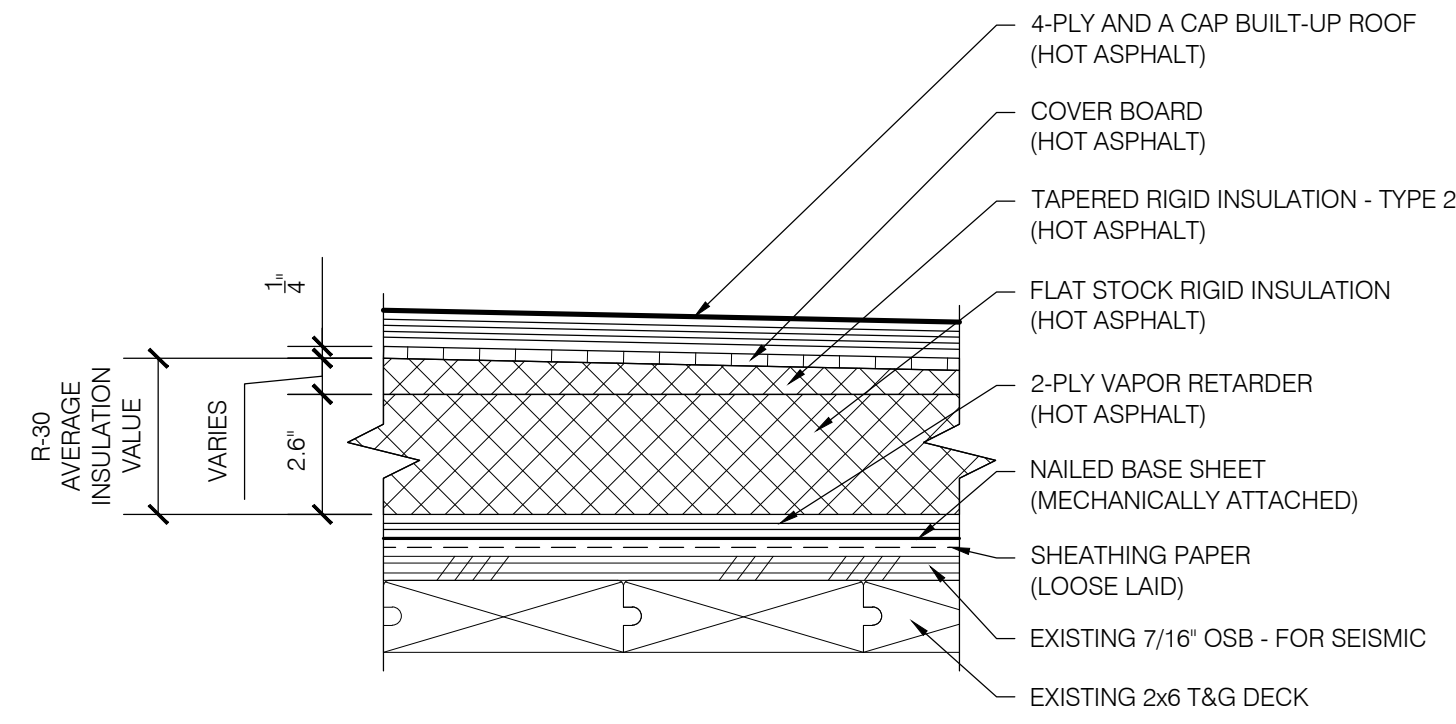

5
GI-2
AREA E
ROOF ASSEMBLY 1
 SCALE: 3" = 1'-0"

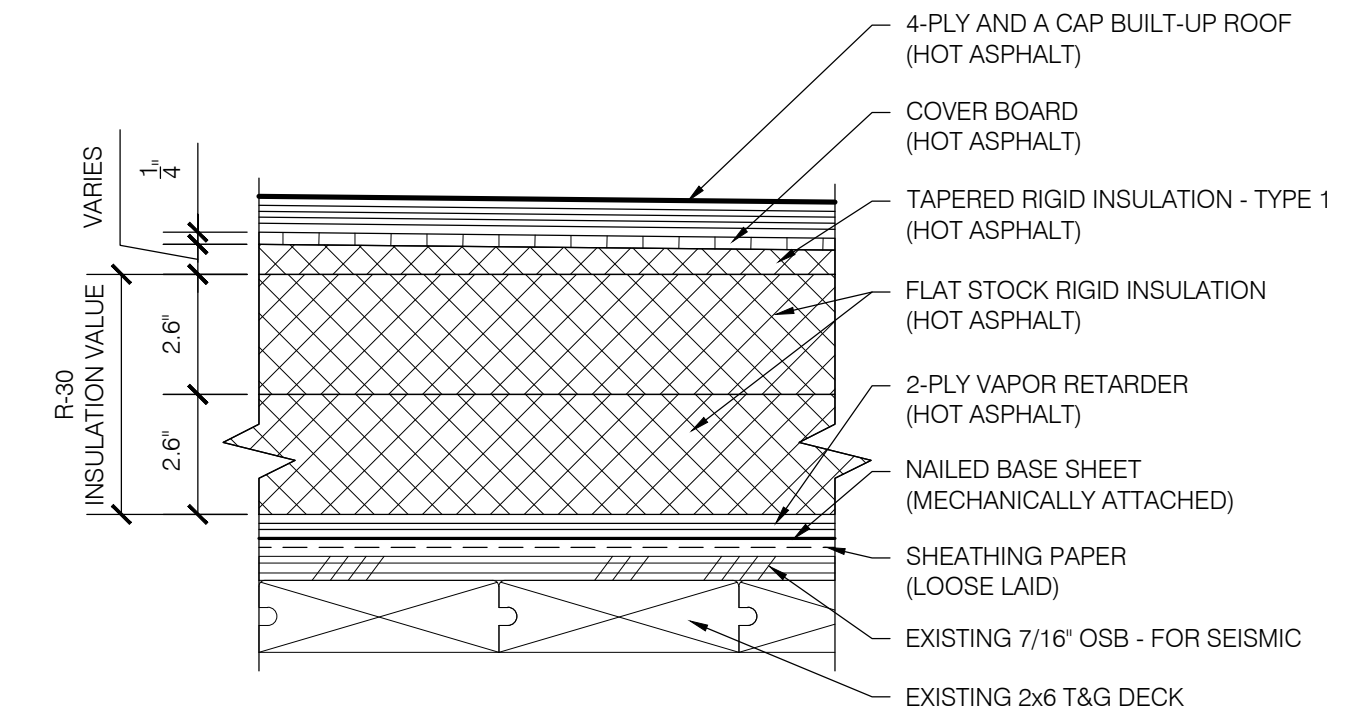

6
GI-2
AREAS B, D, F & H
ROOF ASSEMBLY 2 - ALTERNATE NO. 1
 SCALE: 3" = 1'-0"



EUGENE SCHOOL DISTRICT 4J MONROE MIDDLE SCHOOL ROOF REPLACEMENT

SHEET TITLE:
 SYSTEM ASSEMBLIES

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SHEET NUMBER:
GI-2

REBID SET

**EUGENE SCHOOL DISTRICT 4J
 MONROE MIDDLE SCHOOL
 ROOF REPLACEMENT**

SHEET TITLE:
 DEMOLITION PLAN

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







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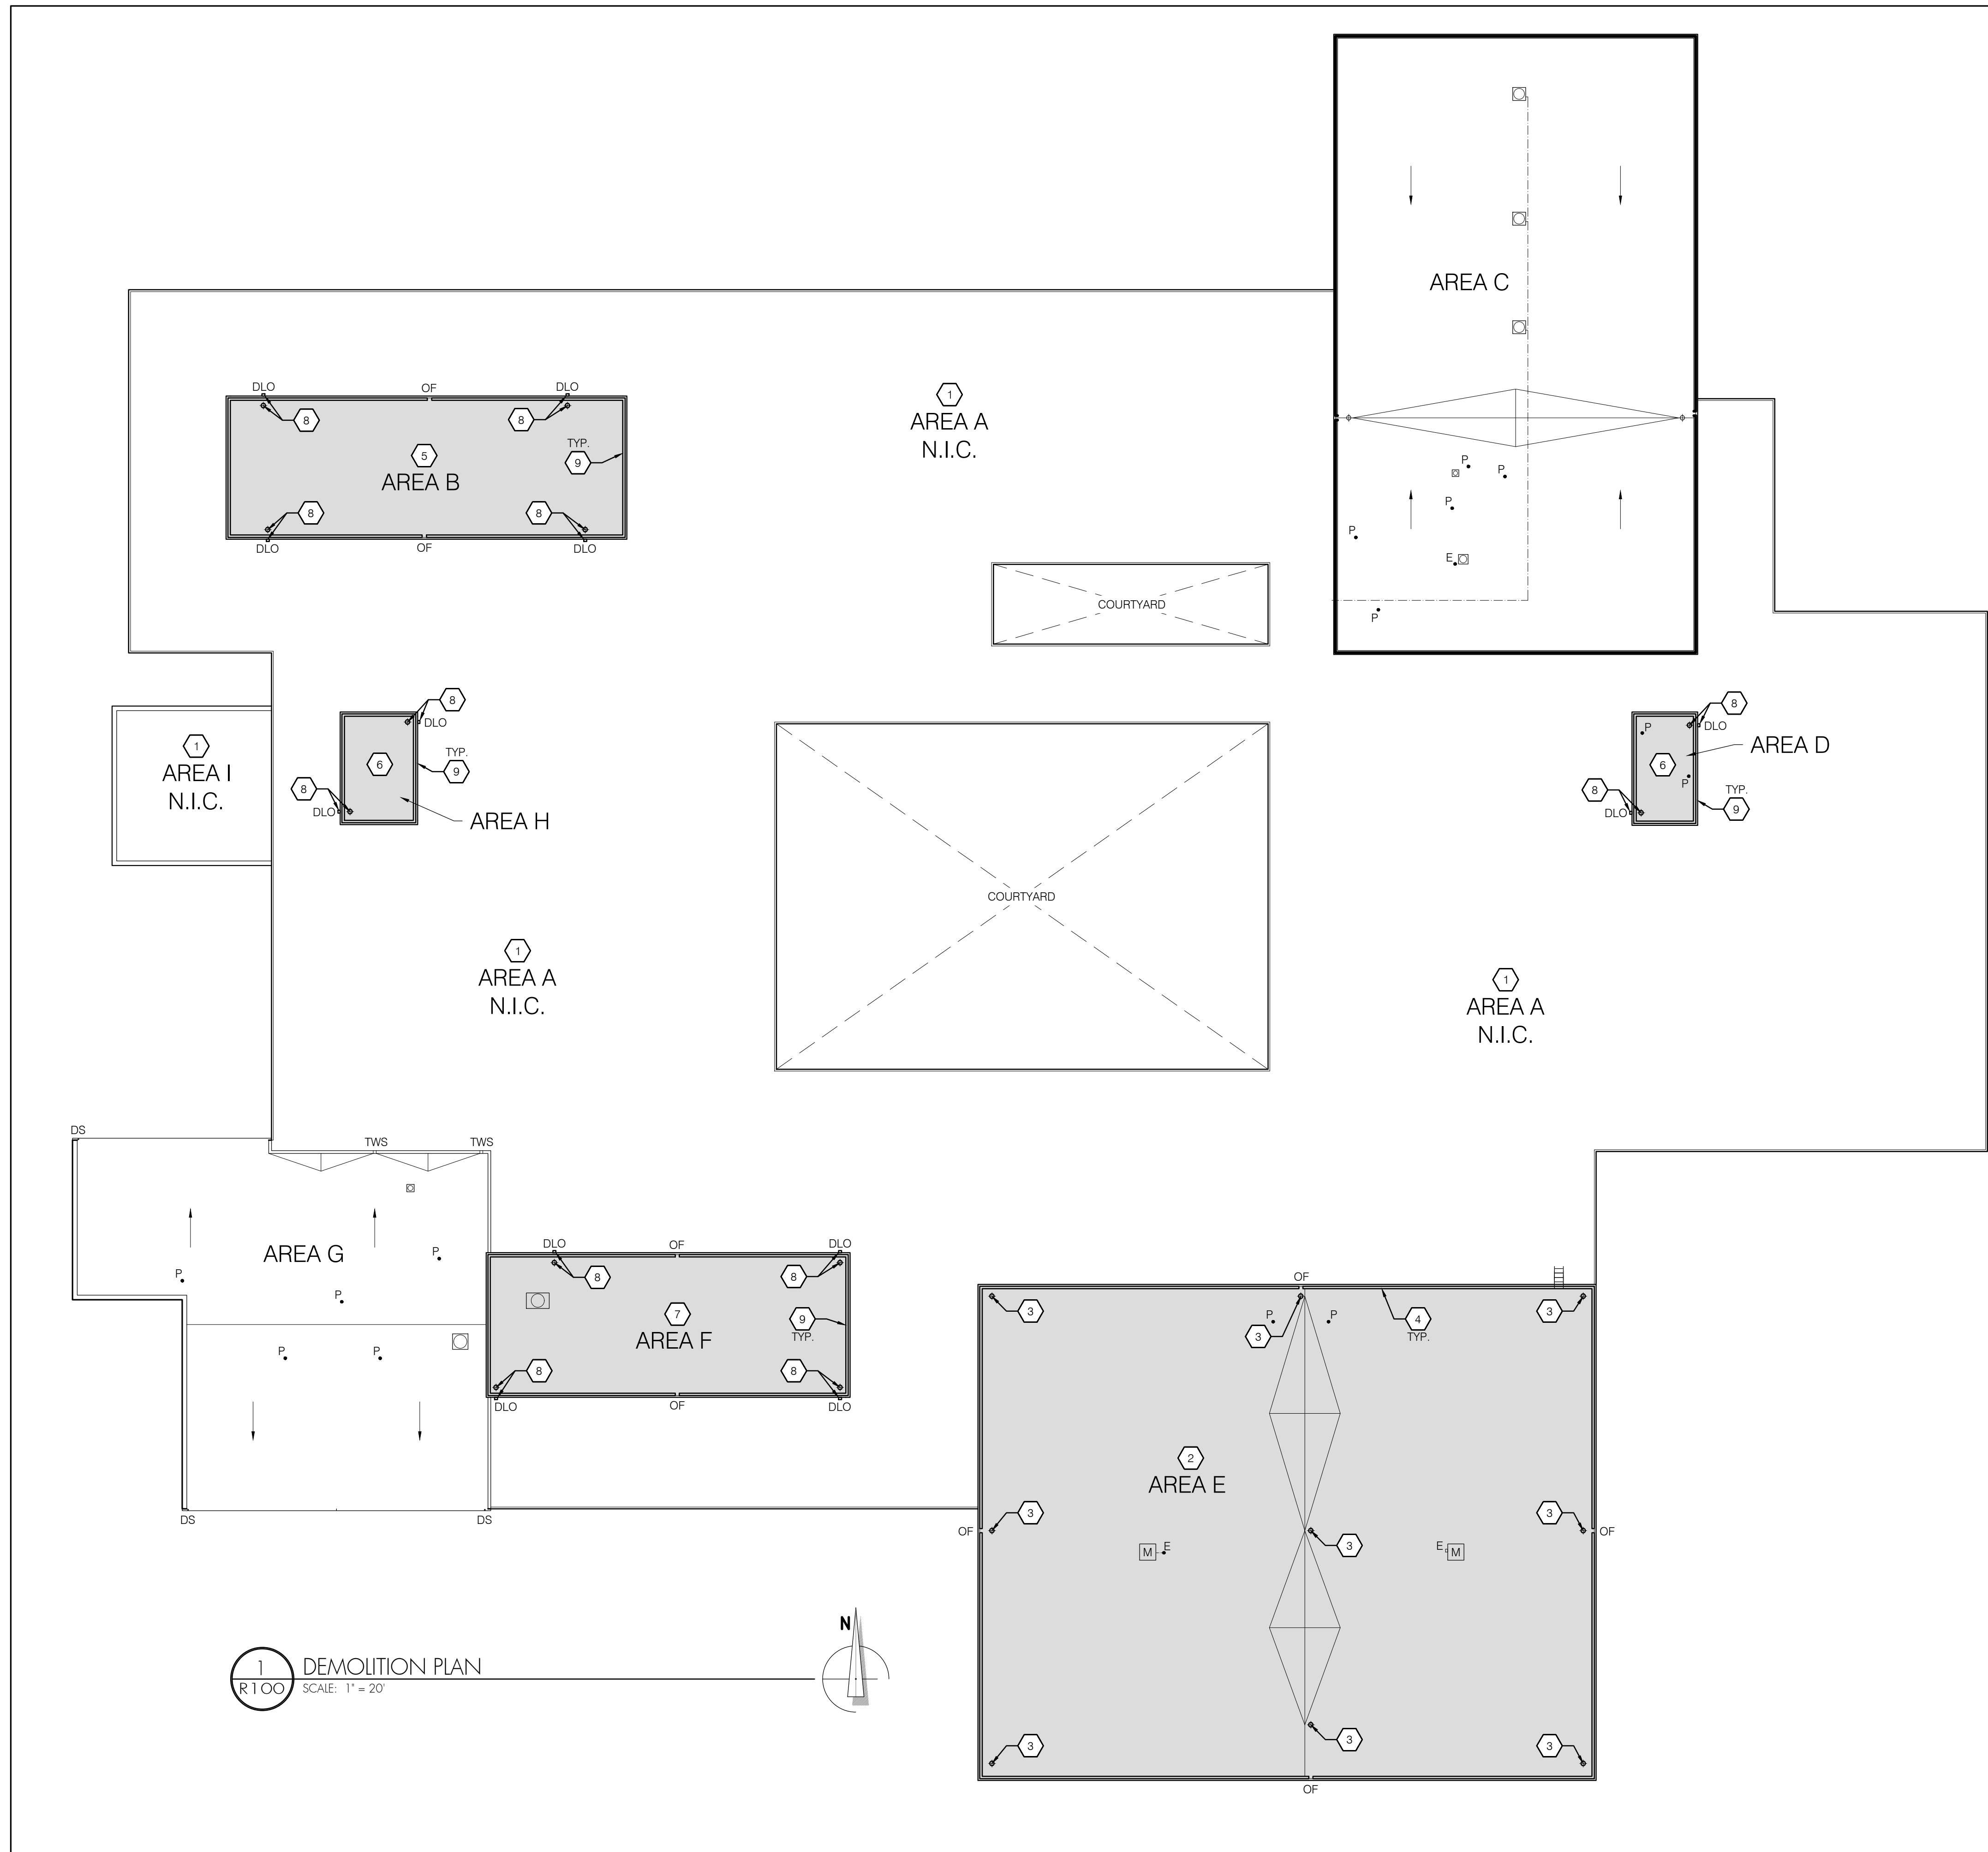
SHEET NUMBER:
R100

LEGEND (SYMBOLS APPLY TO SHADED AREA ONLY)

-  SHADED AREA INDICATES EXTENT OF ROOF REPLACEMENT DEMOLITION SCOPE OF WORK
-  EXISTING ROOF DRAIN - REFERENCE ASSOCIATED KEY NOTE
-  EXISTING OVERFLOW SCUPPER THROUGH CURBED EDGE - REFERENCE ASSOCIATED KEY NOTE
-  EXISTING ROOF DRAIN LINE OUTLET IN PENTHOUSE WALL - REFERENCE ASSOCIATED KEY NOTE
-  EXISTING CURBED FAN UNIT
-  EXISTING CURBED MECHANICAL UNIT
-  EXISTING PLUMBING VENT PIPE
-  EXISTING ELECTRICAL PENETRATION

KEY NOTES

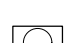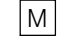- 1 EXISTING TPO ROOF MEMBRANE ASSEMBLY TO REMAIN - PROTECT MEMBRANE FROM DAMAGE DURING CONSTRUCTION ACTIVITIES.
- 2 DEMOLISH EXISTING 4-PLY AND A CAP BUILT-UP ROOF DOWN TO THE EXISTING OSB SHEATHING. - REFERENCE DETAIL 3/GI-2 FOR EXISTING ROOF ASSEMBLY.
- 3 DEMOLISH EXISTING ROOF DRAIN. MAINTAIN EXISTING DRAIN LINE FOR ATTACHMENT OF NEW ROOF DRAINS.
- 4 DEMOLISH EXISTING CURBED EDGE AND SHEET METAL FLASHING ASSEMBLY.
- 5 ALTERNATE NO. 1: DEMOLISH EXISTING 4-PLY AND A CAP BUILT-UP ROOF DOWN TO THE EXISTING OSB SHEATHING. - REFERENCE DETAIL 1/GI-2 FOR EXISTING ROOF ASSEMBLY.
- 6 ALTERNATE NO. 1: DEMOLISH EXISTING 3-PLY AND A CAP BUILT-UP ROOF DOWN TO THE EXISTING OSB SHEATHING. - REFERENCE DETAIL 2/GI-2 FOR EXISTING ROOF ASSEMBLY.
- 7 ALTERNATE NO. 1: DEMOLISH EXISTING 4-PLY AND A CAP BUILT-UP ROOF DOWN TO THE EXISTING OSB SHEATHING. - REFERENCE DETAIL 4/GI-2 FOR EXISTING ROOF ASSEMBLY.
- 8 ALTERNATE NO. 1: DEMOLISH EXISTING ROOF DRAIN, DRAIN LINE, AND PENTHOUSE WALL DRAIN OUTLET NOZZLE (COWS TONGUE).
- 9 ALTERNATE NO. 1: DEMOLISH EXISTING CURBED EDGE AND SHEET METAL FLASHING ASSEMBLY.




REBID SET

**EUGENE SCHOOL DISTRICT 4J
 MONROE MIDDLE SCHOOL
 ROOF REPLACEMENT**

SHEET TITLE:
 ROOF PLAN

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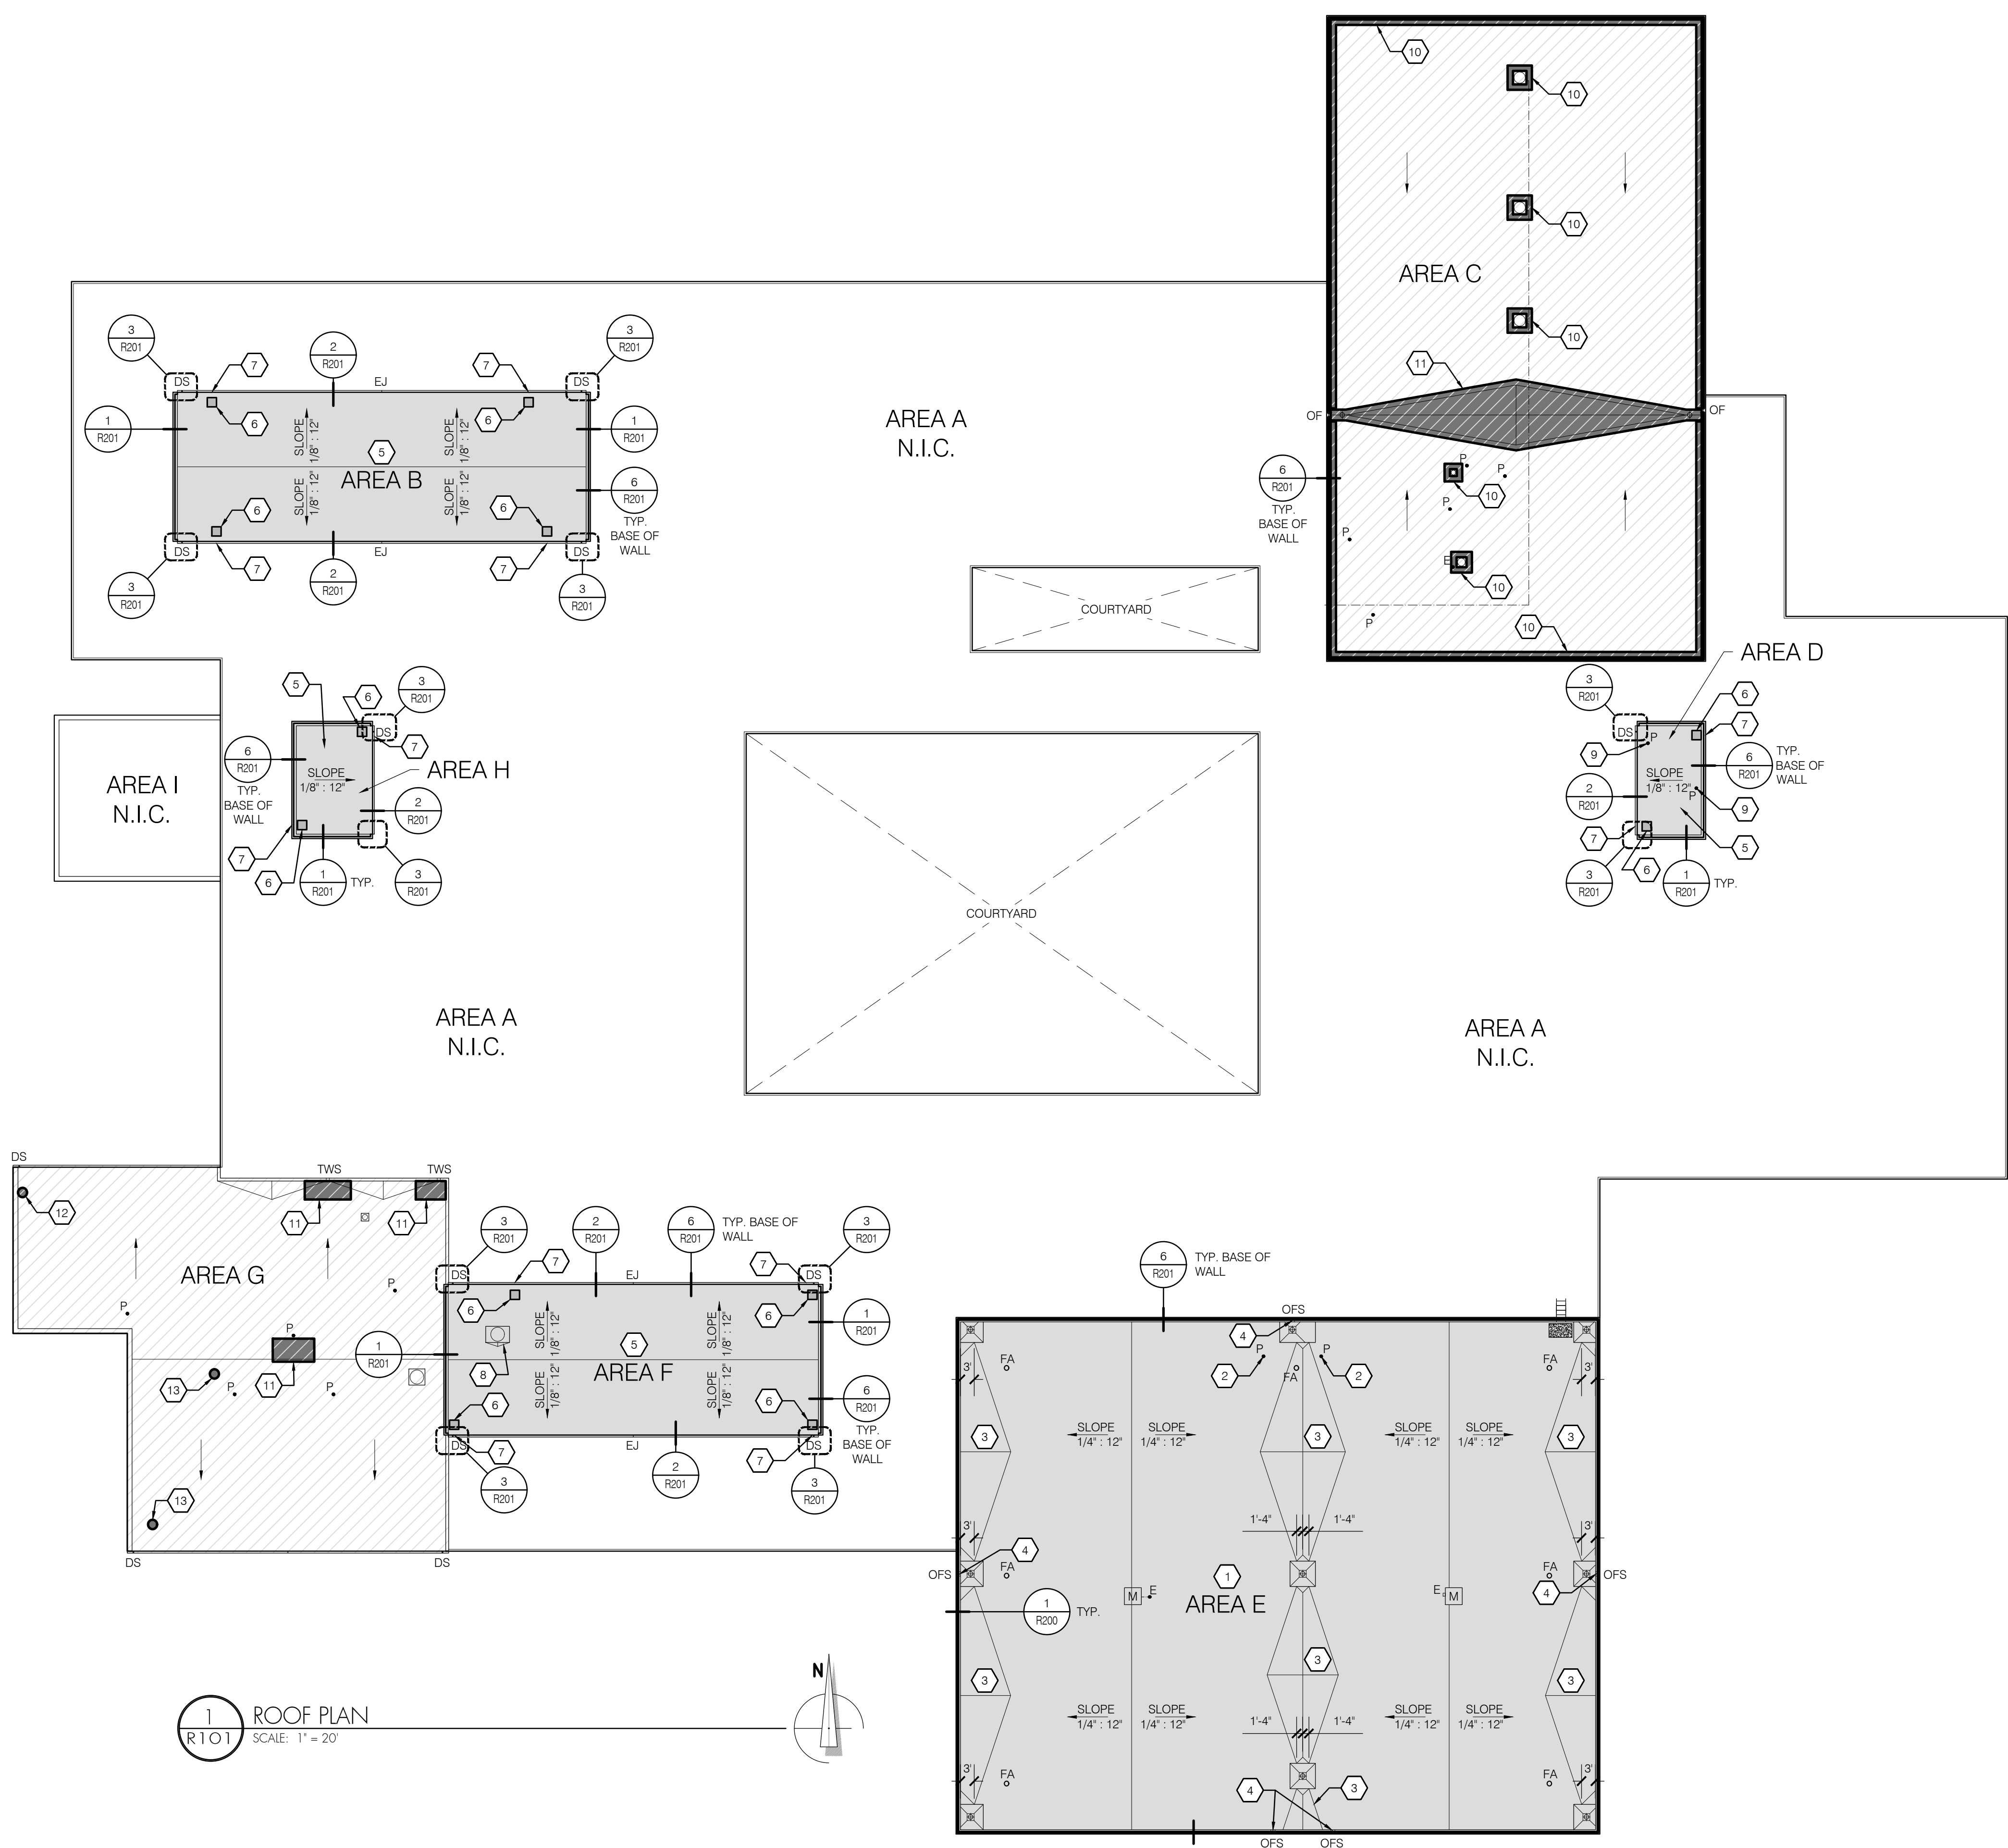
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SHEET NUMBER:
R101

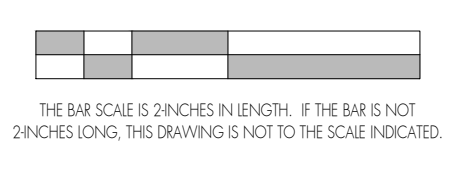LEGEND		(SYMBOLS APPLY TO SHADED/HATCHED AREAS ONLY)
	SHADED INDICATES ROOF AREAS TO BE REPLACED	
	HATCH INDICATES ROOF AREAS TO RECEIVE REPAIRS	
	INDICATES APPROXIMATE EXTENT/LOCATION OF REPAIR ACTIVITIES - REFERENCE KEY NOTES AND SPECIFICATIONS	
	6 R200	DRAIN SUMP
	DS	GUTTER DOWNSPOUT
	EJ	GUTTER EXPANSION JOINT
	2 R200	OVERFLOW SCUPPER
	OF	EXISTING OVERFLOW THROUGH CURBED EDGE
		EXISTING ROOF DRAIN
	4 R201	EXISTING CURBED FAN UNIT
	ALT. NO. 1	EXISTING PLUMBING VENT PIPE
	5 R200	EXISTING ELECTRICAL PENETRATION
		EXISTING ROOF ACCESS LADDER TO BE REPLACED - REFERENCE STRUCTURAL
	4 R201	EXISTING CURBED MECHANICAL UNIT
	ALT. NO. 1	EXISTING OVER-DECK ELECTRICAL CONDUIT
	3 R200	FA
	SLOPE 1/8" : 12"	DIRECTION AND SLOPE OF TAPERED INSULATION SYSTEMS - TAPERED INSULATION CRICKETS SHALL PRODUCE A FINISHED SLOPE EQUAL TO THE TAPERED INSULATION TO WHICH IT IS APPLIED UNLESS OTHERWISE NOTED
		WALKPAD

- KEY NOTES**
- INSTALL NEW 4-PLY AND A CAP BUILT UP ROOF ASSEMBLY. - REFERENCE DETAIL 5/GI-2.
 - RAISE AND INTEGRATE PLUMBING VENT PIPE INTO ROOF MEMBRANE ASSEMBLY. - REFERENCE DETAIL 4/R200.
 - INSTALL INSULATION CRICKET WITH 1/2" PANEL SLOPE UTILIZING A 3:1 LENGTH/WIDTH RATIO. PROVIDE BULL NOSE TERMINATION OF CRICKET AT SUMP.
 - OVERFLOW SCUPPERS TO BE NO MORE THAN 2" ABOVE THE SURFACE OF THE ROOF MEMBRANE. - REFERENCE DETAIL 2/R200.
 - ALTERNATE NO. 1: INSTALL NEW 4-PLY AND A CAP BUILT UP ROOF ASSEMBLY. - REFERENCE DETAIL 6/GI-2.
 - ALTERNATE NO. 1: INSTALL NEW DECK INFILL PRIOR TO ROOF MEMBRANE ASSEMBLY. - REFERENCE STRUCTURAL DRAWINGS.
 - ALTERNATE NO. 1: INSTALL WALL PANEL COVER PLATE OVER VOID IN EXISTING METAL WALL PANELS WHERE DRAIN OUTLET WAS REMOVED. WALL PANEL COVER PLATE IS TO MATCH THE PROFILE OF THE EXISTING METAL WALL PANEL AND EXTEND A MINIMUM OF 6" ABOVE AND BELOW THE HOLE IN THE EXISTING METAL WALL PANEL. CLEAN THE SURFACE OF THE EXISTING METAL WALL PANEL AROUND THE HOLE AND WET SET THE WALL PANEL COVER PLATE INTO A BED OF BUTYL SEALANT. FASTEN THE PERIMETER OF THE WALL PANEL COVER PLATE WITH RUBBER WASHERED FASTENERS AT 3" ON CENTER.
 - ALTERNATE NO. 1: PROVIDE CRICKET ON UP-SLOPE SIDE OF CURB.
 - ALTERNATE NO. 1: RAISE AND INTEGRATE PLUMBING VENT PIPE INTO ROOF MEMBRANE ASSEMBLY. - REFERENCE DETAIL 5/R201.
 - ALTERNATE NO. 1: BUR MEMBRANE REPAIR - ALUMINUM COATING APPLICATION.
 - ALTERNATE NO. 1: BUR MEMBRANE REPAIR - REINFORCED FLUID-APPLIED MEMBRANE APPLICATION - EXTEND THROUGH SCUPPER LINERS AND TERMINATE AT EXTERIOR LEADING EDGE.
 - ALTERNATE NO. 1: BUR MEMBRANE REPAIR - OPEN/DRY LAP PATCH.
 - ALTERNATE NO. 1: BUR MEMBRANE REPAIR - MEMBRANE PATCH.



REBID SET

**EUGENE SCHOOL DISTRICT 4J
 MONROE MIDDLE SCHOOL
 ROOF REPLACEMENT**


SHEET TITLE:
 DETAILS - BASE BID

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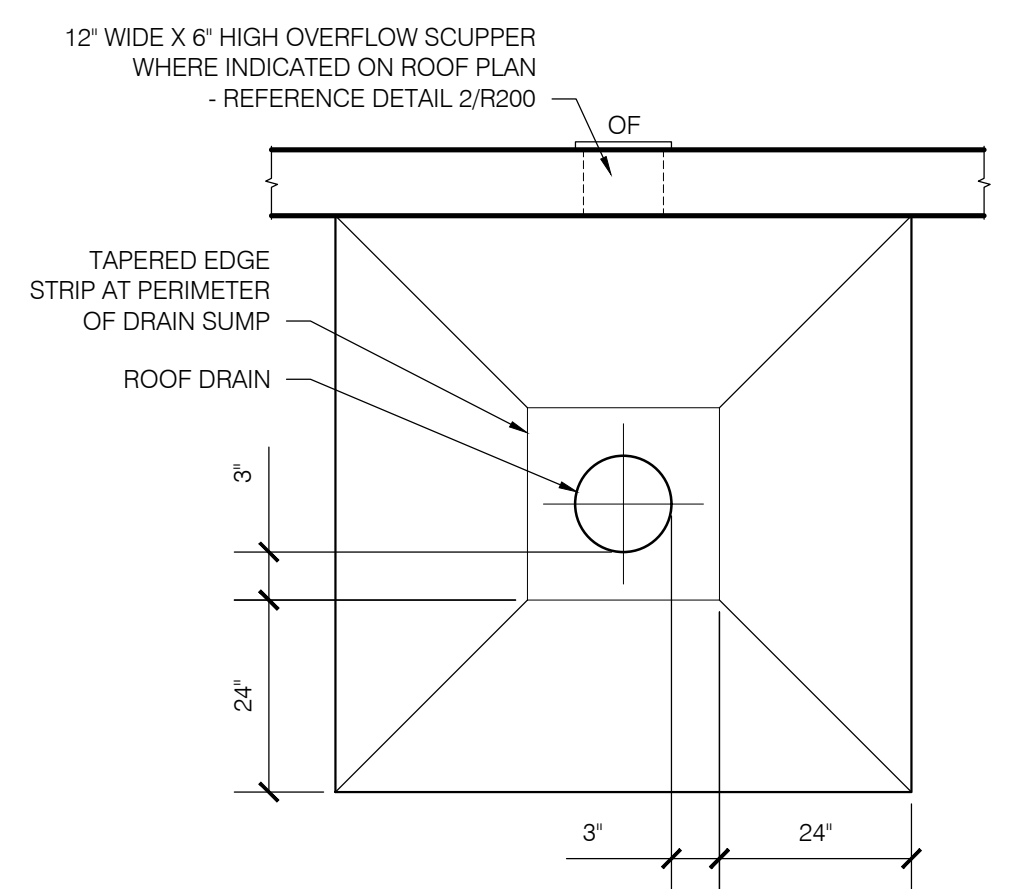
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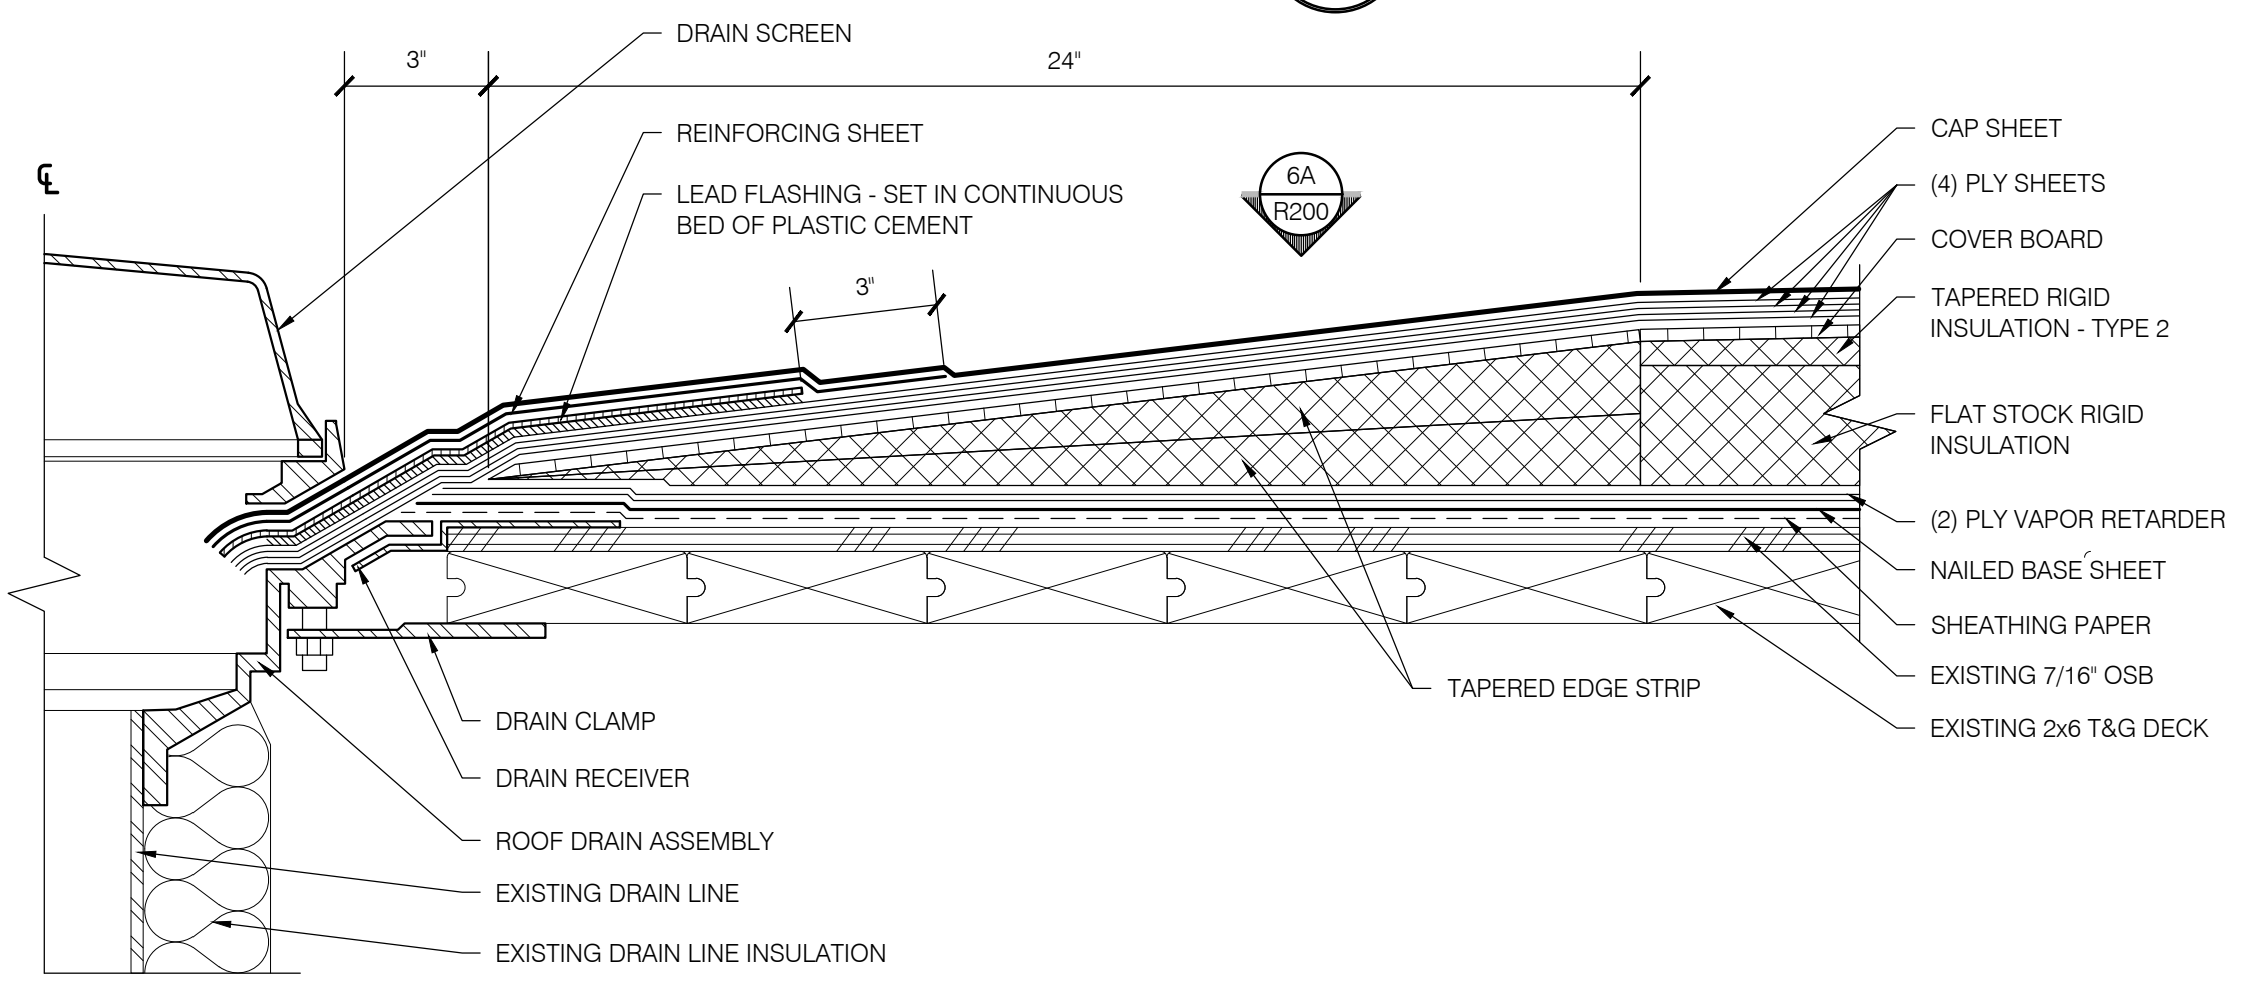
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R200




**AREA E
 FALL PROTECTION ANCHOR**
 SCALE: 3" = 1'-0" (ROOF ASSEMBLY PER 8/GH-2 WHERE SIM)

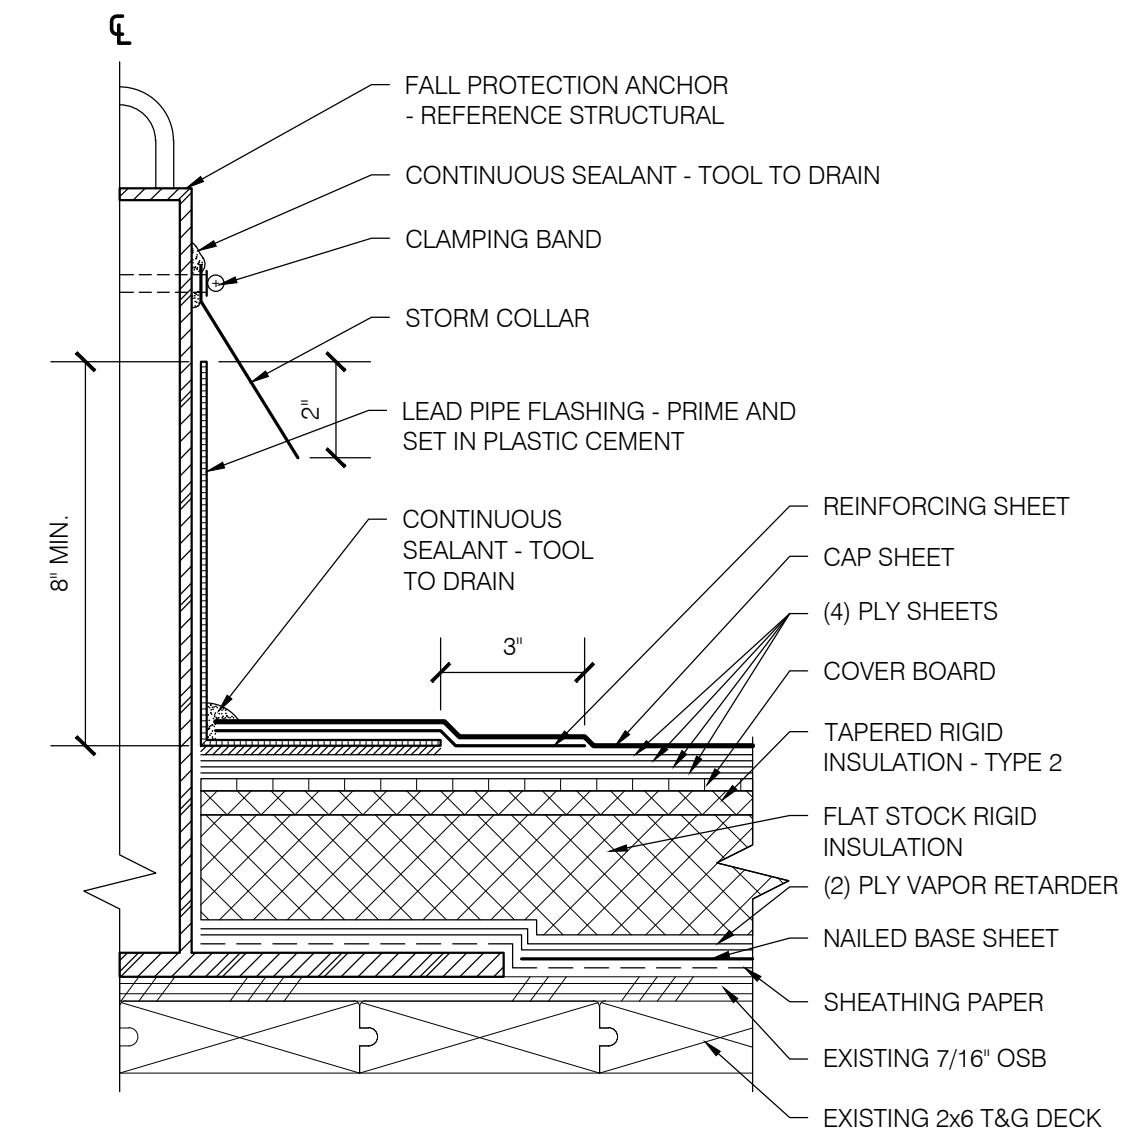


**AREA E
 PLAN VIEW - DRAIN SUMP ASSEMBLY**
 SCALE: 1/2" = 1'-0"




**AREA E
 DRAIN SUMP ASSEMBLY**
 SCALE: 3" = 1'-0"

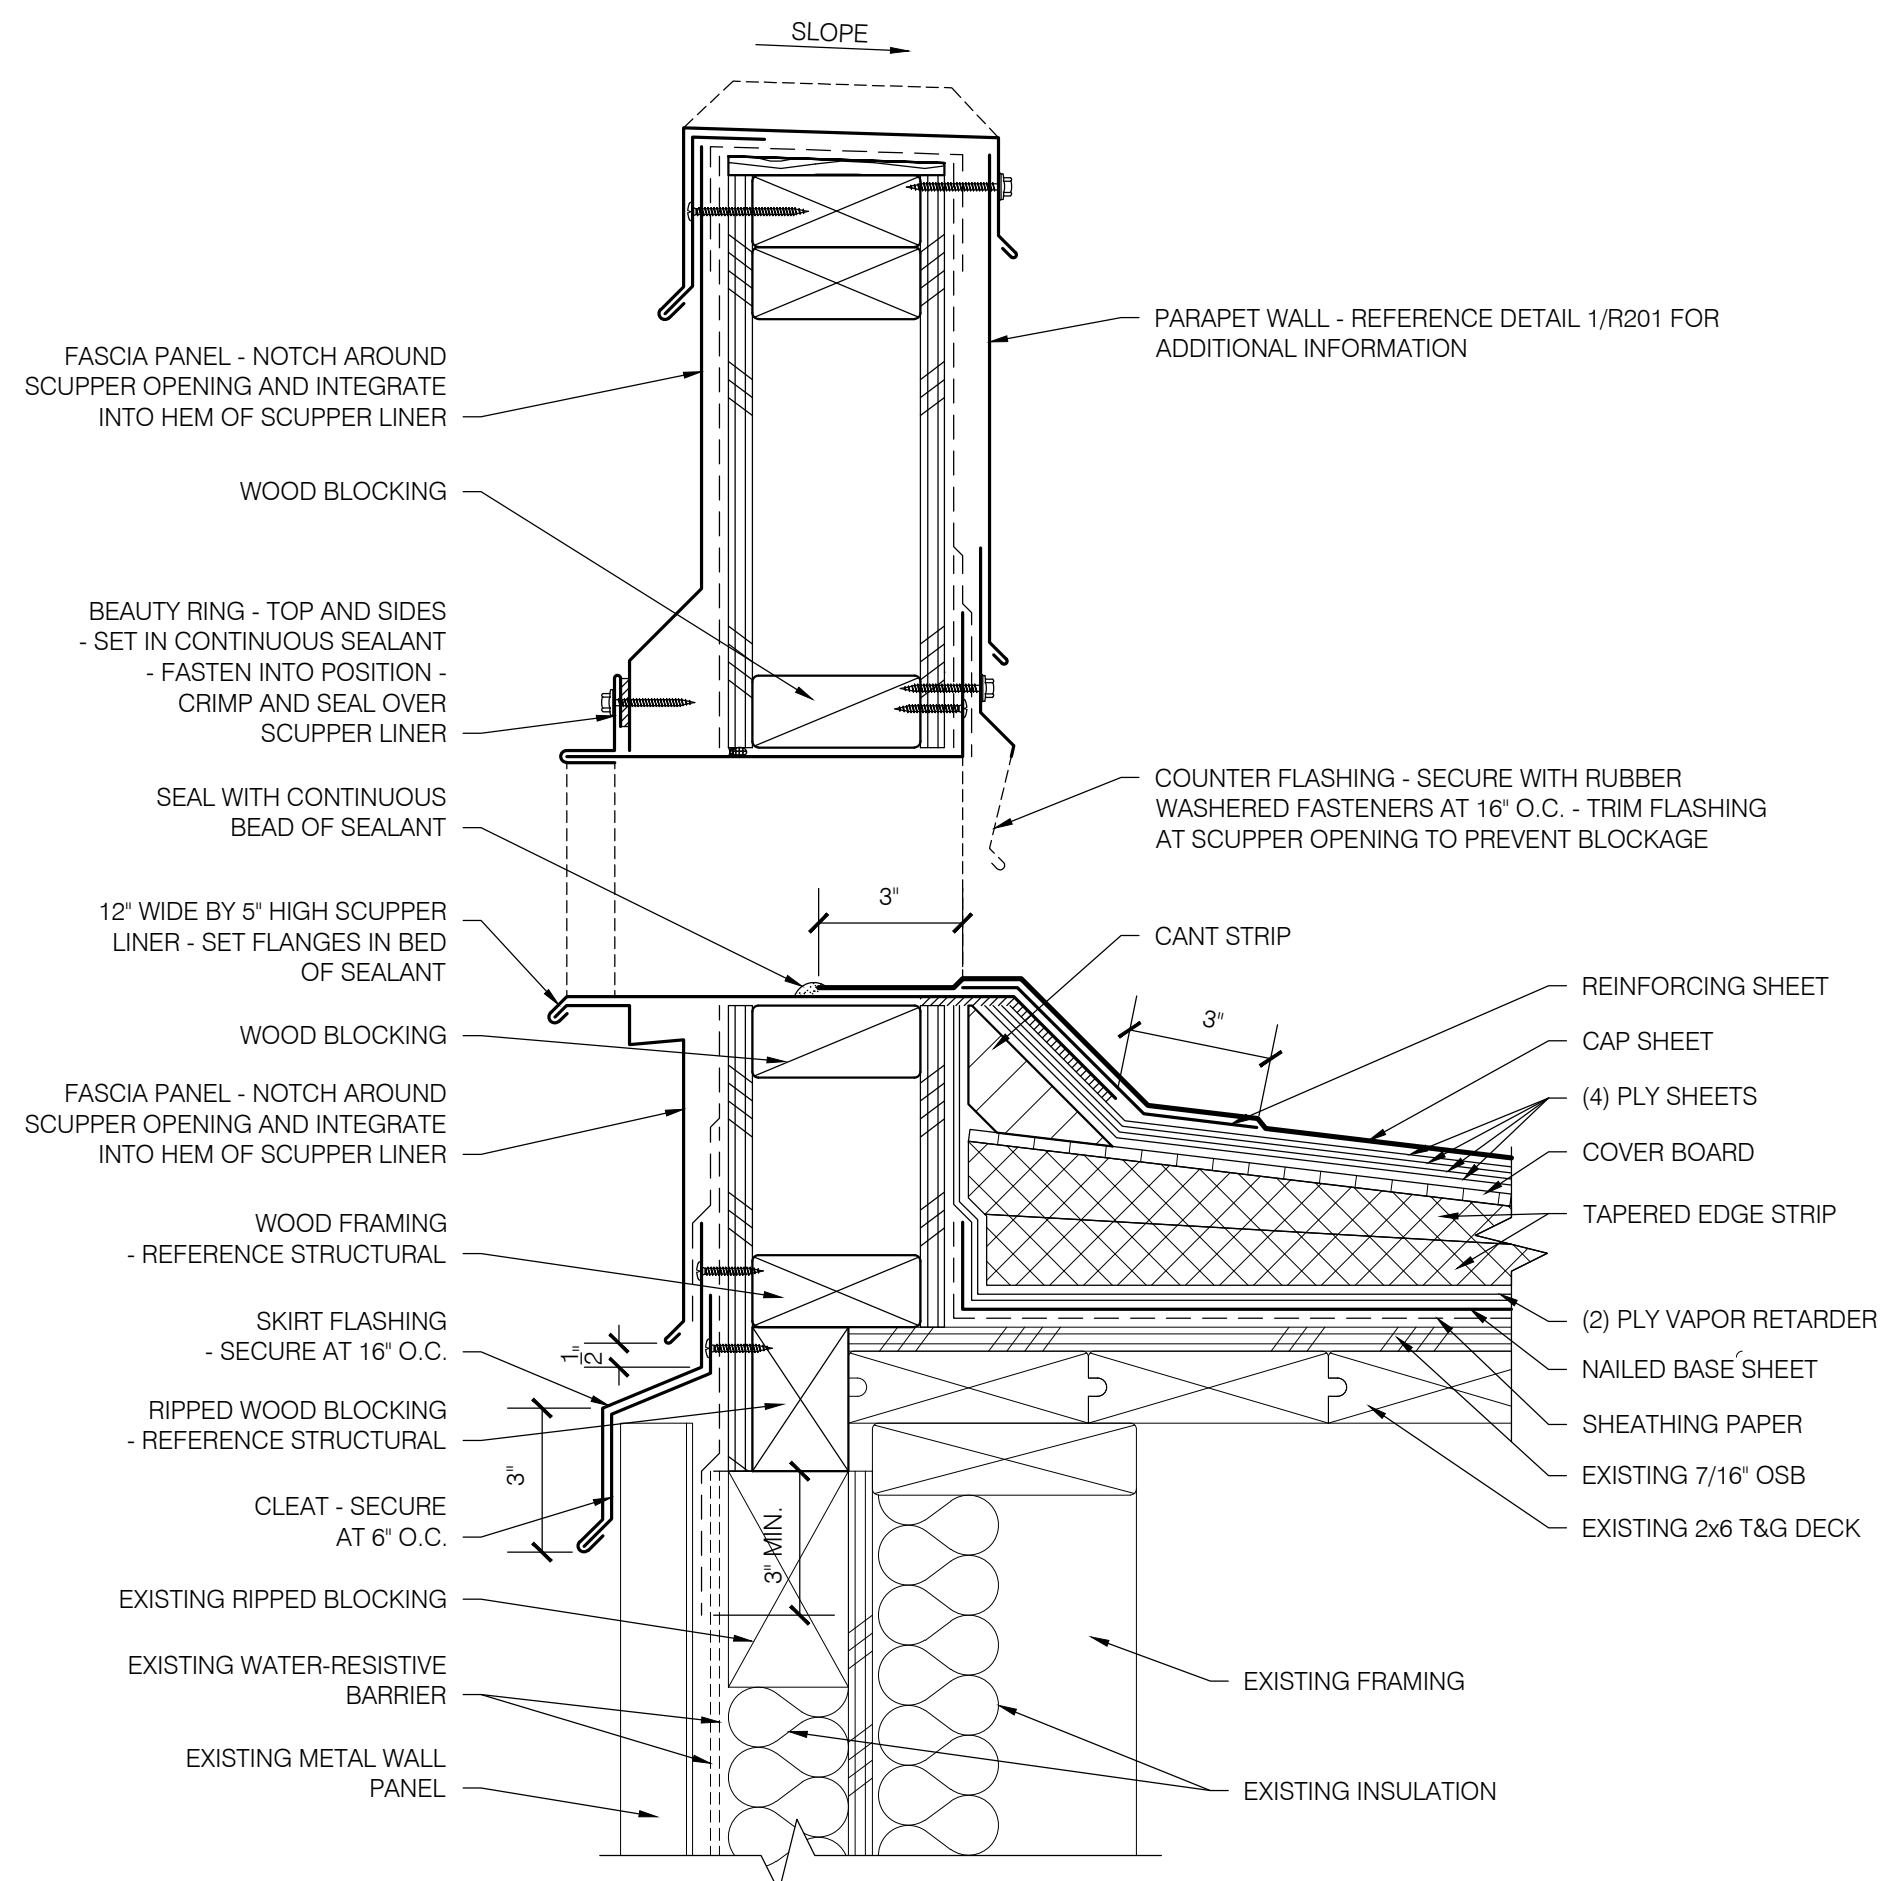


**AREA E
 OVERFLOW SCUPPER**
 SCALE: 3" = 1'-0"

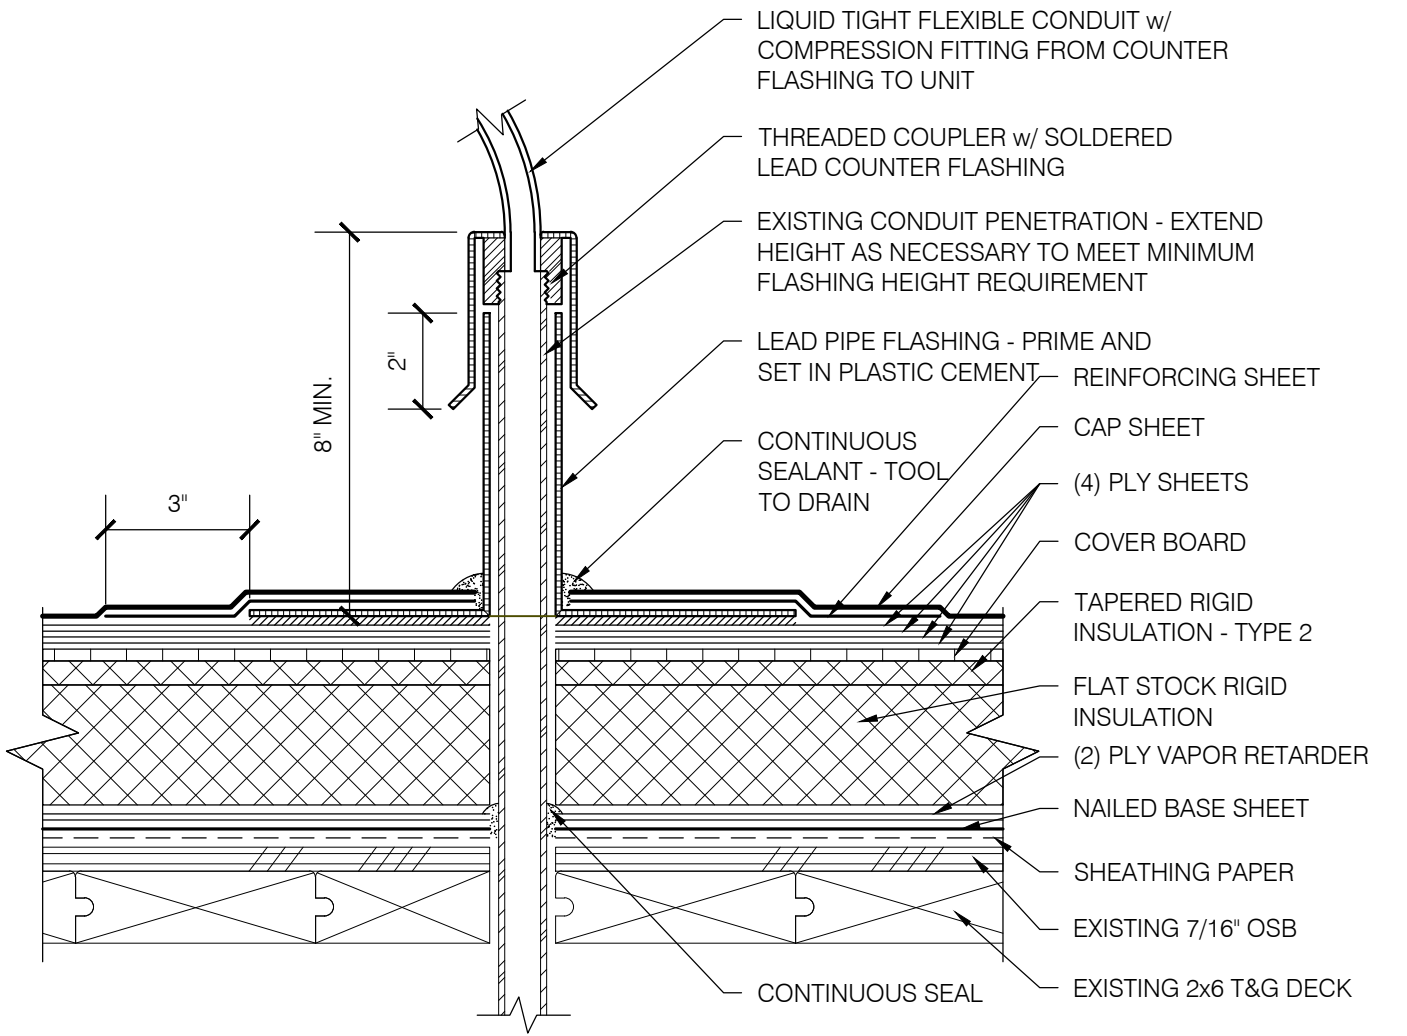

**AREA E
 ELECTRICAL CONDUIT PENETRATION**
 SCALE: 3" = 1'-0"

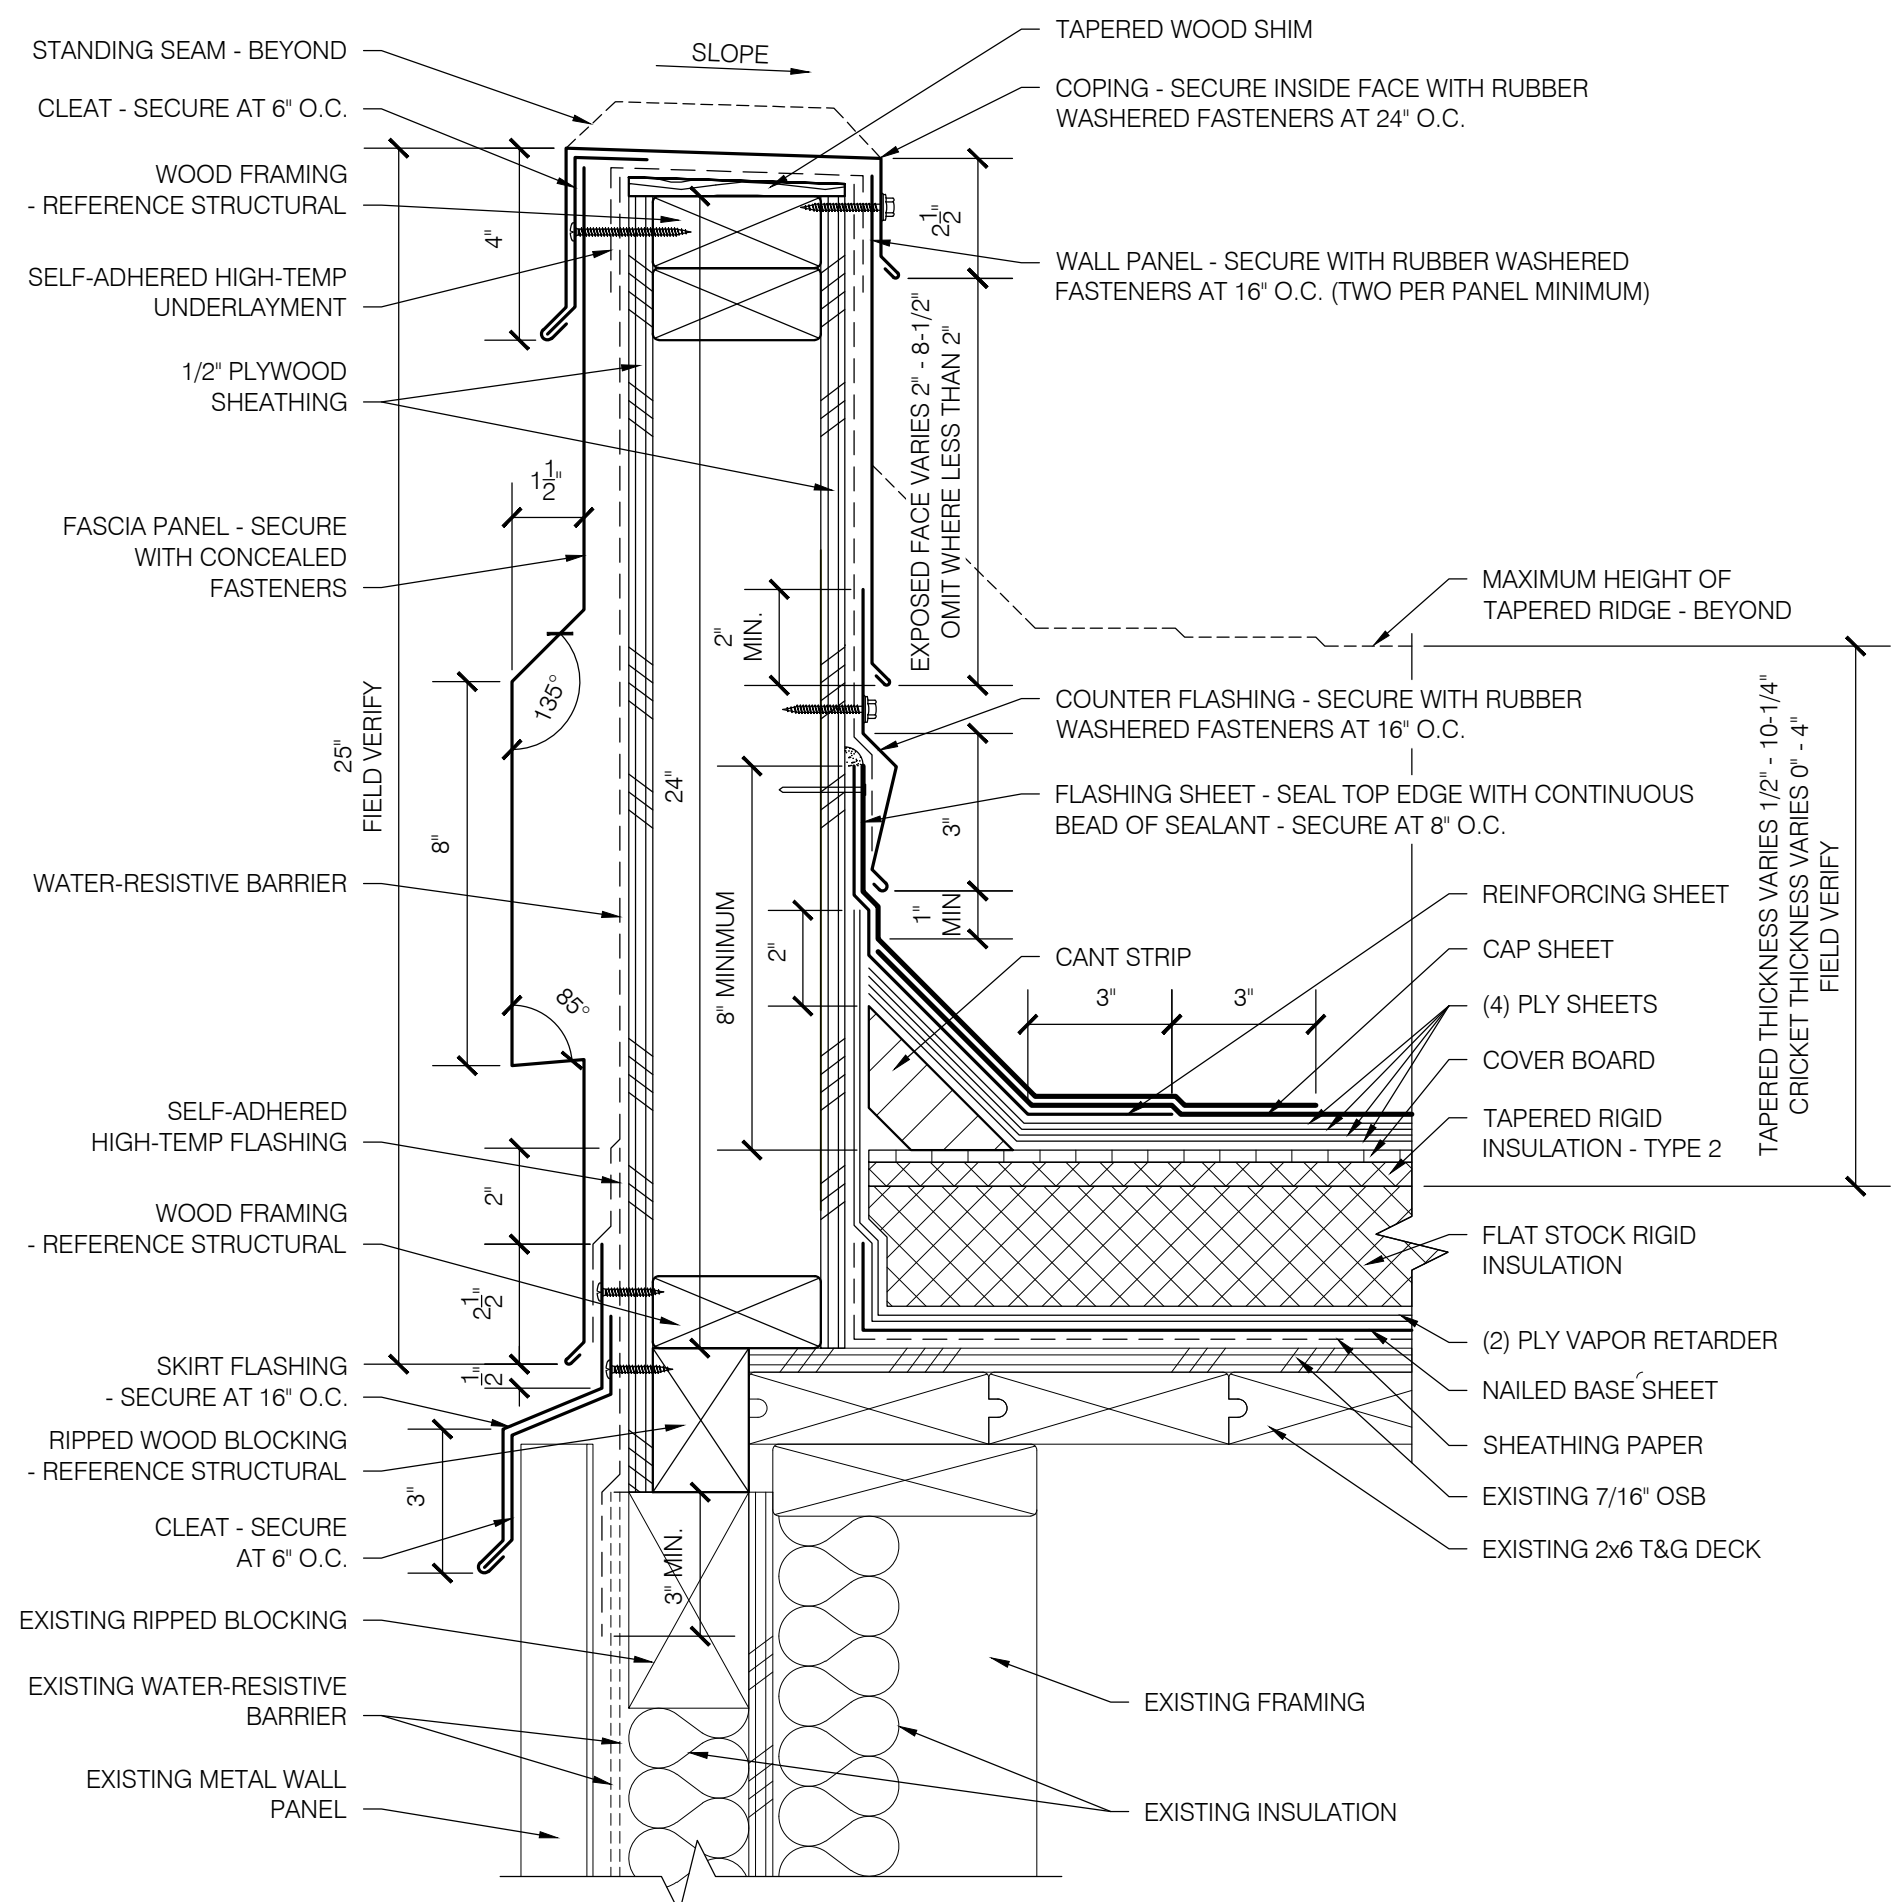


**AREA E
 PARAPET WALL**
 SCALE: 3" = 1'-0" (ROOF ASSEMBLY PER 8/GH-2 WHERE SIM)

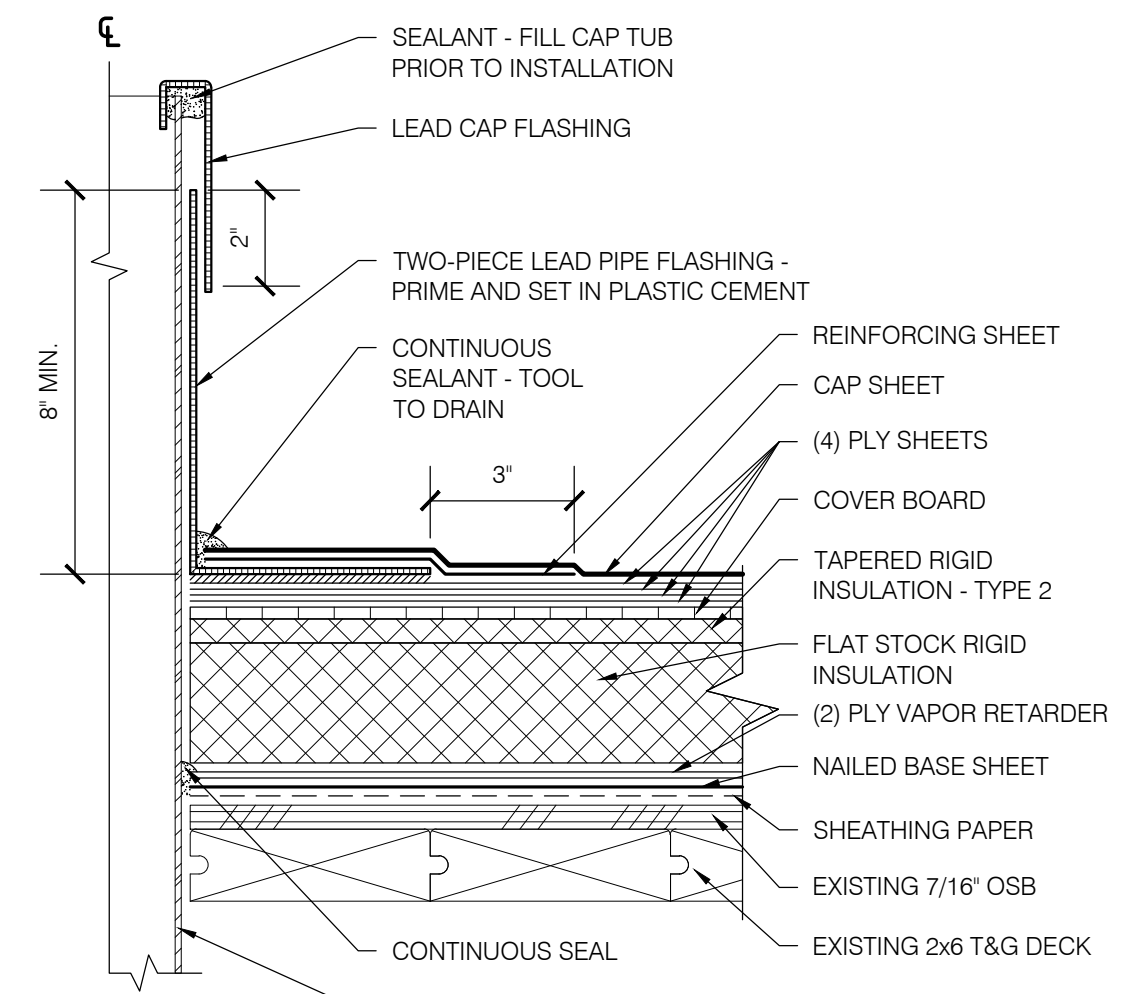


**AREA E
 PLUMBING VENT PIPE**
 SCALE: 3" = 1'-0"

REBID SET


**EUGENE SCHOOL DISTRICT 4J
 MONROE MIDDLE SCHOOL
 ROOF REPLACEMENT**

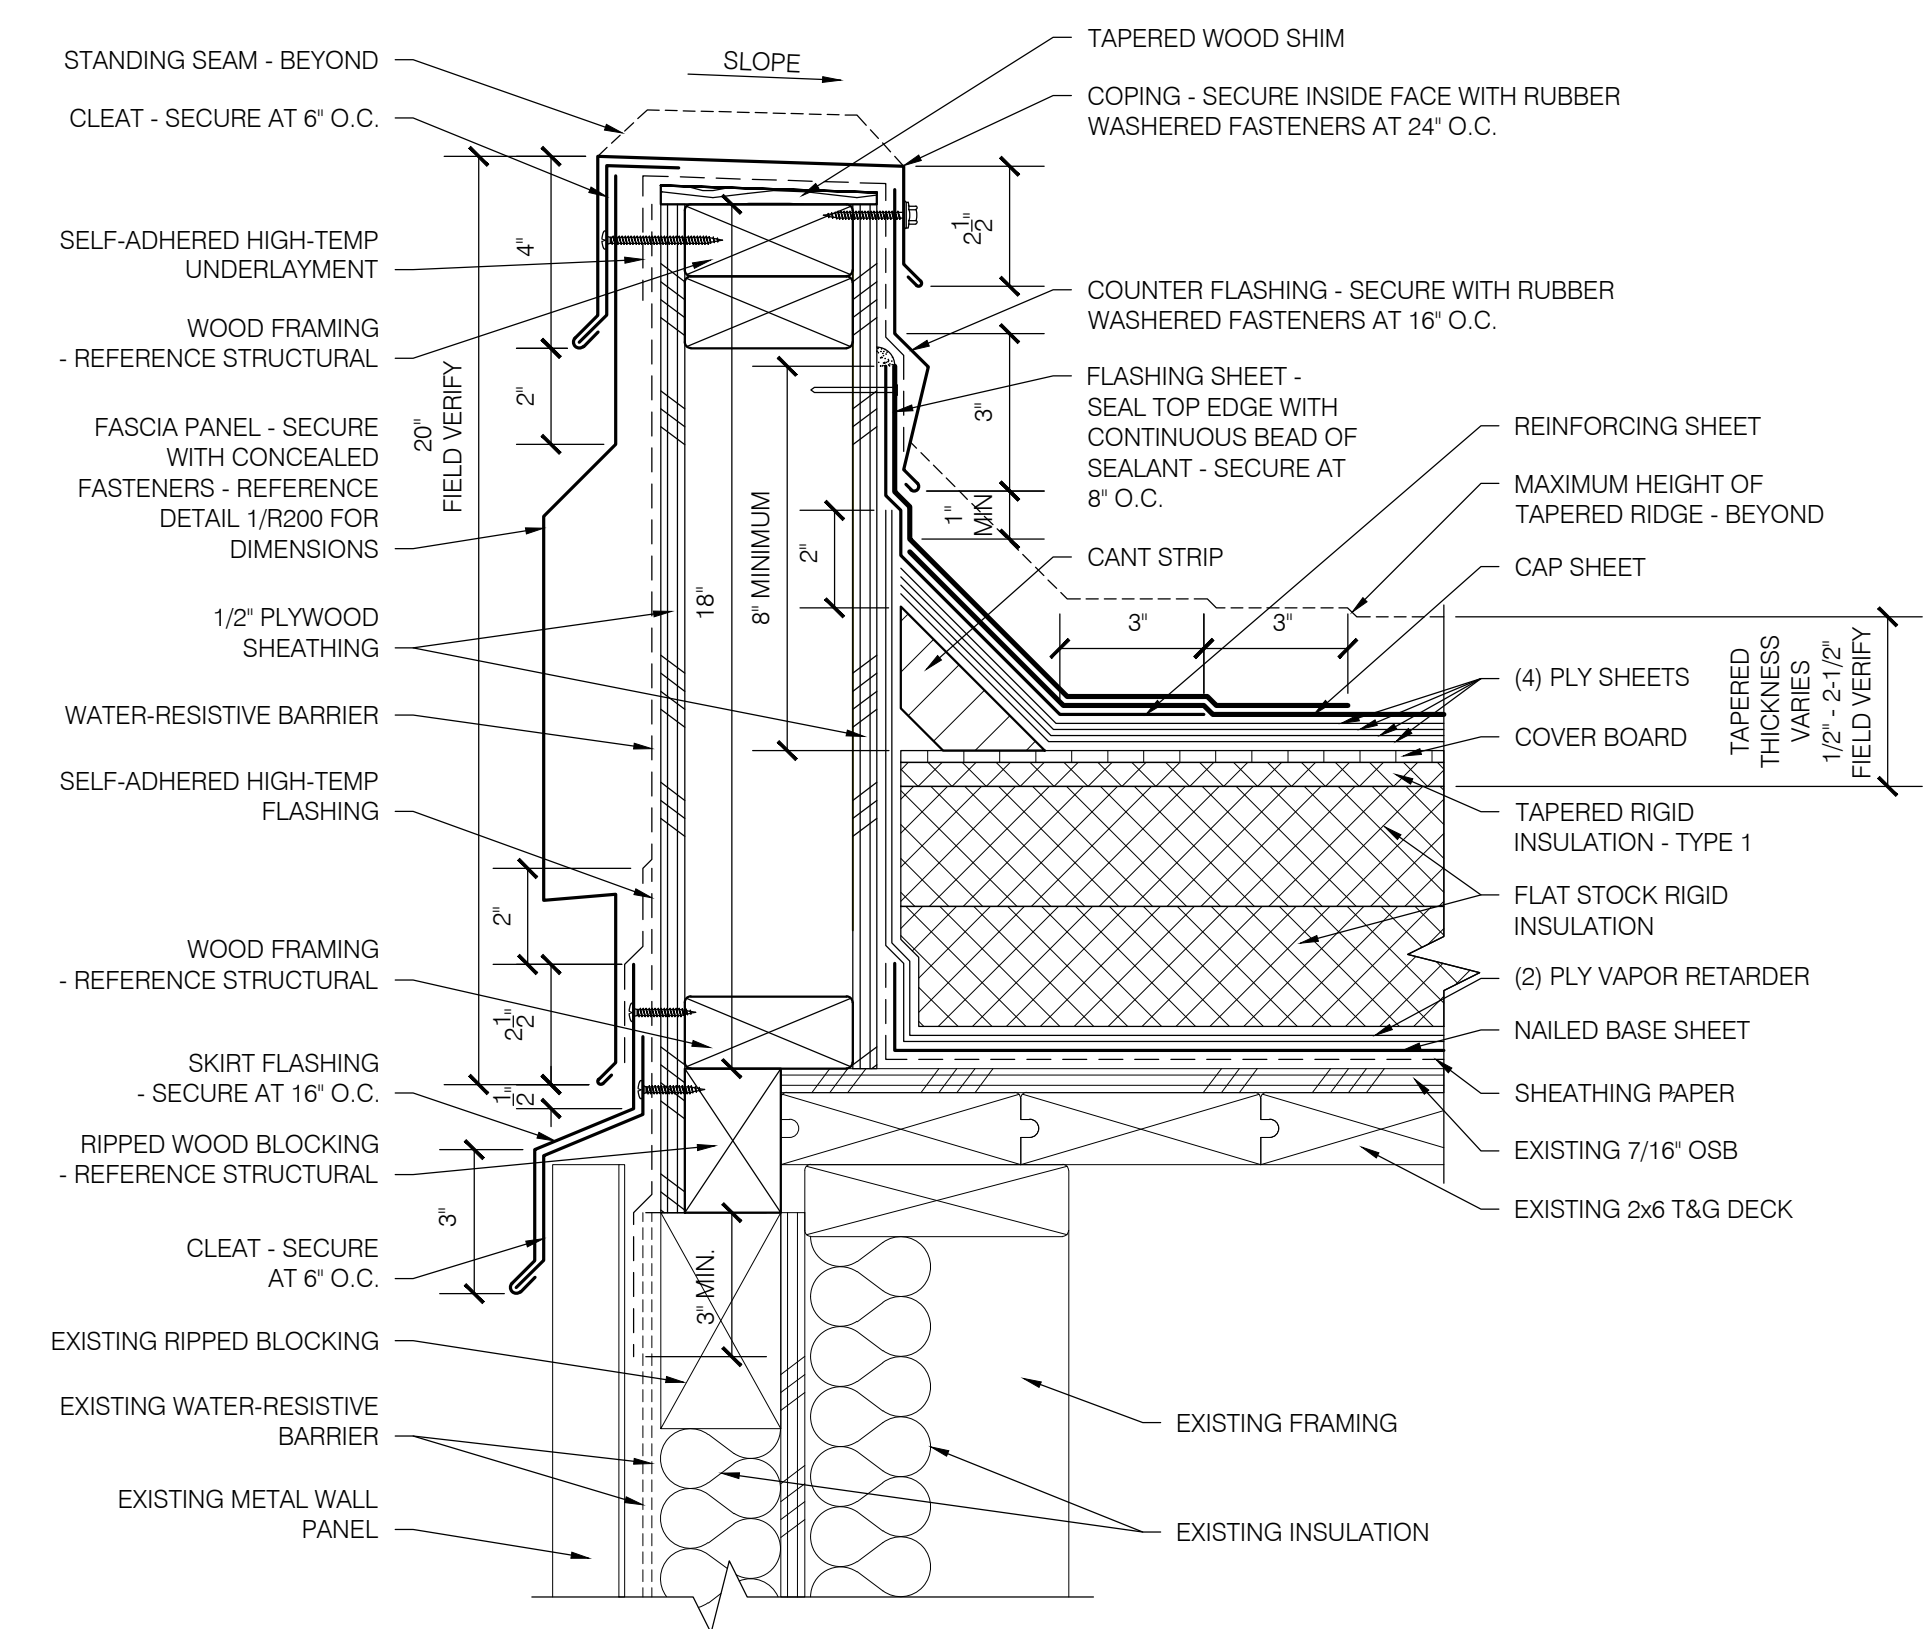


1
R201
 AREAS B, D, F & H
 PARAPET WALL
 SCALE: 3" = 1'-0"

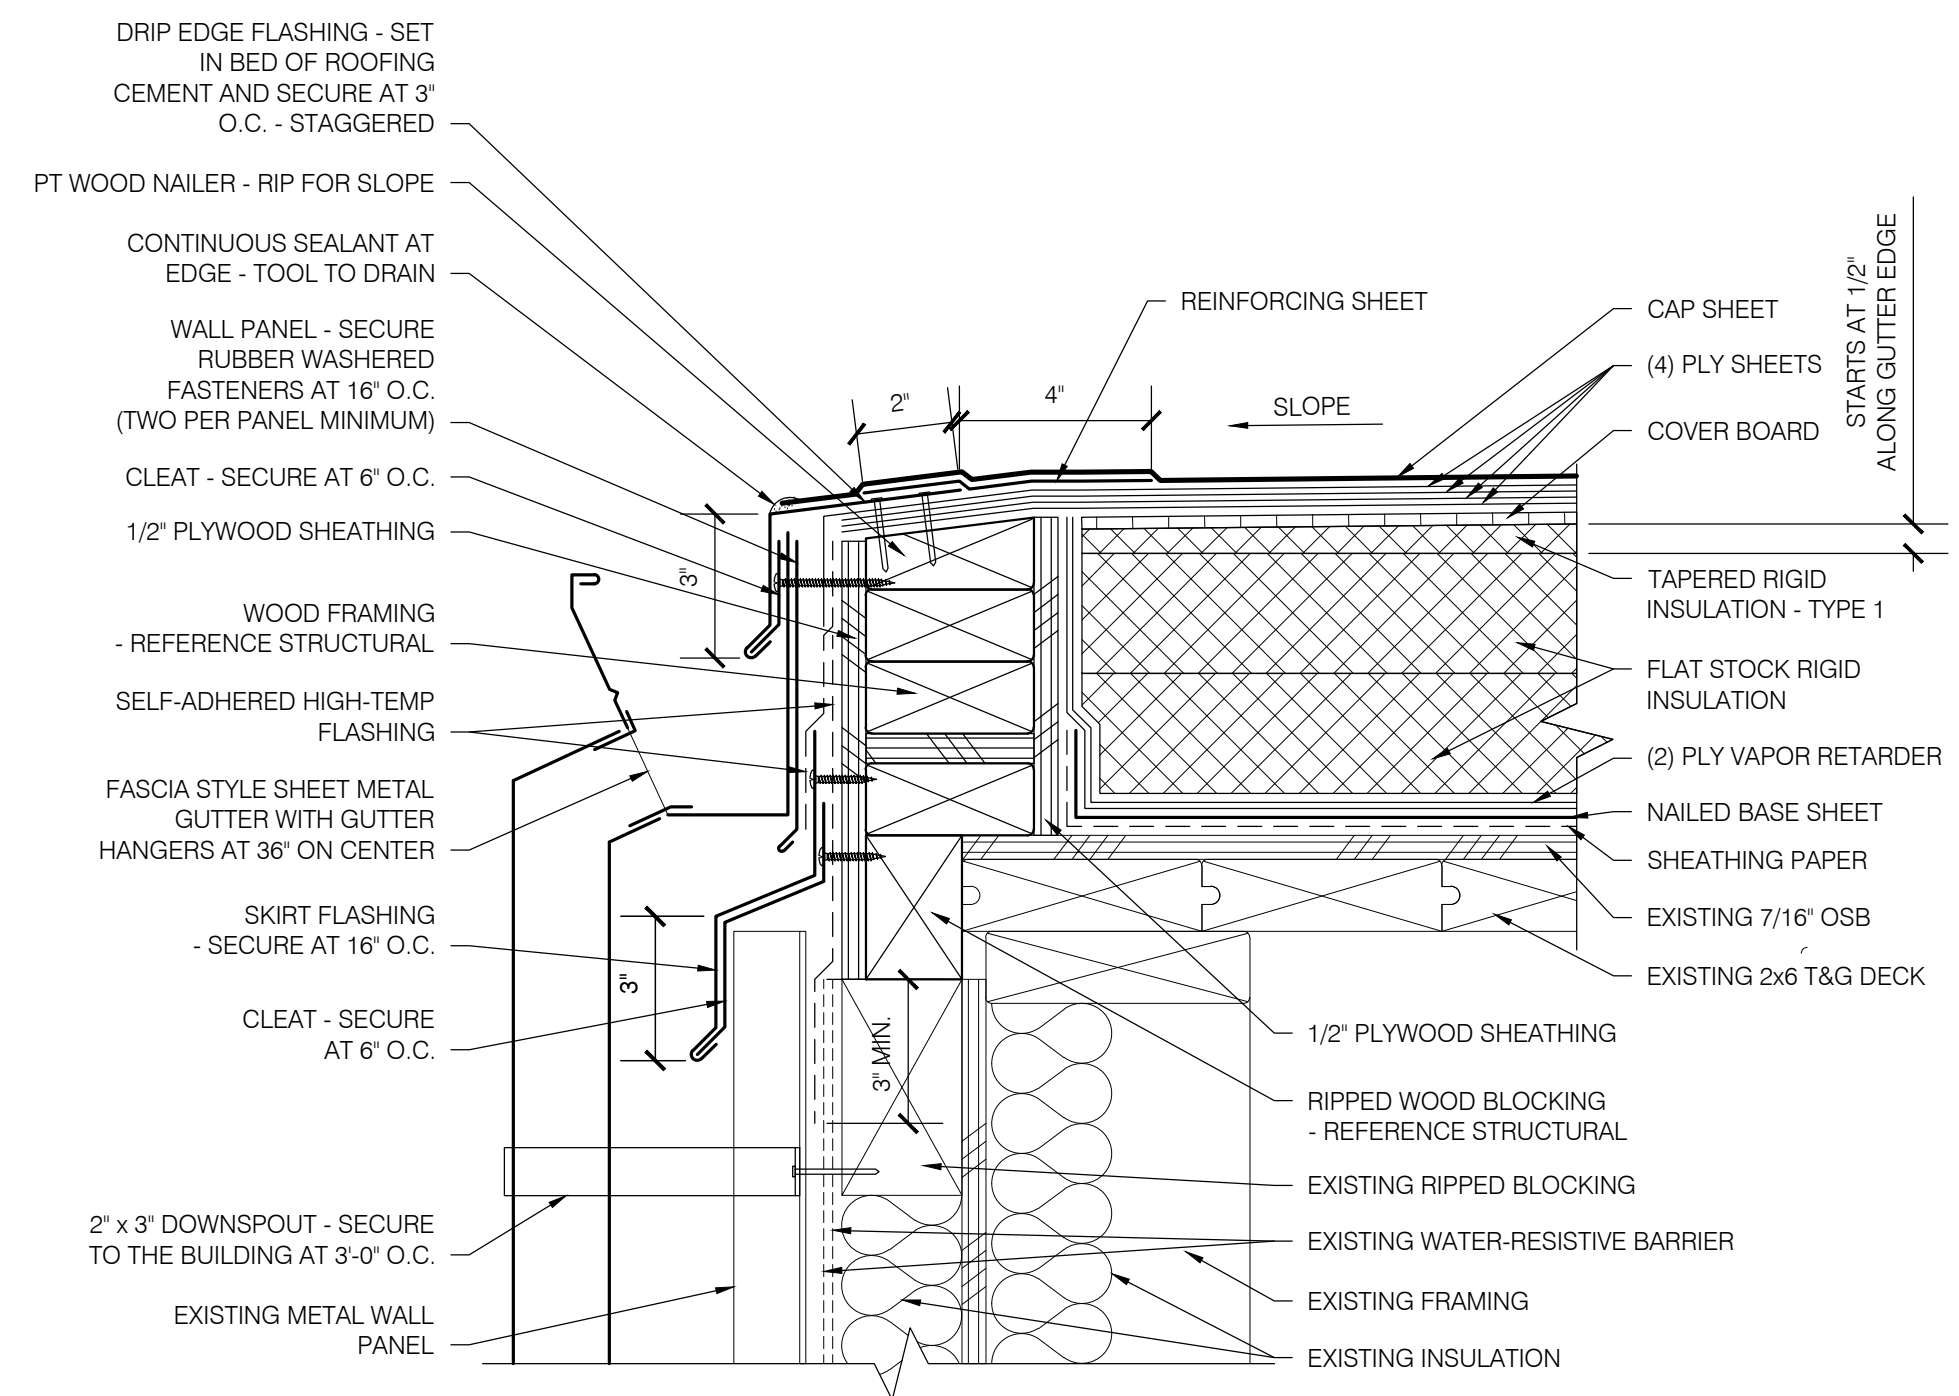


2
R201
 AREAS B, D, F & H
 GUTTER EDGE
 SCALE: 3" = 1'-0"

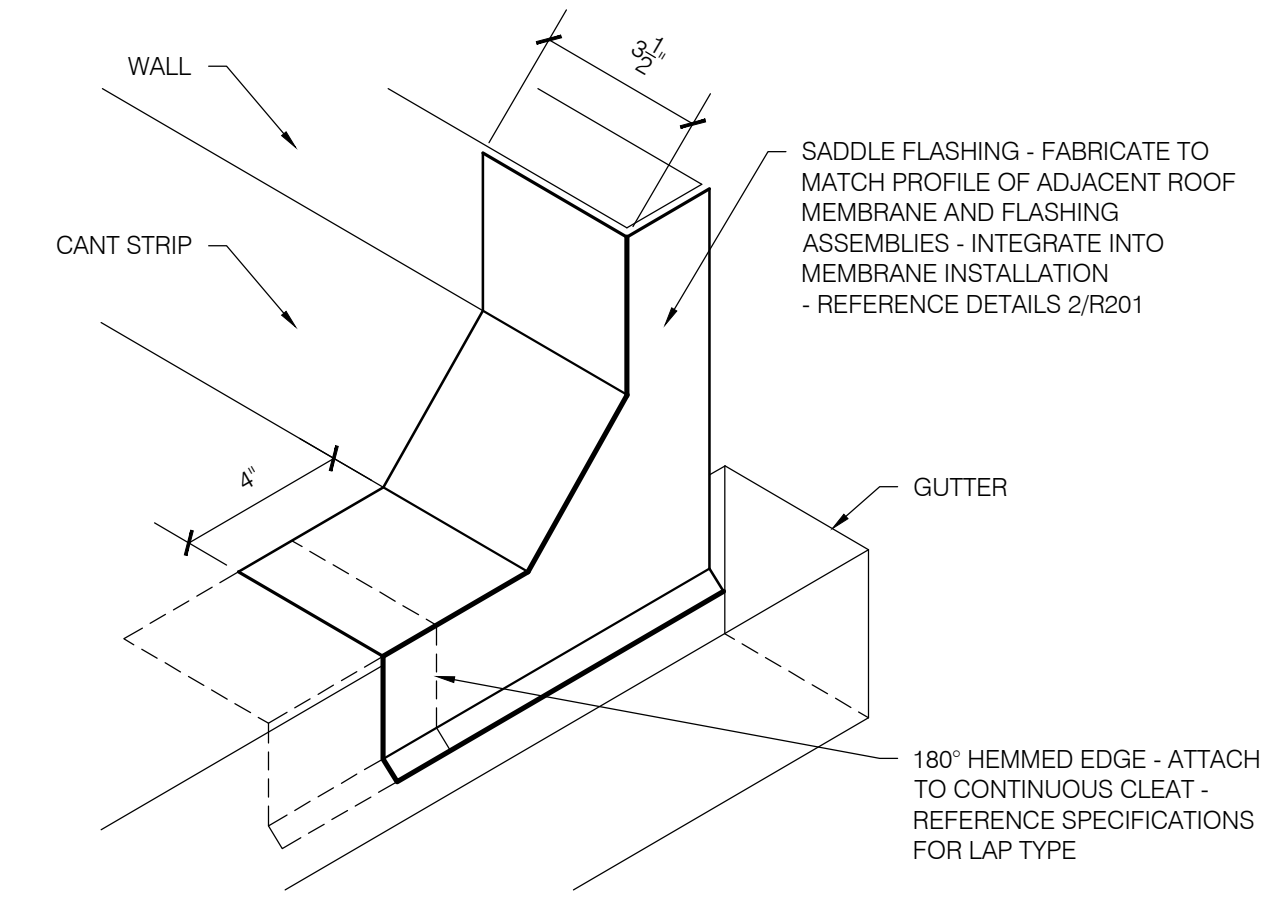


3
R201
 AREAS B, D, F & H
 ROOF-TO-WALL SADDLE FLASHING
 SCALE: 3" = 1'-0"

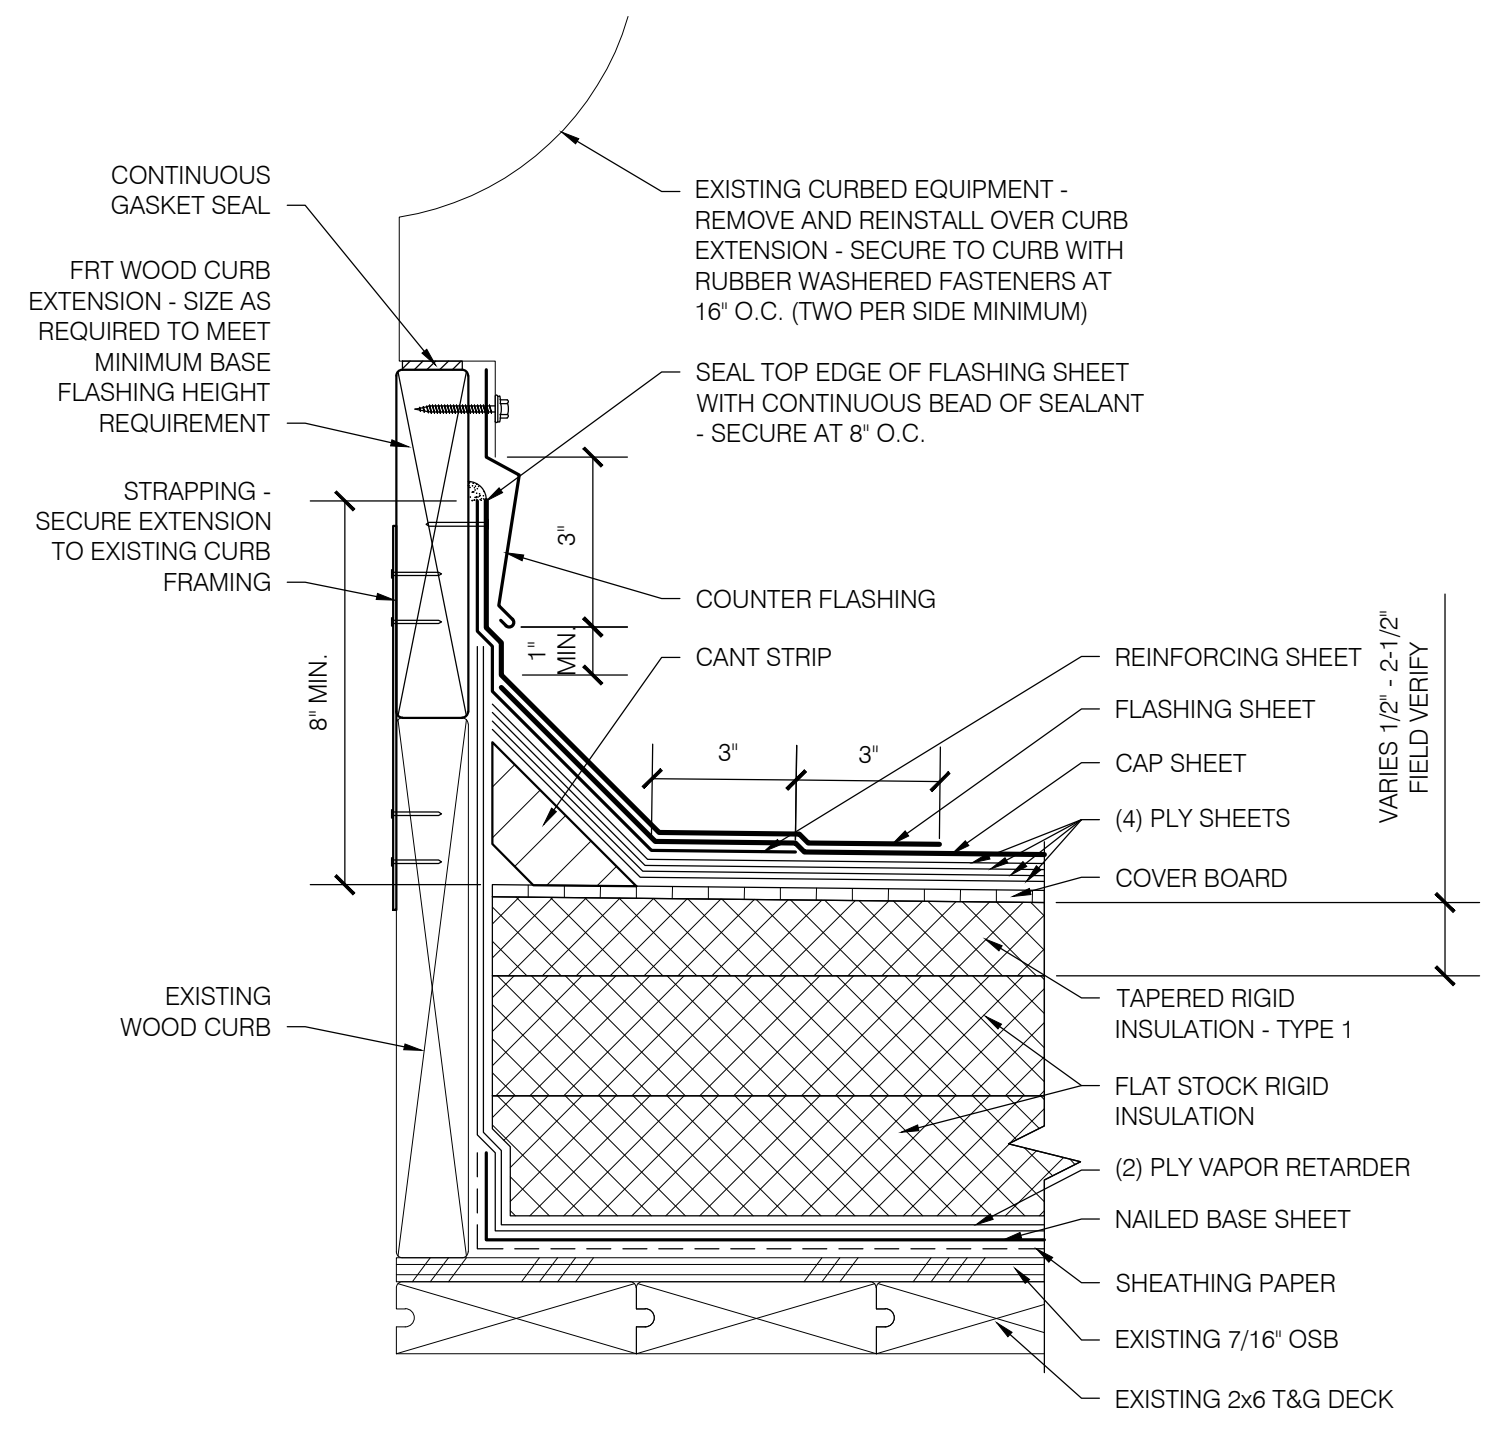

4
R201
 AREAS B, D, E, F & H
 CURBED FAN
 SCALE: 3" = 1'-0" (ROOF ASSEMBLY PER 5/GI2 WHERE SHOWN)

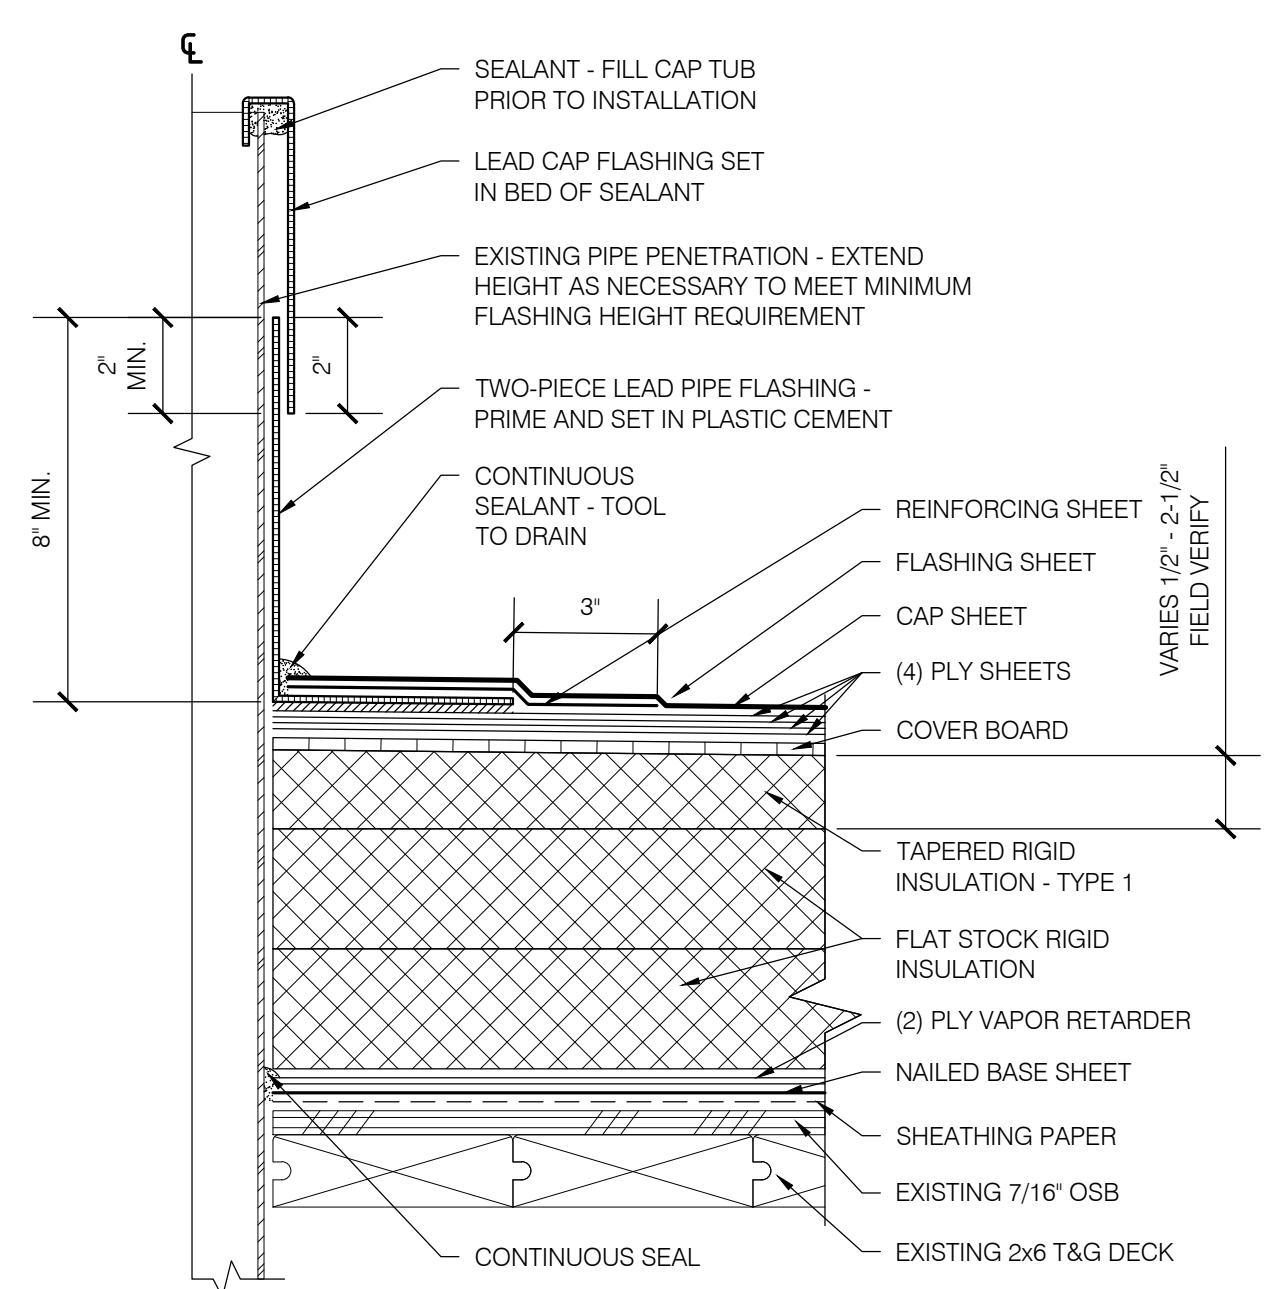

5
R201
 AREAS B, D, F & H
 PLUMBING VENT PIPE
 SCALE: 3" = 1'-0"

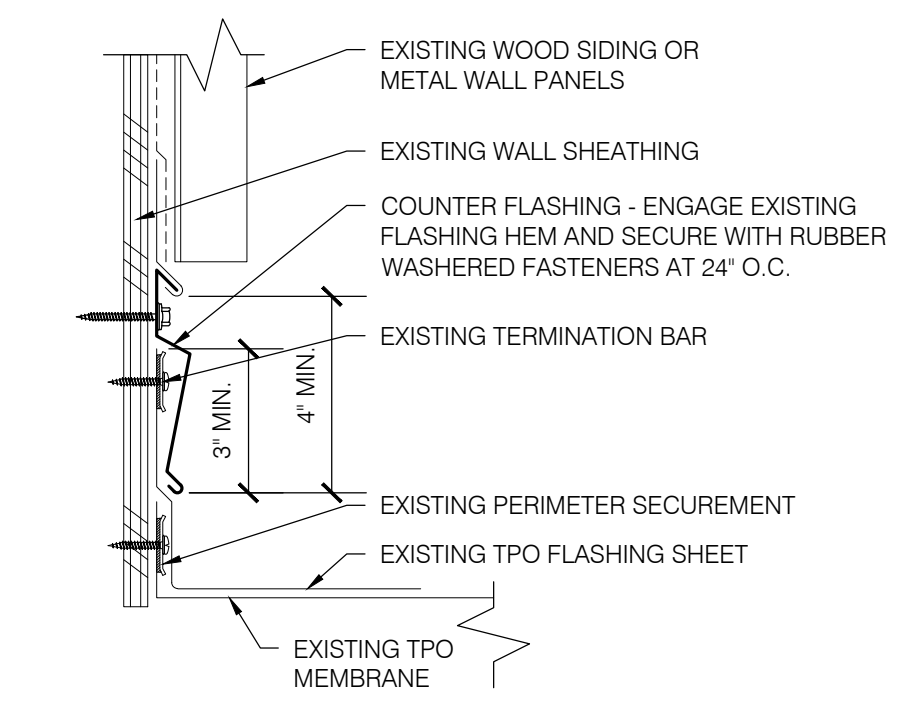

6
R201
 BASE OF PENTHOUSE WALLS AT AREA A INTERFACE
 SCALE: 3" = 1'-0"

SHEET TITLE:
 DETAILS - ALTERNATE NO. 1

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Date: OCTOBER 29, 2021
 Revisions:
 Drawn: TWB
 Check: BAR
 File: R200-Details
 Job: R3282.07

SHEET NUMBER:
R201

REBID SET

GENERAL STRUCTURAL NOTES:

CODE REQUIREMENTS:
CONFORM TO THE 2018 INTERNATIONAL BUILDING CODE AS AMENDED BY THE 2019 OSSC, REFERENCED HEREFTER AS IBC.

DESIGN CRITERIA:
DESIGN WAS BASED ON THE STRENGTH AND DEFLECTION CRITERIA OF THE IBC. IN ADDITION TO THE DEAD LOADS, THE FOLLOWING LOADS WERE USED FOR DESIGN:

GROUND SNOW LOAD Pg: 25 PSF
FLAT-ROOF SNOW LOAD Pf: 25 PSF
SNOW EXPOSURE FACTOR Ce: 1.0
SNOW IMPORTANCE FACTOR ic: 1.10
THERMAL FACTOR Ct: 1.0

BASIC WIND SPEED (3-SEC GUST, ULTIMATE): 105 MPH
BUILDING CATEGORY: III
WIND EXPOSURE: B

EXISTING CONDITIONS:
THE CONTRACTOR SHALL FIELD VERIFY ALL EXISTING CONDITIONS, DIMENSIONS AND ELEVATIONS. THE CONTRACTOR SHALL NOTIFY THE ENGINEER OF ANY DISCREPANCIES FROM CONDITIONS SHOWN ON THE DRAWINGS PRIOR TO THE START OF THE WORK.

TEMPORARY CONDITIONS:
THE CONTRACTOR SHALL BE RESPONSIBLE FOR STRUCTURAL STABILITY OF THE NEW AND EXISTING STRUCTURES AND WALLS DURING CONSTRUCTION. THE STRUCTURE SHOWN ON THE DRAWINGS HAS BEEN DESIGNED FOR STABILITY UNDER THE FINAL CONFIGURATION ONLY.

CARPENTRY:
SAWN LUMBER DESIGN IS BASED ON THE NATIONAL DESIGN SPECIFICATION, LATEST EDITION. SAWN LUMBER SHALL CONFORM TO WEST COAST LUMBER INSPECTION BUREAU OR WESTERN WOOD PRODUCTS ASSOCIATION GRADING RULES. UNLESS NOTED OTHERWISE ALL LUMBER SHALL BE 19% AT TIME OF FABRICATION AND DRIED TO A MAXIMUM OF 15% BEFORE INSTALLATION OF GYP. BOARD AND OF BRICK VENEER AND VERIFIED BY THE GENERAL CONTRACTOR. ALL WOOD IN PERMANENT CONTACT WITH CONCRETE OR CMU SHALL BE PRESSURE TREATED UNLESS AN APPROVED BARRIER IS PROVIDED. GRADES SHALL BE D.F. #2 UNLESS NOTED OTHERWISE ON THE PLANS.

FRAMING ACCESSORIES AND STRUCTURAL FASTENERS SHALL BE MANUFACTURED BY SIMPSON STRONG-TIE COMPANY (OR ENGINEER APPROVED EQUAL) AND OF THE SIZE AND TYPE SHOWN ON THE DRAWINGS AND ATTACHED PER MANUFACTURER'S REQUIREMENTS AND RECOMMENDATIONS UNLESS NOTED OTHERWISE. HANGERS NOT SHOWN SHALL BE SIMPSON HU OF SIZE RECOMMENDED FOR MEMBER. ALL FRAMING NAILS SHALL BE COMMON NAILS. NO BOX NAILS ALLOWED. FASTENERS AND ACCESSORIES IN CONTACT WITH PRESERVATIVE TREATED WOOD MUST BE HOT DIPPED GALVANIZED OR HAVE ZMAX COATING. ALL FASTENERS IN CONTACT WITH FIRE RETARDANT LUMBER MUST BE HOT-DIPPED GALVANIZED. DO NOT INSTALL 0.148" x 1 1/2" NAILS IN HANGERS UNLESS SPECIFICALLY NOTED ON THE PLANS & DETAILS. NAIL CALLOUTS SHALL BE INTERPRETED AS FOLLOWS:

NAIL CALLOUT	DIAMETER	LENGTH
8d COMMON	0.131"	2 1/2"
10d COMMON	0.148"	3"
16d COMMON	0.162"	3 1/2"
16d SINKER	0.148"	3 1/4"
ROOF SHEATHING NAILS	0.131"	2 1/2" (RING SHANK AT DECK ROOF)

SHEATHING PANELS SHALL CONFORM TO THE REQUIREMENTS OF VOLUNTARY PRODUCT STANDARD PS 1 OR PS 2, OR APA PRP-108 PERFORMANCE STANDARDS. UNLESS NOTED, PANELS SHALL BE APA RATED SHEATHING, EXPOSURE 1, OF THE THICKNESS AND SPAN RATING SHOWN ON THE DRAWINGS. INSTALLATION SHALL BE IN CONFORMANCE WITH APA RECOMMENDATIONS. ALLOW 1/8" SPACING AT PANEL ENDS AND EDGES, UNLESS OTHERWISE RECOMMENDED BY THE PANEL MANUFACTURER.

ALL ROOF SHEATHING SHALL BE INSTALLED WITH FACE GRAIN PERPENDICULAR TO SUPPORTS, EXCEPT AS INDICATED ON THE DRAWINGS. ROOF SHEATHING SHALL EITHER BE BLOCKED, TONGUE-AND-GROOVE, OR HAVE EDGES SUPPORTED BY PLYCLIPS. NAILING NOT SPECIFICALLY IDENTIFIED ON THE DRAWINGS SHALL CONFORM TO IBC TABLE 2304.9.1.

METALS:
ALL MISCELLANEOUS STEEL: ASTM A36 (Fy=36,000 PSI), OR AS NOTED ASTM A572 (Fy=50 KSI).
ALL BOLTS: ASTM A307 UNLESS NOTED OTHERWISE.
ALL STEEL TO HAVE SHOP COAT.
ALL STEEL EXPOSED TO WEATHER SHALL BE HOT DIP GALVANIZED PER ASTM 123 FOR STRUCTURAL STEEL AND ASTM 153 FOR BOLTS AND HARDWARE. FABRICATION OF STEEL THAT IS TO BE HOT DIP GALVANIZED SHALL ALSO MEET ASTM A385. REPAIR OF DAMAGED GALVANIZED COATING SHALL BE MADE WITH PRODUCTS MEETING ASTM A780 AND AS A MINIMUM SHALL BE 50% GREATER IN THICKNESS THAN THE SURROUNDING GALVANIZING.

MECHANICAL:
THE CONTRACTOR SHALL COORDINATE SEISMIC RESTRAINTS OF ELECTRICAL EQUIPMENT, MECHANICAL, PLUMBING, FIRE SPRINKLER, MACHINERY, AND ASSOCIATED PIPING WITH THE STRUCTURE. ANY CONNECTIONS TO STRUCTURE NOT CONFORMING TO SHEET METAL AND AIR CONDITIONING CONTRACTORS NATIONAL ASSOCIATION (SMACNA), OR SPECIFICALLY DETAILED ON THE MECHANICAL ENGINEER'S DRAWINGS, SHALL BE DESIGNED IN ACCORDANCE OF THESE GENERAL NOTES, BY AN ENGINEER REGISTERED IN THE STATE OF WASHINGTON, AND SHALL BE SUBMITTED TO THE ENGINEER PRIOR TO FABRICATION.

FLASHING AND WATERPROOFING:
ALL FLASHING AND WATERPROOFING SHALL BE PER PROFESSIONAL ROOF CONSULTANTS UNLESS NOTED OTHERWISE ON THE PLANS.

FALL PROTECTION GENERAL STRUCTURAL NOTES:


CODE REQUIREMENTS:
1. CONFORM TO THE 2018 INTERNATIONAL BUILDING CODE AS AMENDED BY THE 2019 OREGON STRUCTURAL SPECIALTY CODE, REFERENCED HEREFTER AS IBC.
2. CONFORM TO OREGON OSHA STANDARDS FOR THE CONSTRUCTION INDUSTRY SUBPART M (FALL PROTECTION) AND ALL APPLICABLE STATE ADMINISTRATIVE CODE SAFETY STANDARDS.
3. CONFORM TO ANSIASSE Z359 AMERICAN NATIONAL STANDARD, CURRENT EDITION.

SYSTEM REQUIREMENTS:
1. INDIVIDUAL ANCHORS SHALL BE USED FOR A MAXIMUM OF ONE PERSON IN FALL ARREST OR FALL RESTRAINT.
2. PERSONAL FALL ARREST SYSTEMS (PFAS) SHALL BE LIMITED TO FULL BODY HARNESSES THAT LIMIT THE MAXIMUM FALL ARREST LOAD TO 900 LBS.
3. ANCHORS ARE TO BE USED ONLY BY PERSONS TRAINED IN THEIR USE. LANYARDS, SAFETY HARNESSES, ATTACHMENTS, AND ALL OTHER PERSONAL SAFETY DEVICES ATTACHED TO THE ANCHOR ARE THE SOLE RESPONSIBILITY OF THE USER AND NOT TM RIPPEY CONSULTING ENGINEERS.
4. ANCHORS ARE TO BE VISUALLY INSPECTED BY THE USER PRIOR TO EACH USE.
5. ANCHORS ARE TO BE INSPECTED ANNUALLY BY A 'QUALIFIED PERSON'.
6. ANCHORS SHALL BE RE-CERTIFIED BY A 'COMPETENT PERSON' WHEN RE-ROOFING OR RENOVATION OR AT PERIODS NOT TO EXCEED 10 YEARS.
7. THE SYSTEM USER IS TO MAINTAIN A LOG BOOK OF USE AND INSPECTION.
8. FALL PROTECTION SYSTEMS SERVING ROOF EDGES WITH INSUFFICIENT HEIGHT FOR FALL ARREST CLEARANCE SHALL BE CLEARLY IDENTIFIED AS 'FALL RESTRAINT' ONLY.

ANCHOR LOADS:
ULTIMATE ANCHOR LOAD: 5000 LB
ALLOWABLE LOAD: 310 LB (PER PERSON, COMBINED BODY WEIGHT AND TOOLS).

PRODUCTS:
1. SINGLE POINT FALL ARREST ANCHORS - 'GUARDIAN CB18', OR EQUIVALENT APPROVED BY THE ENGINEER.

INSTALLATION:
1. INSTALL IN ACCORDANCE WITH APPROVED DRAWINGS AND MANUFACTURER'S INSTRUCTIONS.
2. PROVIDE SPECIAL INSPECTION OF INSTALLATION BY A CERTIFIED INDEPENDENT TESTING LABORATORY EMPLOYED BY THE OWNER.

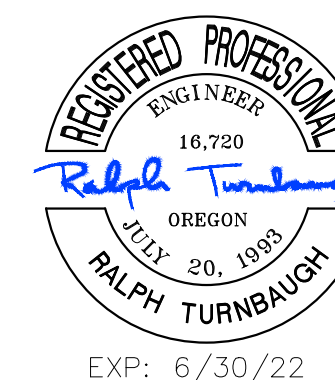

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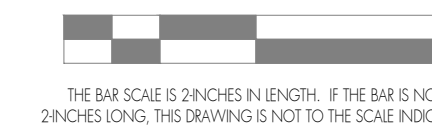
EXP: 6/30/22



**EUGENE SCHOOL DISTRICT 4J
MONROE MIDDLE SCHOOL
ROOF REPLACEMENT**

SHEET TITLE:
GENERAL STRUCTURAL NOTES
AND FALL PROTECTION
STRUCTURAL NOTES

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Date: OCTOBER 29, 2021

Revisions:

Drawn: JSC


Check: JH / RNT

File:

TMR Job: 21069

REBID SET

SHEET NUMBER:
S100

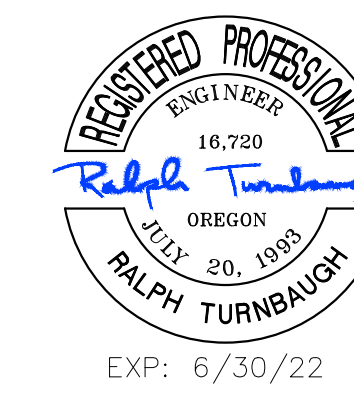


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 EXP: 6/30/22



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EUGENE SCHOOL DISTRICT 4J MONROE MIDDLE SCHOOL ROOF REPLACEMENT

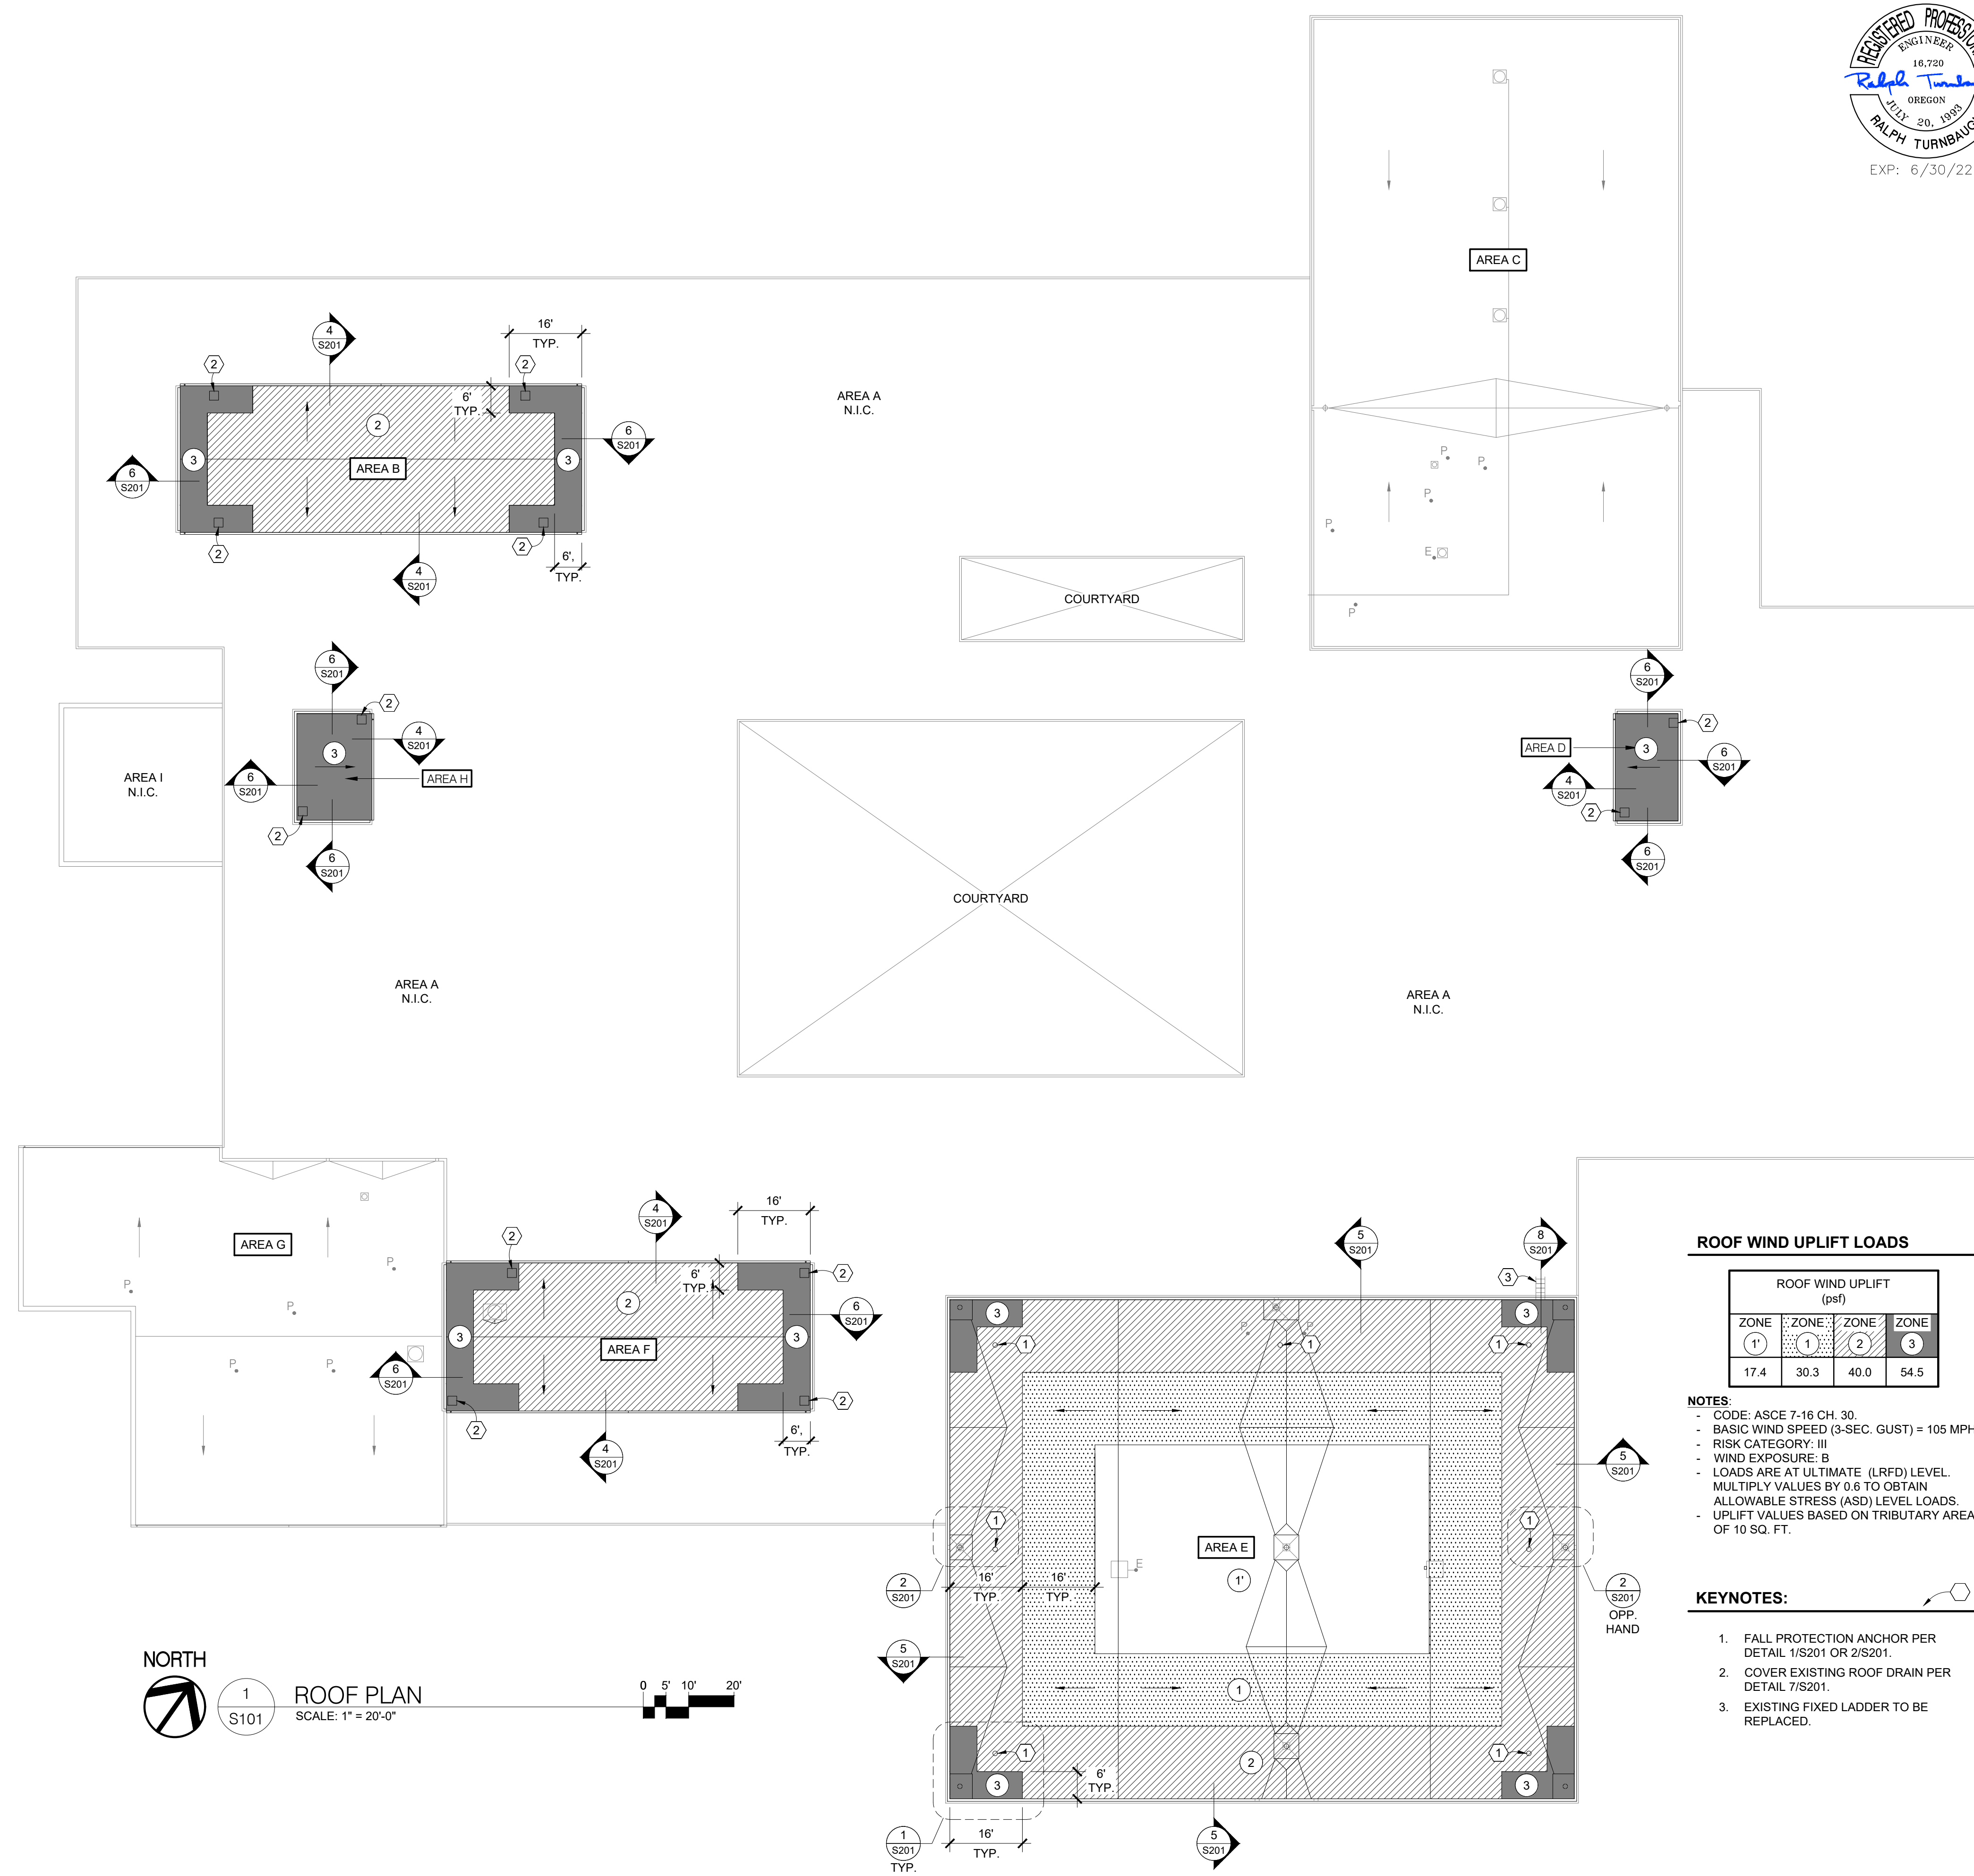

ROOF WIND UPLIFT LOADS

ROOF WIND UPLIFT (psf)			
ZONE	ZONE	ZONE	ZONE
(1)	(1)	(2)	(3)
17.4	30.3	40.0	54.5

- NOTES:**
- CODE: ASCE 7-16 CH. 30.
 - BASIC WIND SPEED (3-SEC. GUST) = 105 MPH
 - RISK CATEGORY: III
 - WIND EXPOSURE: B
 - LOADS ARE AT ULTIMATE (LRFD) LEVEL. MULTIPLY VALUES BY 0.6 TO OBTAIN ALLOWABLE STRESS (ASD) LEVEL LOADS.
 - UPLIFT VALUES BASED ON TRIBUTARY AREA OF 10 SQ. FT.

KEYNOTES:

1. FALL PROTECTION ANCHOR PER DETAIL 1/S201 OR 2/S201.
2. COVER EXISTING ROOF DRAIN PER DETAIL 7/S201.
3. EXISTING FIXED LADDER TO BE REPLACED.

SHEET TITLE:
 ROOF PLAN
 WIND LOAD DIAGRAM


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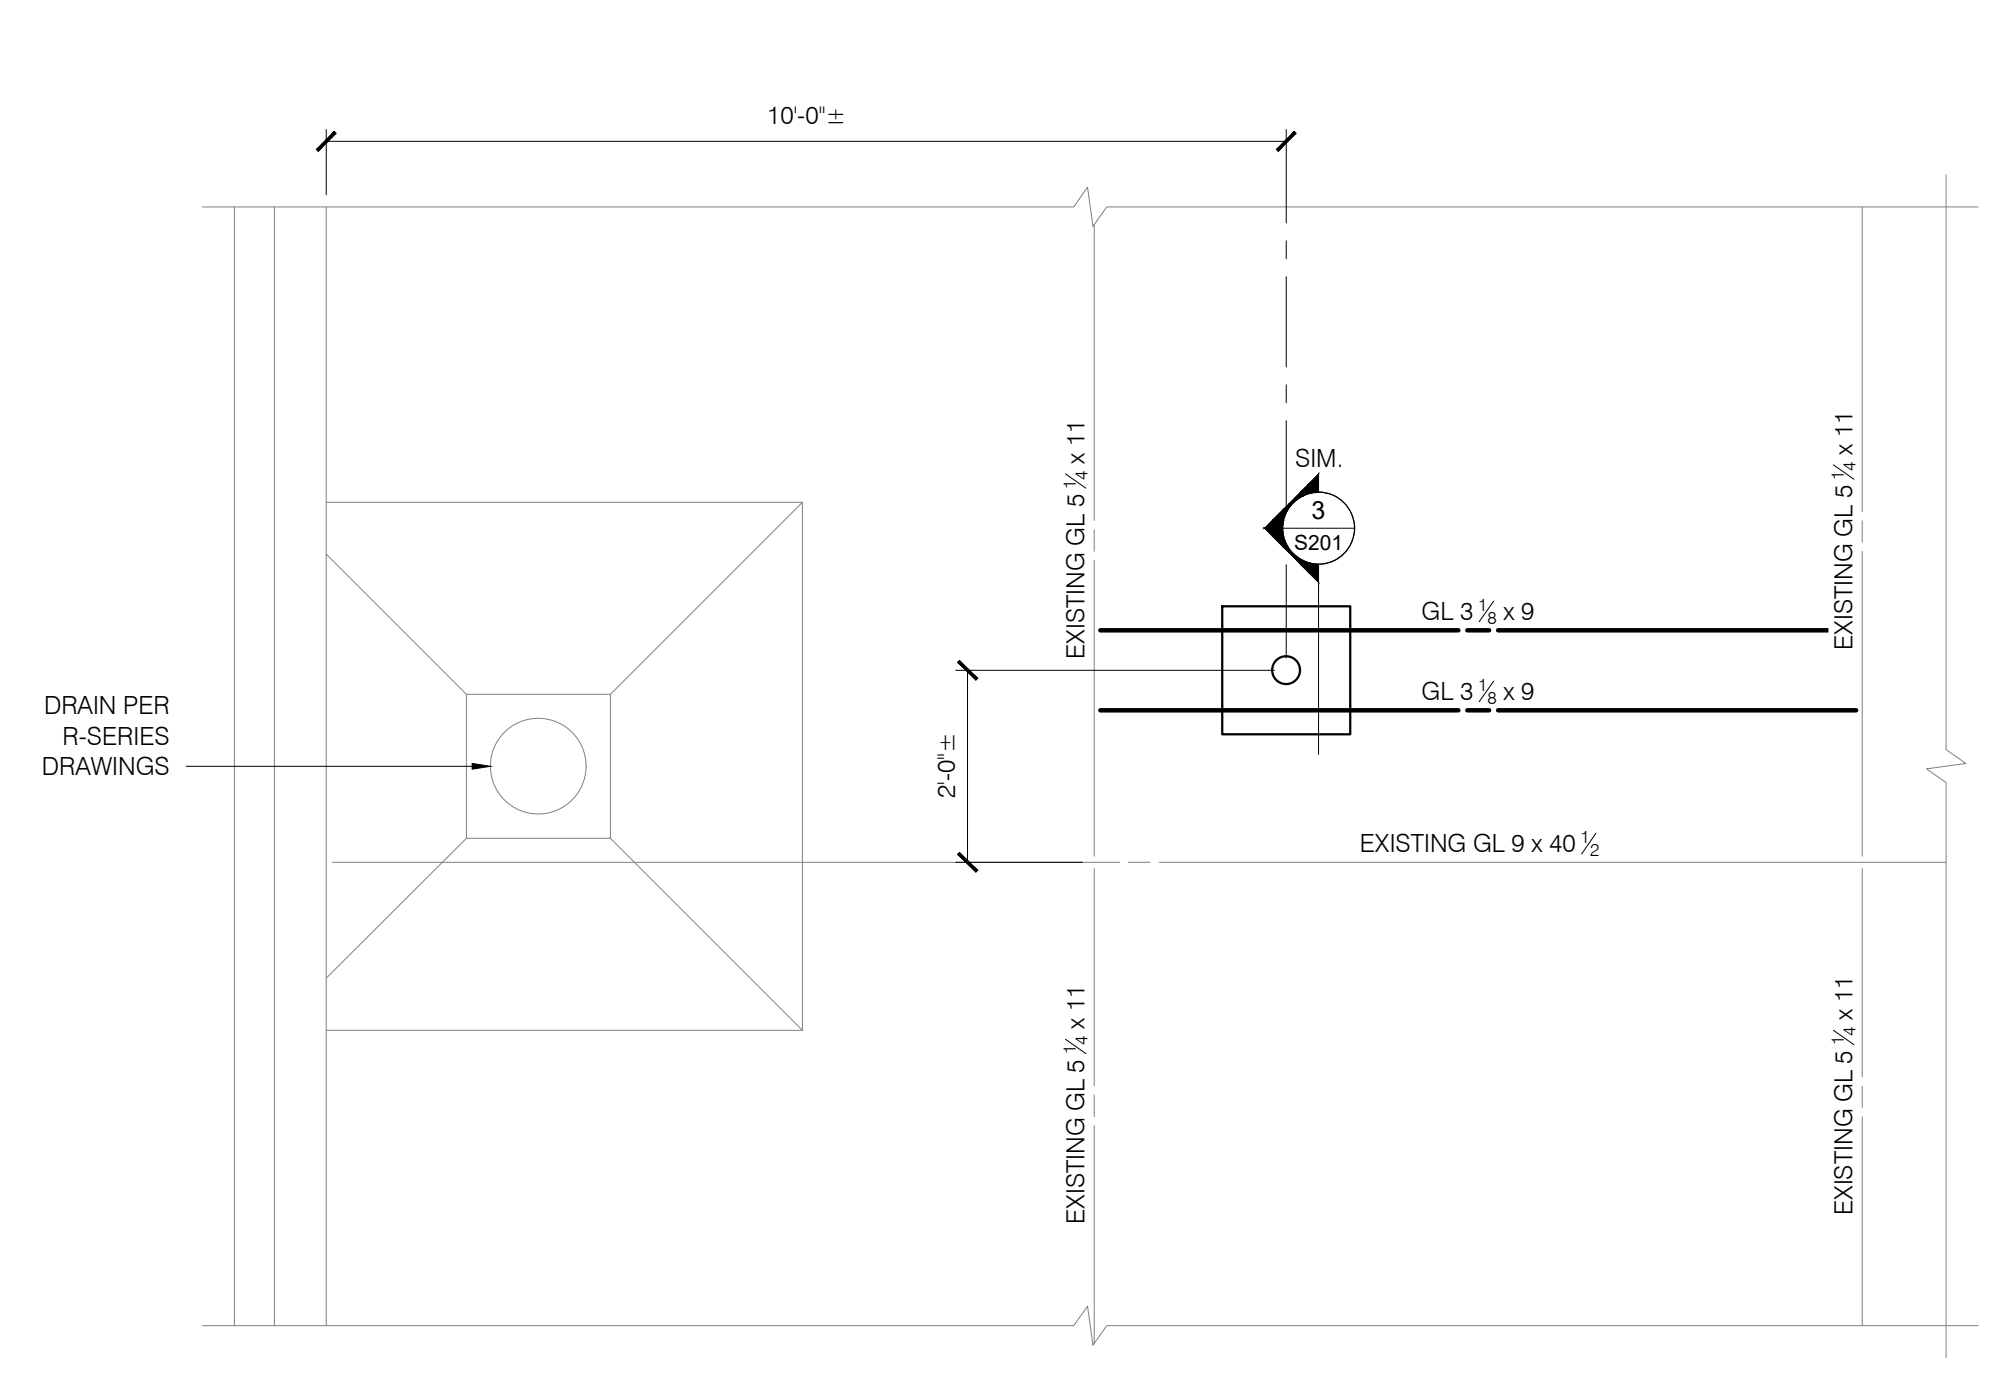
Date: OCTOBER 29, 2021
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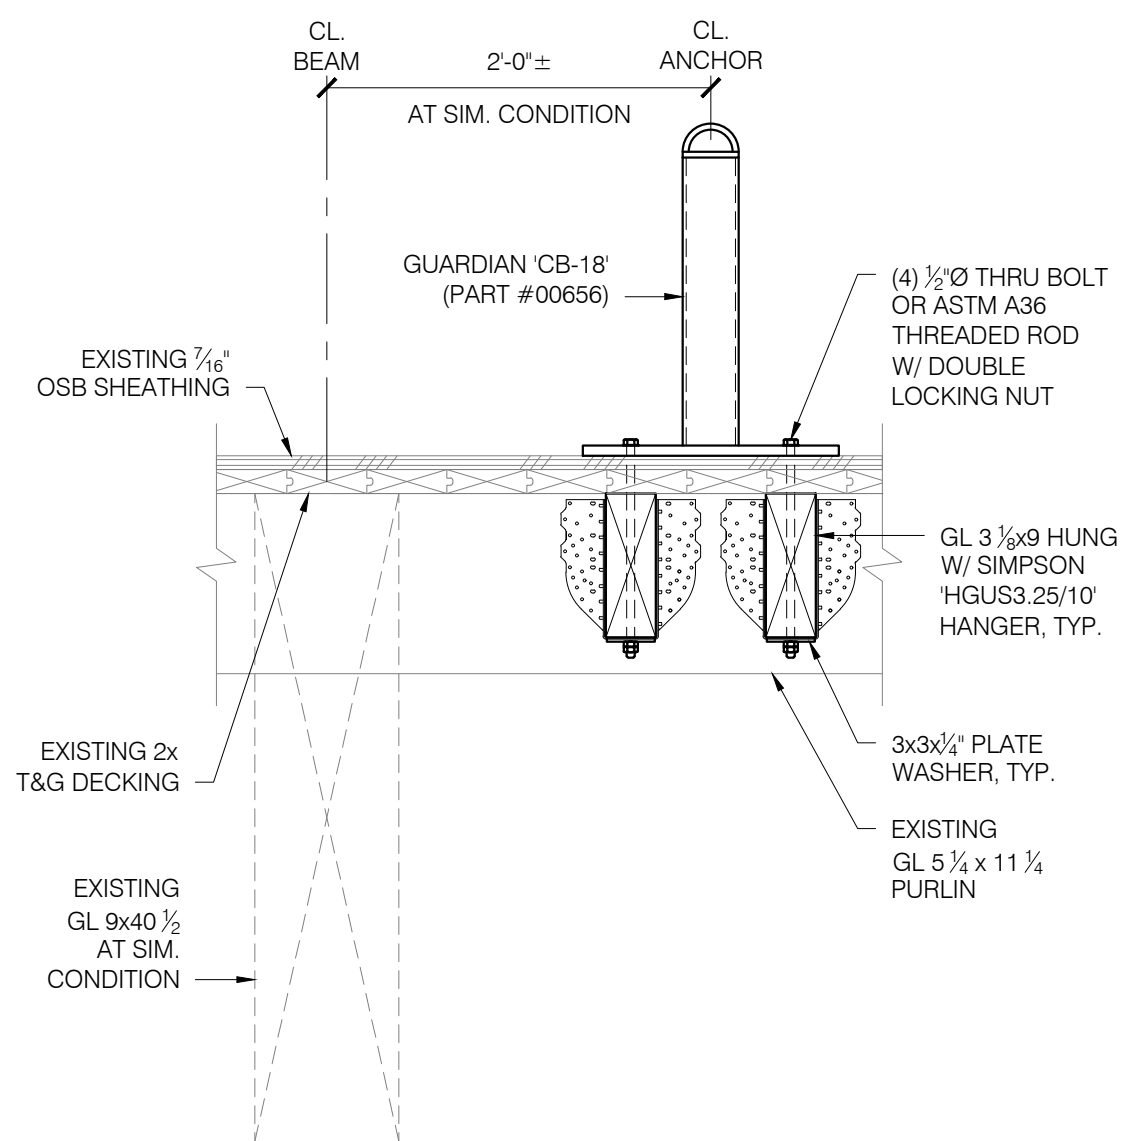
SHEET NUMBER:
S101




1 PLAN AT FALL PROTECTION ANCHOR
 S201 21069-01 SCALE: 1/2" = 1'-0"




2 PLAN AT FALL PROTECTION ANCHOR
 S201 21069-02 SCALE: 1/2" = 1'-0"

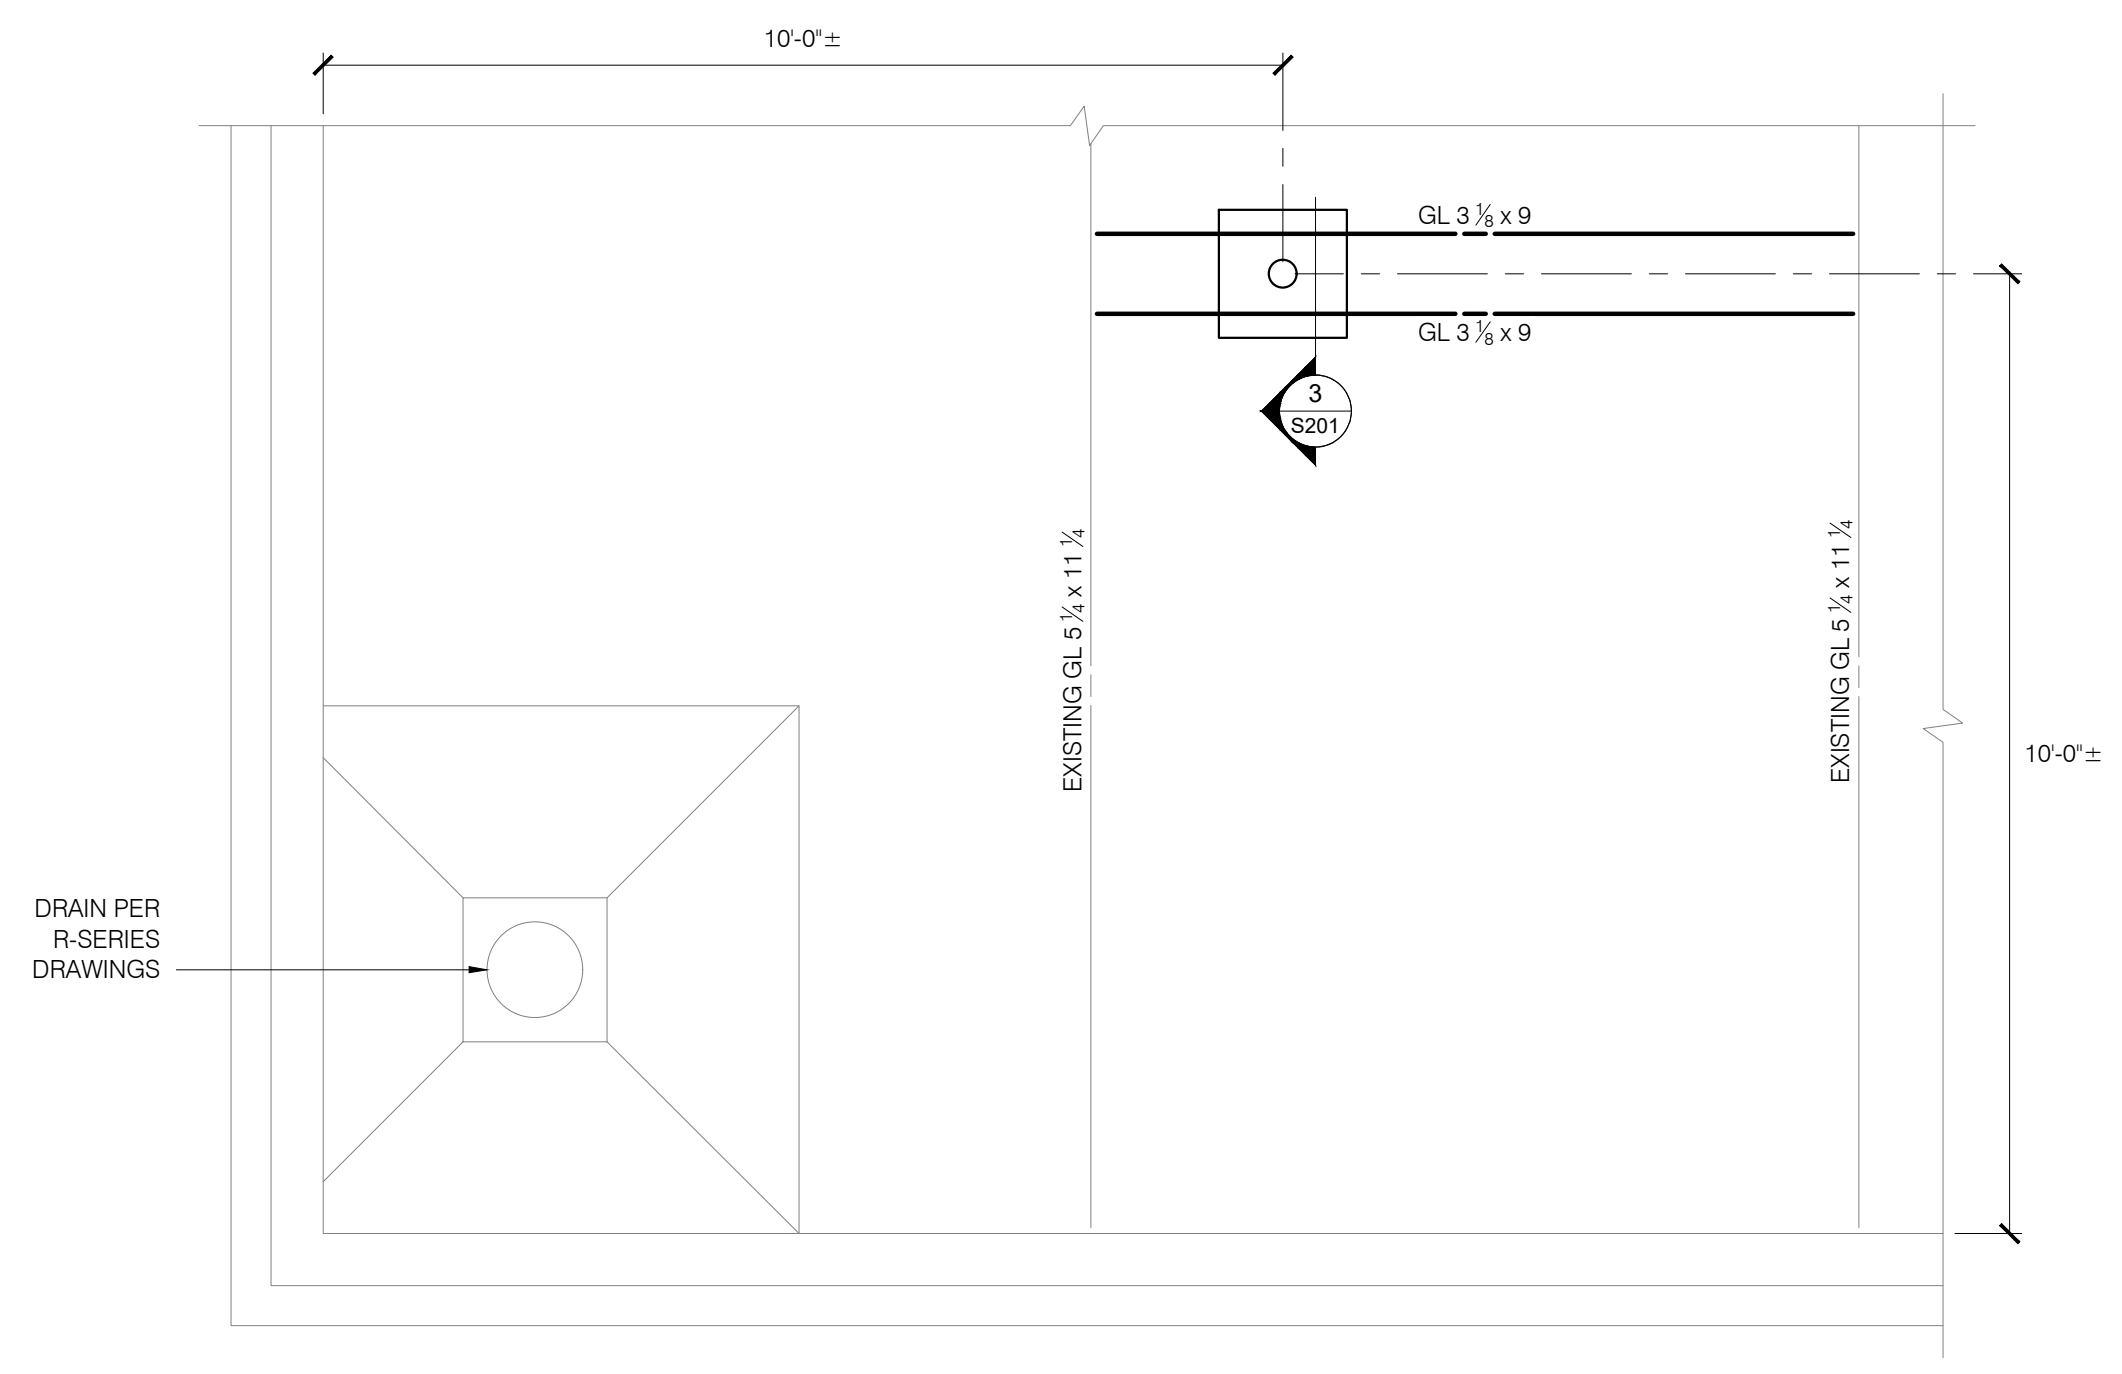


3 FALL ANCHOR SECTION
 S201 21069-03 SCALE: 1" = 1'-0"

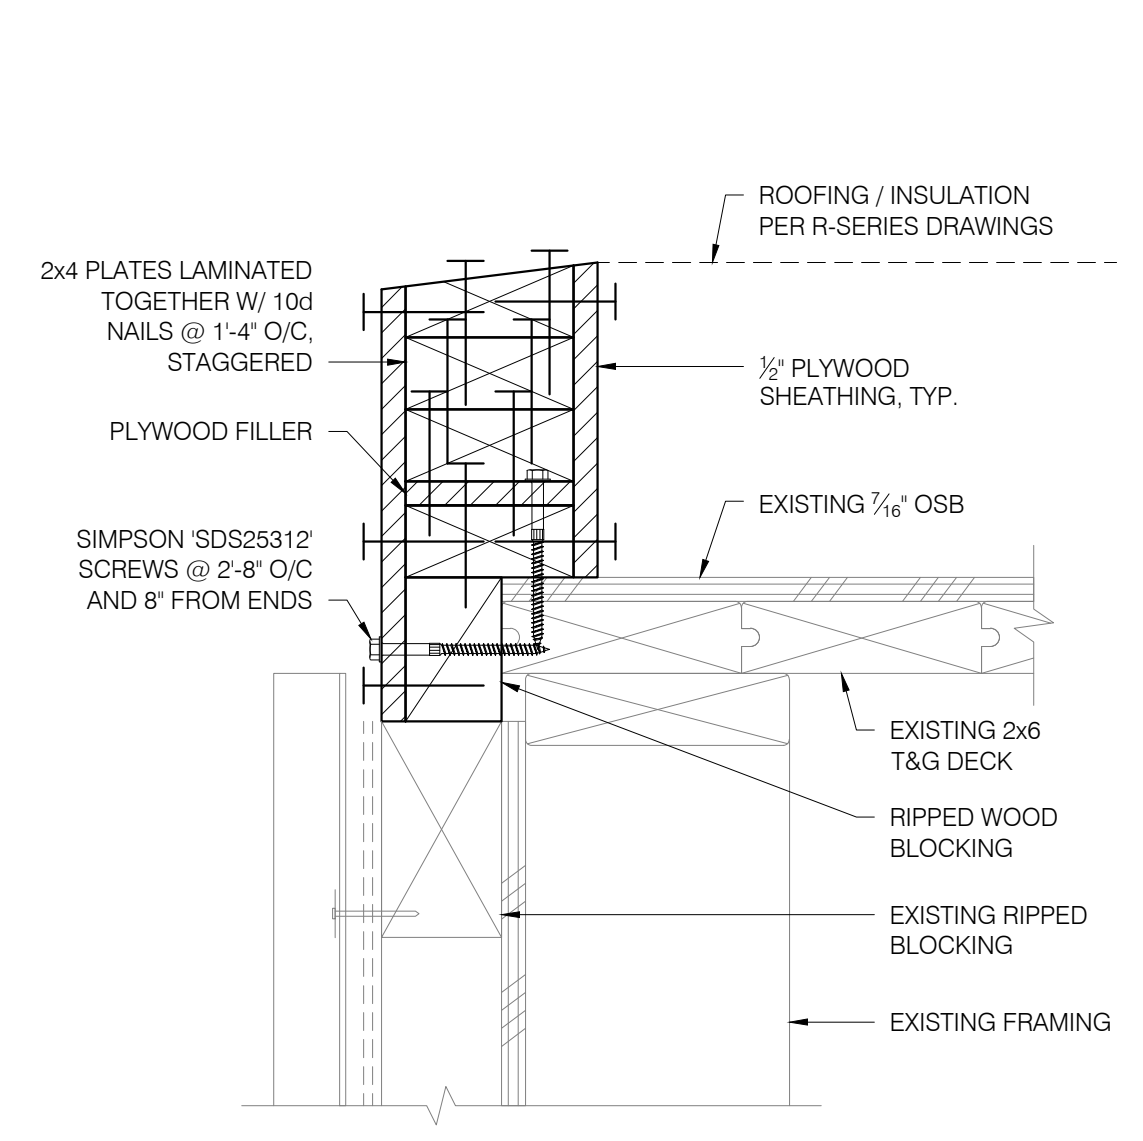


4 AREA: B, D, F, & H GUTTER EDGE
 S201 21069-04 SCALE: 3" = 1'-0"

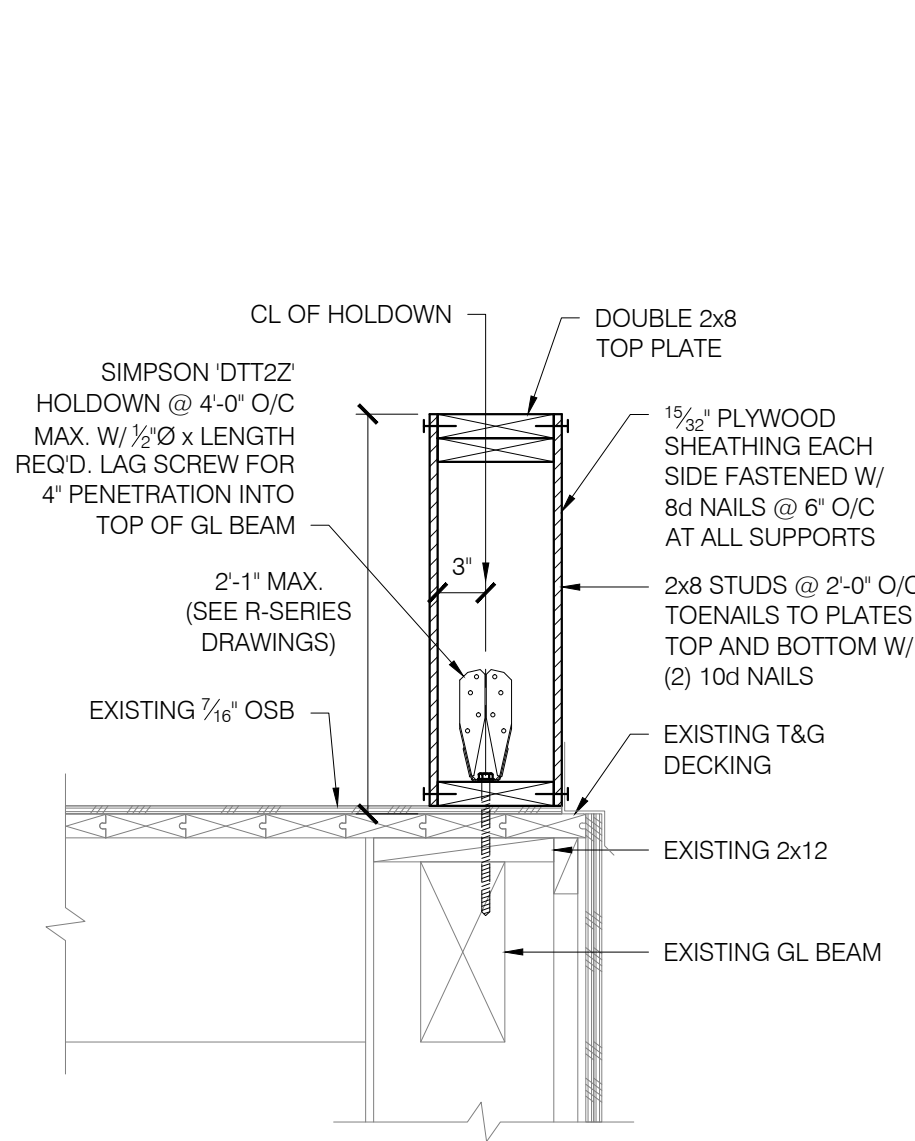


5 AREA 'E' PARAPET SECTION
 S201 21069-05 SCALE: 1" = 1'-0"

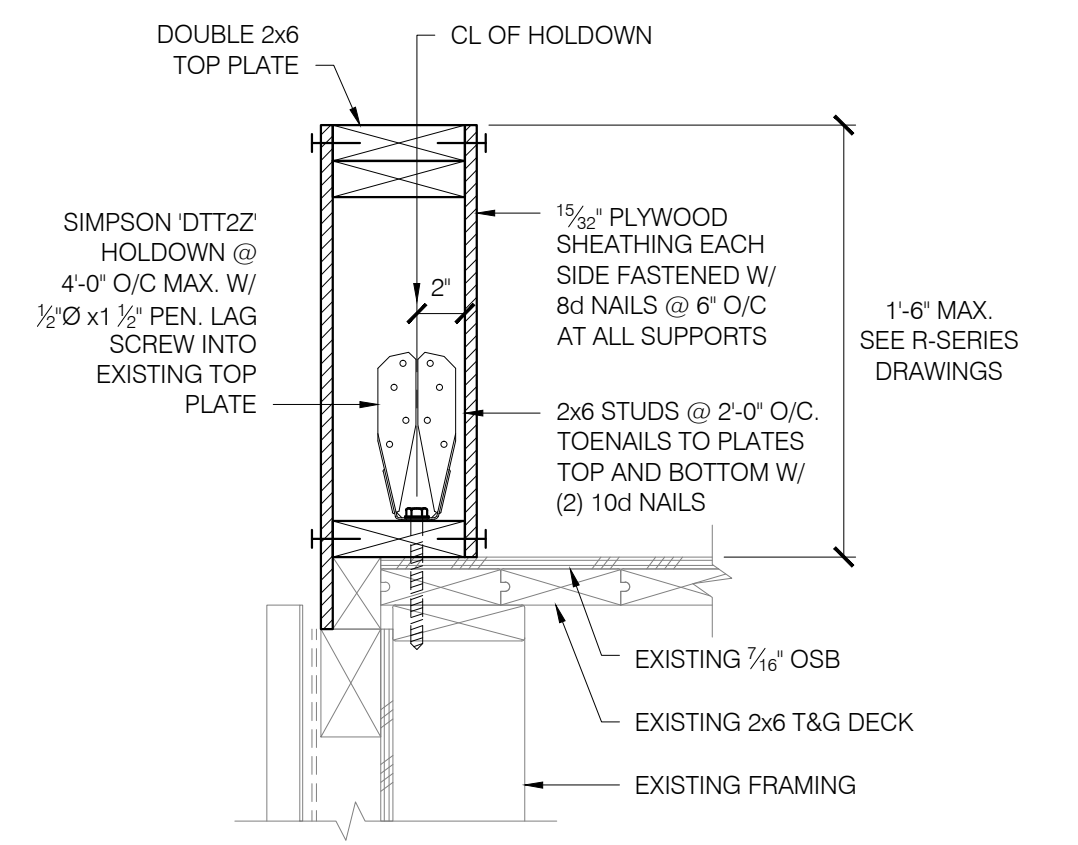


6 AREAS 'B', 'D', 'F', & 'H' PARAPET SECTION
 S201 21069-06 SCALE: 1 1/2" = 1'-0"

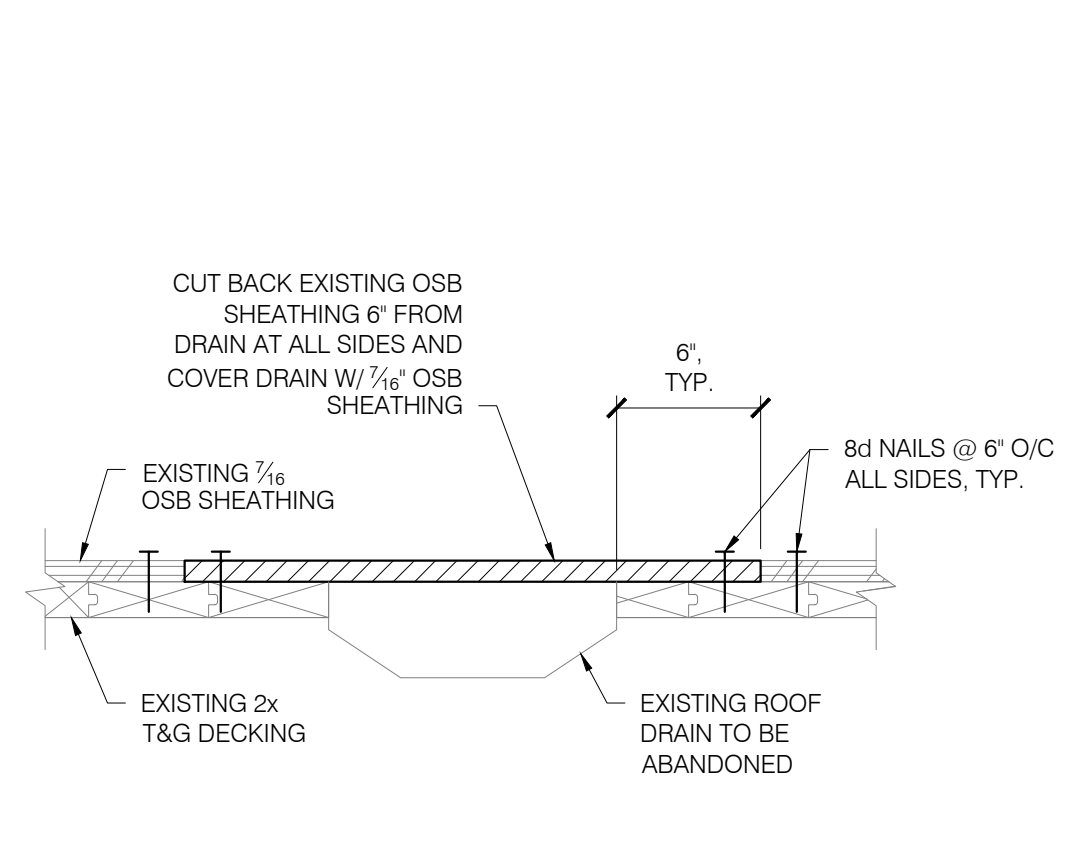

7 SECTION AT ABANDONED ROOF DRAIN
 S201 21069-07 SCALE: 1 1/2" = 1'-0"

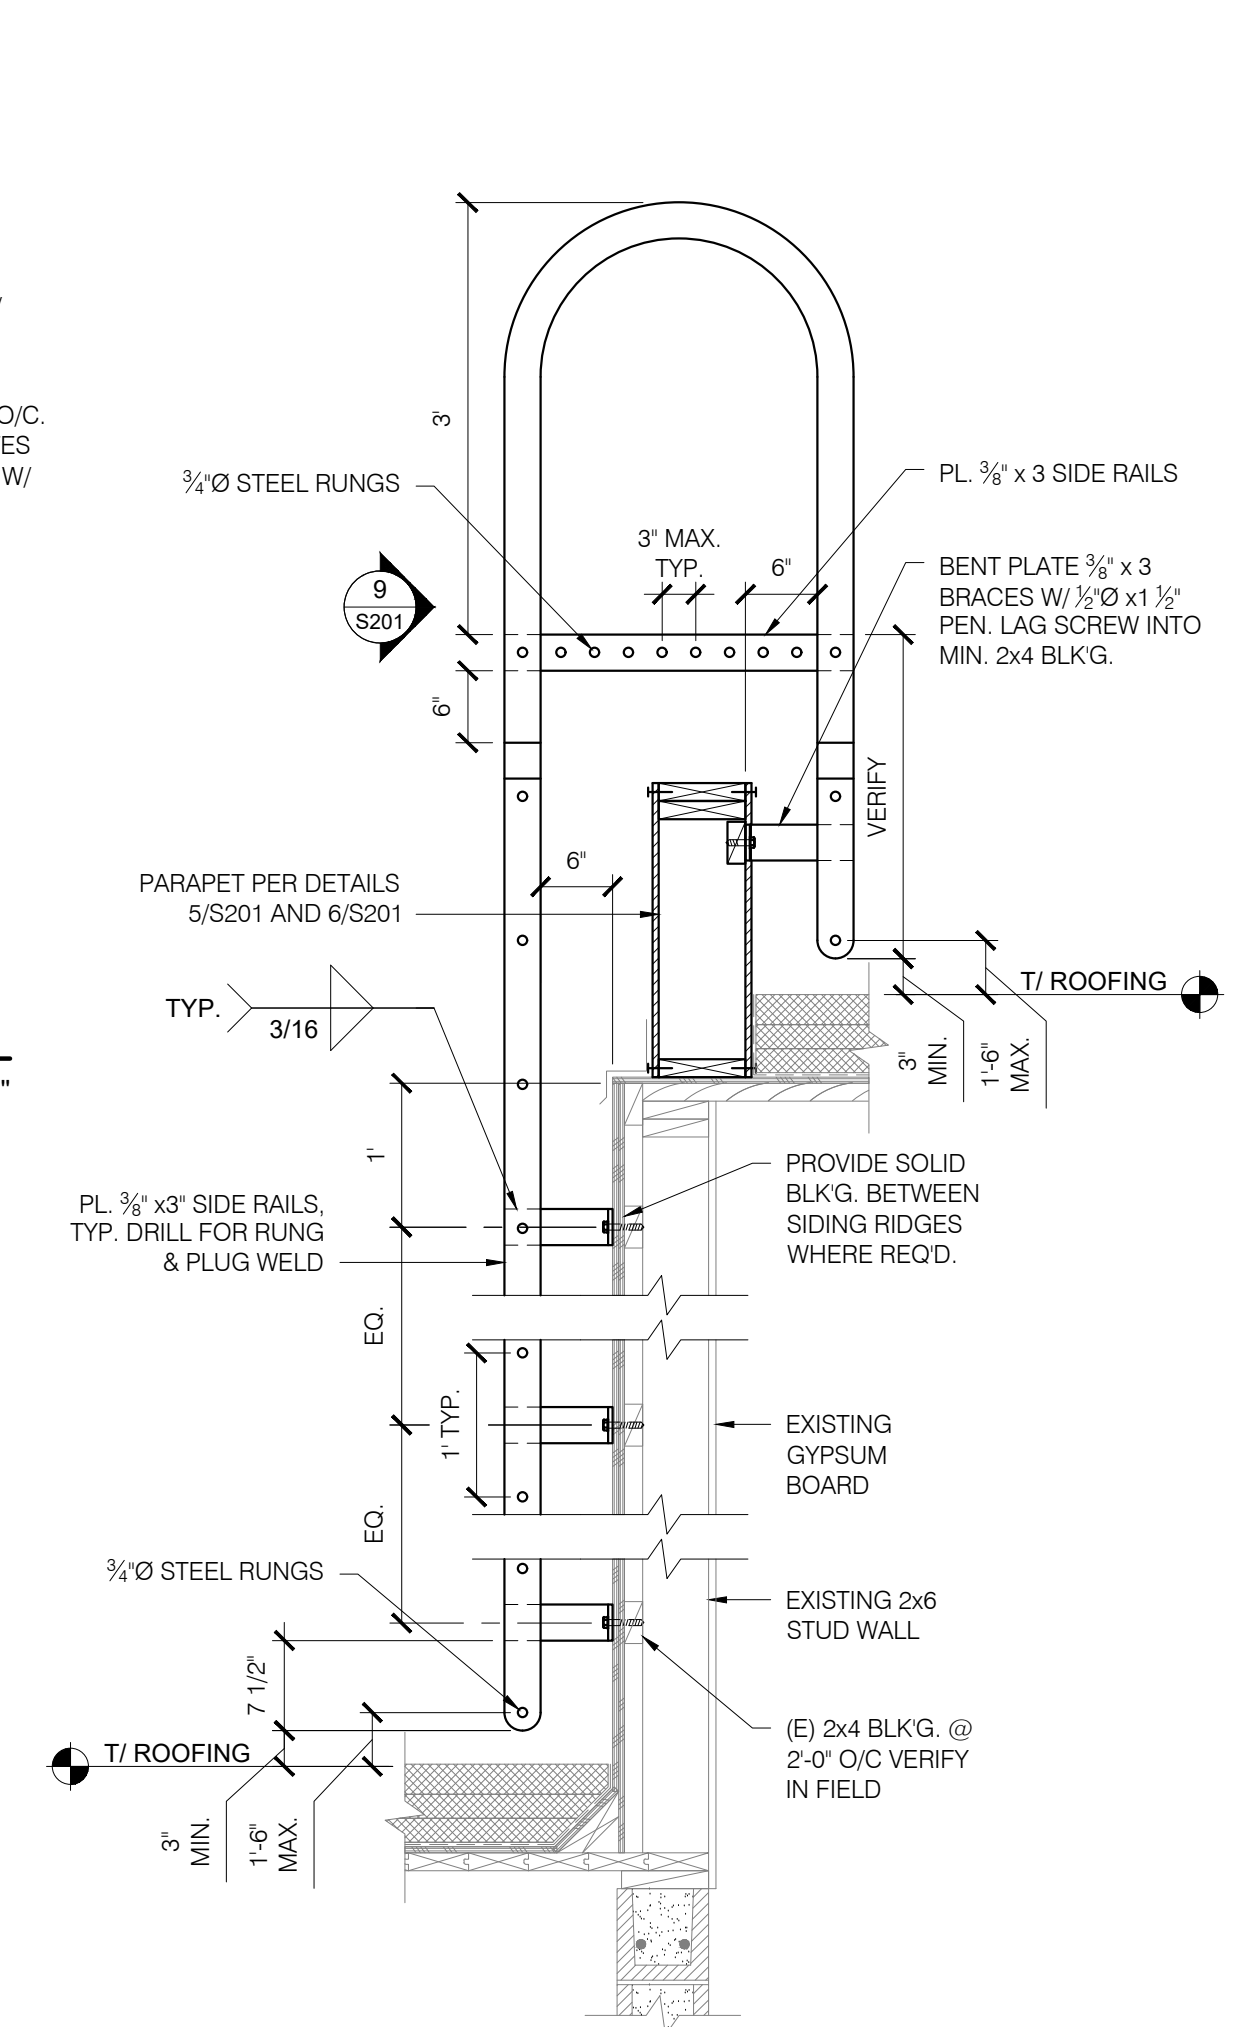

8 ROOF LADDER SECTION
 S201 21069-08 SCALE: 3/4" = 1'-0"

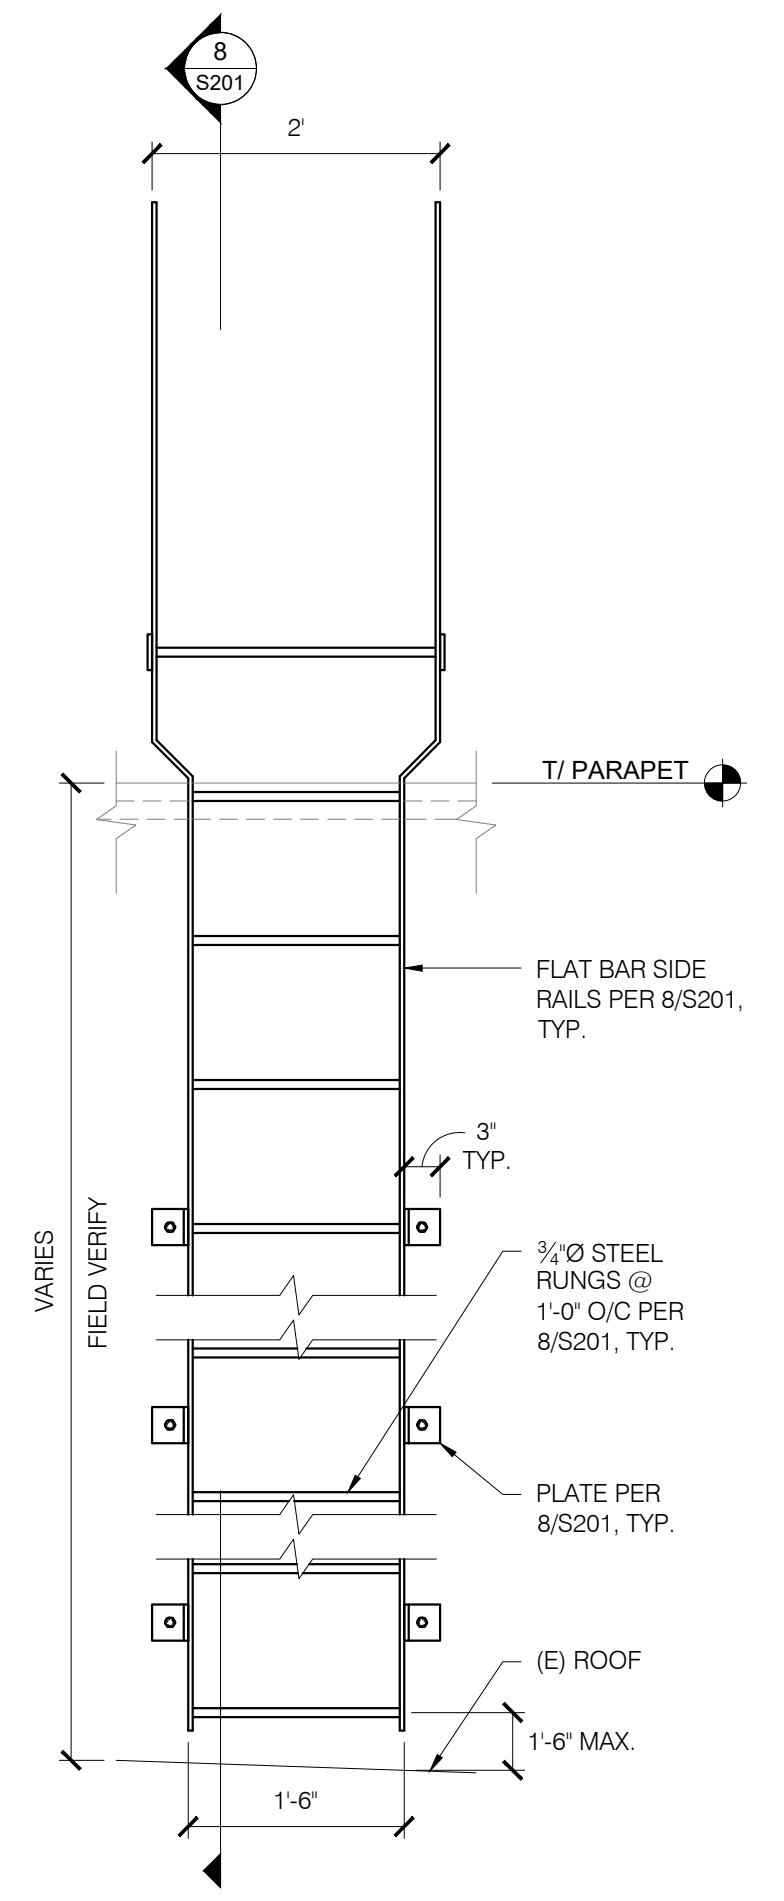

9 ROOF LADDER ELEVATION
 S201 21069-09 SCALE: 3/4" = 1'-0"

EUGENE SCHOOL DISTRICT 4J
MONROE MIDDLE SCHOOL
ROOF REPLACEMENT

SHEET TITLE:
 STRUCTURAL DETAILS
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