
## EUGENE SCHOOL DISTRICT 4J SPENCER BUTTE MIDDLE SCHOOL ROOF REPLACEMENT PROJECT

## SITE MAPS

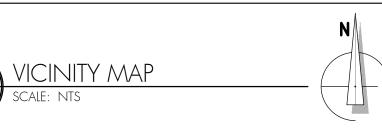










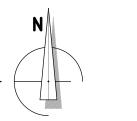

## GENERAL NOTES

- CONTRACTOR IS RESPONSIBLE FOR VERIFYING ALL DIMENSIONS AND CONDITIONS OF THE PROJECT, INCLUDING VERIFICATION OF EXISTING ROOF SYSTEM CONSTRUCTION AND MATERIALS.
- 2. EXISTING MATERIALS AND CONSTRUCTION ARE NOTED ON THE DRAWINGS AS EXISTING. ALL OTHER NOTATIONS INDICATE NEW MATERIALS, PRODUCTS, AND CONSTRUCTION UNLESS OTHERWISE STATED OR INDICATED.
- 3. ALL PERMITTING, INCLUDING ROAD CLOSURES, PARKING STALLS, SIDEWALK CLOSURES, SCAFFOLD ERECTION, ETC. SHALL BE COORDINATED, OBTAINED, AND PAID FOR BY CONTRACTOR.
- 4. CONTRACTOR STAGING AND STORAGE AREAS SHALL BE AS DIRECTED BY THE OWNER'S REPRESENTATIVE AT THE PRE-CONSTRUCTION MEETING. CONTRACTOR SHALL ASSUME A REASONABLE AMOUNT OF STORAGE, AND STAGING SPACE WILL BE MADE AVAILABLE.
- 5. IT IS THE RESPONSIBILITY OF THE CONTRACTOR TO PROTECT BUILDING OCCUPANTS AND PASSERS-BY FROM FALLING DEBRIS OR EQUIPMENT AT ALL TIMES DURING THE COURSE OF CONSTRUCTION. DO NOT THROW MATERIALS FROM THE ROOF.
- 6. CONTRACTOR SHALL BE RESPONSIBLE FOR PROTECTING BUILDING SURFACES, FINISHES, AND SYSTEMS FROM DAMAGE, DISCOLORATION, ETC. DURING THE COURSE OF ALL CONSTRUCTION ACTIVITIES.
- 7. PERSONAL FALL PROTECTION DEVICES ARE NOT, NOR WILL BE, PROVIDED BY THE OWNER ON ANY ROOF AREA DESIGNATED TO RECEIVE WORK. PERSONAL FALL PROTECTION IS THE RESPONSIBILITY OF THE CONTRACTOR.
- 3. ALL CONSTRUCTION SHALL CONFORM TO THE 2019 OREGON STRUCTURAL SPECIALTY CODE (2019 OSSC), AND ALL LOCAL GOVERNING BUILDING CODES AND ORDINANCES.

- 9. IT SHALL BE THE RESPONSIBILITY OF THE CONTRACTOR TO LOCATE ALL EXISTING UTILITIES WHETHER SHOWN HEREIN OR NOT, AND TO PROTECT UTILITIES FROM DAMAGE. THE CONTRACTOR SHALL BEAR ALL EXPENSES OF REPAIR OR REPLACEMENT OF UTILITIES OR OTHER PROPERTY DAMAGED BY OPERATIONS IN CONJUNCTION WITH THE EXECUTION OF THE
- 10. ROOF ACCESS BY MEANS OF EXTERNAL LIFT OF OTHER DEVICE. NO INTERIOR ACCESS IS PRESENT.
- 11. ALL ITEMS TRANSPORTED TO ROOF SHALL BE TRANSPORTED USING APPROVED AND SAFE METHODS OF LOADING.
- 12. SCOPE OF WORK CONSISTS OF THIS DRAWINGS SET AND THE ASSOCIATED PROJECT MANUAL.
- 13. EXISTING ROOF SYSTEMS HAVE BEEN TESTED FOR ASBESTOS CONTAINING MATERIALS (ACM). NO ASBESTOS WAS IDENTIFIED WITHIN ROOFING SAMPLES TAKEN FROM ROOF AREAS TO BE REPLACED AS PART OF THIS SCOPE OF WORK. ACM WAS, HOWEVER, IDENTIFIED WITHIN THE ROOF ASSEMBLY AT AREA I WHICH IS SCHEDULED TO RECEIVE A ROOF RE-COVER. WHEN PERFORMING MOISTURE MITIGATION AND DEMOLITION ACTIVITIES AT AREA I, ALL MATERIALS TO BE DEMOLISHED ARE TO BE HANDLED APPROPRIATELY WITH REGARD TO OROSHA, DEQ, AND THE OWNER.
- 14. WHILE NOT TESTED FOR ASBESTOS CONTAINING MATERIALS (ACM), ALL REPAIR MASTICS/SEALANTS ARE ASSUMED TO BE ACM. ADDITIONAL TESTING MAY BE REQUIRED BY THE CONTRACTOR TO ENSURE ALL MATERIALS TO BE DEMOLISHED ARE HANDLED APPROPRIATELY WITH REGARD TO OROSHA, DEQ AND THE OWNER.

- 5. THIS PROJECT INCLUDES THE FOLLOWING BASE BID. BID WORK DOES NOT INCLUDE ANY INCREASE IN AREA OR CHANGES IN
- OF EXISTING BUILT-UP ROOF MEMBRANE ASSEMBLIES AT ROOF AREAS A, B, C, F & H DOWN TO THE DECK. REMOVAL OF EXISTING SHEET METAL FLASHINGS, CURBED EDGES, CLERESTORY WINDOWS AND ABANDONED EQUIPMENT. INSTALLATION OF DECK INFILL AT ABANDONED EQUIPMENT. INSTALLATION OF WALL FRAMING AT ABANDONED CLERESTORY OPENINGS. INSTALLATION OF BUILT-UP ROOF MEMBRANE ASSEMBLY, TAPERED INSULATION ASSEMBLIES, FLASHINGS, WALL PANELS, GUTTERS, AND COPING. INSTALLATION OF A ROOF OVERLAY ASSEMBLY AT AREA I. INSTALLATION OF PERMANENT FALL PROTECTION ANCHORS. INSTALLATION OF REPAIRS AT AREAS D, E, G, J, K & L.

## BUILDING DATA

MAXIMUM TOP OF ROOF DECK HEIGHT (OF AREAS TO BE RE-ROOFED):	28-FEET
EXPOSURE:	В
RISK CATEGORY:	III
BASIC WIND SPEED:	105 MPI

## DRAWING SCHEDULE

GI-1 GENERAL INFORMATION
GI-2 SYSTEM ASSEMBLIES

R100 OVERALL ROOF PLAN

R101 SECTOR A - DEMOLITION ROOF PLAN R102 SECTOR B - DEMOLITION ROOF PLAN R103 SECTOR C - DEMOLITION ROOF PLAN R104 SECTOR D - DEMOLITION ROOF PLAN

R105 SECTOR A - ROOF PLAN

R106 SECTOR B - ROOF PLAN R107 SECTOR C - ROOF PLAN R108 SECTOR D - ROOF PLAN

R200 DETAILS - AREAS A, B & C R201 DETAILS - AREAS A, B & C

R202 DETAILS - AREAS A, B & C

R203 DETAILS - AREA F R204 DETAILS - AREA F

R205 DETAILS - AREA F

R206 DETAILS - AREA H R207 DETAILS - AREA H

R208 DETAILS - AREA H

R209 DETAILS - AREA I R210 DETAILS - AREA I


S100 GENERAL STRUCTURAL NOTES
AND FALL PROTECTION STRUCTURAL

NOTES


S101 ROOF PLAN WIND LOAD DIAGRAM

S102 STRUCTURAL DETAILS

## DRAWING SYMBOLS

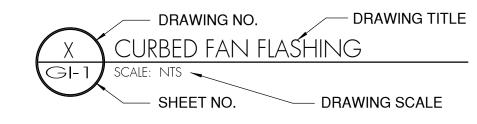

DETAIL REFERENCE ON PLAN DRAWINGS - SIM. INDICATES SIMILAR CONSTRUCTION AS SHOWN ON DETAIL NOTED.

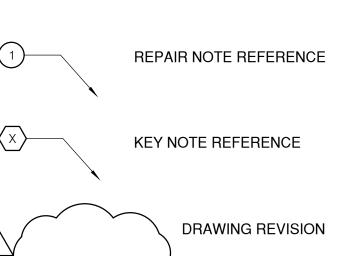

 Drawn:
 TVVB

 Check:
 BAR

 File:
 GI-Gen\_Info

 Job:
 R3282.07

GENERAL INFORMATION

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NOVEMBER 10, 202

SHEET NUMBER:

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## PROJECT TEAM =

## OWNER

Eugene School District 4J 200 N. Monroe St. Eugene, OR 97402 tel: (541) 790-7700

fax: (541) 790-7711

Contact: Kirk Gebb, Capital Improvement Program

## ROOF CONSULTANT

Professional Roof Consultants, Inc. 1108 SE Grand Ave., Suite 300 Portland, Oregon 97214 tel: (503) 280-8759

fax: (503) 280-8759

Contact: Thomas Bertrand, RRO, AHERA


## STRUCTURAL CONSULTANT

TM Rippey Consulting Engineers 7650 SW Beveland St. Suite 100 Tigard, Oregon 97223 tel: (503) 443-3900


fax: (503) 443-3900

Contact: Ralph Turnbaugh, P.E.


## EXISTING ROOF SYSTEMS

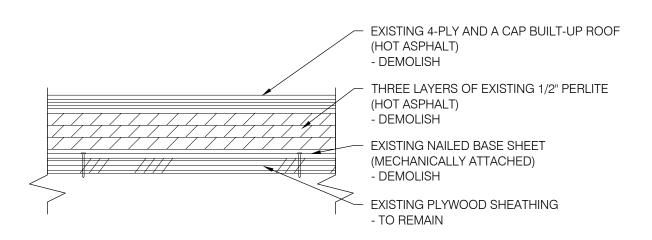



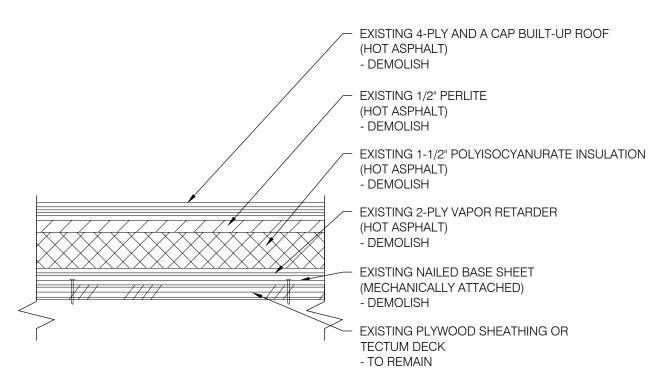





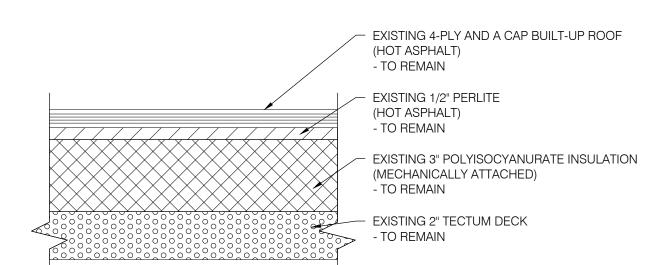





## NEW ROOF SYSTEMS

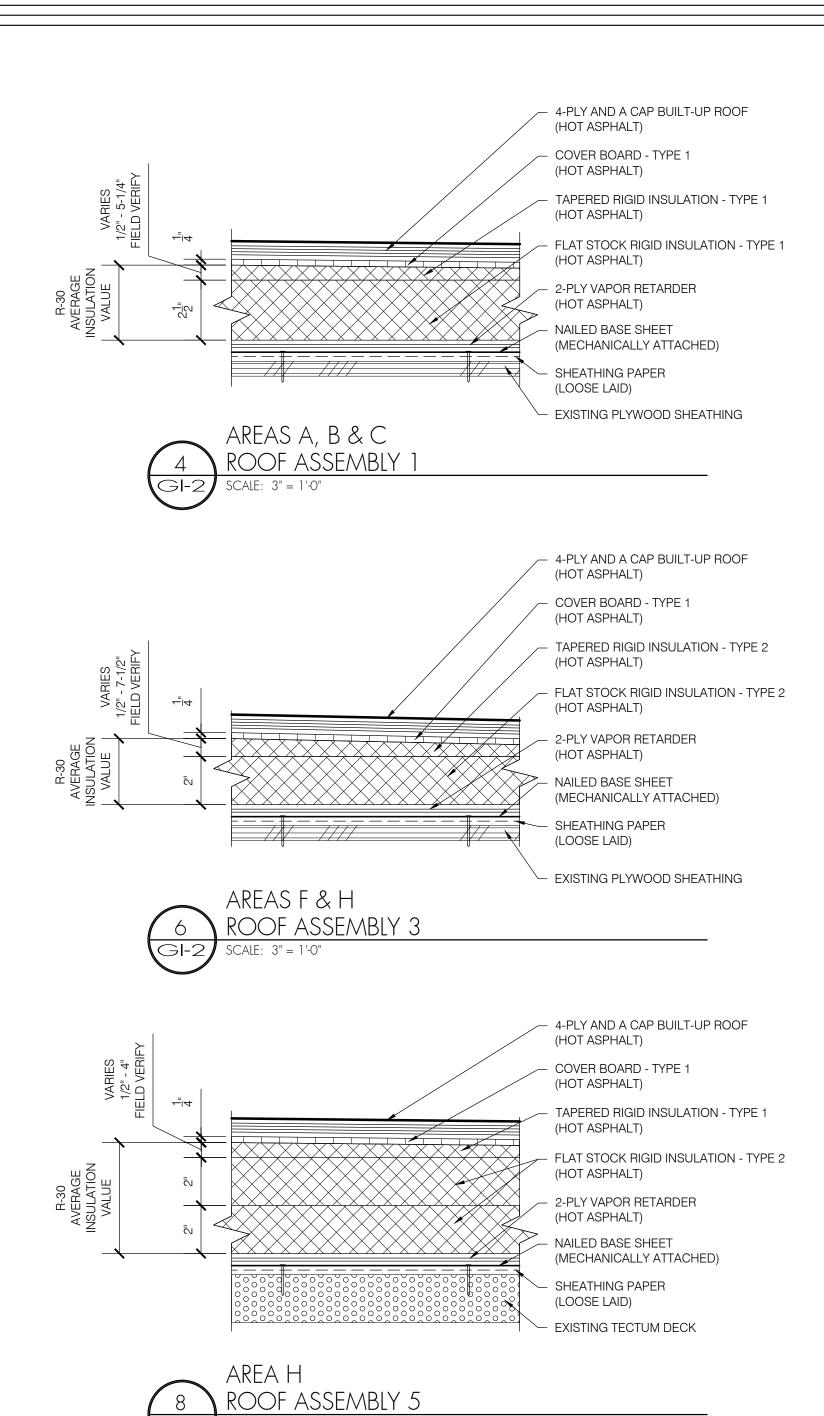

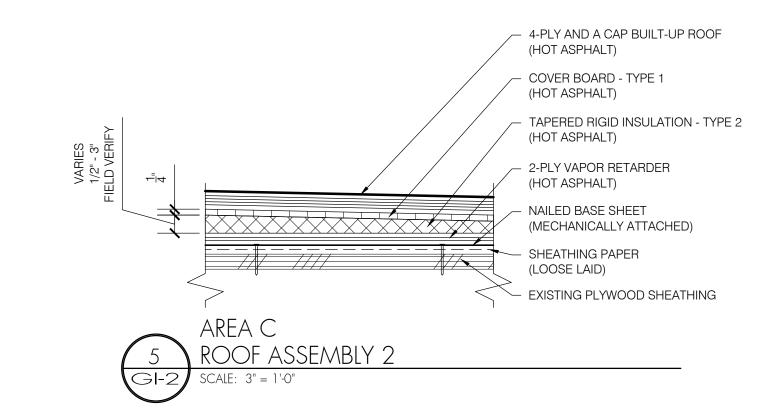

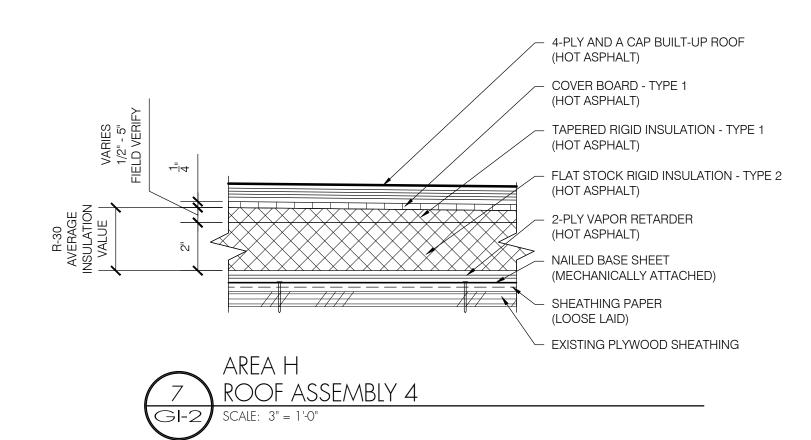

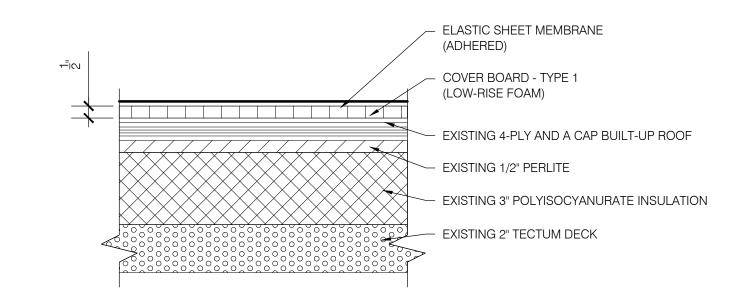





# SPENCER BUTTE MIDDLE SCHOOL


SHEET TITLE:		
SYSTEM ASSEME	BLIES	

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Date:	NOVEMBER 10, 2021
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	R3282 07





SHEET TITLE: OVERALL ROOF PLAN
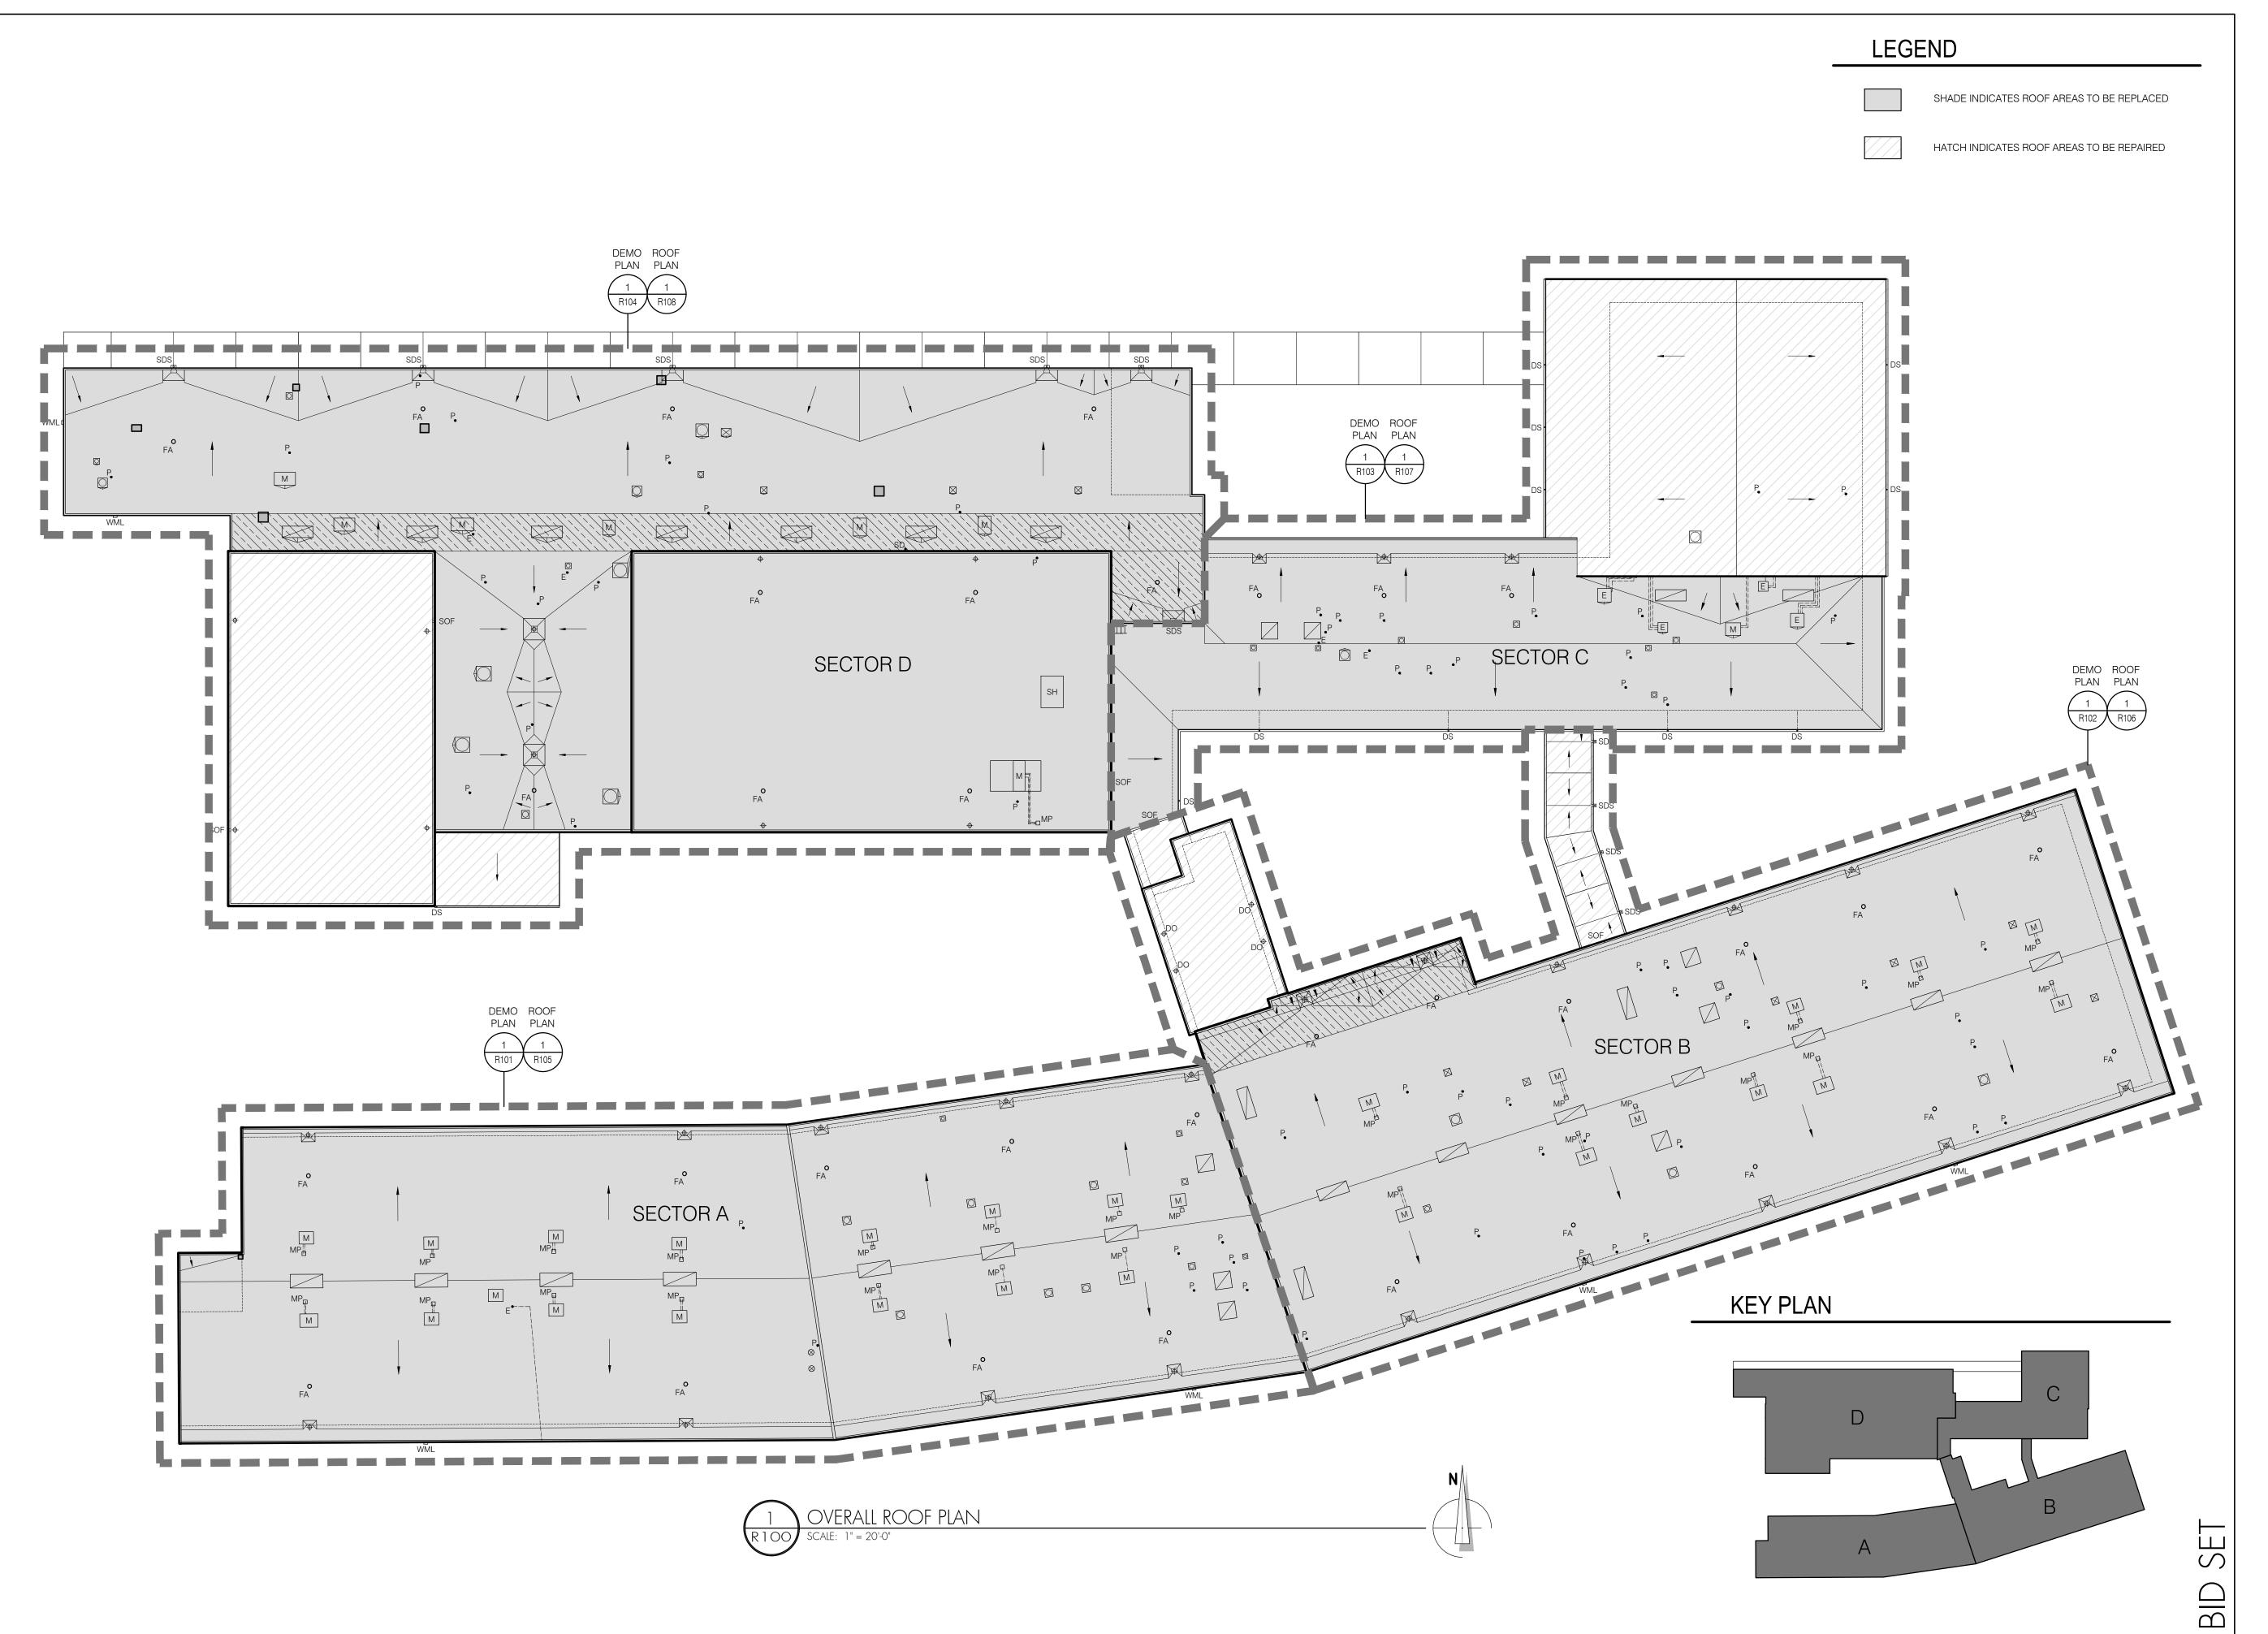
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R100-Roof\_Plans R3282.07

DEMOLISH EXISTING 4-PLY AND A CAP BUILT-UP ROOF DOWN TO THE EXISTING DECK. - REFERENCE DETAIL 1/GI-2 FOR EXISTING ROOF ASSEMBLY.

DEMOLISH ABANDONED PIPE/CONDUIT PENETRATION. DEMOLISH CONDUIT/PIPE BACK A MINIMUM OF 6" WITHIN THE INTERIOR OF THE BUILDING AND TERMINATE ACCORDING TO THE APPLICABLE MECHANICAL/PLUMBING CODE. COVER ANY HOLE IN THE PLYWOOD DECK SHEATHING 3" OR SMALLER IN DIAMETER WITH A 24 GAUGE STAINLESS STEEL PLATE - PERMANENTLY ANCHOR THE PLATE TO THE DECK.

DEMOLISH EXISTING ROOF DRAIN AND ASSOCIATED DRAIN LINE BACK TO THE STORMWATER OUTLET AT BASE OF WALL.

DEMOLISH EXISTING ROOF DRAIN AND ASSOCIATED DRAIN LINE BACK TO THE STORMWATER OUTLET AT BASE OF WALL. CAP OUTLET IN ACCORDANCE WITH THE PLUMBING CODE. COVER HOLE IN THE PLYWOOD DECK SHEATHING IN ACCORDANCE WITH THE STRUCTURAL DRAWINGS.

DEMOLISH EXISTING ROOF DRAIN. MAINTAIN EXISTING DRAIN LINE FOR ATTACHMENT OF NEW ROOF DRAIN.

DEMOLISH EXISTING CURBED EDGE BLOCKING AND SHEET METAL FLASHING ASSEMBLY WHERE INDICATED.

EXISTING CURBED EDGE BLOCKING TO REMAIN.

DEMOLISH EXISTING PARAPET DOWN TO THE EXISTING DECK.

LEGEND

(SYMBOLS APPLY TO SHADED AREA ONLY)

SHADED AREA INDICATES EXTENT OF ROOF REPLACEMENT SCOPE OF WORK

EXISTING ROOF DRAIN - REFERENCE ASSOCIATED KEY NOTES

EXISTING WALL MOUNTED LIGHT - TO REMAIN

EXISTING PLUMBING VENT PIPE - MODIFY AS REQUIRED PER SHEET R105

EXISTING ELECTRICAL PENETRATION - MODIFY AS REQUIRED PER SHEET R105


- REFERENCE ASSOCIATED KEY NOTE EXISTING CURBED MECHANICAL EQUIPMENT

EXISTING CURBED FAN - MODIFY AS REQUIRED PER SHEET R105


EXISTING FLANGED VENT





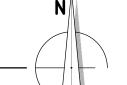

## KEY PLAN

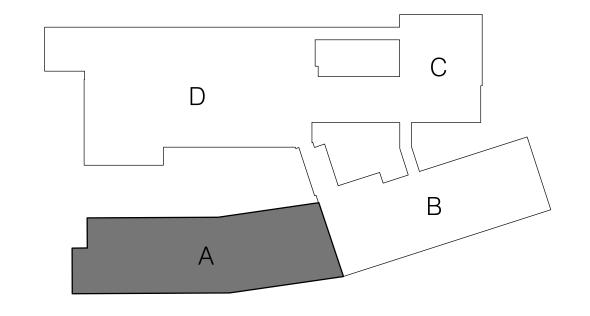

PORTLAND, OREGON 97214

PH. 503 280 8759 FAX: 503 280 8866

- TO REMAIN EXISTING CURBED SKYLIGHT

ABANDONED PIPE/CONDUIT PENETRATION

- MODIFY AS REQUIRED PER SHEET R105

- MODIFY AS REQUIRED PER SHEET R105

EXISTING OVER-ROOF ELECTRICAL CONDUITS - MODIFY AS REQUIRED PER SHEET R105

SHEET TITLE:	
SECTOR A - DEMOLITION ROOF PLAN	

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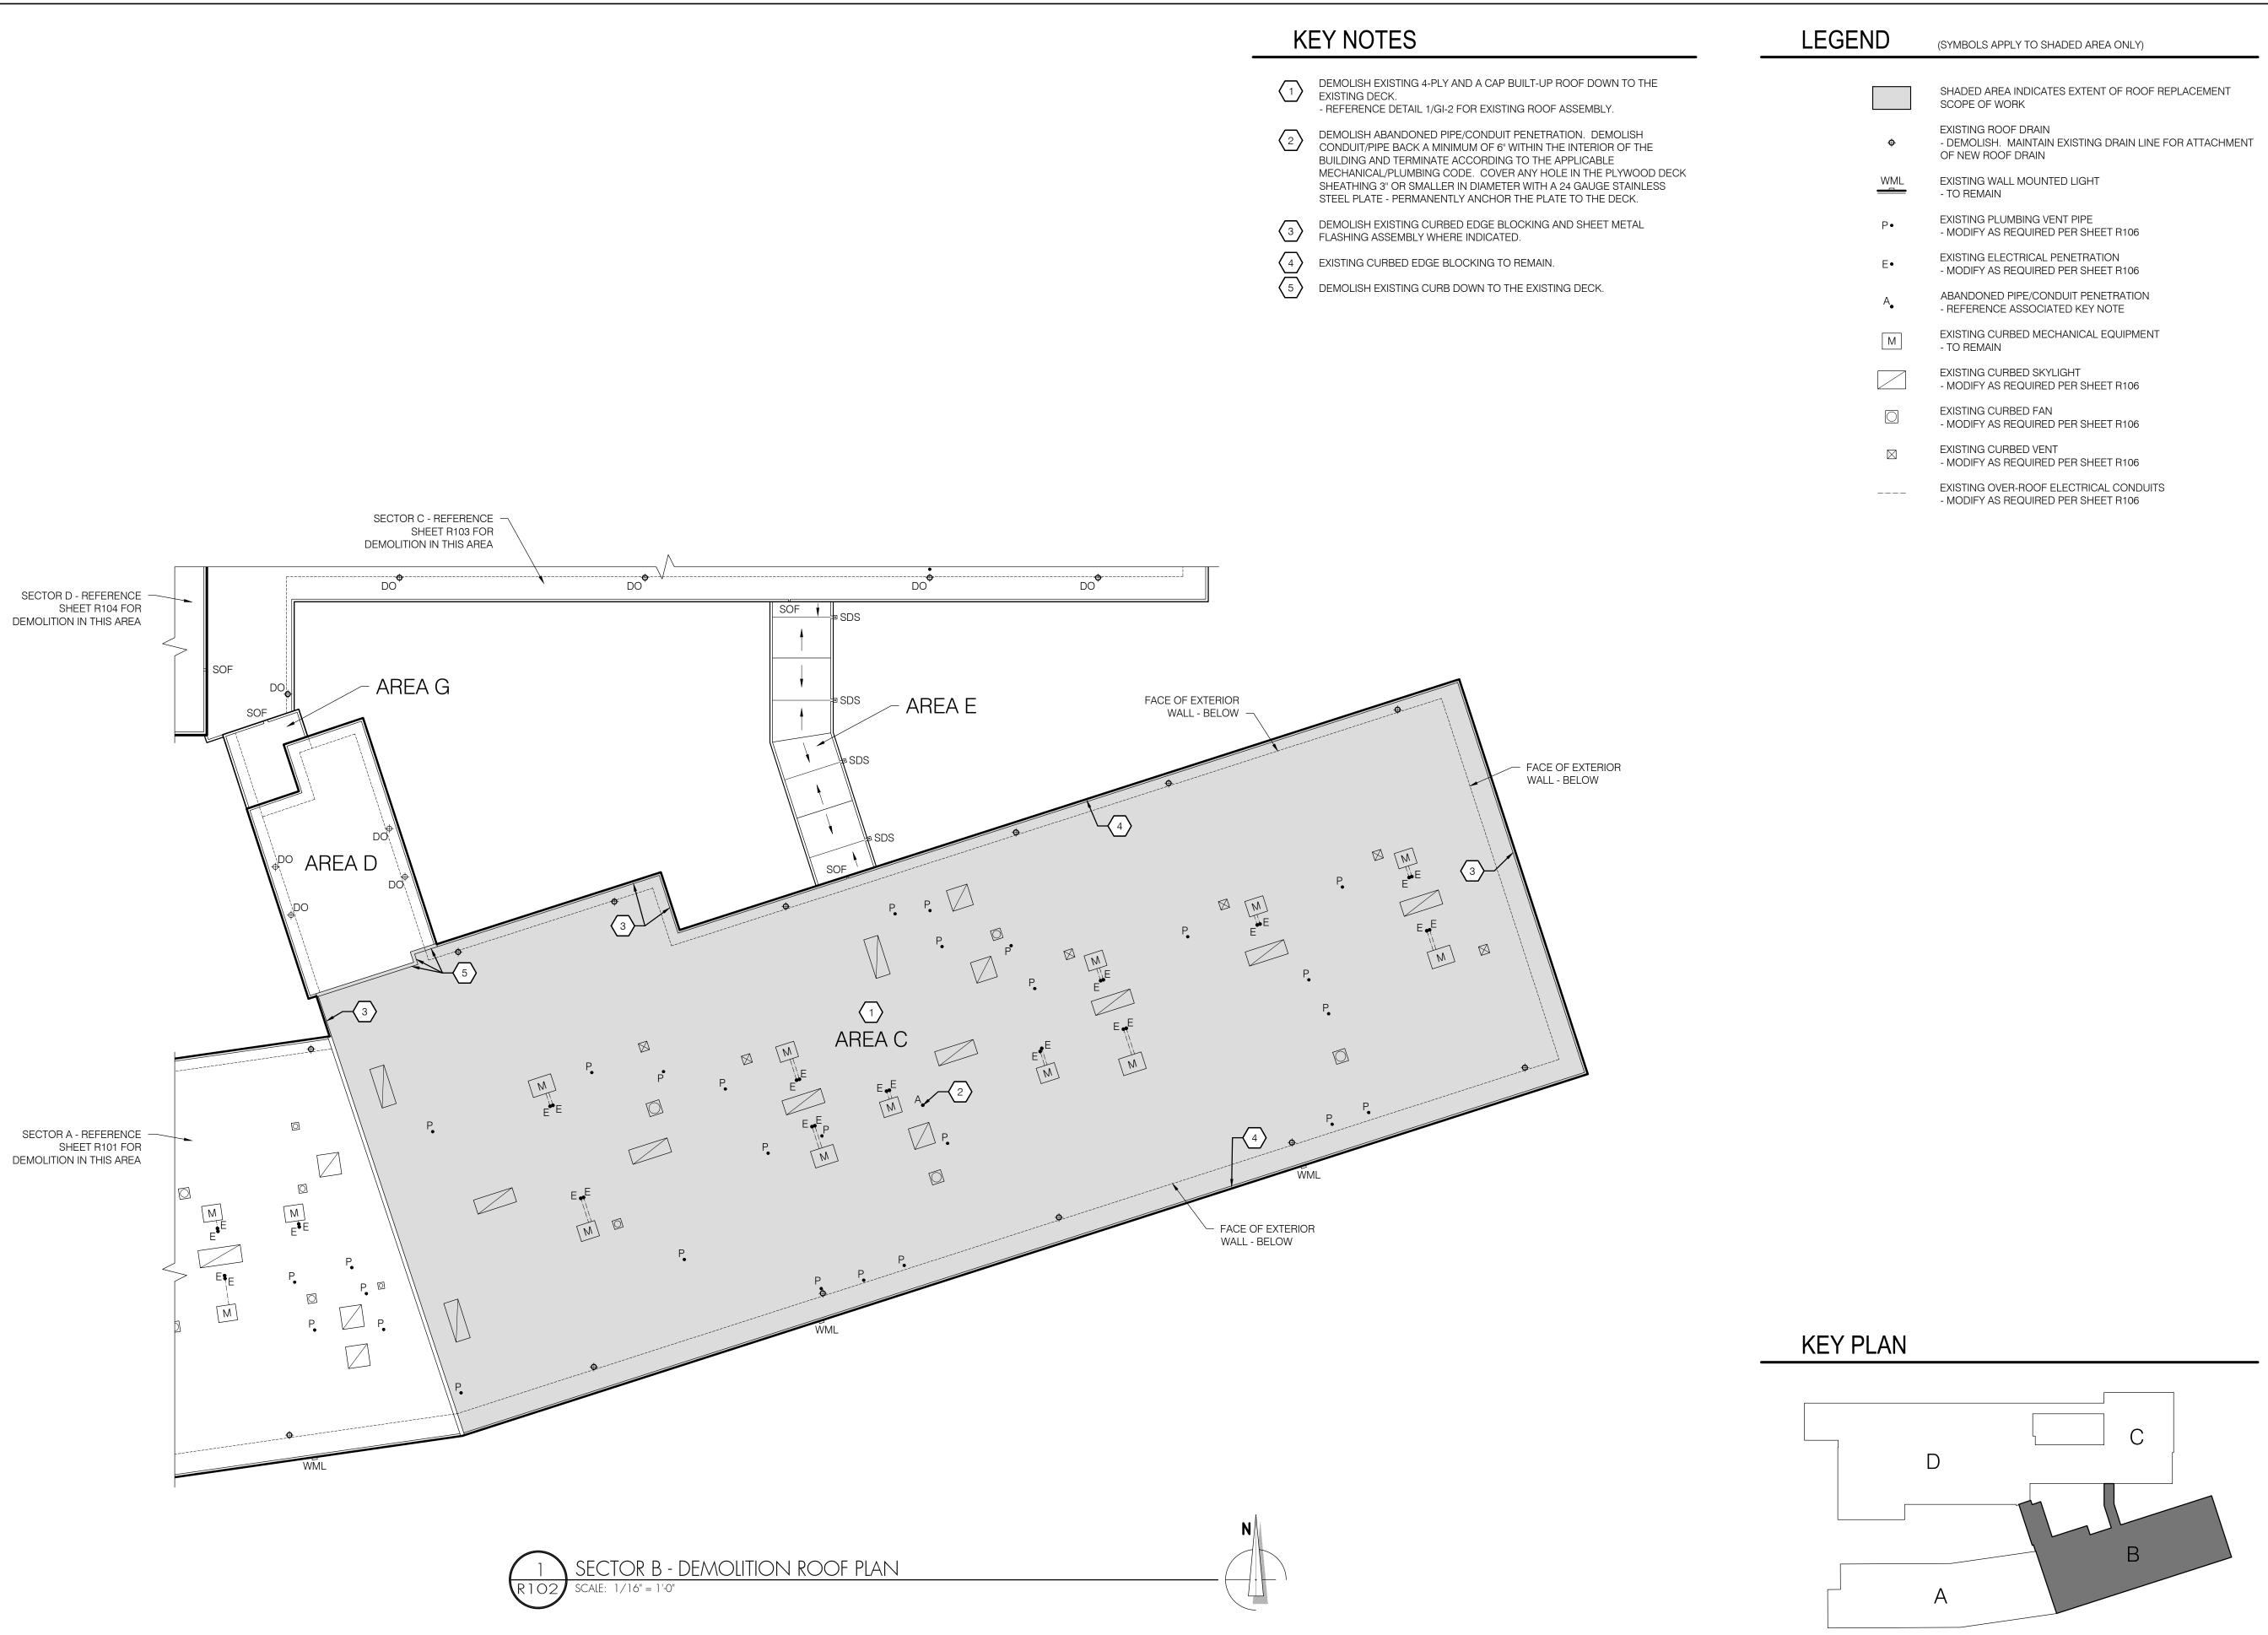
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2-11			HIS DRAWING			


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SHEET TITLE: SECTOR B - DEMOLITION ROOF PLAN

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## **KEY NOTES**

- DEMOLISH EXISTING 4-PLY AND A CAP BUILT-UP ROOF DOWN TO THE EXISTING DECK. - REFERENCE DETAIL 2/GI-2 FOR EXISTING ROOF ASSEMBLY.
  - DEMOLISH EXISTING CLERESTORY WINDOWS AND ASSOCIATED FLASHING ASSEMBLIES.
  - (3) DETACH EXISTING WALL-MOUNTED LADDER
  - DEMOLISH EXISTING DROP SCUPPER. MAINTAIN EXISTING DRAIN LINE FOR ATTACHMENT OF NEW ROOF DRAIN.
  - DEMOLISH EXISTING DROP SCUPPER. MODIFY ASSOCIATED DOWNSPOUT PER SHEET R107. COVER ANY HOLE IN THE PLYWOOD DECK SHEATHING 3" OR SMALLER IN DIAMETER WITH A 24 GAUGE STAINLESS STEEL PLATE -PERMANENTLY ANCHOR THE PLATE TO THE DECK.
- 6 DEMOLISH EXISTING SCUPPER OVERFLOW.
- DEMOLISH EXISTING CURBED EDGE BLOCKING AND SHEET METAL FLASHING ASSEMBLY WHERE INDICATED.
- (8) EXISTING CURBED EDGE BLOCKING TO REMAIN.
- DEMOLISH EXISTING FACE MOUNTED WALL COUNTER FLASHING
- ASSEMBLIES.

## LEGEND

(SYMBOLS APPLY TO SHADED AREA ONLY)
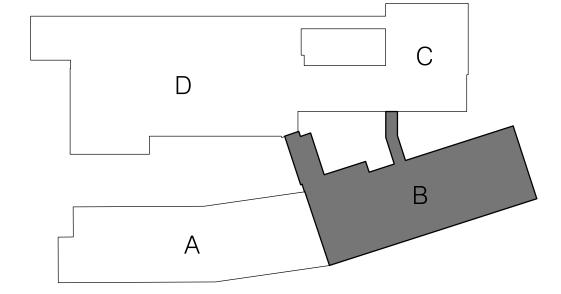
## SHADED AREA INDICATES EXTENT OF ROOF REPLACEMENT SCOPE OF WORK

EXISTING DROP SCUPPER DO 💠 - REFERENCE ASSOCIATED KEY NOTES

> EXISTING SCUPPER OVERFLOW - TO REMAIN EXCEPT WHERE NOTED OTHERWISE

EXISTING ELECTRICAL PENETRATION

- MODIFY AS REQUIRED PER SHEET R107

EXISTING PLUMBING VENT PIPE - MODIFY AS REQUIRED PER SHEET R107

EXISTING CURBED MECHANICAL EQUIPMENT - MODIFY AS REQUIRED PER SHEET R107


EXISTING CAPPED EQUIPMENT CURB - MODIFY AS REQUIRED PER SHEET R107

EXISTING CURBED SKYLIGHT - MODIFY AS REQUIRED PER SHEET R107


EXISTING CURBED FAN - MODIFY AS REQUIRED PER SHEET R107

EXISTING WALL-MOUNTED LADDER - REFERENCE ASSOCIATED KEY NOTE

EXISTING OVER-ROOF ELECTRICAL CONDUITS - MODIFY AS REQUIRED PER SHEET R107

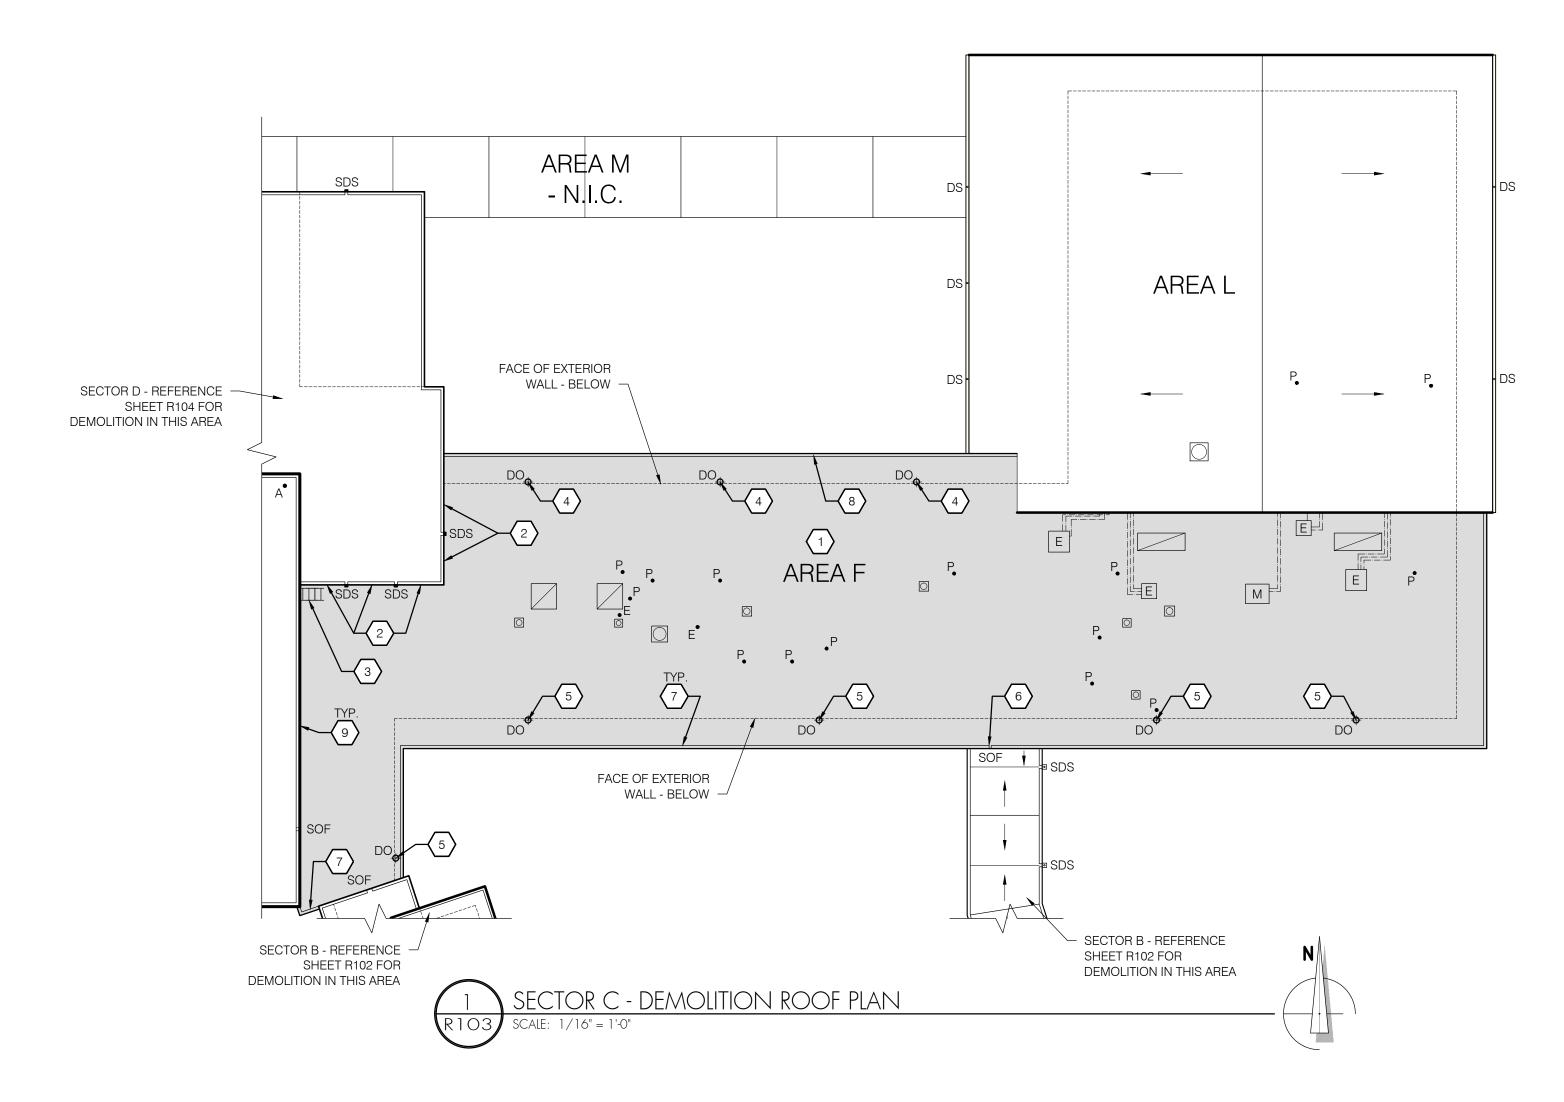

## KEY PLAN

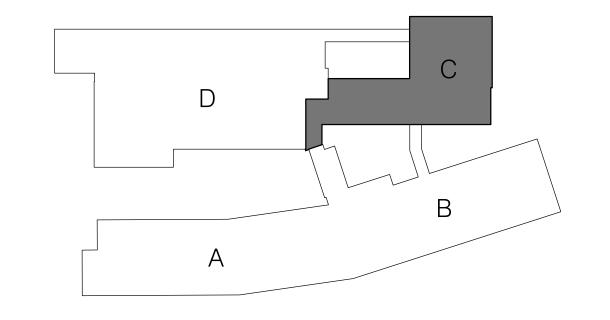

## PORTLAND, OREGON 97214 PH. 503 280 8759 FAX: 503 280 8866

## SHEET TITLE:

SECTOR C - DEMOLITION ROOF PLAN

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EXISTING DECK.

EXISTING DECK.

DEMOLISH EXISTING 4-PLY AND A CAP BUILT-UP ROOF DOWN TO THE

DEMOLISH EXISTING 4-PLY AND A CAP BUILT-UP ROOF DOWN TO THE

WITHIN THE EXISTING ROOF ASSEMBLY AT THIS AREA. FOLLOW ALL REQUIRED GUIDELINES FOR CONTAINMENT/ABATEMENT DURING

DEMOLISH ABANDONED PIPE/CONDUIT PENETRATION. DEMOLISH

STEEL PLATE - PERMANENTLY ANCHOR THE PLATE TO THE DECK.

BUILDING AND TERMINATE ACCORDING TO THE APPLICABLE

CONDUIT/PIPE BACK A MINIMUM OF 6" WITHIN THE INTERIOR OF THE

- NOTE: ASBESTOS CONTAINING MATERIALS (ACM) HAVE BEEN IDENTIFIED

MECHANICAL/PLUMBING CODE. COVER ANY HOLE IN THE PLYWOOD DECK

SHEATHING 3" OR SMALLER IN DIAMETER WITH A 24 GAUGE STAINLESS

DEMOLISH EXISTING CURB AND ANY ASSOCIATED ABANDONED CAP, FAN,

VENT, AND/OR OVER-DECK DUCT ASSEMBLY. DEMOLISH DUCTS, PIPES AND ASSOCIATED CONDUITS BACK A MINIMUM OF 6" WITHIN THE INTERIOR

OF THE BUILDING AND TERMINATE ACCORDING TO THE APPLICABLE

MECHANICAL/PLUMBING CODE. INFILL DECK PRIOR TO MEMBRANE

DEMOLISH EXISTING CURBED EDGE BLOCKING AND SHEET METAL

EXISTING EQUIPMENT PAD - DEMOLISH ALL ROOFING WITHIN 24" OF THE PAD, EVACUATE ANY TRAPPED WATER WITHIN THE CURB AND ALLOW

EXTENDS BEYOND THE 24" ZONE, CONTINUE DEMOLITION UNTIL ALL WET

DEMOLISH EXISTING ROOFING AS REQUESTED FOR INSTALLATION OF NEW

FRAMING TO DRY PRIOR TO NEW ROOF INSTALLATION. IF MOISTURE

DEMOLISH EXISTING FACE MOUNTED WALL COUNTER FLASHING

- REFERENCE DETAIL 2/GI-2 FOR EXISTING ROOF ASSEMBLY.

- REFERENCE DETAIL 3/GI-2 FOR EXISTING ROOF ASSEMBLY.

DEMOLITION ACTIVITIES ON THIS ROOF.

ASSEMBLY INSTALLATION.

ASSEMBLIES.

FLASHING ASSEMBLY WHERE INDICATED.

MATERIALS HAVE BEEN DEMOLISHED.

FALL PROTECTION ANCHORS.

- REFERENCE SHEET R108.

SHADED AREA INDICATES EXTENT OF ROOF REPLACEMENT

EXISTING SCUPPER & DOWNSPOUT - DEMOLISH

EXISTING ROOF DRAIN - TO REMAIN

EXISTING SCUPPER OVERFLOW SOF - TO REMAIN

EXISTING WALL MOUNTED LIGHT WML - TO REMAIN

- MODIFY AS REQUIRED PER SHEET R108 EXISTING PLUMBING VENT PIPE

EXISTING ELECTRICAL PENETRATION

- MODIFY AS REQUIRED PER SHEET R108 MULTIPIPE (LINE SET) PENETRATION

- MODIFY AS REQUIRED PER SHEET R108

ABANDONED PIPE/CONDUIT PENETRATION - REFERENCE ASSOCIATED KEY NOTE

ABANDONED CURB - REFERENCE ASSOCIATE KEY NOTE

EXISTING CURBED MECHANICAL EQUIPMENT - MODIFY AS REQUIRED PER SHEET R108

EXISTING CURBED SKYLIGHT

- MODIFY AS REQUIRED PER SHEET R108


EXISTING CURBED FAN - MODIFY AS REQUIRED PER SHEET R108

**EXISTING CURBED VENT** - MODIFY AS REQUIRED PER SHEET R108

EXISTING CURBED SMOKE HATCH - MODIFY AS REQUIRED PER SHEET R108


EXISTING OVER-ROOF ELECTRICAL CONDUITS - MODIFY AS REQUIRED PER SHEET R108

ARROW INDICATES DIRECTION OF EXISTING STRUCTURAL SLOPE

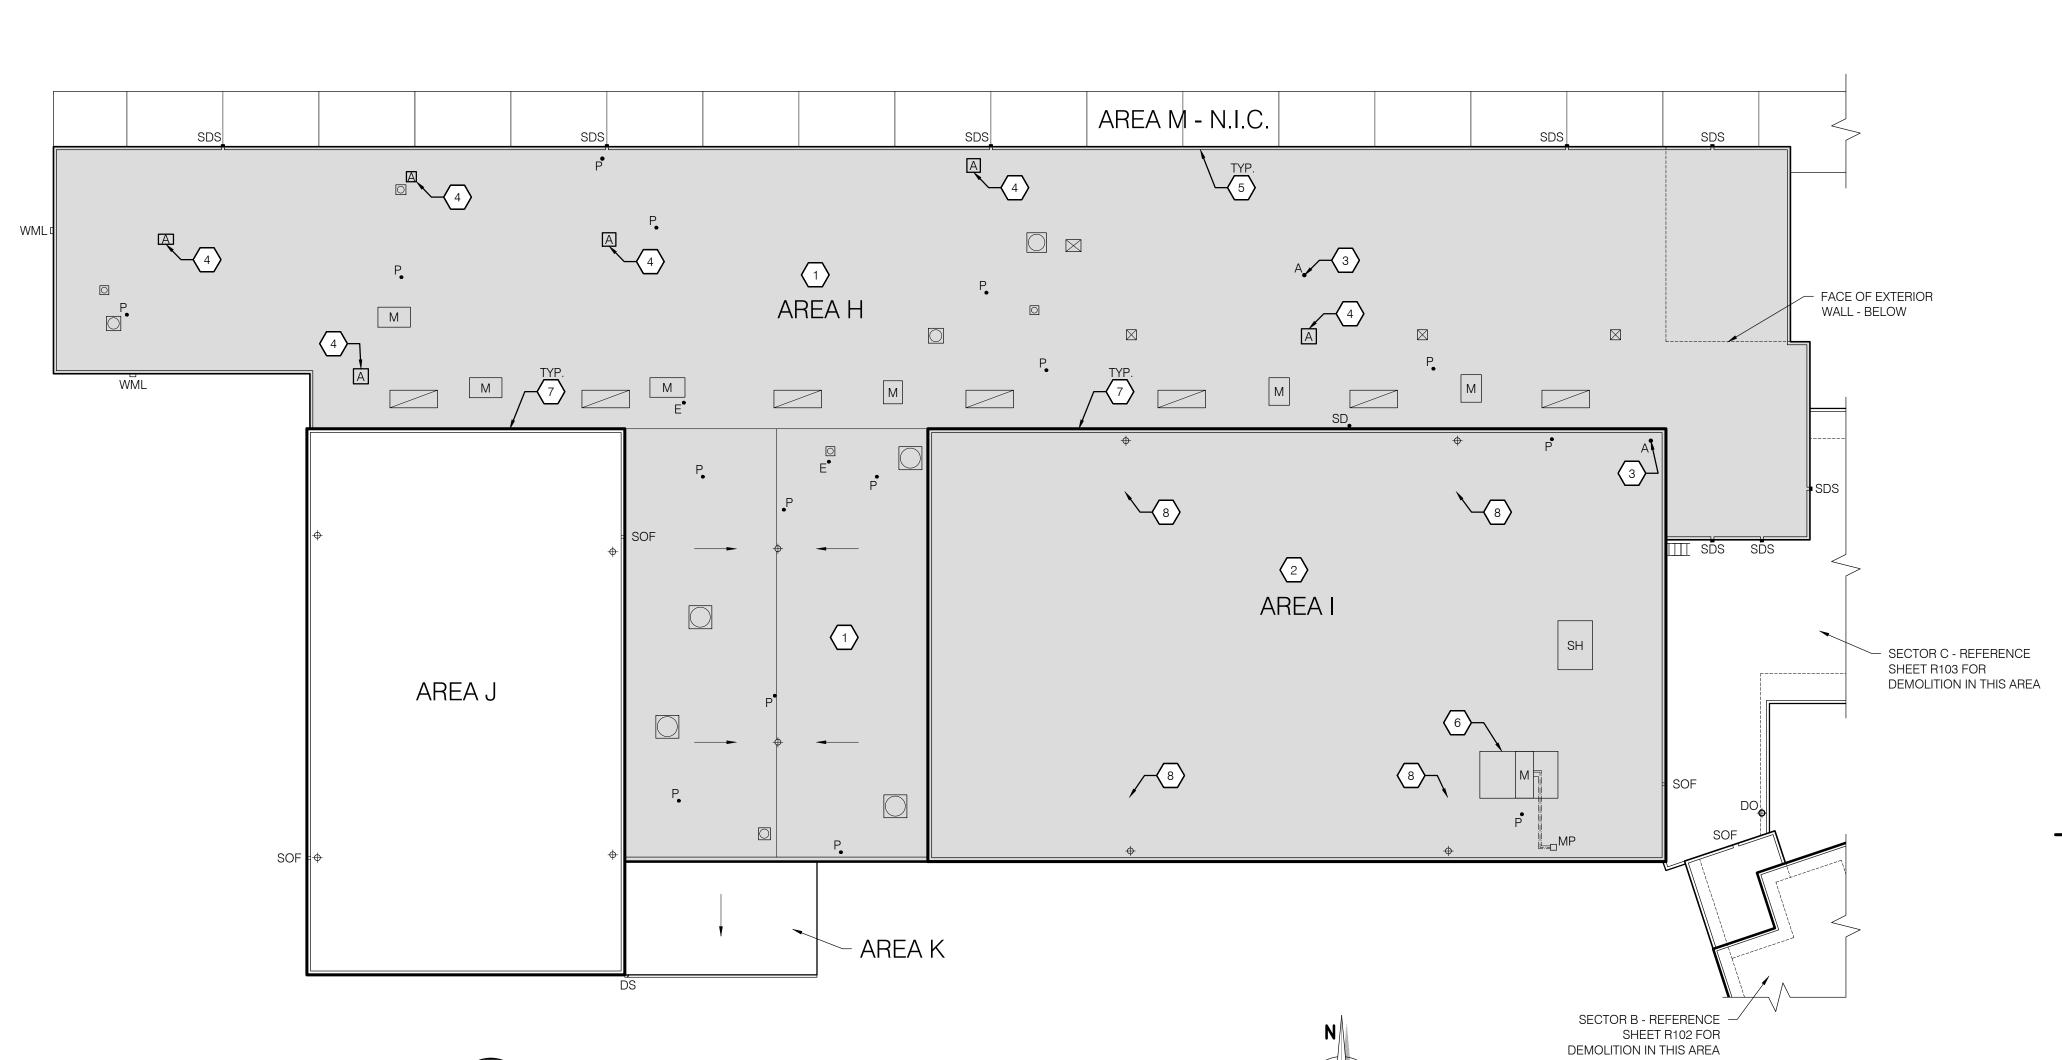

ECTOR D - DEMOLITION ROOF PLAN



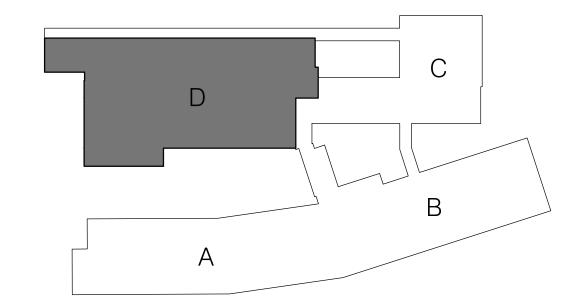



SHEET TITLE:	
SECTOR D - DEMOLITION ROOF PLAN	_
	_

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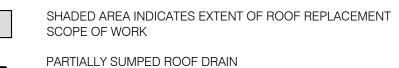
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## **KEY NOTES**

- INSTALL 4-PLY AND A CAP BUILT UP ROOF ASSEMBLY (ROOF ASSEMBLY 1).
   REFERENCE DETAIL 4/GI-2.
- 2 INSTALL DECK INFILL PRIOR TO ROOF MEMBRANE ASSEMBLY.
   REFERENCE STRUCTURAL DRAWINGS.
- 3 INSTALL ROOF DRAIN AND ASSOCIATED 4" DIAMETER DRAIN LINE TIE-INTO EXISTING BASE-OF-WALL STORM DRAINAGE HOOKUP.
- INSTALL INSULATION CRICKET WITH 1/2" PANEL SLOPE UTILIZING A 3:1 LENGTH/WIDTH RATIO EXCEPT WHERE NOTED OTHERWISE.

## LEGEND (SYMBOL

(SYMBOLS APPLY TO SHADED AREA ONLY)



- TIE INTO EXISTING 3" (FIELD VERIFY) DIAMETER DRAIN LINE/DOWNSPOUT ASSEMBLY EXCEPT WHERE NOTED OTHERWISE

WALL MOUNTED LIGHT

EXISTING PLUMBING VENT PIPE
- RAISE AS REQUIRED TO MEET MINIMUM FLASHING HEIGHT
REQUIREMENT

FALL PROTECTION ANCHOR
- REFERENCE STRUCTURAL

MULTI-PENETRATION PITCH PAN
- DISCONNECT ELECTRICAL LINES AS REQUIRED TO RAISE
CONDUITS TO MEET MINIMUM HEIGHT REQUIREMENT ABOVE NEW

EXISTING CURBED MECHANICAL EQUIPMENT

ROOF ASSEMBLY. RECONNECT SERVICES.

EXISTING CURBED SKYLIGHT - RAISE AS REQUIRED TO MEET MINIMUM MEMBRANE FLASHING HEIGHT REQUIREMENT

EXISTING CURBED FAN
- RAISE AS REQUIRED TO MEET MINIMUM MEMBRANE FLASHING
HEIGHT REQUIREMENT


EXISTING CURBED VENT
- RAISE AS REQUIRED TO MEET MINIMUM MEMBRANE FLASHING
HEIGHT REQUIREMENT

EXISTING FLANGED VENT
- RAISE AS REQUIRED TO MEET MINIMUM MEMBRANE FLASHING
HEIGHT REQUIREMENT


EXISTING OVER-ROOF ELECTRICAL CONDUITS
- ADJUST TO CONFORM TO NEW TAPERED ROOF ASSEMBLY

ARROW INDICATES DIRECTION AND FINISHED SLOPE OF TAPERED INSULATION ASSEMBLY

- AT SOLID HATCHED CRICKETS, ARROW INDICATES DIRECTION OF FINISHED SLOPE ONLY

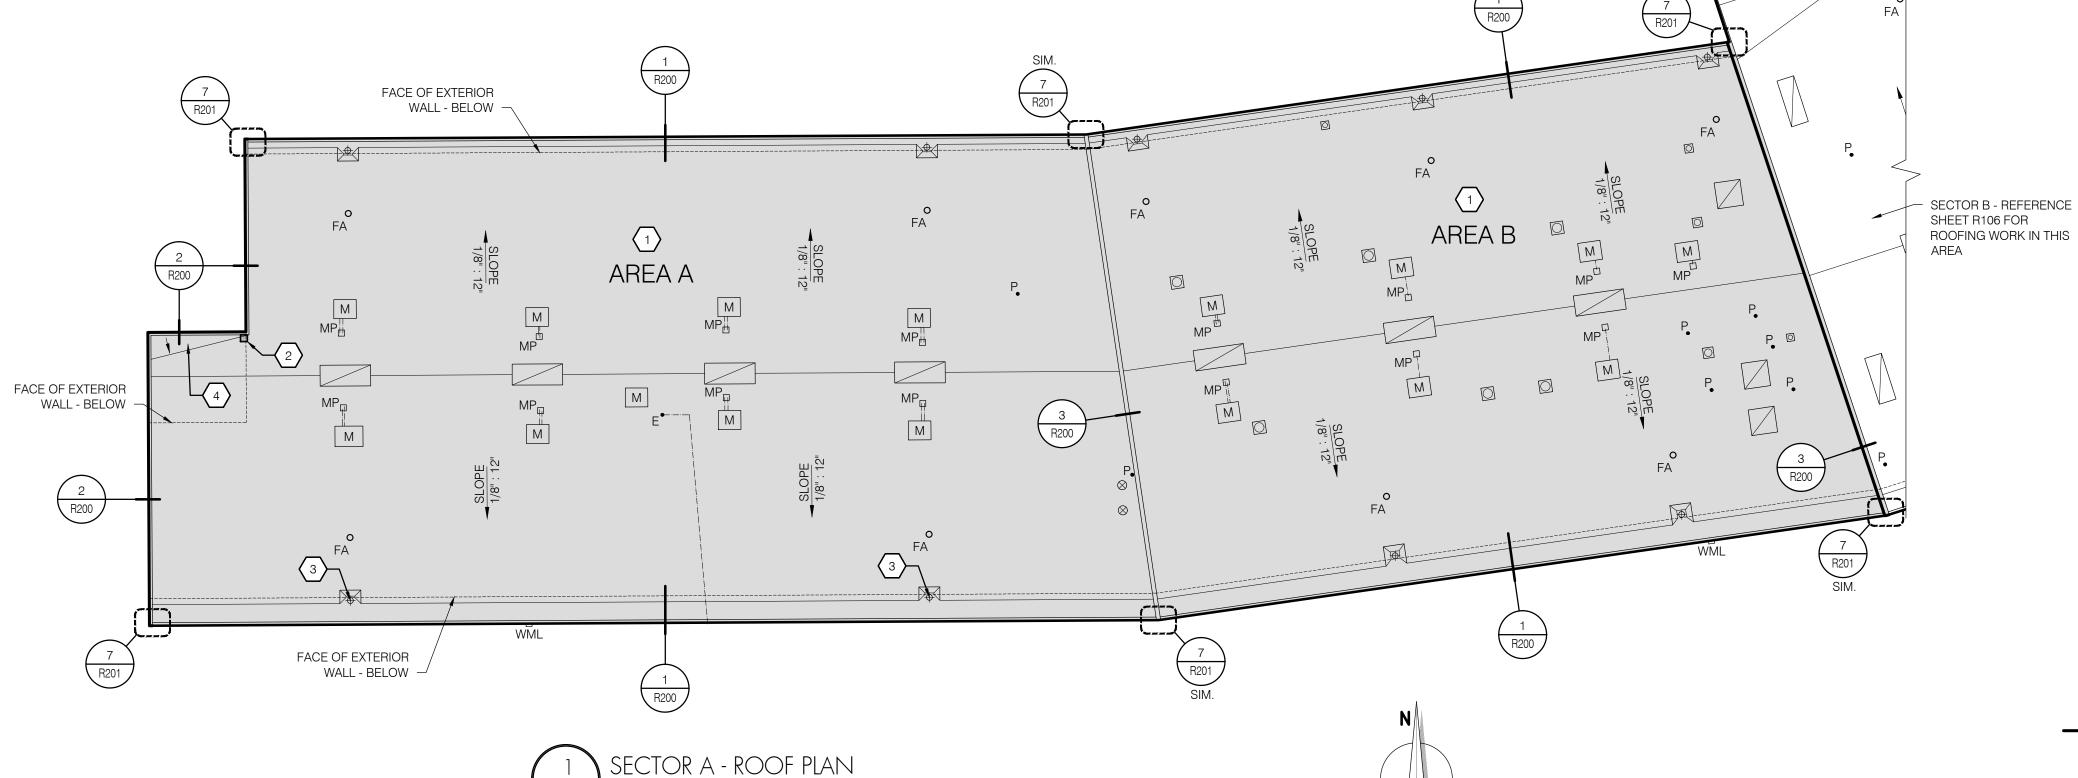

## **KEY PLAN**

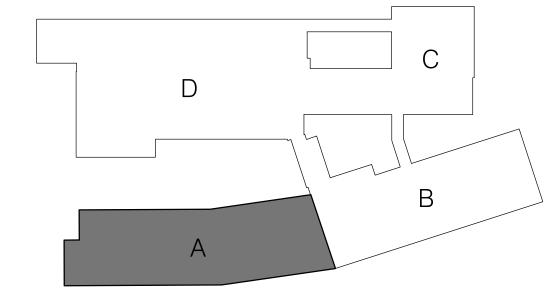

# PENCER BUTTE MIDDLE SCHOOL

PORTLAND, OREGON 97214 PH. 503 280 8759 FAX: 503 280 8866

SHEET TITLE:

SECTOR A - ROOF PLAN

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Date: NOVEMBER 10, 2021

Revisions:


Drawn: TWB
Check: BAR

BAR R100-Roof\_Plans R3282.07

SHEET NUMBER:

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BID SET

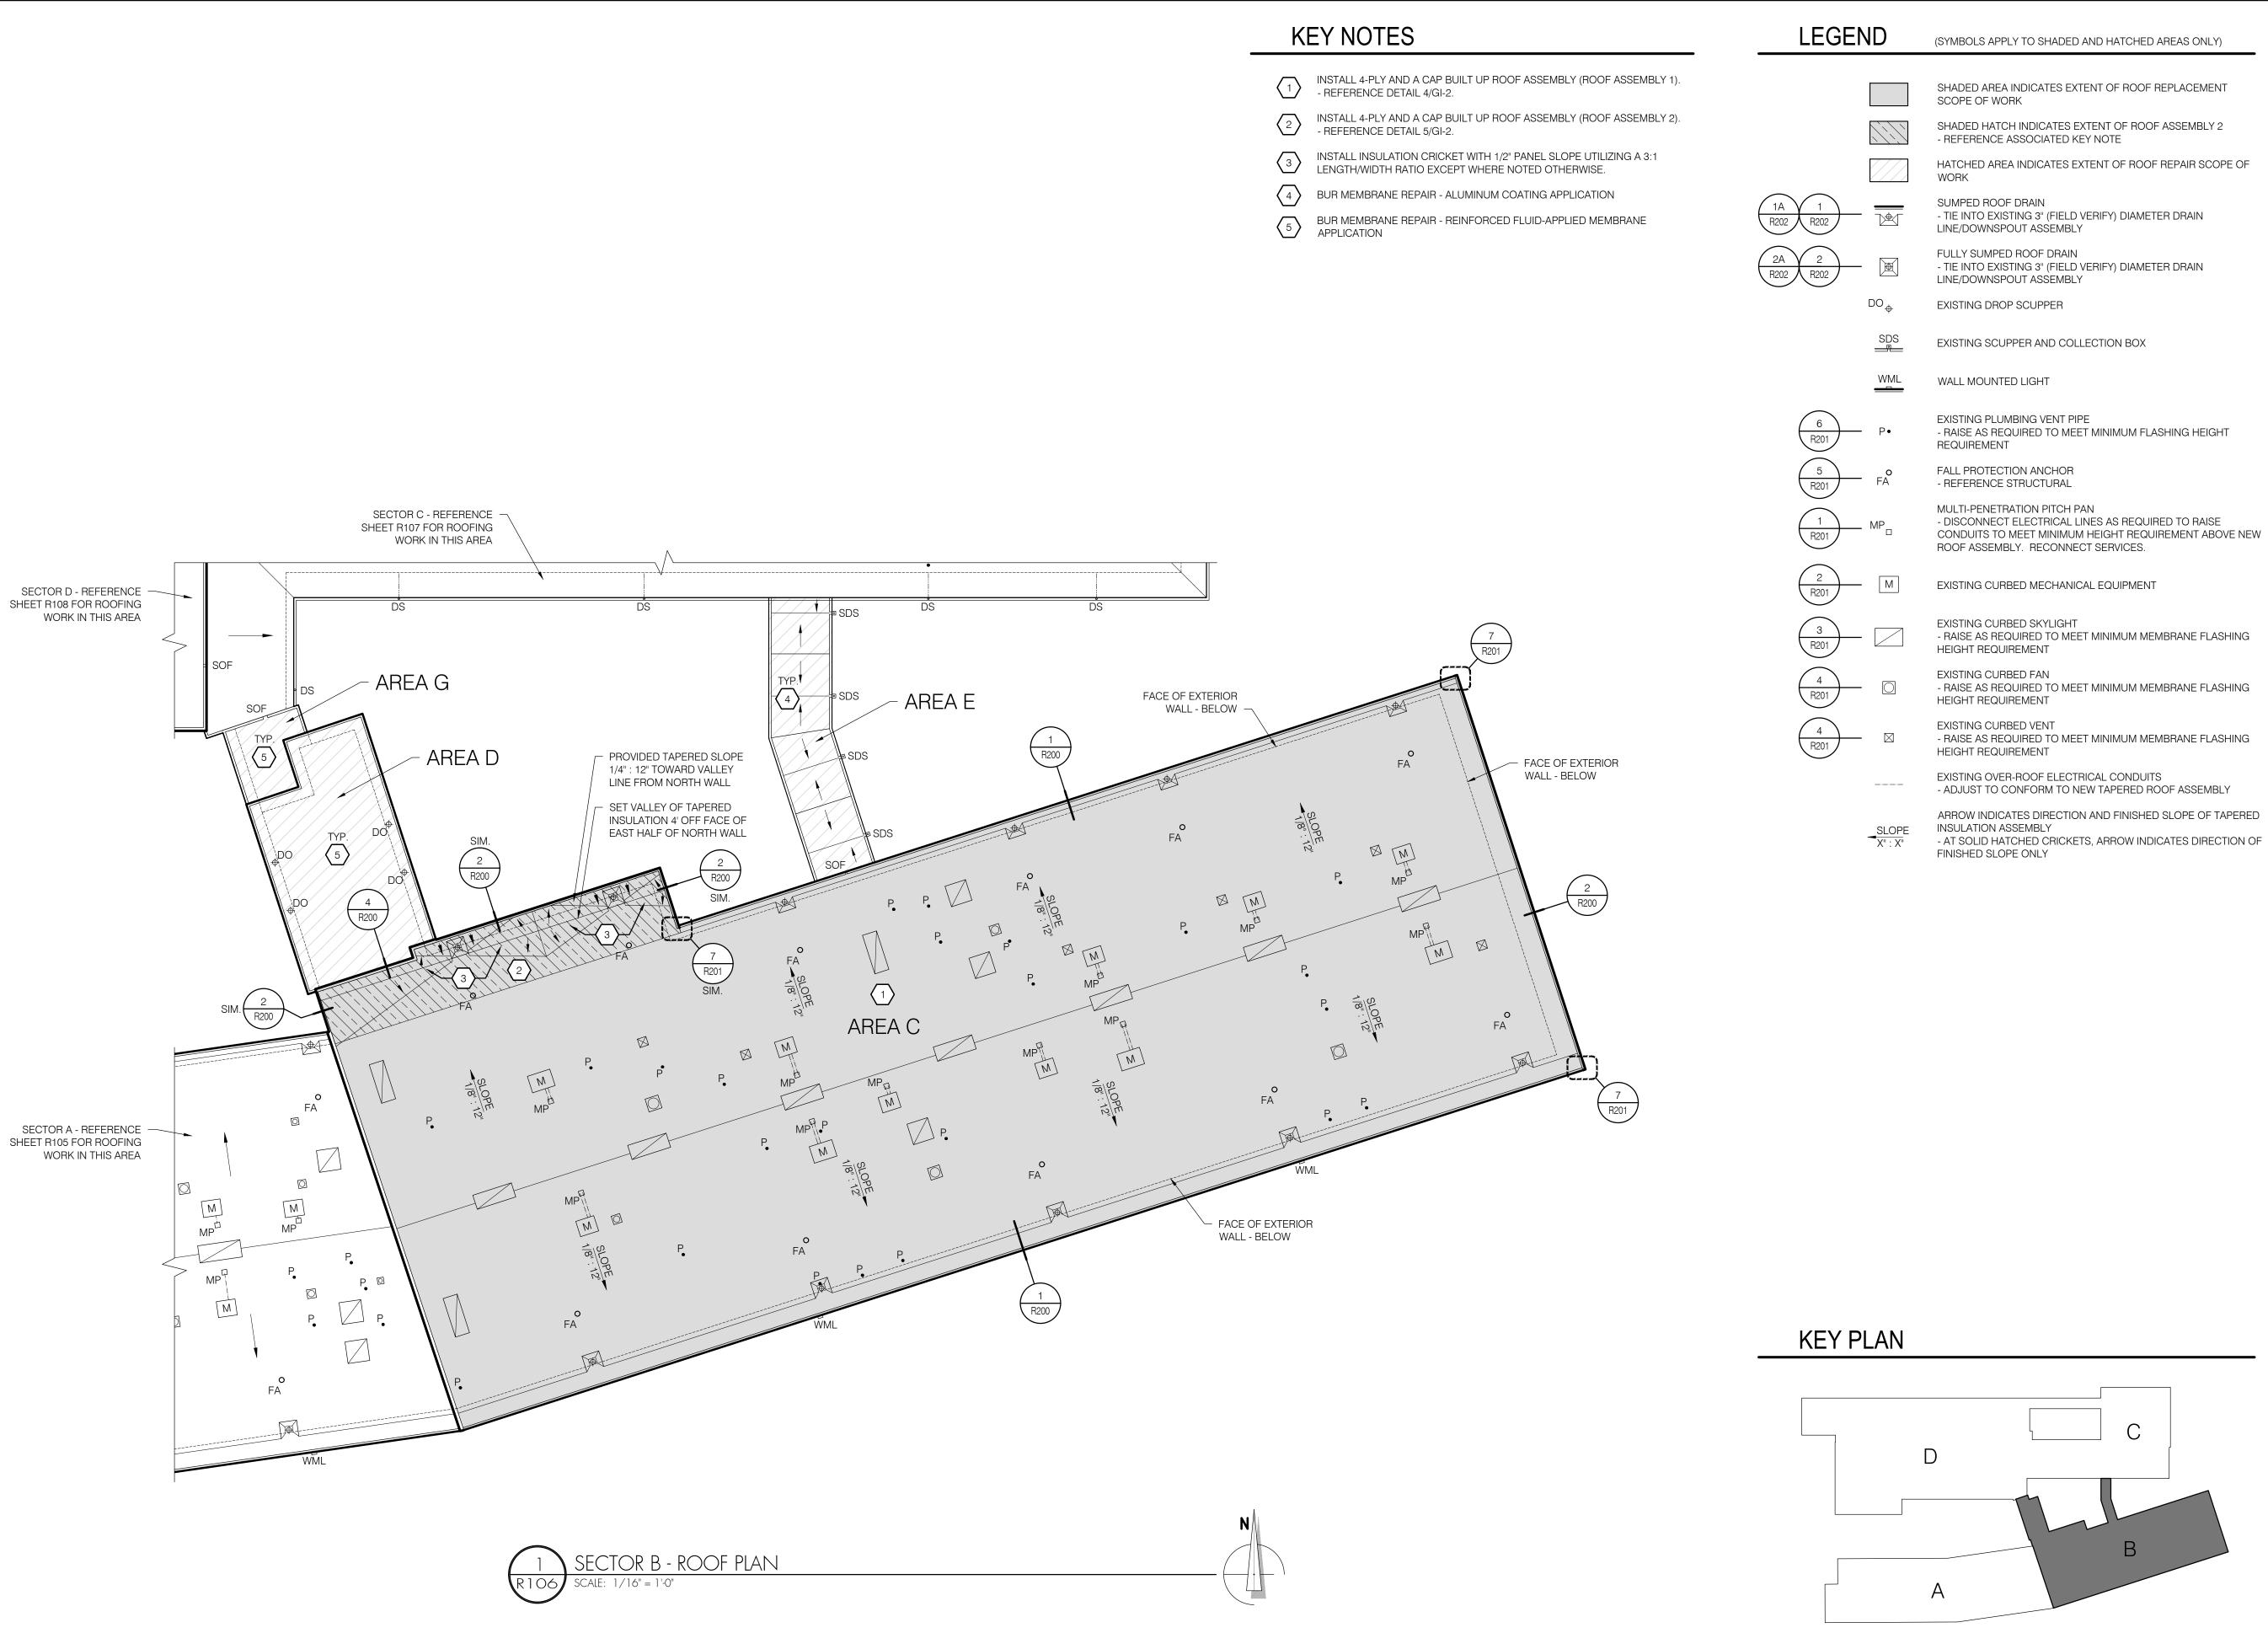

SHEET TITLE:

SECTOR B - ROOF PLAN

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NOVEMBER 10, 2021

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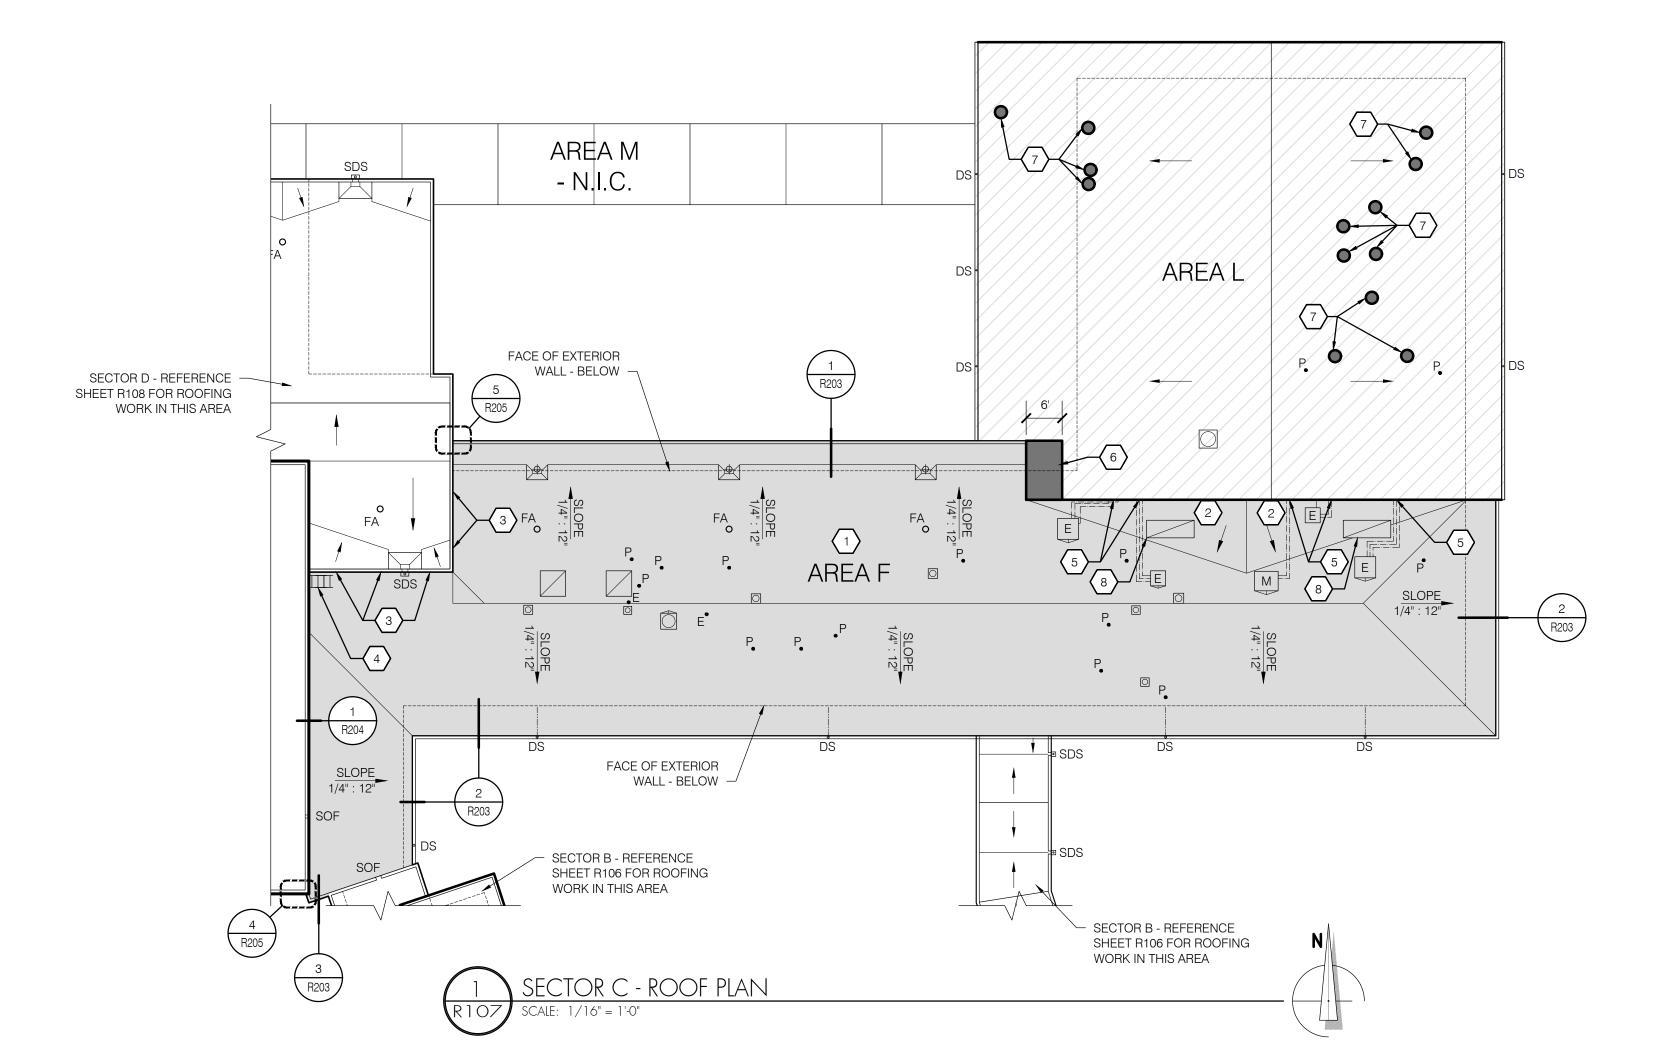
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## **KEY NOTES**

- INSTALL 4-PLY AND A CAP BUILT UP ROOF ASSEMBLY (ROOF ASSEMBLY 3).
   REFERENCE DFTAIL 6/GL-2 - REFERENCE DETAIL 6/GI-2.
- INSTALL INSULATION CRICKET WITH 1/2" PANEL SLOPE UTILIZING A 3:1 LENGTH/WIDTH RATIO EXCEPT WHERE NOTED OTHERWISE.
- INFILL OPENINGS IN WALL WHERE CLERESTORY WINDOWS WERE DEMOLISHED. - REFERENCE 2/R204 FOR WATERPROOFING.
- REFERENCE STRUCTURAL FOR FRAMING. INSTALL WALL-MOUNTED LADDER.

- REFERENCE STRUCTURAL.

- ADJUST CONDUIT PENETRATIONS AT ADJACENT WALL TO MAINTAIN A MINIMUM CLEAR VERTICAL HEIGHT ABOVE THE FINISHED ROOF SURFACE
- BUR MEMBRAN APPLICATION BUR MEMBRANE REPAIR - REINFORCED FLUID-APPLIED MEMBRANE
- (7) BUR MEMBRANE REPAIR MEMBRANE PATCH
- COAT NEW ROOF WITH REINFORCED-FLUID-APPLIED FLASHING AT ANY LOCATION ON THE CRICKET AND IMMEDIATELY ADJACENT TO THE CRICKET VALLEY IN WHICH PONDING WATER OCCURS. REINFORCED FLUID-APPLIED FLASHING IS TO EXTEND A MINIMUM OF 12" BEYOND THE EXTENT OF ANY AREA IN WHICH WATER IS DEEMED TO BE PONDING.



## LEGEND

(SYMBOLS APPLY TO SHADED AND HATCHED AREAS ONLY)



SHADED AREA INDICATES EXTENT OF ROOF REPLACEMENT SCOPE




HATCHED AREA INDICATES EXTENT OF ROOF REPAIR SCOPE OF



INDICATES APPROXIMATE EXTENT/LOCATION OF REPAIR ACTIVITIES - REFERENCE KEY NOTES AND SPECIFICATIONS




SUMPED ROOF DRAIN - TIE NEW ROOF DRAIN INTO EXISTING 3" (FIELD VERIFY) DIAMETER DRAIN LINE/DOWNSPOUT ASSEMBLY

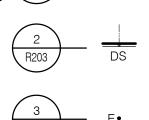


DIAMETER DRAIN LINE/DOWNSPOUTS ASSEMBLIES BELOW OVERHANG EXISTING ELECTRICAL PENETRATION - RAISE AS REQUIRED TO MEET MINIMUM FLASHING HEIGHT

- TIE GUTTER DOWNSPOUTS INTO EXISTING 3" (FIELD VERIFY)

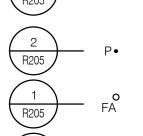


EXISTING PLUMBING VENT PIPE - RAISE AS REQUIRED TO MEET MINIMUM FLASHING HEIGHT

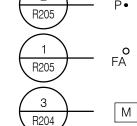


FALL PROTECTION ANCHOR - REFERENCE STRUCTURAL

REQUIREMENT

GUTTER AND DOWNSPOUT

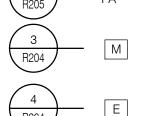


EXISTING CURBED MECHANICAL EQUIPMENT - RAISE AS REQUIRED TO MEET MINIMUM MEMBRANE FLASHING HEIGHT REQUIREMENT

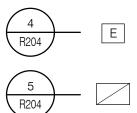

- RAISE AS REQUIRED TO MEET MINIMUM MEMBRANE FLASHING HEIGHT REQUIREMENT

EXISTING CAPPED EQUIPMENT CURBS

EXISTING CURBED SKYLIGHT

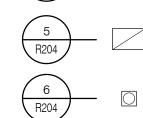

HEIGHT REQUIREMENT EXISTING CURBED FAN - RAISE AS REQUIRED TO MEET MINIMUM MEMBRANE FLASHING

- RAISE AS REQUIRED TO MEET MINIMUM MEMBRANE FLASHING

EXISTING OVER-ROOF ELECTRICAL CONDUITS - ADJUST TO CONFORM TO NEW TAPERED ROOF ASSEMBLY

EXISTING WALL-MOUNTED LADDER - REFERENCE ASSOCIATED KEY NOTE

HEIGHT REQUIREMENT

ARROW INDICATES DIRECTION AND FINISHED SLOPE OF TAPERED INSULATION ASSEMBLY - AT SOLID HATCHED CRICKETS, ARROW INDICATES DIRECTION OF FINISHED SLOPE ONLY



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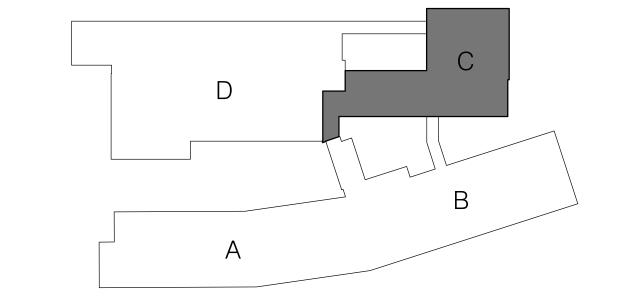
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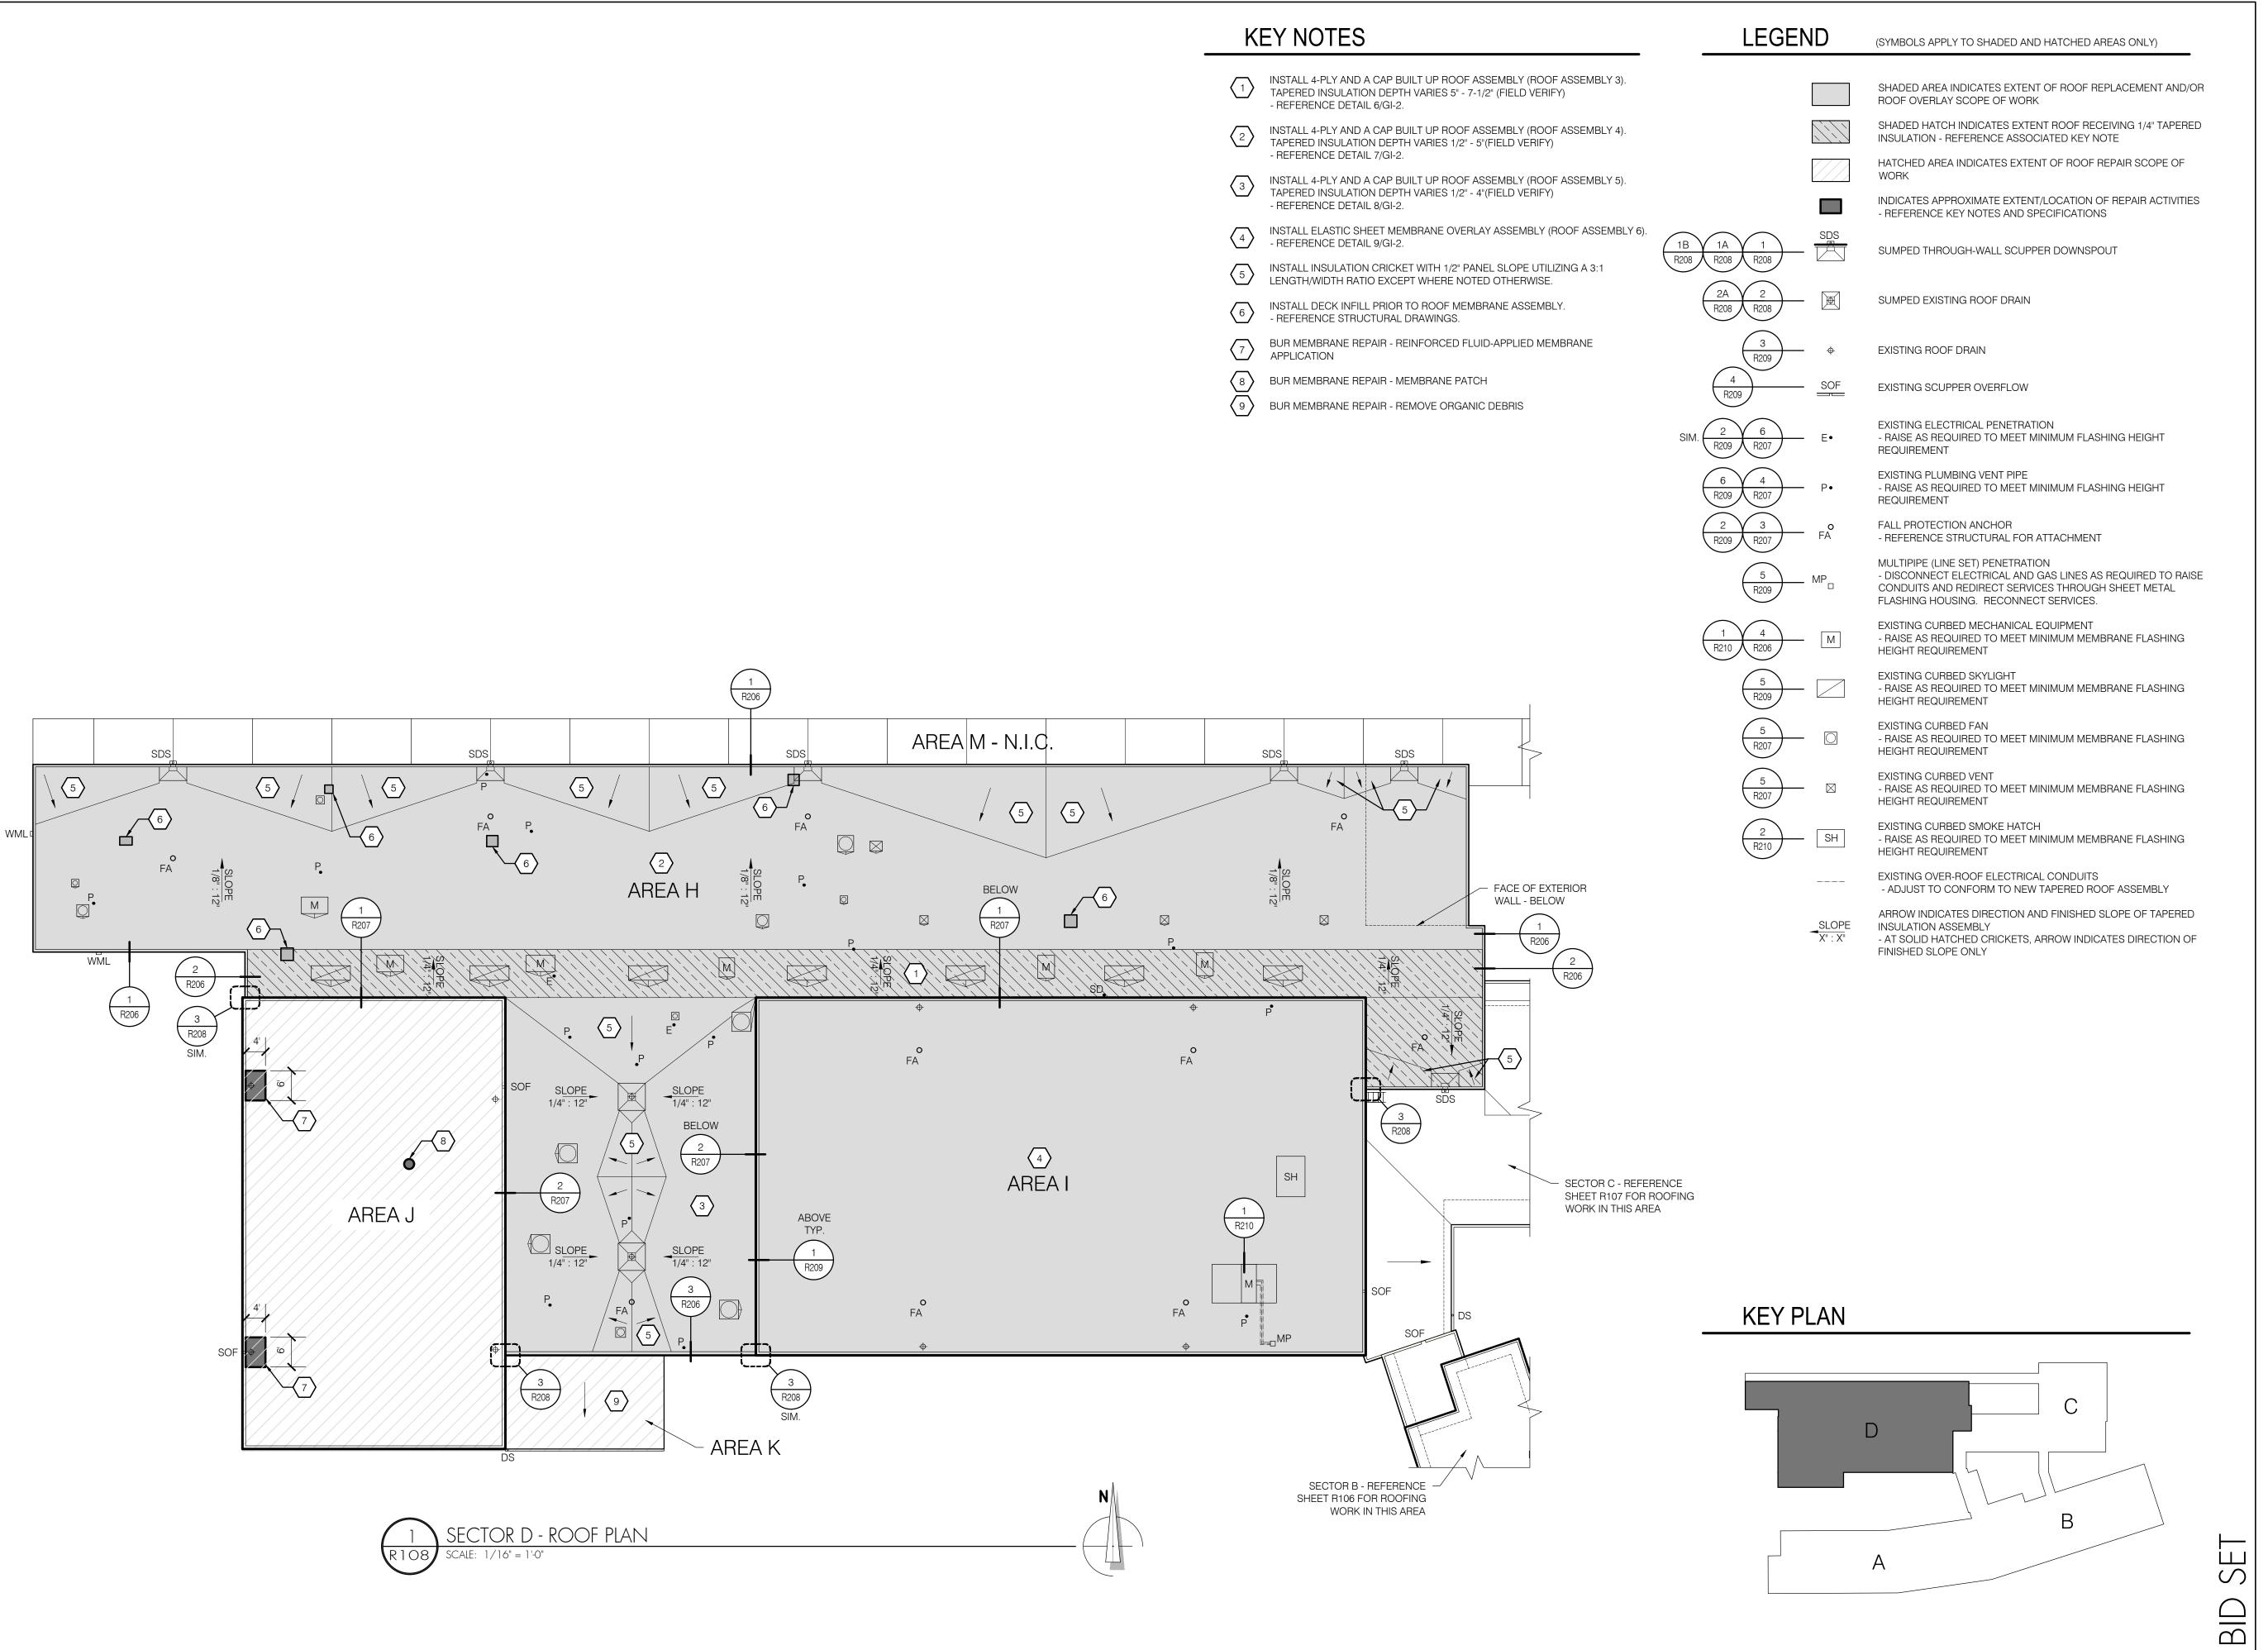
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## KEY PLAN







NOVEMBER 10, 2021

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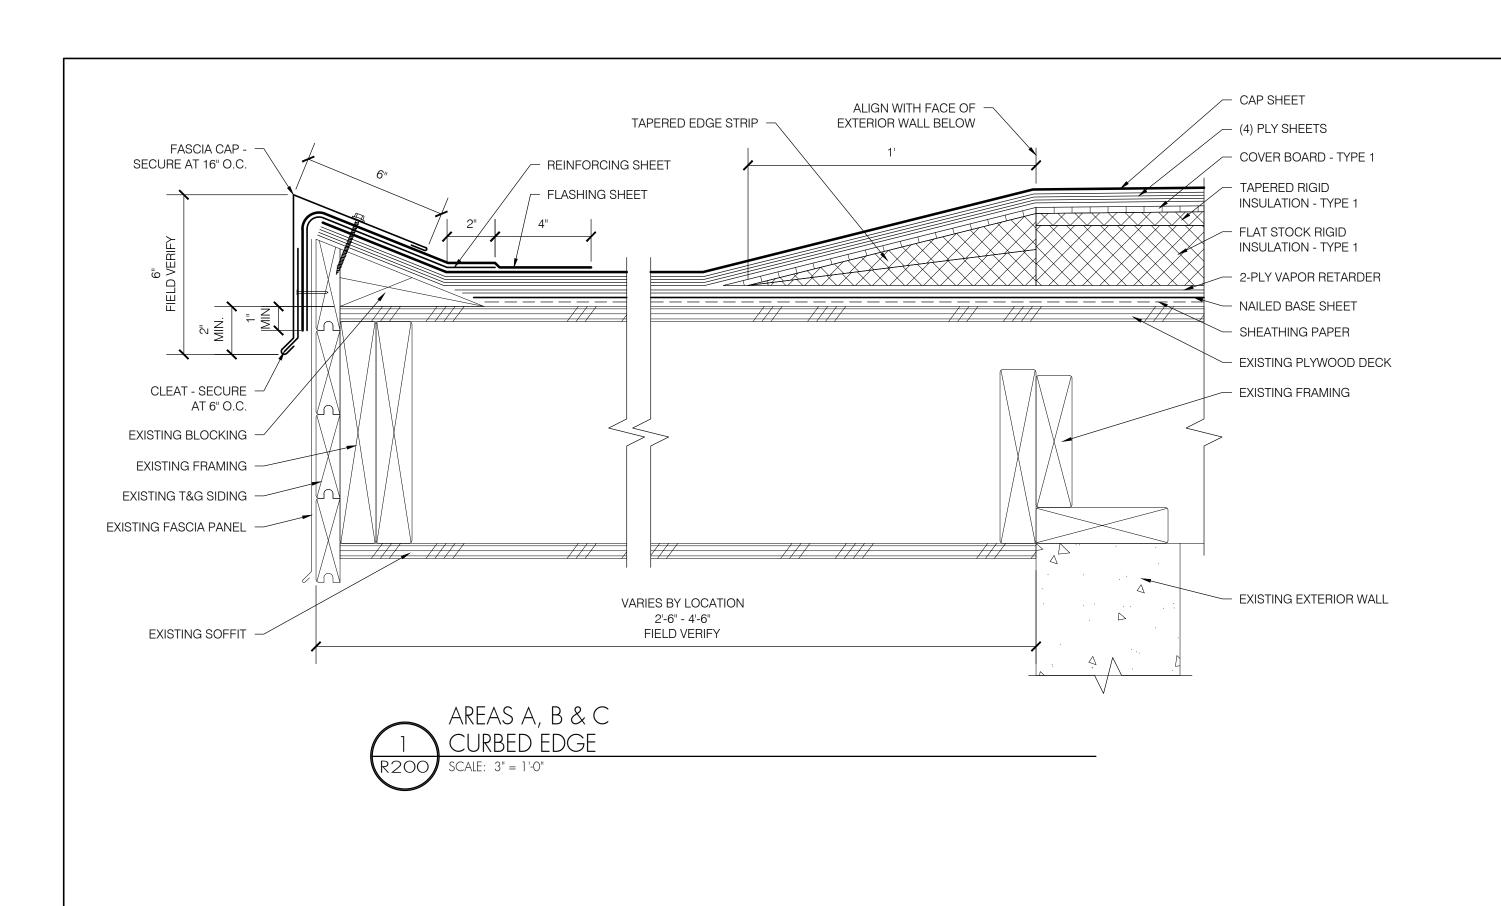
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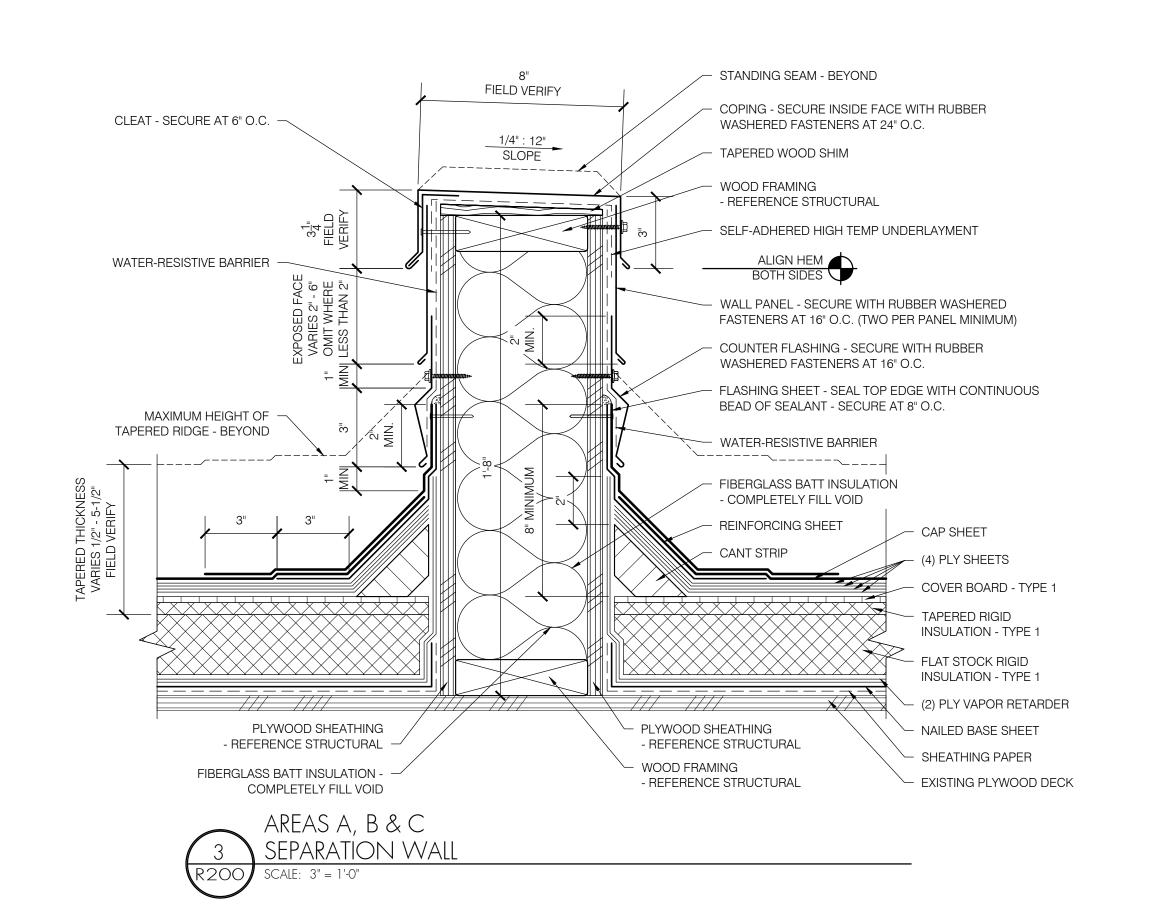
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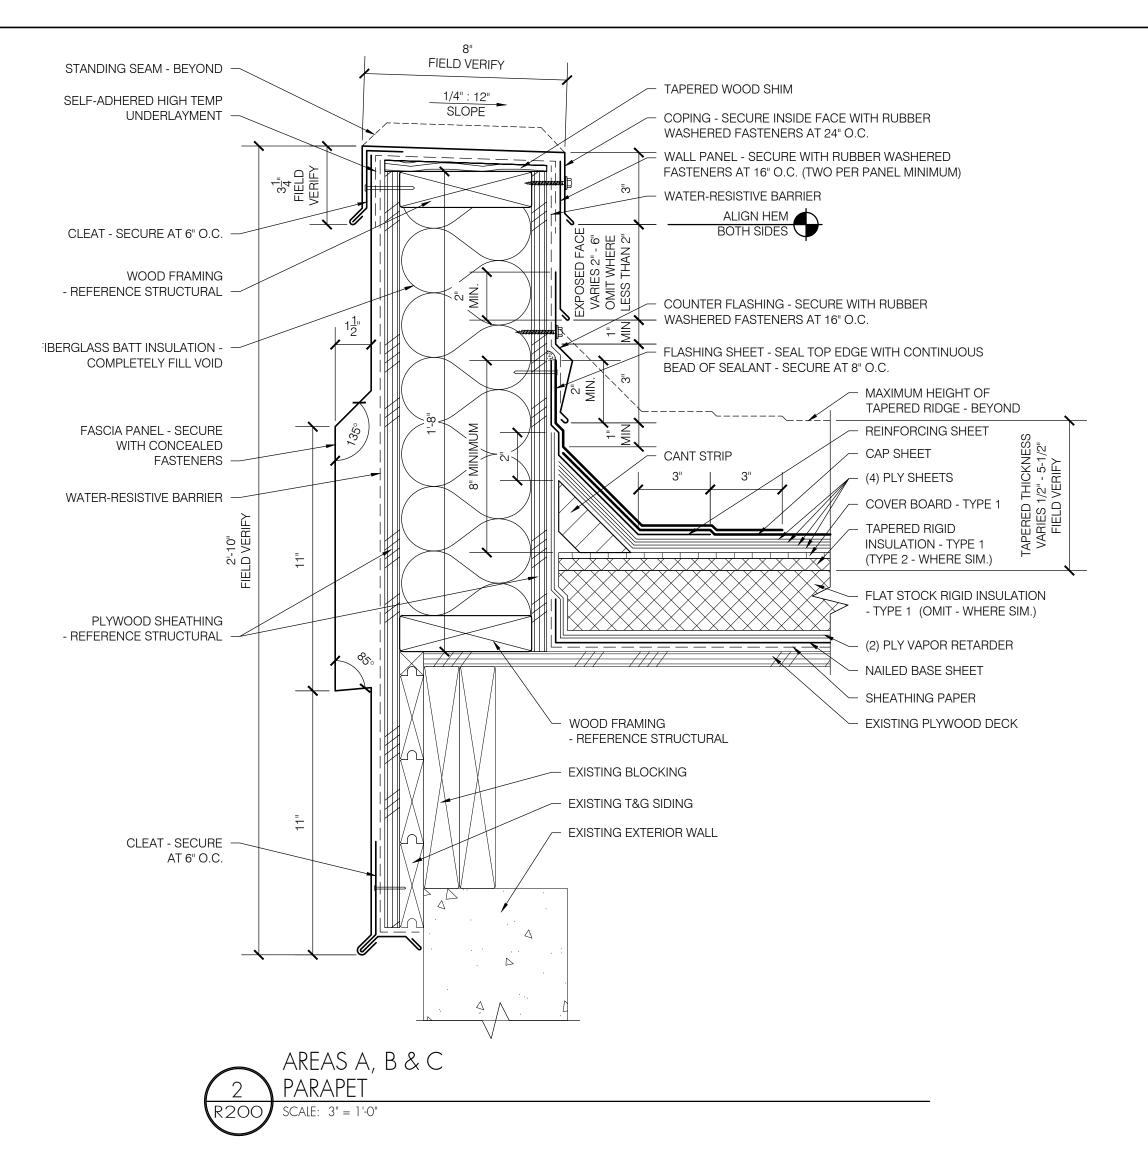
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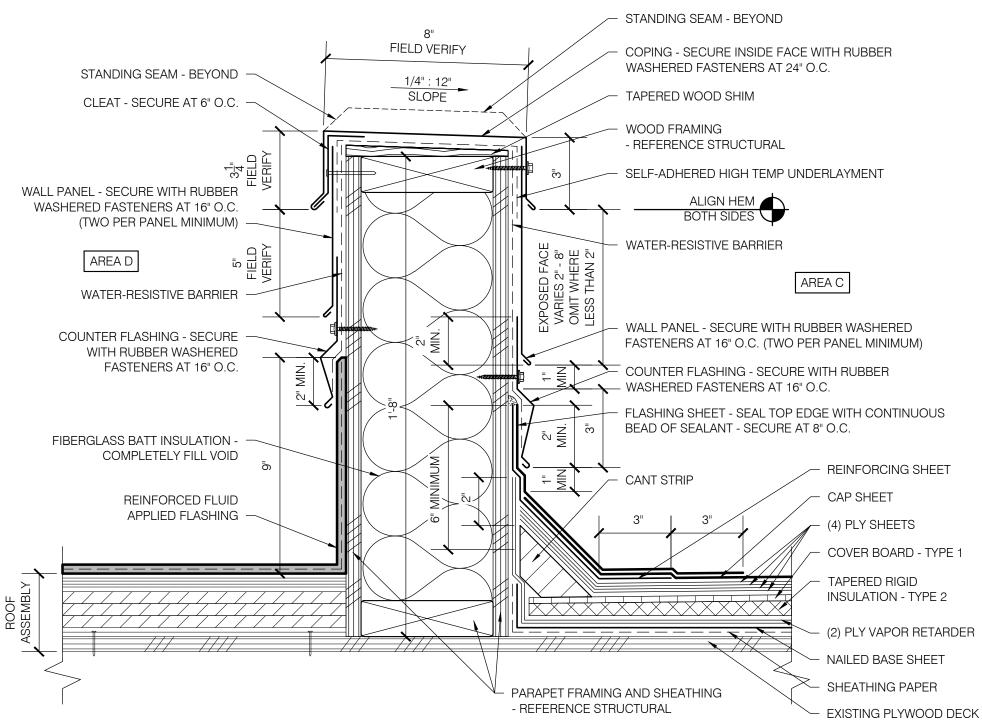
SECTOR D - ROOF PLAN

R100-Roof\_Plans













SHEET TITLE:  DETAILS - AREAS A, B & C	
DETAILS - AREAS A, B & C	SHEET TITLE:
	DETAILS - AREAS A, B & C

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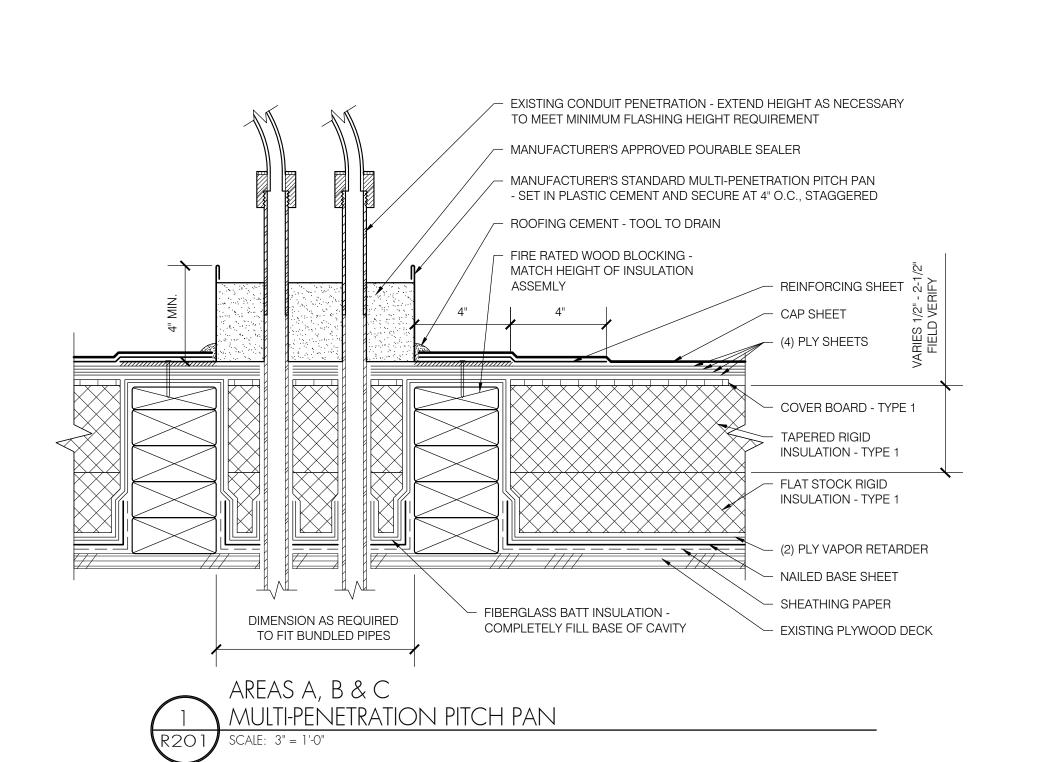
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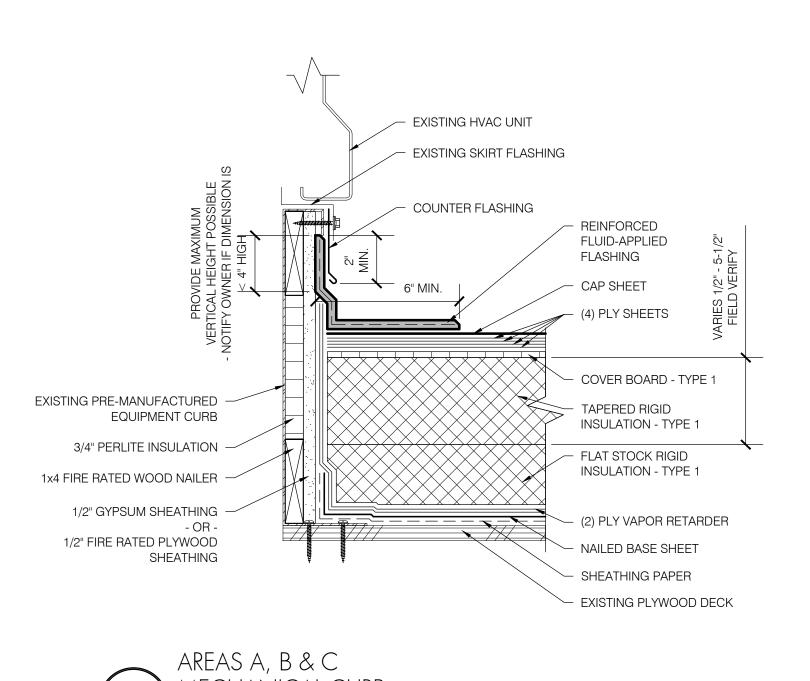
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Job:	R3282.07




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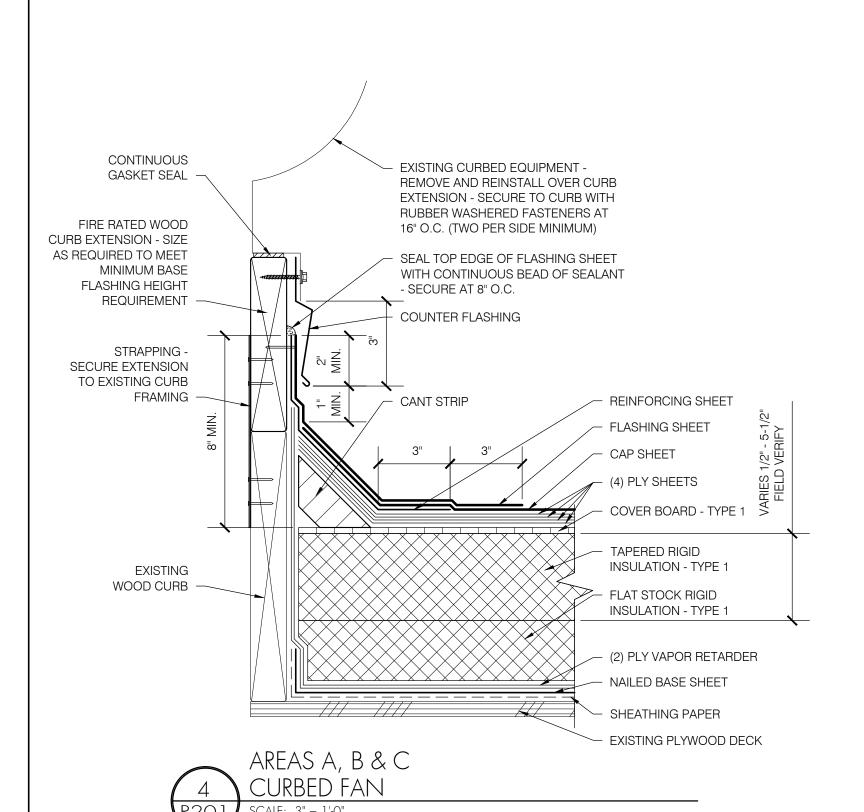
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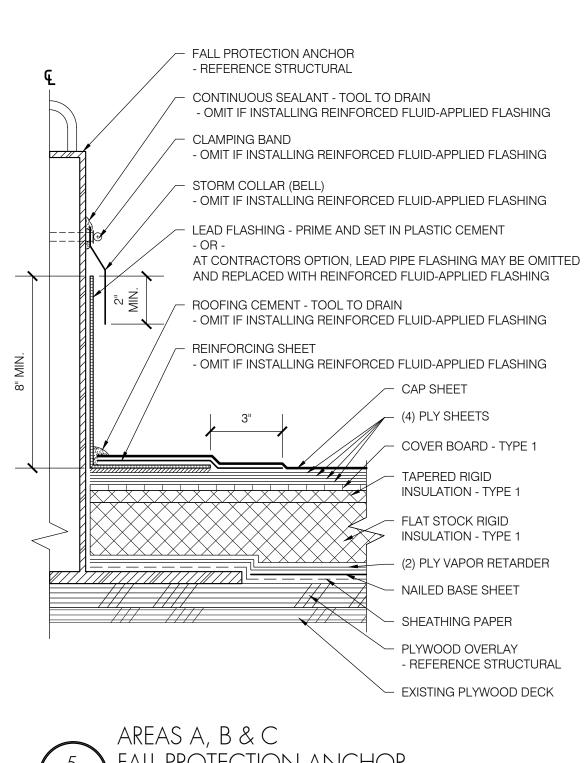








SCALE: 3'' = 1'-0''

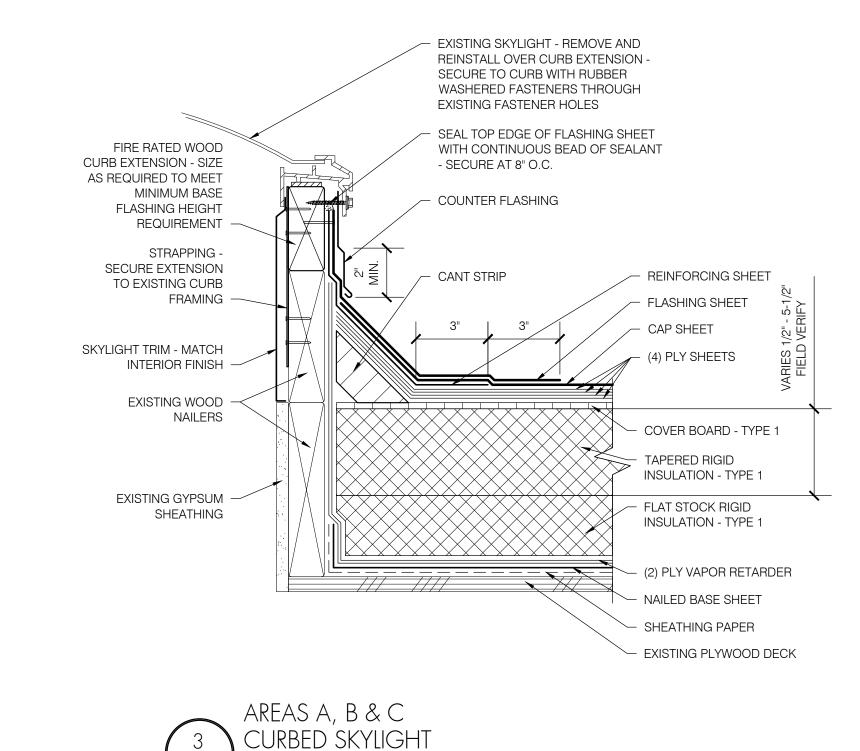



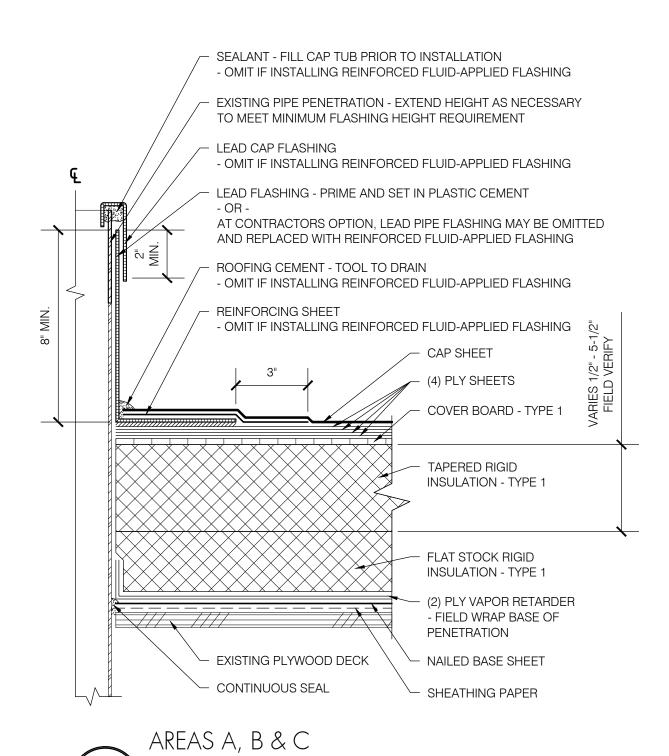

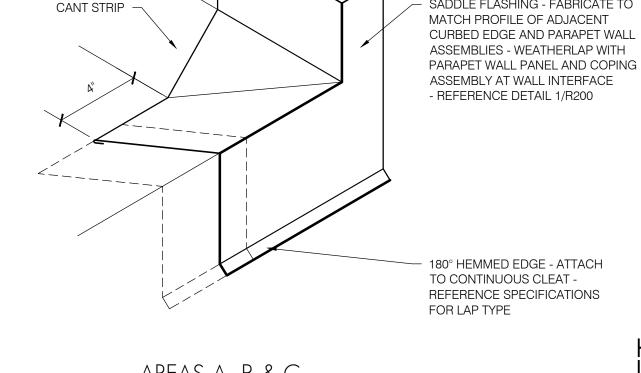

PARAPET WALL

- REFERENCE DETAIL FOR ADJACENT


SADDLE FLASHING - FABRICATE TO

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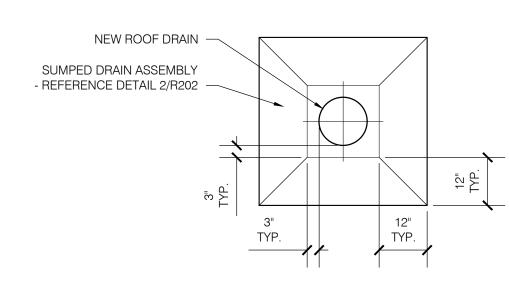
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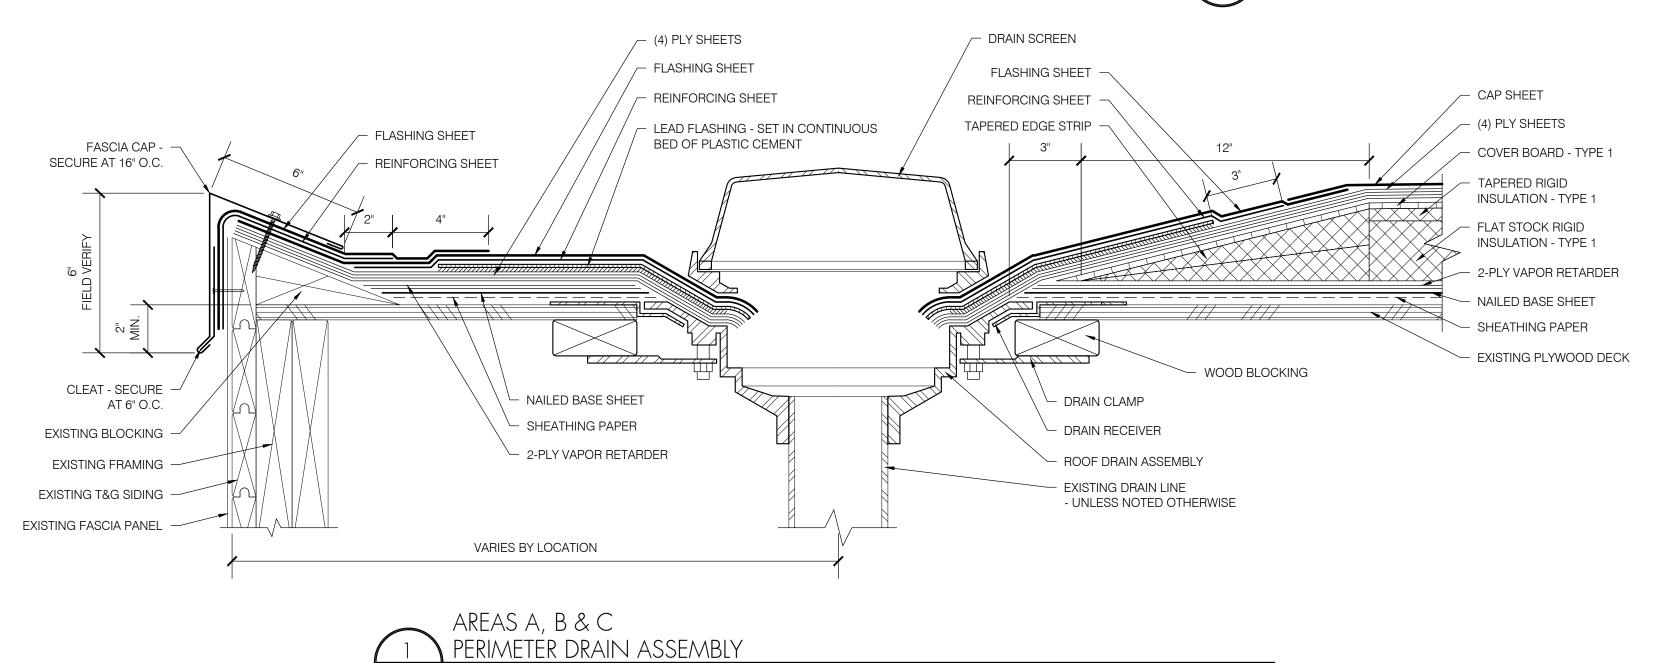
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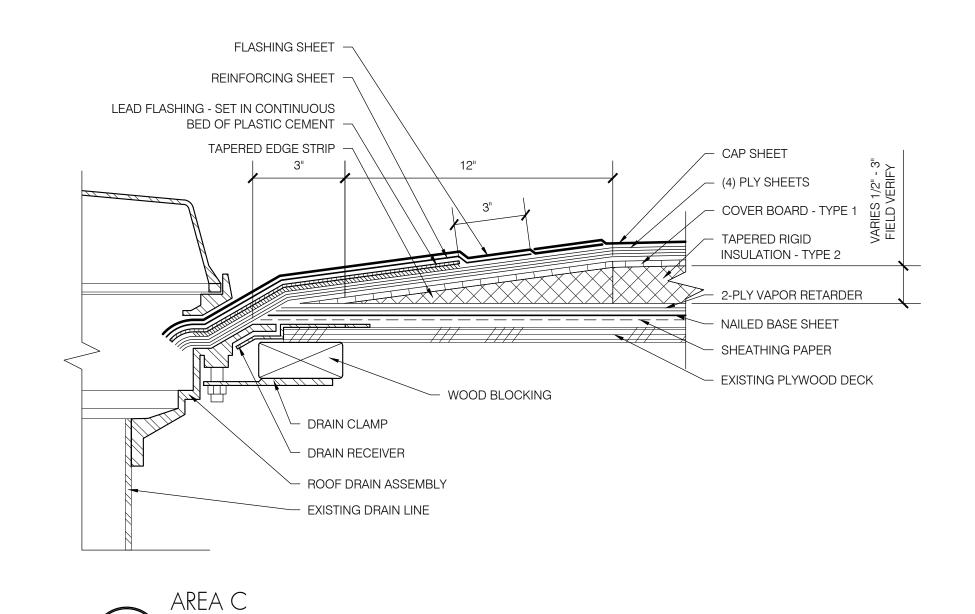


AREAS A, B & C PLAN VIEW - PERIMETER DRAIN ASSEMBLY




AREAS A, B & C PLAN VIEW - DRAIN SUMP SCALE: 1/2" = 1'-0"

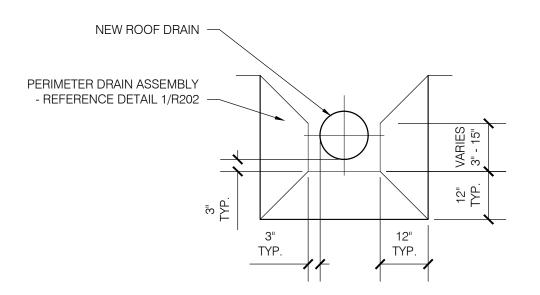



SUMPED DRAIN ASSEMBLY

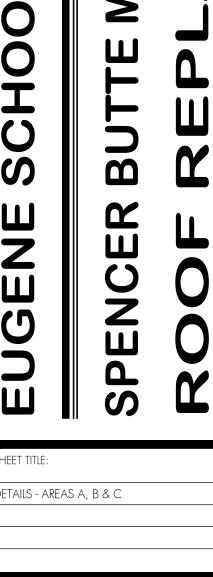

Portland, oregon 97214


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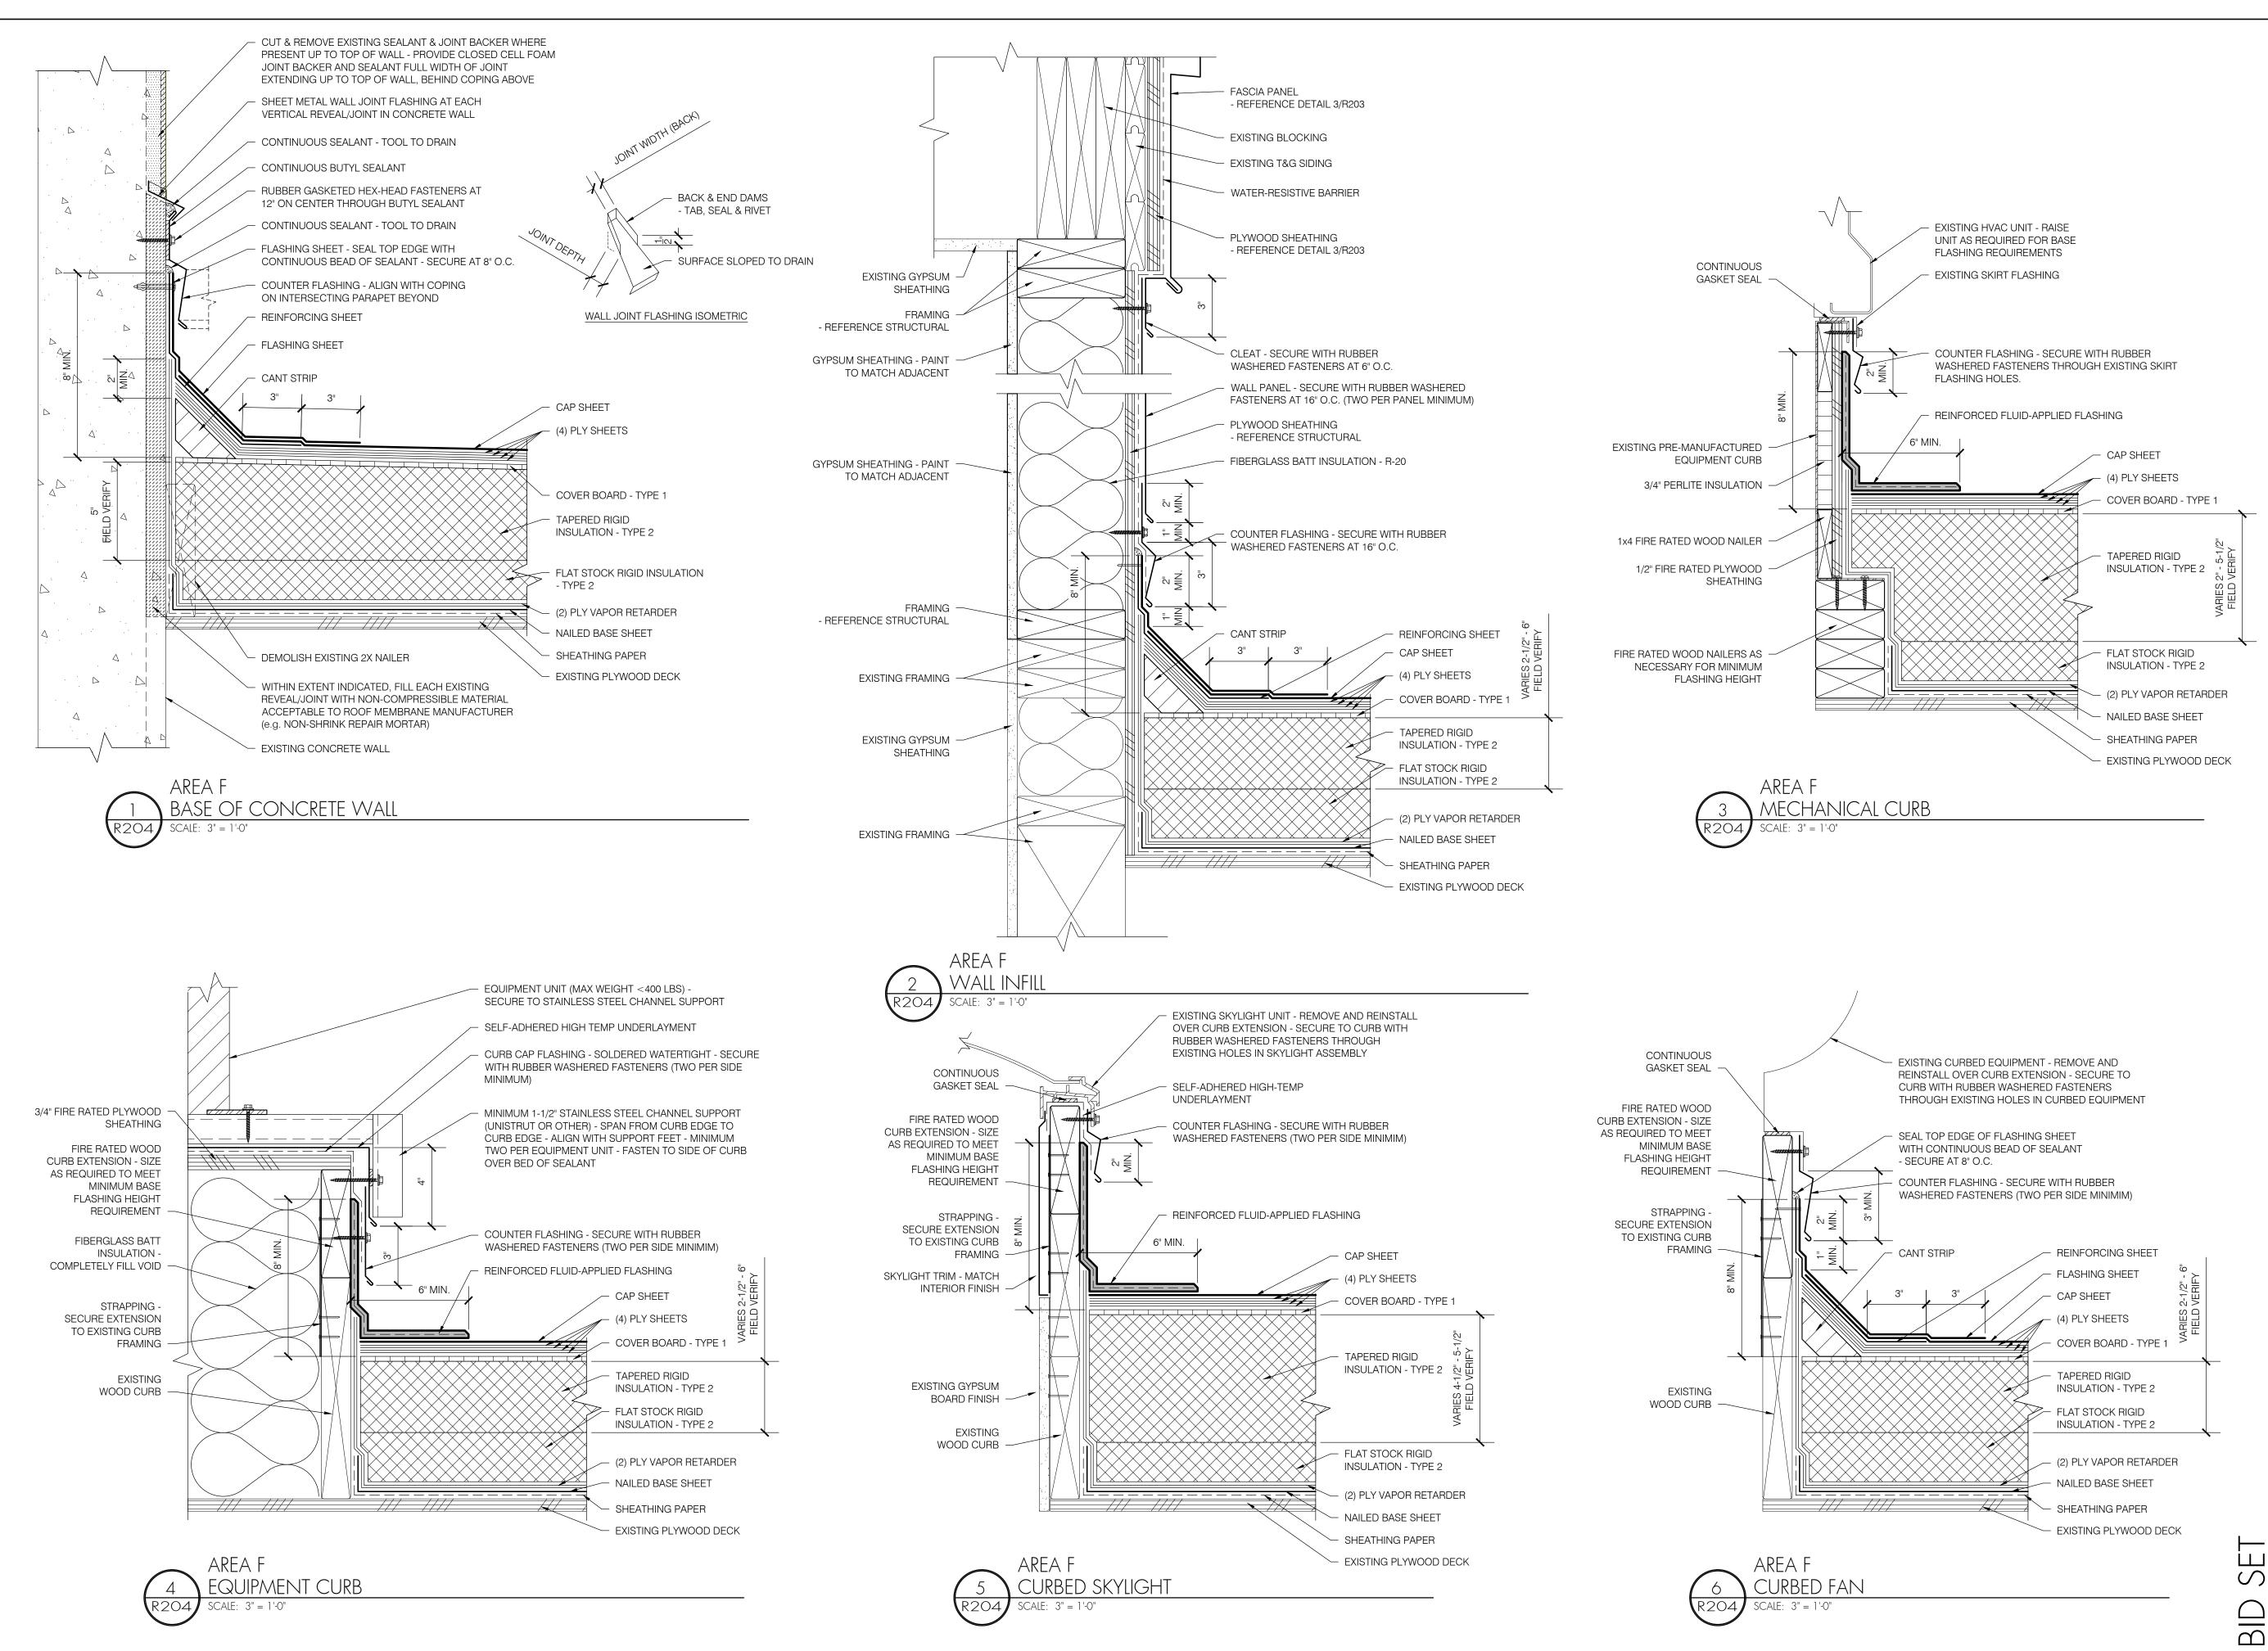
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Job:	R3282.07







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SHEET TITLE:

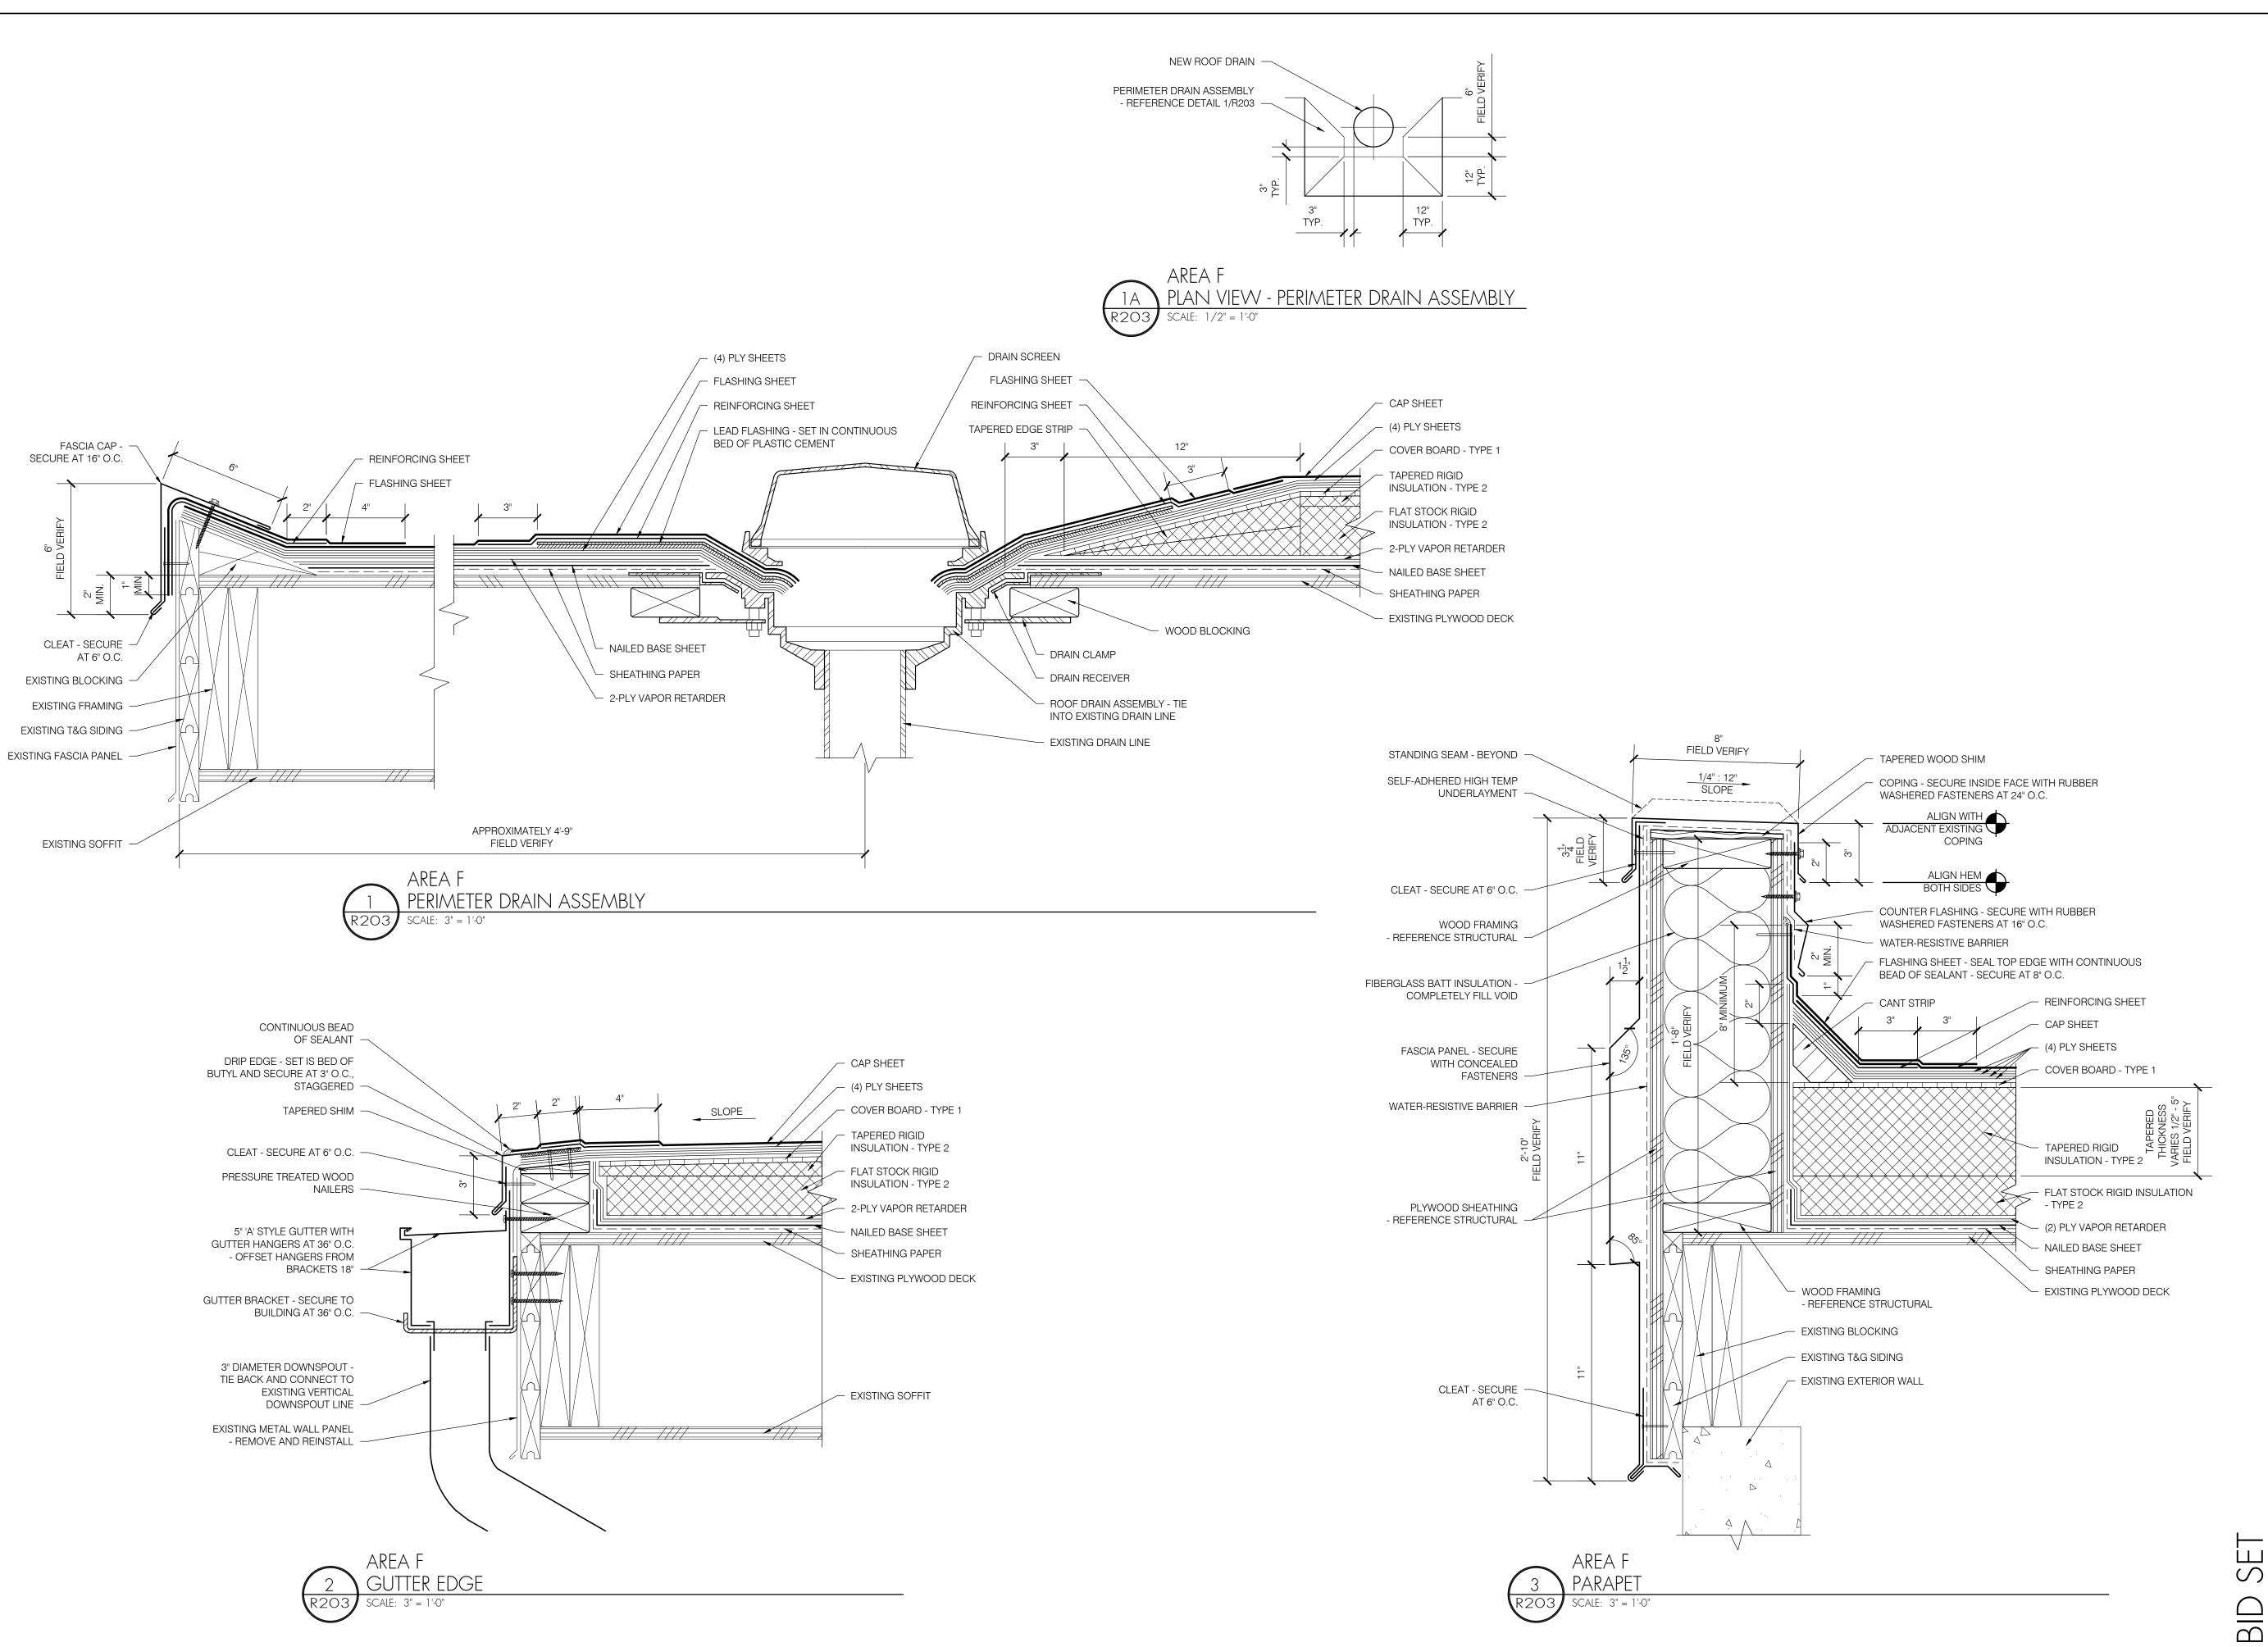DETAILS - AREA F

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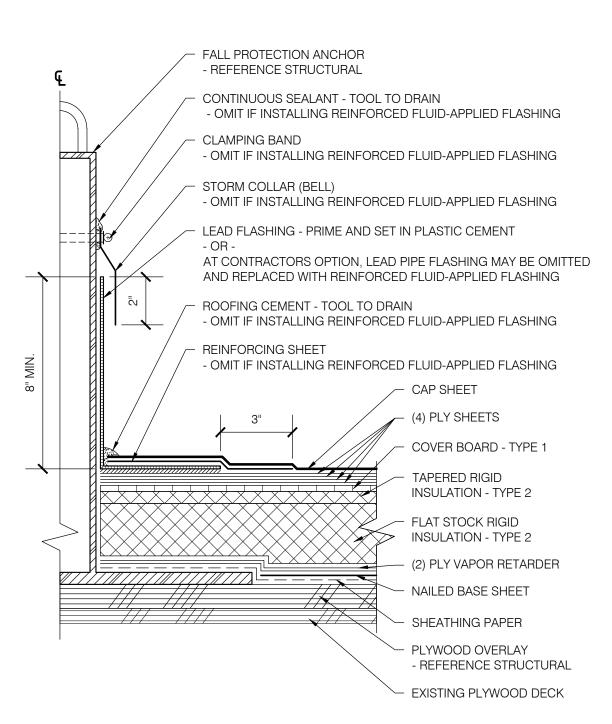
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SHEET NUMBER:



FALL PROTECTION ANCHOR



- EXISTING PLYWOOD DECK

- CONTINUOUS SEAL

SEALANT - FILL CAP TUB PRIOR TO INSTALLATION

TO MEET MINIMUM FLASHING HEIGHT REQUIREMENT

- LEAD FLASHING - PRIME AND SET IN PLASTIC CEMENT

ROOFING CEMENT - TOOL TO DRAIN

REINFORCING SHEET

- OMIT IF INSTALLING REINFORCED FLUID-APPLIED FLASHING

EXISTING PIPE PENETRATION - EXTEND HEIGHT AS NECESSARY

- OMIT IF INSTALLING REINFORCED FLUID-APPLIED FLASHING

AT CONTRACTORS OPTION, LEAD PIPE FLASHING MAY BE OMITTED

AND REPLACED WITH REINFORCED FLUID-APPLIED FLASHING

- OMIT IF INSTALLING REINFORCED FLUID-APPLIED FLASHING

- OMIT IF INSTALLING REINFORCED FLUID-APPLIED FLASHING

- (4) PLY SHEETS

- TAPERED RIGID

INSULATION - TYPE 2

- FLAT STOCK RIGID

PENETRATION

NAILED BASE SHEET


SHEATHING PAPER

INSULATION - TYPE 2


(2) PLY VAPOR RETARDER


- FIELD WRAP BASE OF

- COVER BOARD - TYPE 1

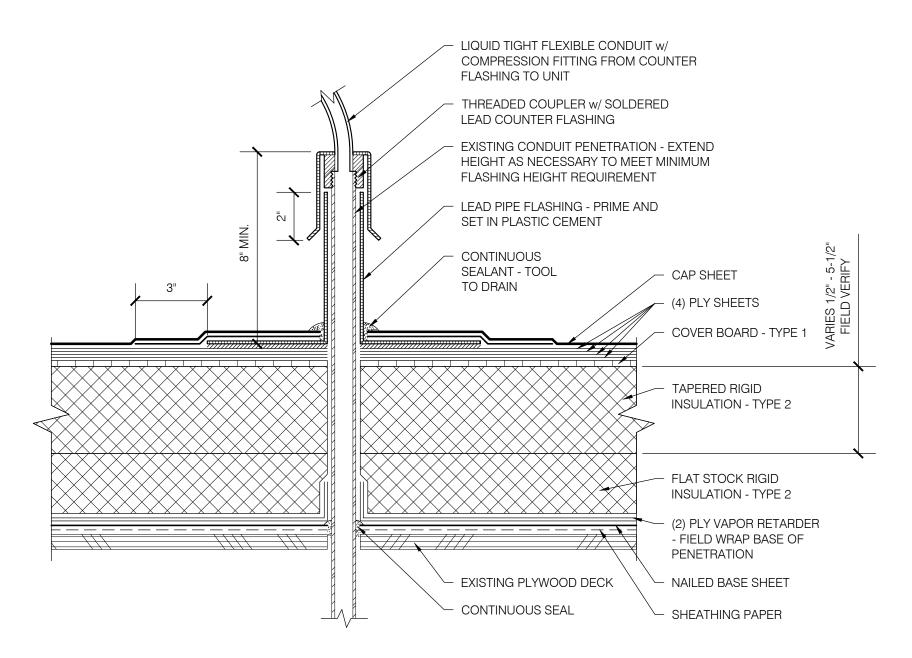



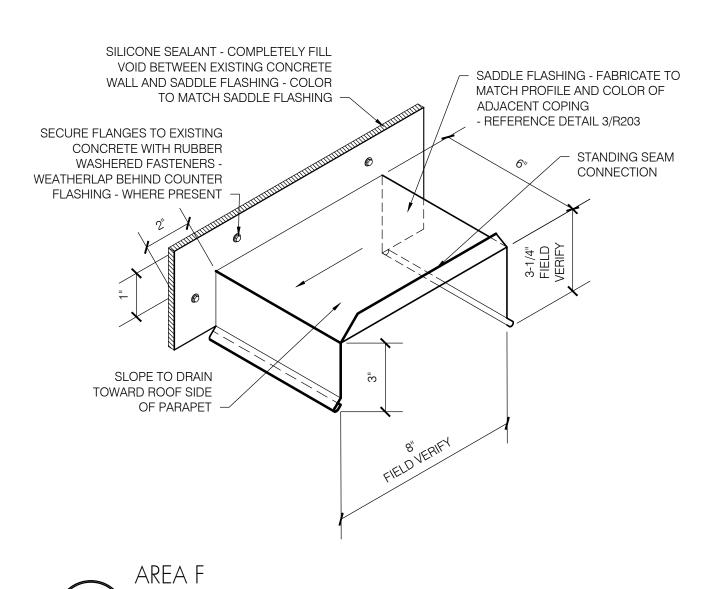

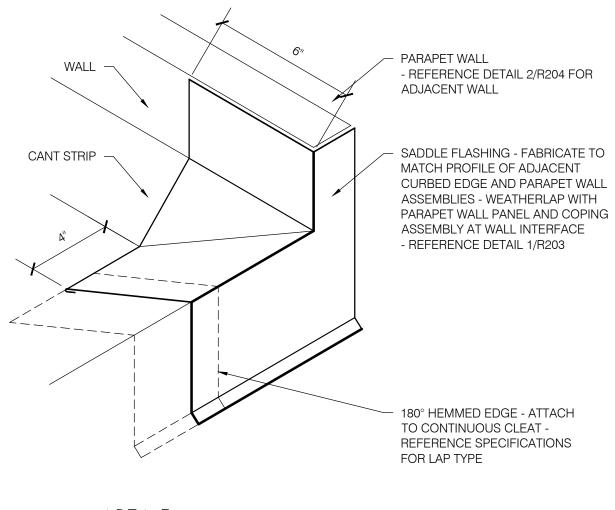






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SHEET TITLE:		
DETAILS - AREA F		

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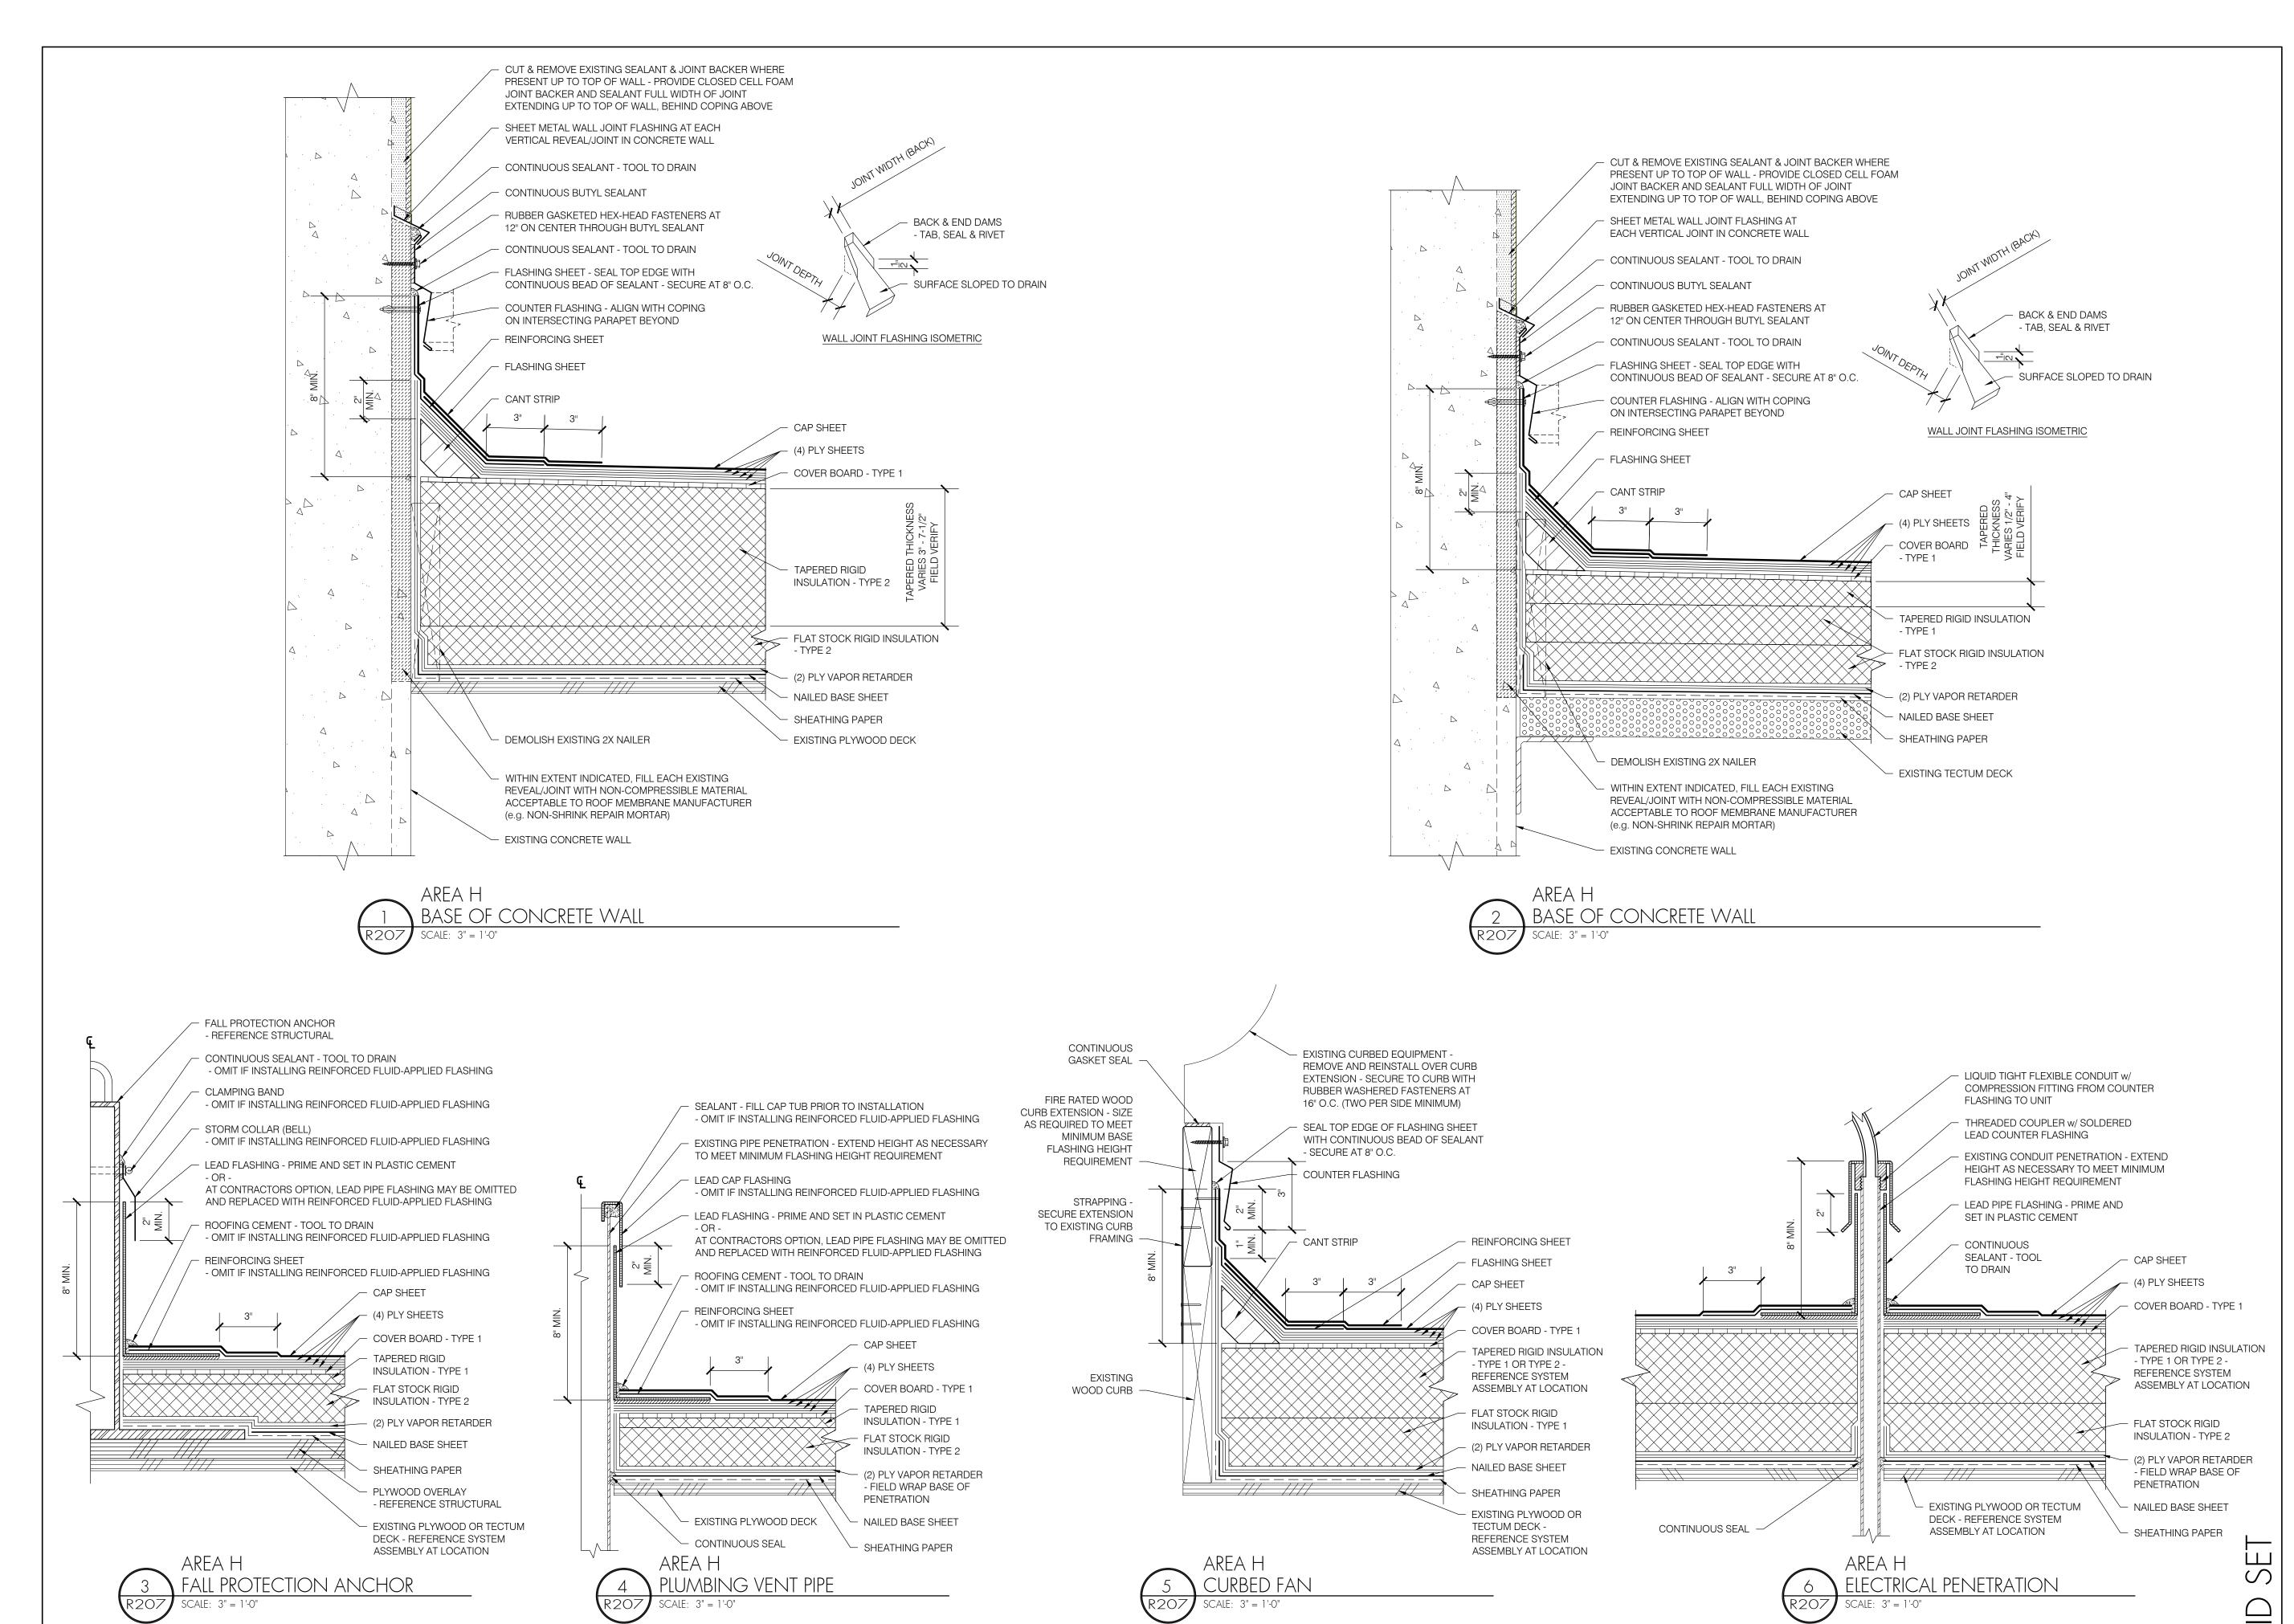




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DETAILS - AREA H	
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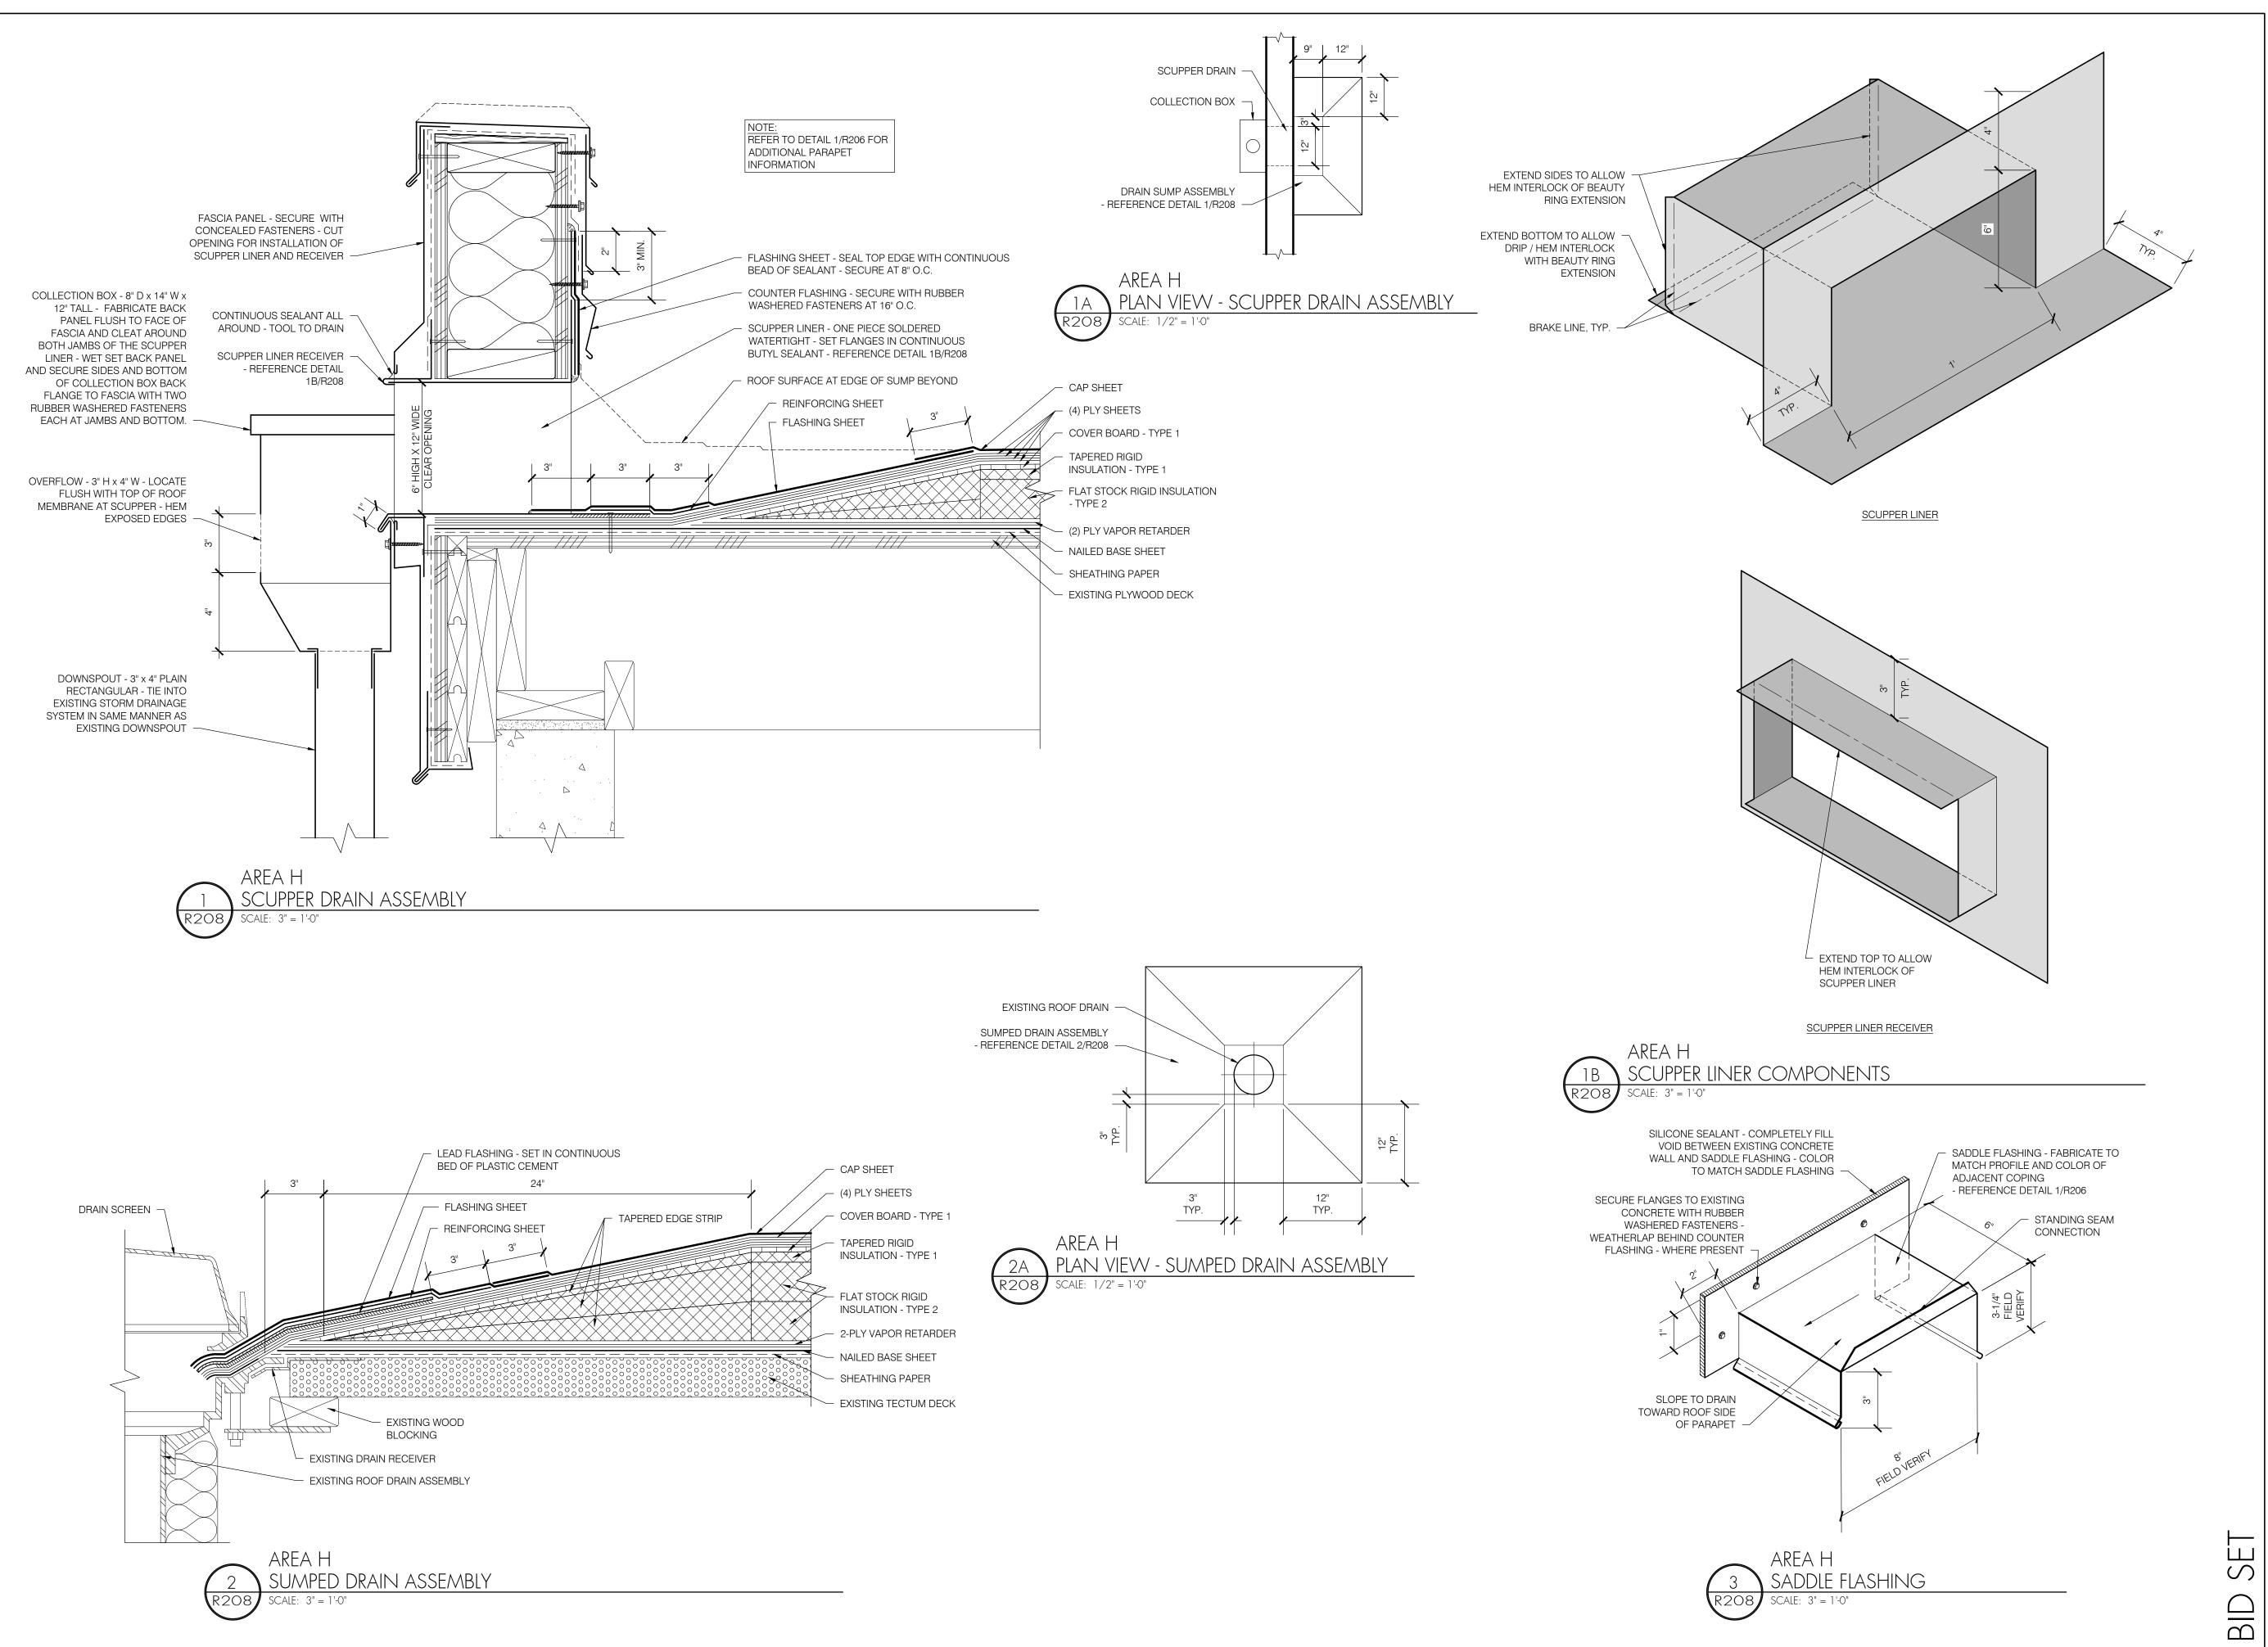
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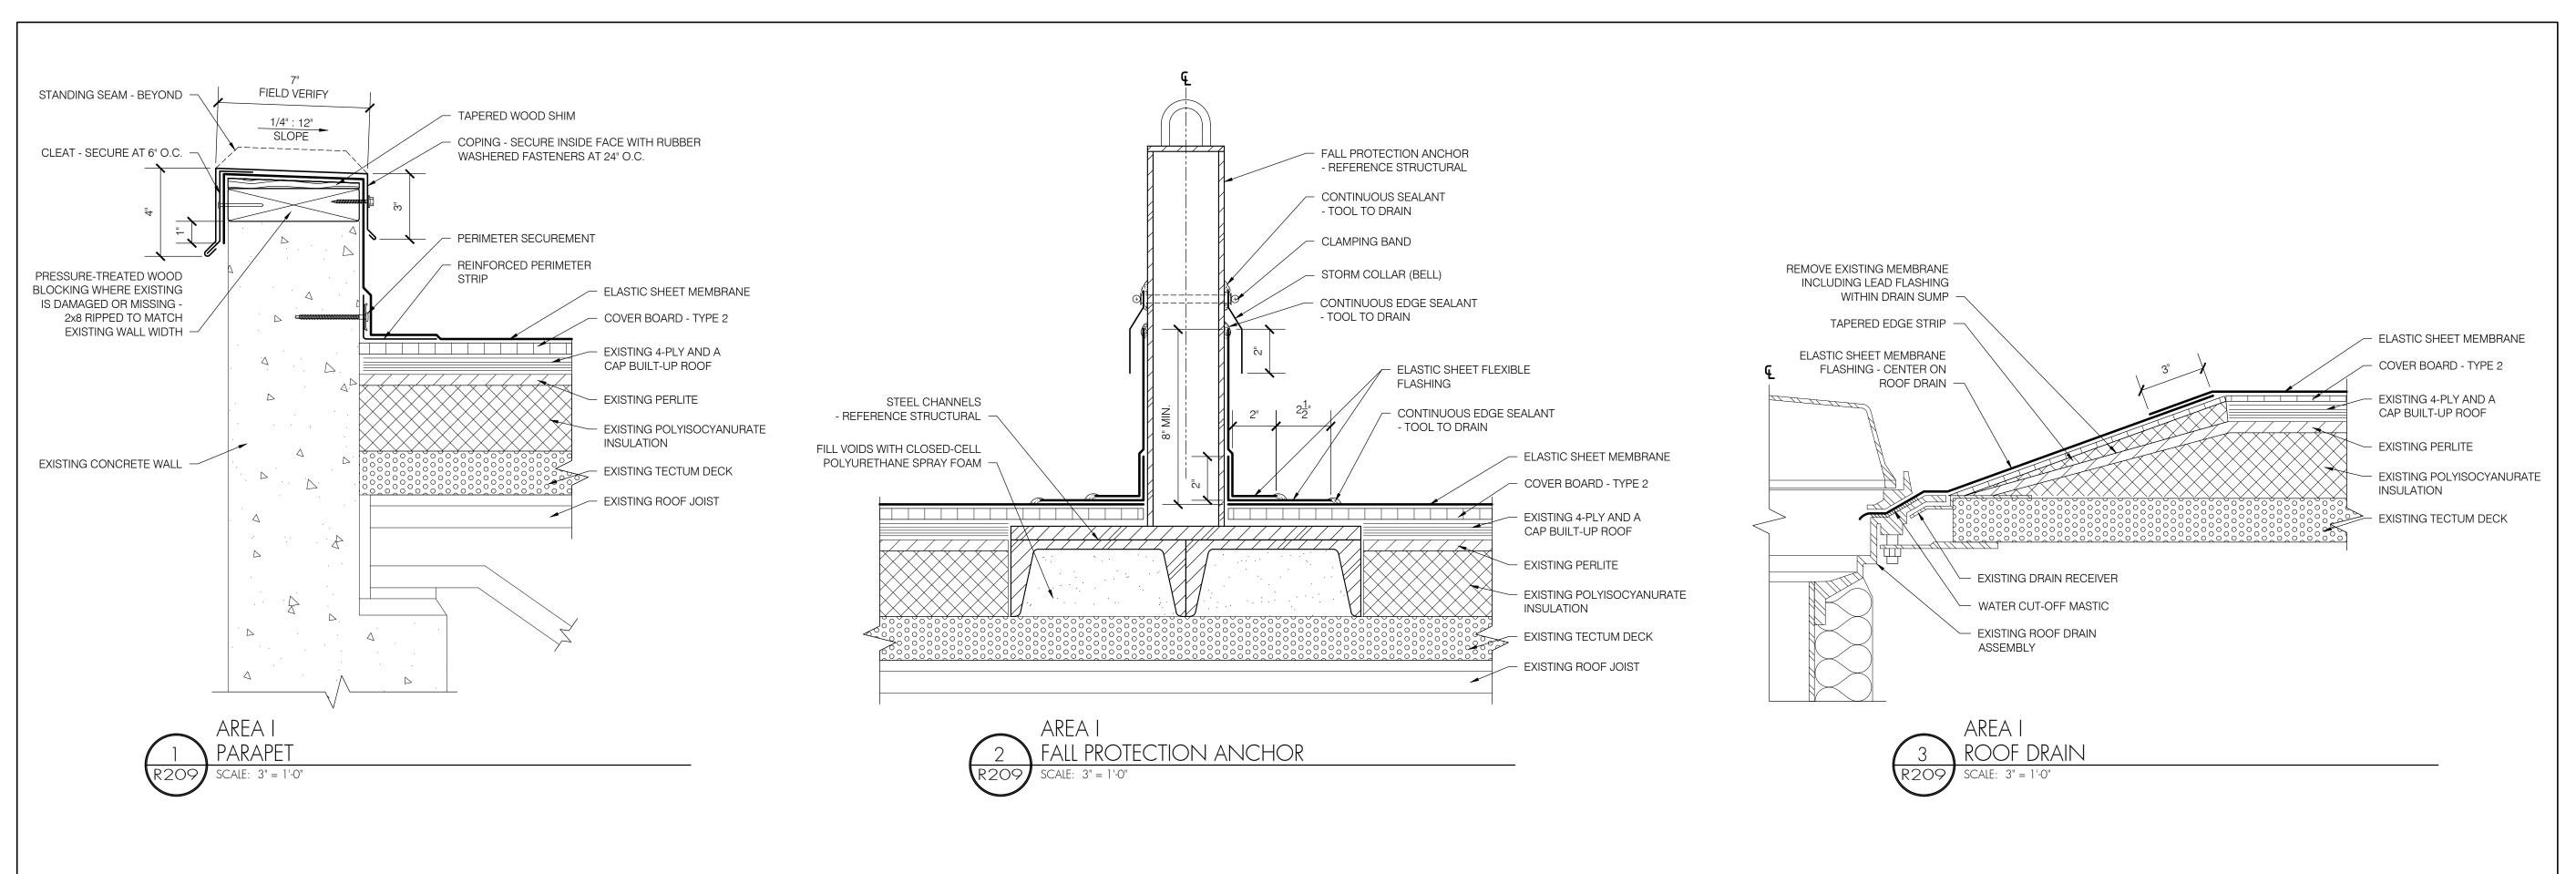
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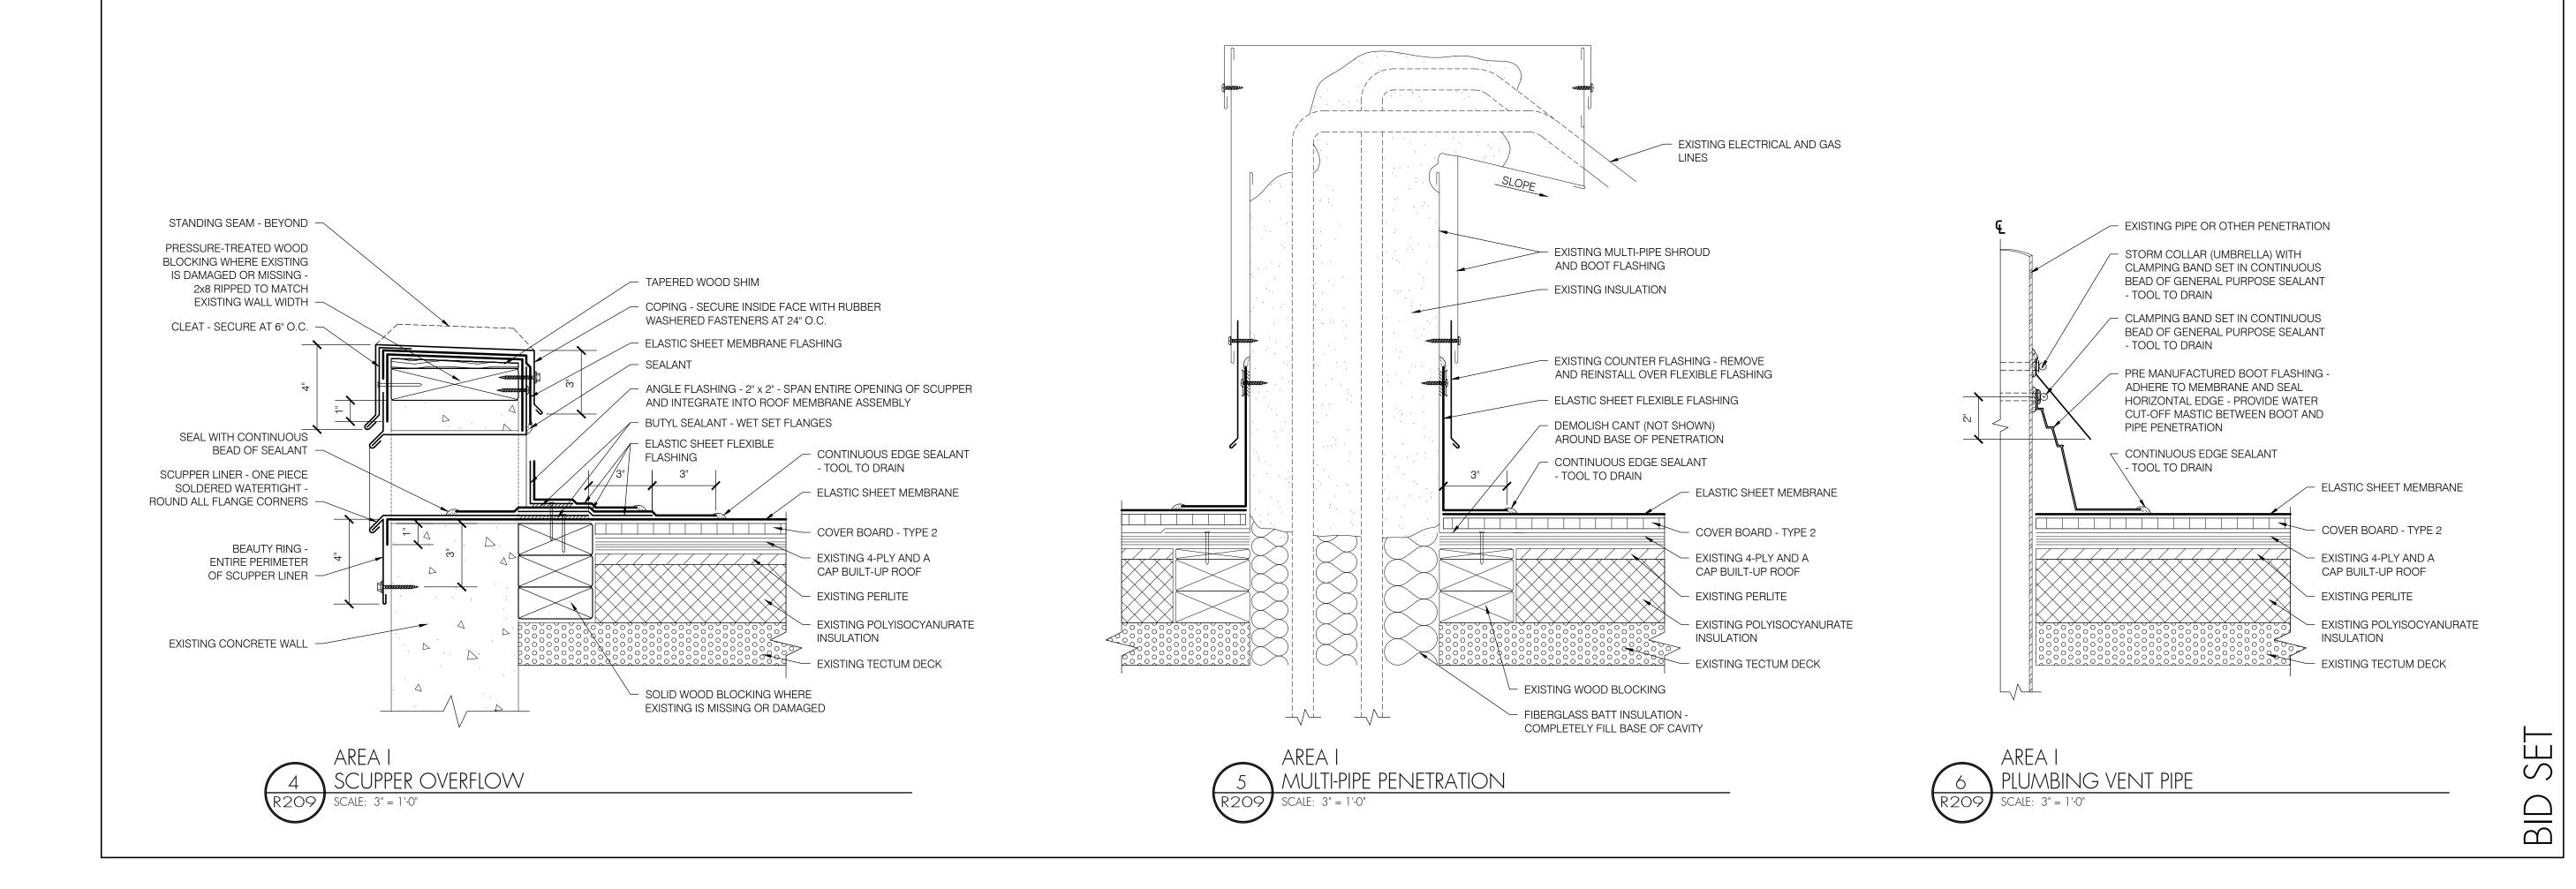
Date: NOVEMBER 10, 2021
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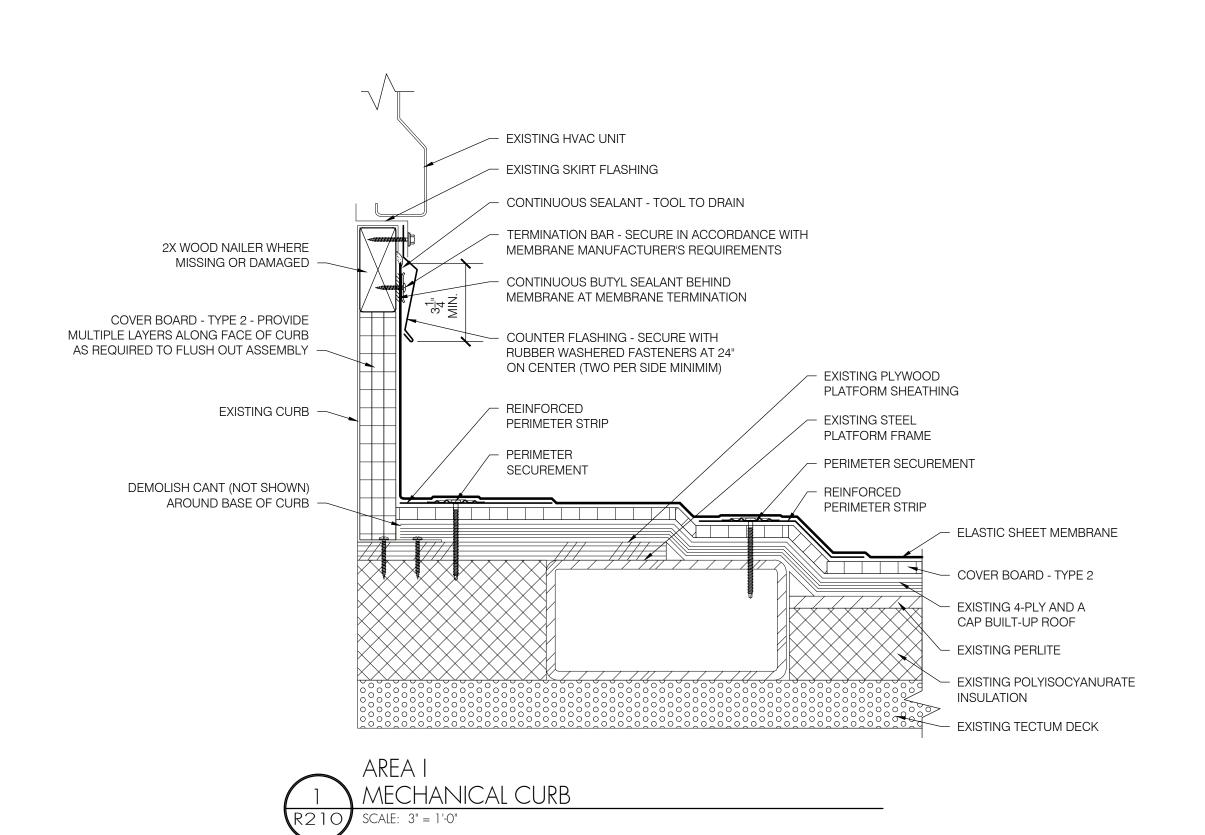





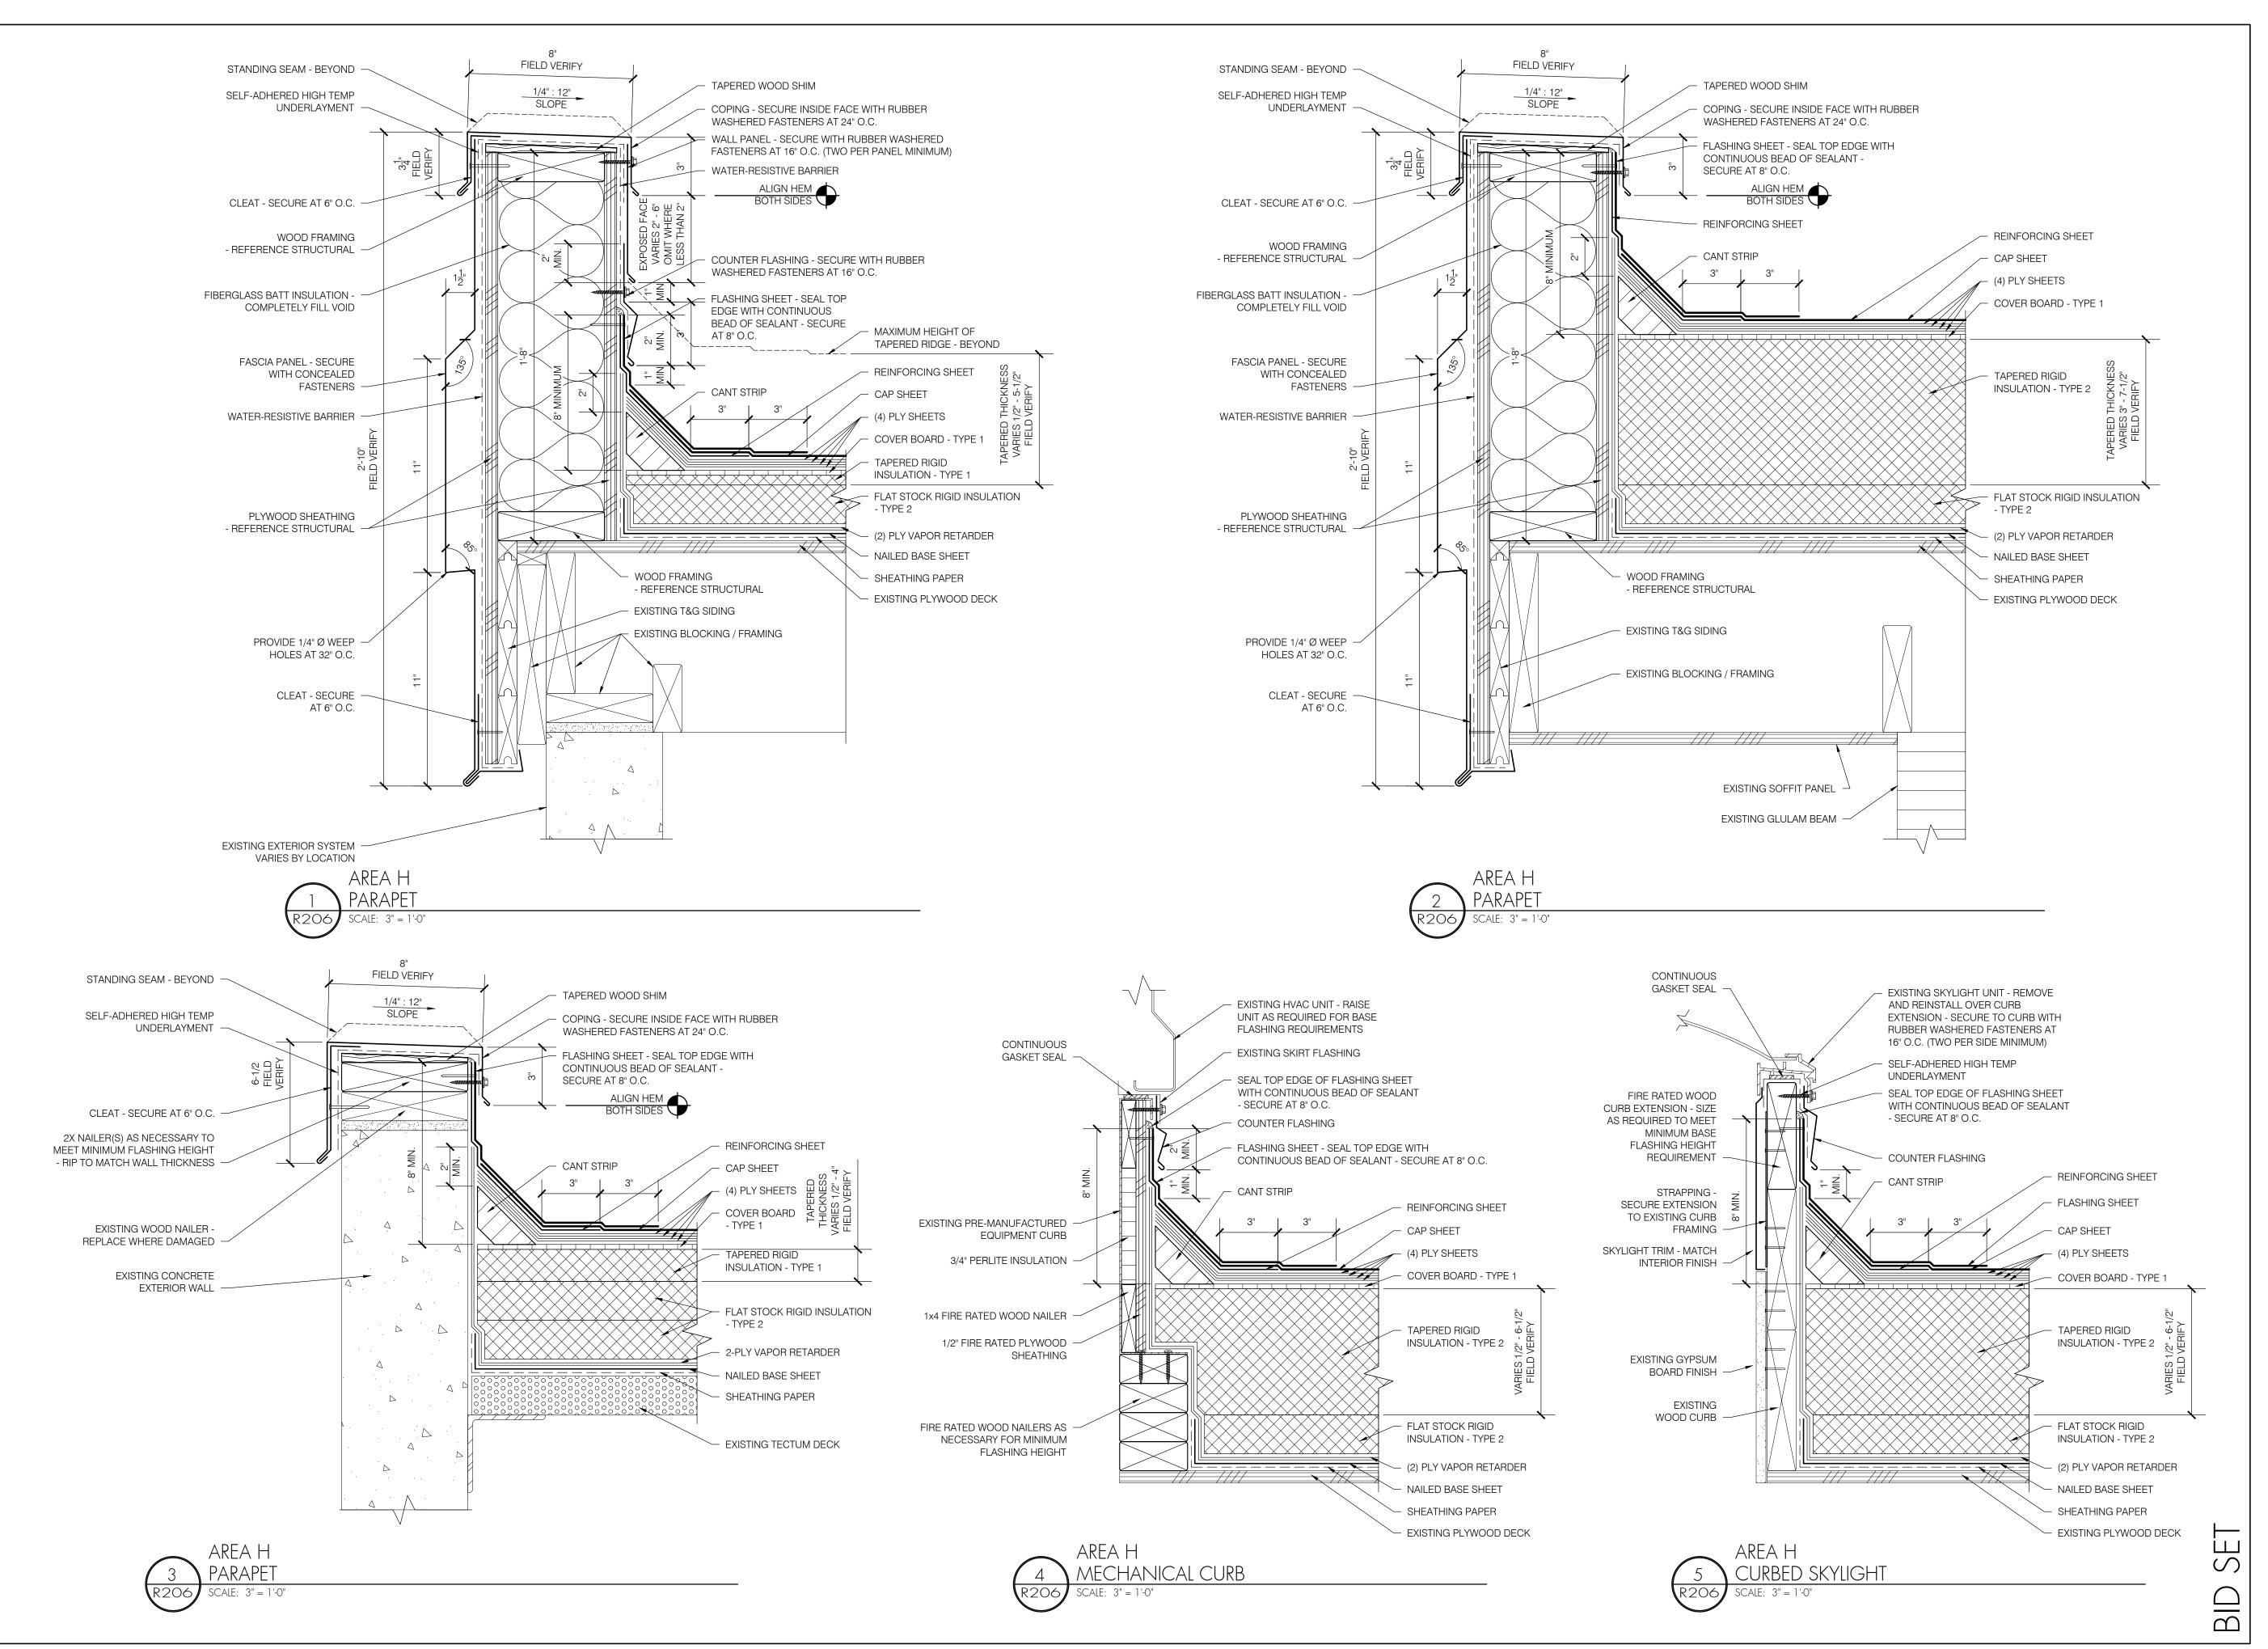

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DETAILS - AREA	1
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## **GENERAL STRUCTURAL NOTES:**

CONFORM TO THE 2018 INTERNATIONAL BUILDING CODE AS AMENDED BY THE 2019 OSSC, REFERENCED

**DESIGN CRITERIA** DESIGN WAS BASED ON THE STRENGTH AND DEFLECTION CRITERIA OF THE IBC. IN ADDITION TO THE DEAD

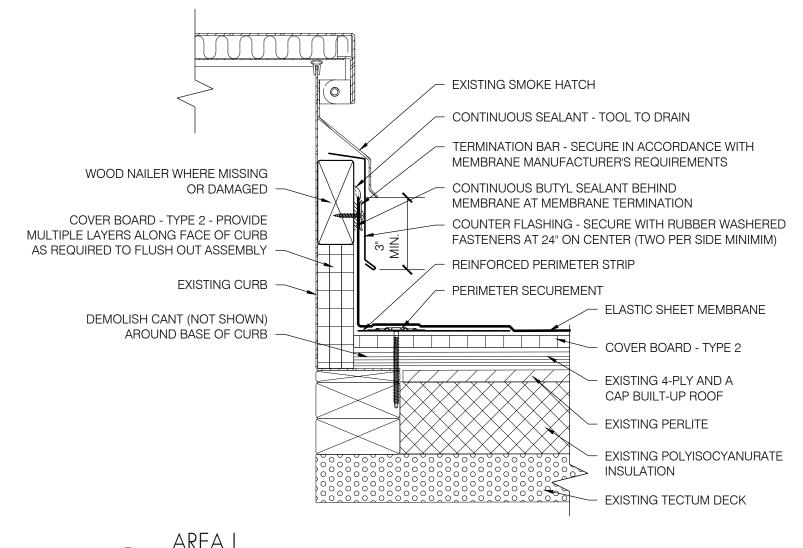LOADS, THE FOLLOWING LOADS WERE USED FOR DESIGN:

## GROUND SNOW LOAD Pg: 25 PSF FLAT-ROOF SNOW LOAD Pf: 25 PSF

SNOW EXPOSURE FACTOR Ce: 1.0

SNOW IMPORTANCE FACTOR Ic: 1.10 THERMAL FACTOR Ct: 1.0

## BASIC WIND SPEED (3-SEC GUST, ULTIMATE): 105 MPH

BUILDING CATEGORY: III WIND EXPOSURE: B

THE CONTRACTOR SHALL FIELD VERIFY ALL EXISTING CONDITIONS, DIMENSIONS AND ELEVATIONS. THE CONTRACTOR SHALL NOTIFY THE ENGINEER OF ANY DISCREPANCIES FROM CONDITIONS SHOWN ON THE DRAWINGS PRIOR TO THE START OF THE WORK.

## TEMPORARY CONDITIONS:

THE CONTRACTOR SHALL BE RESPONSIBLE FOR STRUCTURAL STABILITY OF THE NEW AND EXISTING STRUCTURES AND WALLS DURING CONSTRUCTION. THE STRUCTURE SHOWN ON THE DRAWINGS HAS BEEN DESIGNED FOR STABILITY UNDER THE FINAL CONFIGURATION ONLY.

CONCRETE EXPANSION ANCHORS SHALL BE "SIMPSON STRONG-BOLT 2" (OR ENGINEER APPROVED EQUIVALENT) INSTALLED PER MANUFACTURER'S GUIDELINES AND CURRENT ESR REPORT.

CONCRETE SCREW ANCHORS SHALL BE "SIMPSON TITEN-HD" (OR ENGINEER APPROVED EQUIVALENT) INSTALLED PER MANUFACTURER'S GUIDELINES AND CURRENT ESR REPORT.

SAWN LUMBER DESIGN IS BASED ON THE NATIONAL DESIGN SPECIFICATION, LATEST EDITION. SAWN LUMBER SHALL CONFORM TO WEST COAST LUMBER INSPECTION BUREAU OR WESTERN WOOD PRODUCTS ASSOCIATION GRADING RULES. UNLESS NOTED OTHERWISE ALL LUMBER SHALL BE 19% AT TIME OF FABRICATION AND DRIED TO A MAXIMUM OF 15% BEFORE INSTALLATION OF GYP. BOARD AND OF BRICK VENEER AND VERIFIED BY THE GENERAL CONTRACTOR. ALL WOOD IN PERMANENT CONTACT WITH CONCRETE OR CMU SHALL BE PRESSURE TREATED UNLESS AN APPROVED BARRIER IS PROVIDED. GRADES SHALL BE D.F. #2 UNLESS NOTED OTHERWISE

FRAMING ACCESSORIES AND STRUCTURAL FASTENERS SHALL BE MANUFACTURED BY SIMPSON STRONG-TIE COMPANY (OR ENGINEER APPROVED EQUAL) AND OF THE SIZE AND TYPE SHOWN ON THE DRAWINGS AND ATTACHED PER MANUFACTURER'S REQUIREMENTS AND RECOMMENDATIONS UNLESS NOTED OTHERWISE. HANGERS NOT SHOWN SHALL BE SIMPSON HU OF SIZE RECOMMENDED FOR MEMBER. ALL FRAMING NAILS SHALL BE COMMON NAILS. NO BOX NAILS ALLOWED. FASTENERS AND ACCESSORIES IN CONTACT WITH PRESERVATIVE TREATED WOOD MUST BE HOT DIPPED GALVANIZED OR HAVE ZMAX COATING. ALL FASTENERS IN CONTACT WITH FIRE RETARDANT LUMBER MUST BE HOT-DIPPED GALVANIZED. DO NOT INSTALL 0.148" x 1 1/2" NAILS IN HANGERS UNLESS SPECIFICALLY NOTED ON THE PLANS & DETAILS. NAIL CALLOUTS SHALL BE INTERPRETED AS FOLLOWS:

NAIL CALLOUT	DIAMETER	LENGTH
8d COMMON	0.131"	2 1/2"
10d COMMON	0.148"	3"
16d COMMON	0.162"	3 1/2"
164 CINIZED	0.140"	2 1/4"

0.131" 2 1/2" (RING SHANK AT DECK ROOF) ROOF SHEATHING NAILS

SHEATHING PANELS SHALL CONFORM TO THE REQUIREMENTS OF VOLUNTARY PRODUCT STANDARD PS 1 OR PS 2. OR APA PRP-108 PERFORMANCE STANDARDS. UNLESS NOTED, PANELS SHALL BE APA RATED SHEATHING, EXPOSURE 1, OF THE THICKNESS AND SPAN RATING SHOWN ON THE DRAWINGS. INSTALLATION SHALL BE IN CONFORMANCE WITH APA RECOMMENDATIONS. ALLOW 1/8" SPACING AT PANEL ENDS AND EDGES, UNLESS OTHERWISE RECOMMENDED BY THE PANEL MANUFACTURER.

ALL ROOF SHEATHING SHALL BE INSTALLED WITH FACE GRAIN PERPENDICULAR TO SUPPORTS, EXCEPT AS INDICATED ON THE DRAWINGS. ROOF SHEATHING SHALL EITHER BE BLOCKED, TONGUE-AND-GROOVE, OR HAVE EDGES SUPPORTED BY PLYCLIPS. NAILING NOT SPECIFICALLY IDENTIFIED ON THE DRAWINGS SHALL CONFORM TO IBC TABLE 2304.9.1.

ALL MISCELLANEOUS STEEL: ASTM A36 (Fy=36,000 PSI), OR AS NOTED ASTM A572 (Fy=50 KSI). CHANNELS: ASTM A572 (Fy = 50,000 PSI) OR ENGINEER APPROVED EQUAL.

ALL BOLTS: ASTM A307 UNLESS NOTED OTHERWISE.

WELDING: PER AWS STANDARDS. E70XX ELECTRODE AND BY CERTIFIED WELDERS. DESIGN, FABRICATION, AND ERECTION SHALL BE IN ACCORDANCE WITH THE "AISC SPECIFICATION FOR STRUCTURAL STEEL BUILDINGS". WELDING SHALL CONFORM TO THE AWS CODES FOR ARC AND GAS WELDING IN BUILDING CONSTRUCTION AND SHALL BE 3/16" MINIMUM UNLESS OTHERWISE NOTED. WELDING SHALL BE BY AWS CERTIFIED WELDERS. PRE-QUALIFIED WELDING PROCEDURES ARE TO BE USED, UNLESS AWS QUALIFICATION IS SUBMITTED TO THE ARCHITECT/ENGINEER PRIOR TO FABRICATION.

ALL STEEL TO HAVE SHOP COAT. ALL STEEL EXPOSED TO WEATHER SHALL BE HOT DIP GALVANIZED PER ASTM 123 FOR STRUCTURAL STEEL AND ASTM 153 FOR BOLTS AND HARDWARE. FABRICATION OF STEEL THAT IS TO BE HOT DIP GALVANIZED SHALL ALSO MEET ASTM A385. REPAIR OF DAMAGED GALVANIZED COATING SHALL BE MADE WITH PRODUCTS MEETING ASTM A780 AND AS A MINIMUM SHALL BE 50% GREATER IN THICKNESS THAN THE SURROUNDING GALVANIZING.

SPECIAL INSPECTIONS: IN ACCORDANCE WITH SECTION 1704 OF THE IBC AND APPLICABLE SECTIONS OF THE PROJECT SPECIFICATIONS. SPECIAL INSPECTIONS ARE TO BE PERFORMED BY AN INDEPENDENT TESTING LABORATORY EMPLOYED BY THE OWNER FOR THE AREAS INDICATED BELOW:

- 1. FILLET WELDING (PERIODIC)
- 2. POST-INSTALLED ANCHORS (PERIODIC)

THE CONTRACTOR AND SPECIAL INSPECTOR SHALL NOTIFY THE ENGINEER OF RECORD OF ANY ITEM NOT COMPLYING WITH THE PROJECT SPECIFICATIONS AND/OR APPLICABLE CODES BEFORE PROCEEDING WITH ANY WORK INVOLVING THAT ITEM. THE ENGINEER OF RECORD WILL REVIEW THE ITEM AND DETERMINE ACCEPTABILITY. IF WORK INVOLVING THAT ITEM PROCEEDS WITHOUT THE APPROVAL OF THE ENGINEER OF RECORD THEN THE WORK WILL BE CONSIDERED NON-COMPLIANT.

THE CONTRACTOR SHALL COORDINATE SEISMIC RESTRAINTS OF ELECTRICAL EQUIPMENT, MECHANICAL, PLUMBING, FIRE SPRINKLER, MACHINERY, AND ASSOCIATED PIPING WITH THE STRUCTURE. ANY CONNECTIONS TO STRUCTURE NOT CONFORMING TO SHEET METAL AND AIR CONDITIONING CONTRACTORS NATIONAL ASSOCIATION (SMACNA), OR SPECIFICALLY DETAILED ON THE MECHANICAL ENGINEER'S DRAWINGS, SHALL BE DESIGNED IN ACCORDANCE OF THESE GENERAL NOTES, BY AN ENGINEER REGISTERED IN THE STATE OF WASHINGTON, AND SHALL BE SUBMITTED TO THE ENGINEER PRIOR TO FABRICATION.

## **FLASHING AND WATERPROOFING:**

ALL FLASHING AND WATERPROOFING SHALL BE PER PROFESSIONAL ROOF CONSULTANTS UNLESS NOTED OTHERWISE ON THE PLANS.

## WIND LOAD DIAGRAM:

THIS WIND LOAD DIAGRAM IS BEING PROVIDED FOR USE BY THE ROOFING CONTRACTOR TO DETERMINE APPROPRIATE MEANS OF SECURING ROOFING COMPONENTS. ATTACHMENT METHOD, ANCHOR SELECTION, SPACING OF FASTENERS, AND VERIFICATION OF THE EXISTING SUBSTRATE AS SUITABLE FOR THE ATTACHMENT METHOD IS BEYOND THE SCOPE OF TM RIPPEY CONSULTING ENGINEERS WORK AND IS THE SOLE RESPONSIBILITY OF THE INSTALLER.

## **FALL PROTECTION GENERAL STRUCTURAL NOTES:**

## **CODE REQUIREMENTS:**

- 1. CONFORM TO THE 2018 INTERNATIONAL BUILDING CODE AS AMENDED BY THE 2019 OREGON STRUCTURAL SPECIALTY CODE, REFERENCED HEREAFTER AS IBC.
- 2. CONFORM TO OREGON OSHA STANDARDS FOR THE CONSTRUCTION INDUSTRY SUBPART M (FALL PROTECTION) AND ALL APPLICABLE STATE ADMINISTRATIVE CODE SAFETY STANDARDS.
- 3. CONFORM TO ANSI/ASSE Z359 AMERICAN NATIONAL
- STANDARD, CURRENT EDITION.

## **SYSTEM REQUIREMENTS:**


- 1. INDIVIDUAL ANCHORS SHALL BE USED FOR A MAXIMUM OF ONE PERSON IN FALL ARREST OR FALL RESTRAINT.
- 2. PERSONAL FALL ARREST SYSTEMS (PFAS) SHALL BE LIMITED TO FULL BODY HARNESSES THAT LIMIT THE MAXIMUM FALL ARREST LOAD TO 900 LBS.
- 3. ANCHORS ARE TO BE USED ONLY BY PERSONS TRAINED IN THEIR USE. LANYARDS, SAFETY HARNESSES, ATTACHMENTS, AND ALL OTHER PERSONAL SAFETY DEVICES ATTACHED TO THE ANCHOR ARE THE SOLE RESPONSIBILITY OF THE USER AND NOT TM RIPPEY CONSULTING ENGINEERS.
- 4. ANCHORS ARE TO BE VISUALLY INSPECTED BY THE USER PRIOR TO EACH USE.
- 5. ANCHORS ARE TO BE INSPECTED ANNUALLY BY A 'QUALIFIED PERSON'.
- 6. ANCHORS SHALL BE RE-CERTIFIED BY A 'COMPETENT PERSON' WHEN RE-ROOFING OR RENOVATION OR AT PERIODS NOT TO EXCEED 10 YEARS.
- 7. THE SYSTEM USER IS TO MAINTAIN A LOG BOOK OF USE AND INSPECTION.
- 8. FALL PROTECTION SYSTEMS SERVING ROOF EDGES WITH INSUFFICIENT HEIGHT FOR FALL ARREST CLEARANCE SHALL BE CLEARLY IDENTIFIED AS 'FALL RESTRAINT' ONLY.

ULTIMATE ANCHOR LOAD: 5000 LB

ALLOWABLE LOAD: 310 LB (PER PERSON, COMBINED BODY WEIGHT

1. SINGLE POINT FALL ARREST ANCHORS - 'GUARDIAN CB18 (DBI-SALA AT AREA 'I')', OR EQUIVALENT APPROVED BY THE ENGINEER.

- 1. INSTALL IN ACCORDANCE WITH APPROVED DRAWINGS AND MANUFACTURER'S INSTRUCTIONS.
- 2. PROVIDE SPECIAL INSPECTION OF INSTALLATION BY A CERTIFIED INDEPENDENT TESTING LABORATORY EMPLOYED BY THE OWNER.

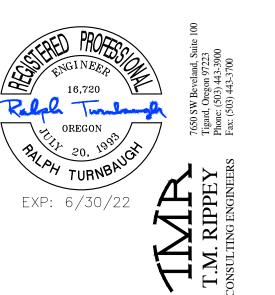



SHEET	TITLE

GENERAL STRUCTURAL NOTES AND FALL PROTECTION STRUCTURAL NOTES

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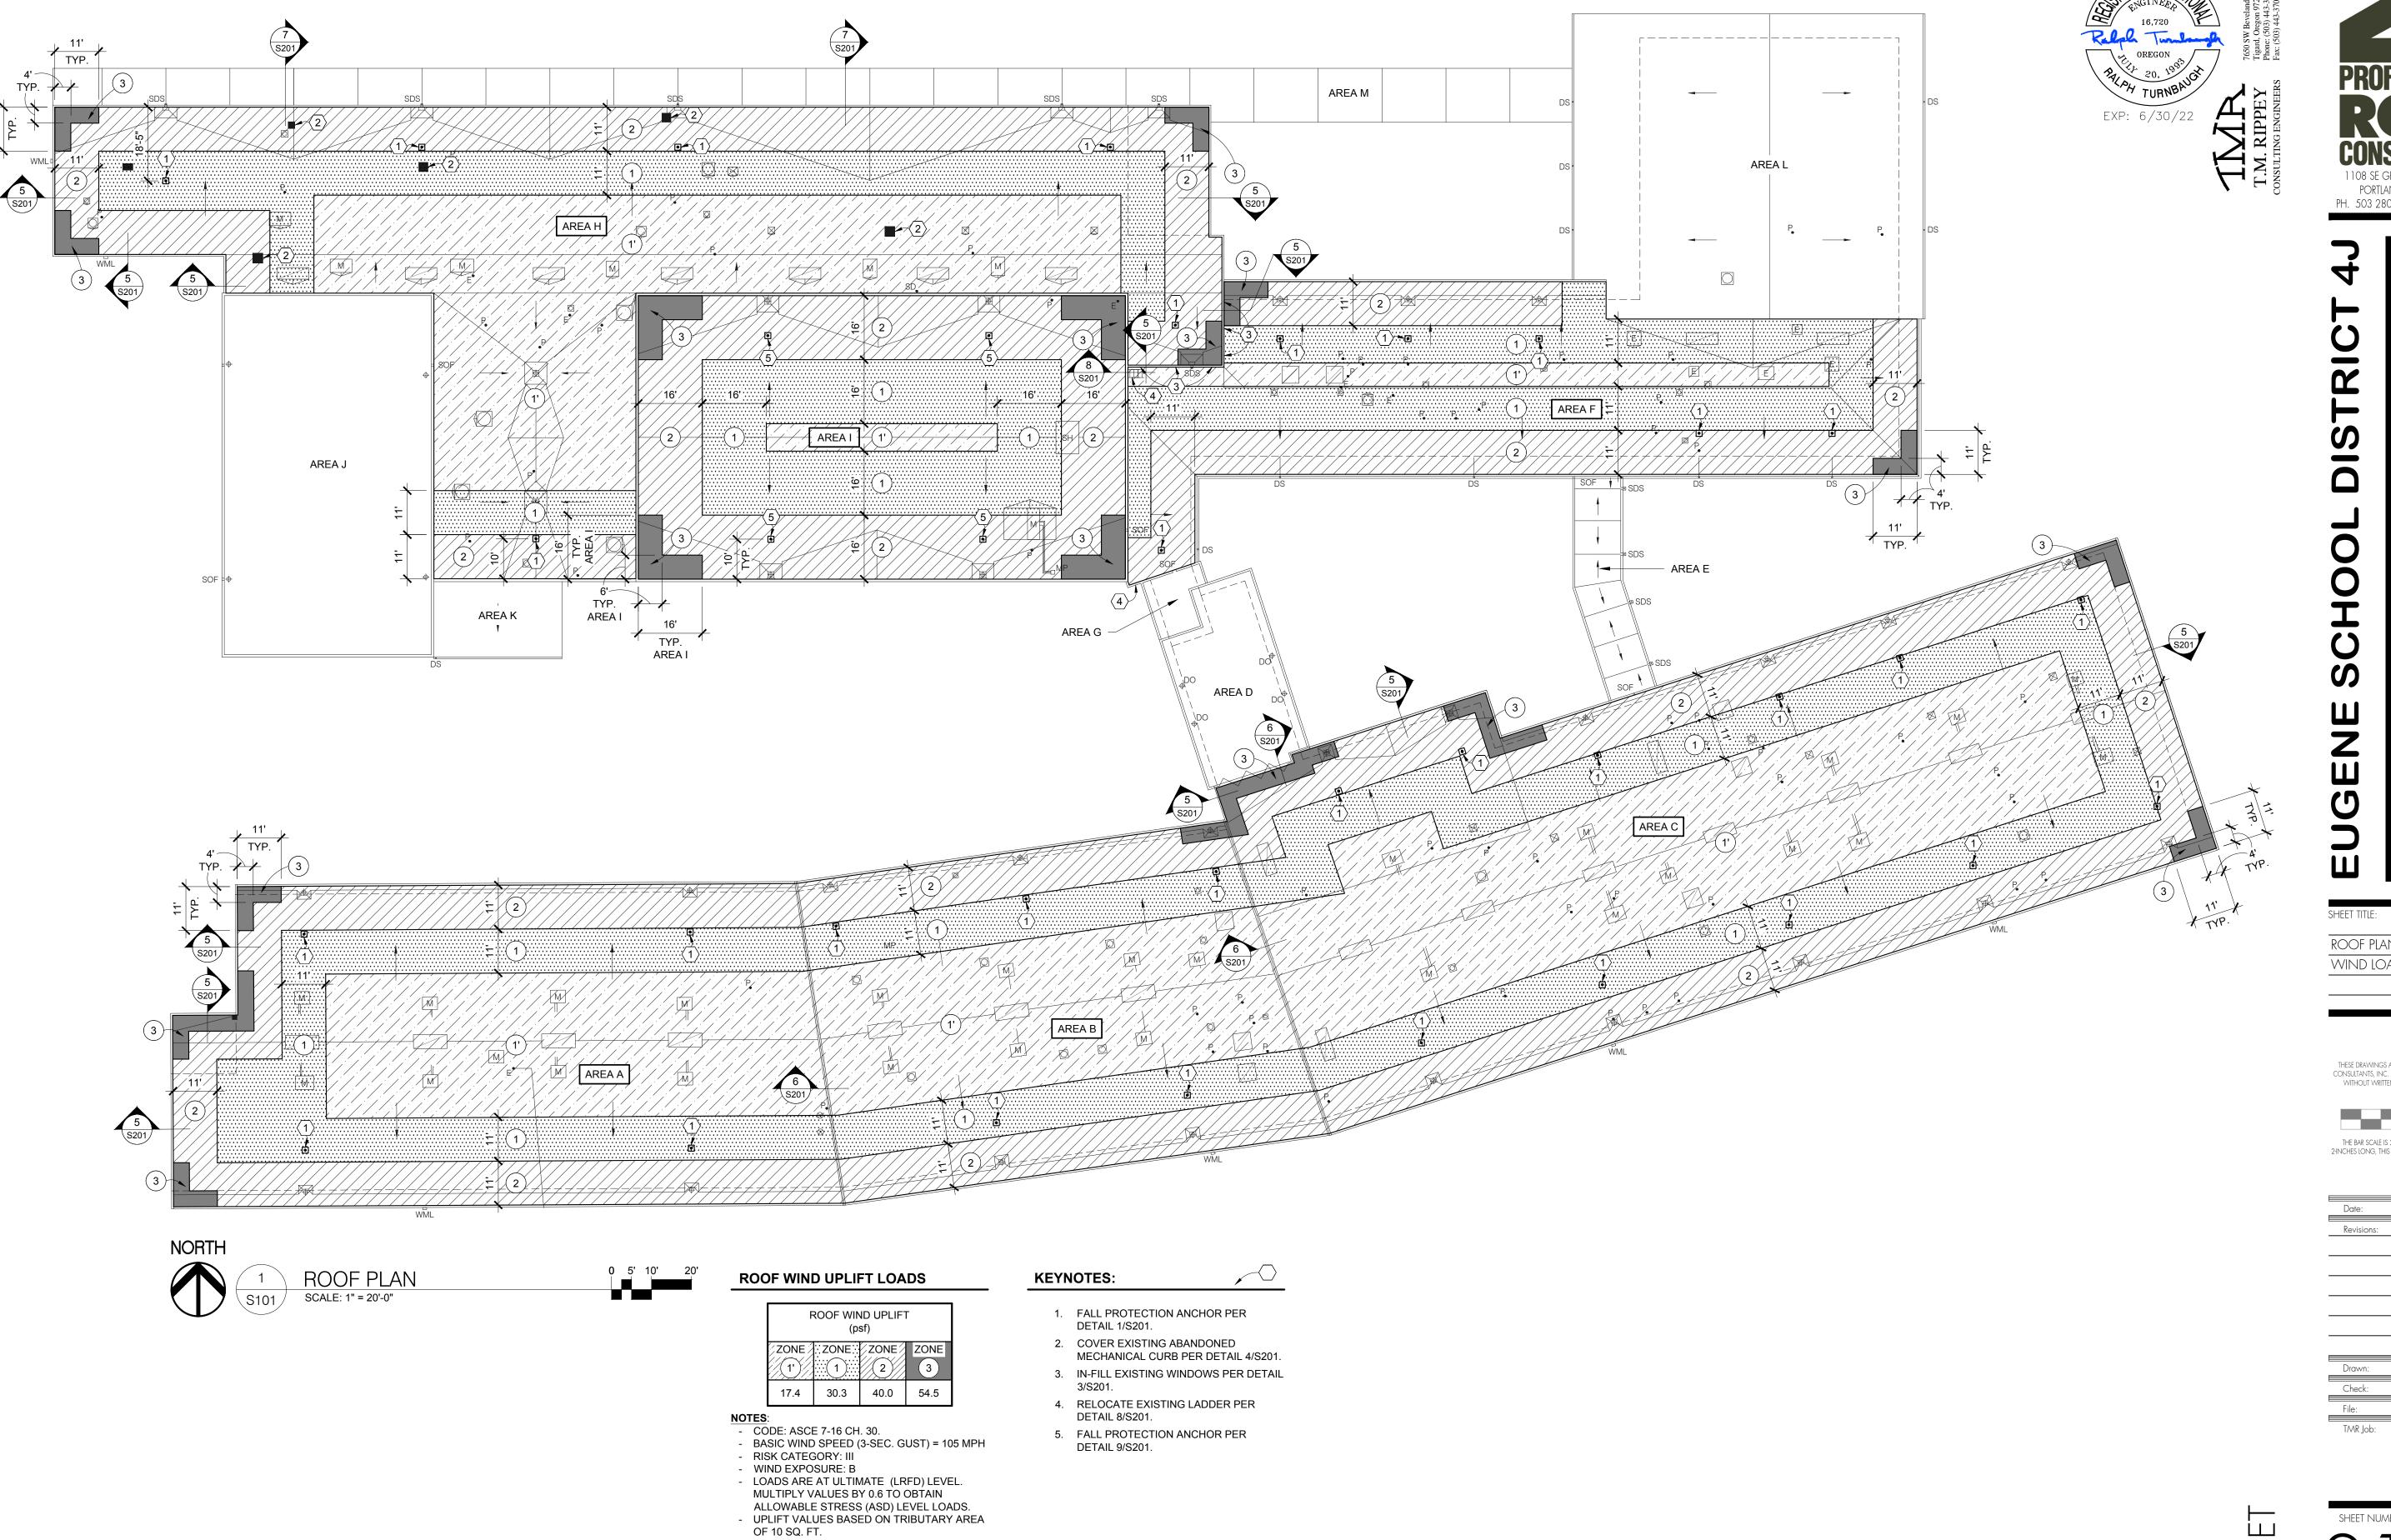


THE BAR SCALE IS 2-INCHES IN LENGTH. IF THE BAR IS NOT 2-INCHES LONG, THIS DRAWING IS NOT TO THE SCALE INDICATED.

Date:	MAY 31, 2021
Revisions:	
Drawn:	JSC
Check:	JH / RNT
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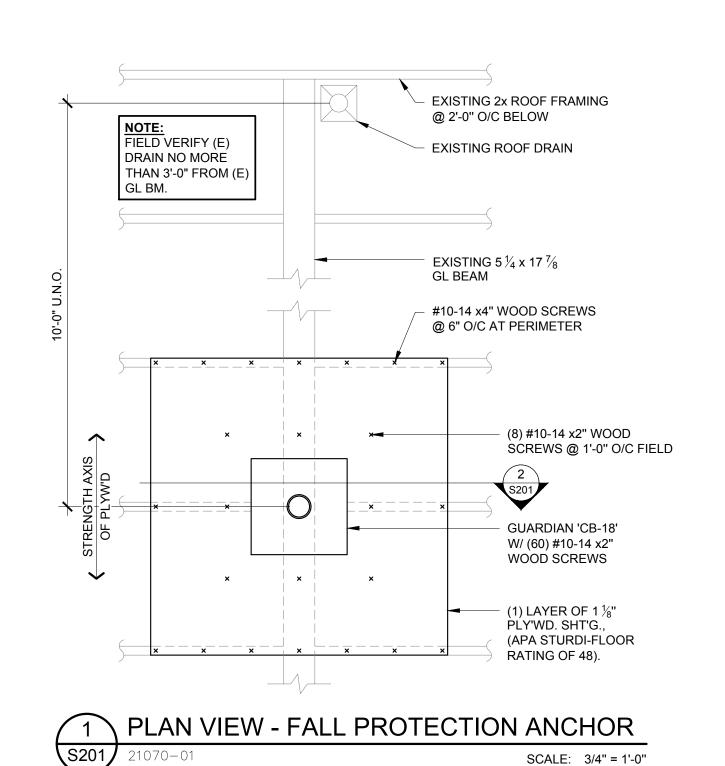



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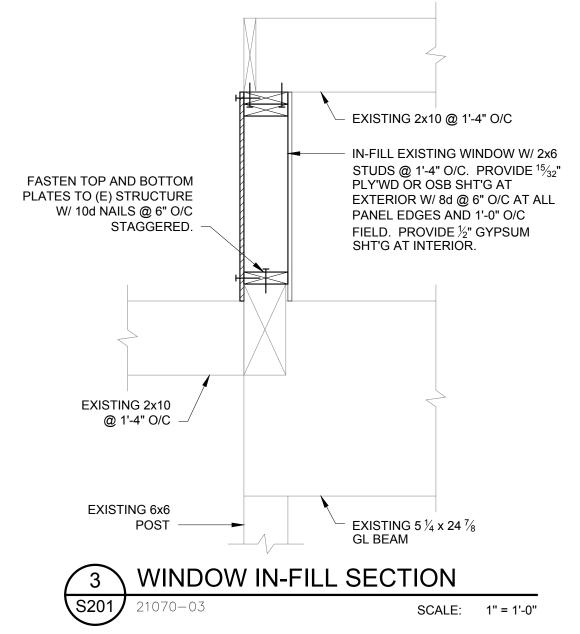
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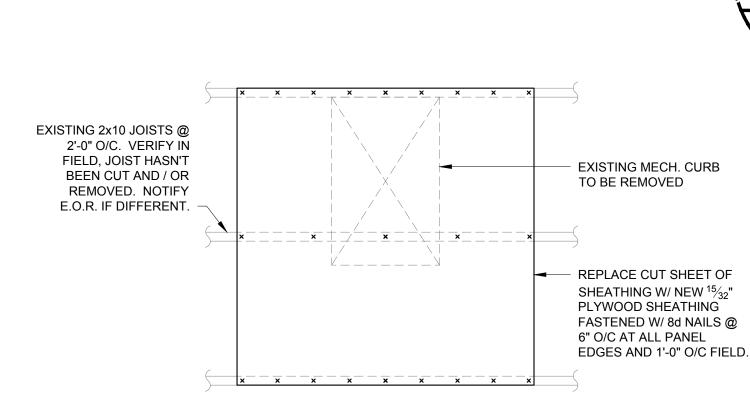
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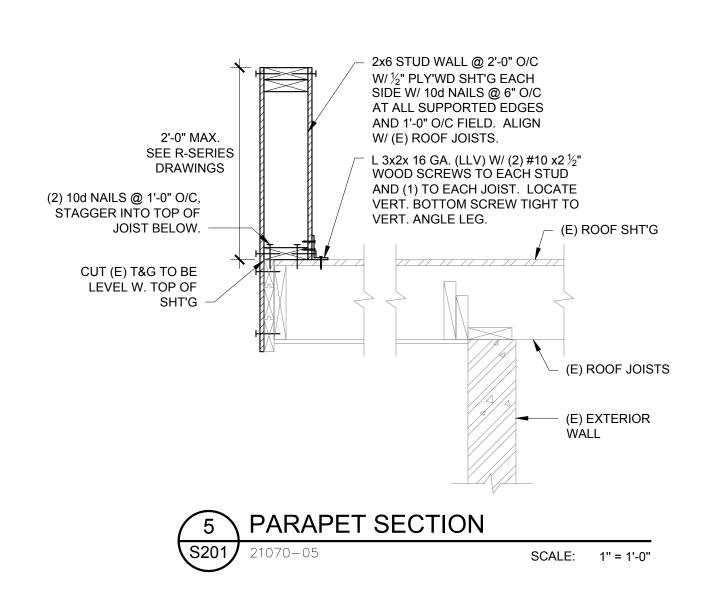






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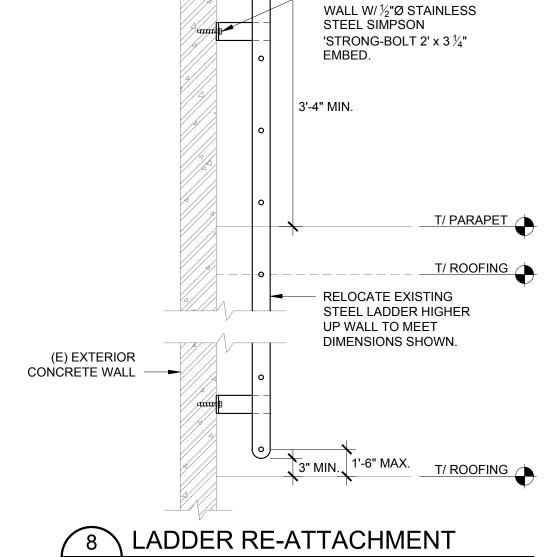
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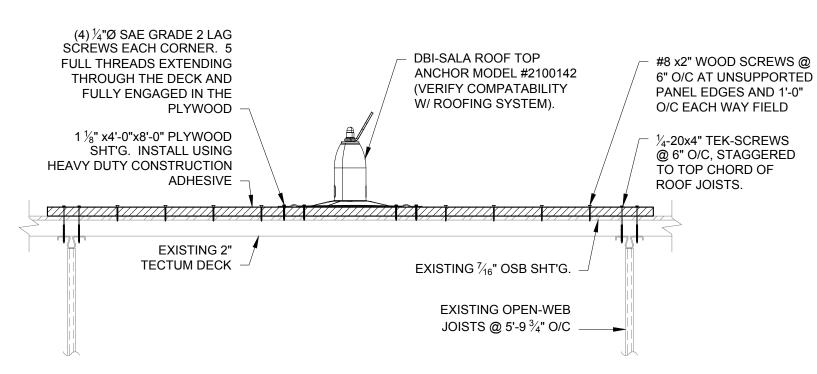






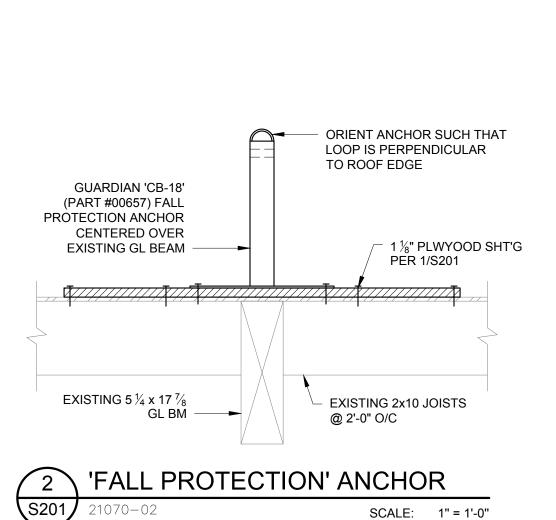

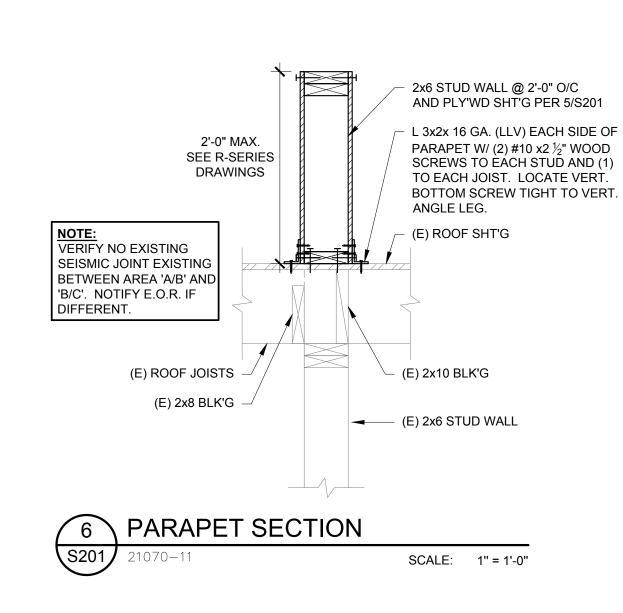

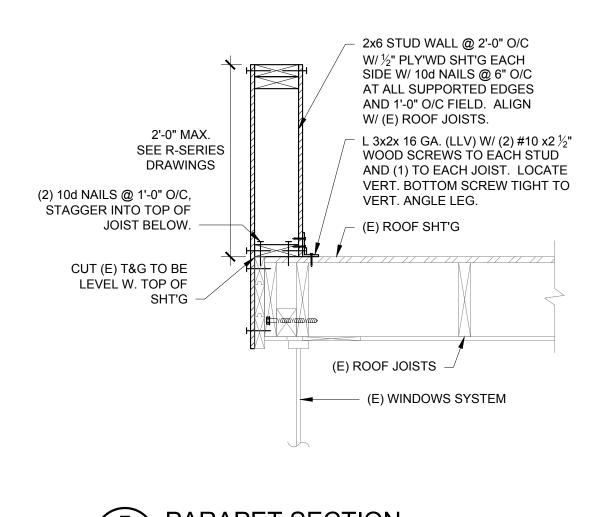





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21070

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STRUCTURAL DETAILS

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MAY 31, 2021

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