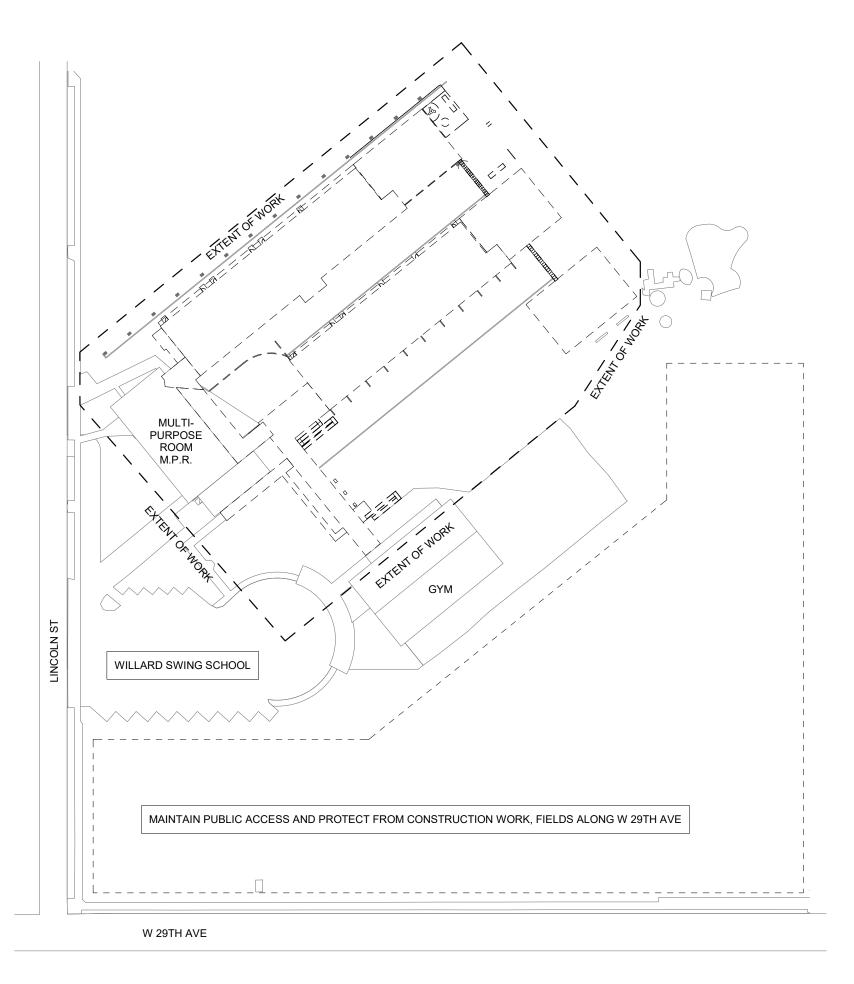
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4J WILLARD SWING SCHOOL **4J SCHOOL DISTRICT**

2840 LINCOLN STREET EUGENE, OR 97405

DEMOLITION SET

09.26.2019

PROJECT TEAM

<u>OWNER</u>

EUGENE SCHOOL DISTRICT 4J 715 WEST 4[™] AVE. EUGENE, OR, 97402 PHONE: (541) 790 7417 CONTACT: GLEN MACDONALD

ARCHITECT

PIVOT ARCHITECTURE PC 44 WEST BROADWAY, SUITE 300 EUGENE, OR 97401 PHONE: (541) 342-7291 FAX: (541) 342-1535 CONTACT: JÓHN STAPLETON, AIÁ

STRUCTURAL ENGINEER

HOHBACH-LEWIN, INC 296 EAST 5TH AVE. SUITE 302 EUGENE, OR 97401 PHONE: (541)-349-1701 CONTACT: VIKKI BOURCIER, S.E.

<u>CIVIL ENGINEER</u>

KPFF EUGENE CIVIL + SURVEY 800 WILLAMETTE STREET SUITE 400 EUGENE, OR 97401 PHONE: (541) 684 4902 CONTACT: ANNA BACKUS, PE

MECHANICAL/PLUMBING ENGINEER

SYSTEM WEST ENGINEERS 725 A STREET SPRINGFIELD, OR 97477 PHONE: (541) 342 7210 CONTACT: STEVEN J. SAVICH, CPD, LEED AP

ELECTRICAL ENGINEER

SYSTEM WEST ENGINEERS 725 A STREET SPRINGFIELD, OR 97477 PHONE: (541) 342 7210 CONTACT: JOSE GUERRERO





DEMOLITION SET	4J WILLARD SWING SCHOOL	4J SCHOOL DISTRICT 2840 LINCOLN STREET EUGENE, OR 97405
	T TITLE: LE SHEE	T
REVIS #	BIONS: DESCRP.	DATE

ISSUE DATE: 09.26.2019

TITLE

PROJECT GENERAL NOTES

SPACE FOR COLUMN OF INDEX OF GENERAL LEGAL COMMENTS

(SPACE FOR COLUMN 1)

(SPACE FOR COLUMN 2)

ABBREVIATIONS

ARCHITECTURAL SYMBOLS

						GENERAL
) B C COUS CT	AT ANCHOR BOLT ASPHALTIC CONCRETE ACOUSTIC ACOUSTICAL TILE CEILING SYSTEM	A201 ■ 3	BUILDING ELEVATION	—X—	FLOOR MATERIAL TRANSITION	TIT G0 CIVIL DM
FF LUM LDG	ABOVE FINISH FLOOR ALUMINUM BUILDING	_				DM: DM: DEMOLITION
O B FCI J L	BOTTOM OF CATCH BASIN CONTRACTOR FURNISHED/CONTRACTOR INSTALLED CONTROL JOINT CENTER LINE	A541	INTERIOR ELEVATION	ROOM NAME	ROOM NAME & NUMBER	D0 D0 D0 D0
LG LR MU OL ONC	CEILING CLEAR CONCRETE MASONRY UNIT COLUMN CONCRETE	1 (A101)	BUILDING SECTION	×00	WINDOW SYMBOL	MECHANICA M0 M0 M1 M1
ONT PT BL	CONTINUOUS CARPET DOUBLE					PLUMBING P0
EMO E AG A SP	DEMOLITION/DEMOLISH DOUGLAS FIR, DRINKING FOUNTAIN DIAGONAL DIAMETER DISPENSER				STOREFRONT SYMBOL	P0 P1 ELECTRICAL E1
N S TL WG	DOWN DOWNSPOUT DETAIL DRAWING EXISTING	(A101)	WALL SECTION	101A	DOOR SYMBOL	
) A J LEC Q	EACH EXPANSION JOINT ELEVATION ELECTRICAL EQUAL		DETAIL SECTION	(20'-0")	CEILING HEIGHT SYMBOL	
	EACH WAY EXTERIOR FLOOR DRAIN FIRE EXTINGUISHER FIRE EXTINGUISHER CABINET		- TYP	\bullet	VERTICAL ELEVATION	
E N R	FINISH FLOOR ELEVATION FINISH FLOOR FINISH/FINISHED FLOOR FACE OF					
F P G B	FACE OF FINISH FIBER REINFORCED PANEL FOOTING GAUGE GRAB BAR GLUE LAM BEAM		DETAIL CALLOUT	нн	INTERIOR WALL TYPE WITH NO SOUND ATTENUATION	
P BD F RIZ	GYPSUM BOARD GYPSUM BOARD HEIGHT HORIZONTAL HANDRAIL	05 5000-A —	SPECIFICATION KEYNOTE*	(HH)	INTERIOR WALL TYPE WITH SOUND	
1 SUL F	HOLLOW METAL INSULATION INTERIOR JOINT		NOT LINKED TO A SPECIFIC SPEC ITEM		ATTENUATION	
V C X CH	KNOCK DOWN LAVATORY LOCATION MAXIMUM MECHANICAL		KEYNOTE	100 XXX/XXX XXX/XXX XXX/XXX	ROOM FINISH TAG	
R N SC L S	MANUFACTURER MINIMUM MISCELLANEOUS METAL NOT TO SCALE	P - 1	FINISH TAG		FIRE EXTINGUISHER	
CI	ON CENTER OUTSIDE DIMENSION OWNER FURNISHED CONTRACTOR INSTALLED OWNER FURNISHED OWNER INSTALLED	###.#	CASEWORK	EXIT		
S I VNG VP	OUTSIDE FACE OF STUD OPPOSITE HAND OPENING OPPOSITE PANEL JOINT	xxx xxx	REVISION TAG	X	EXIT SIGN	
AM D	PLASTIC LAMINATE PAINT SYSTEM PRESSURE TREATED PAINTED PLYWOOD	<u> </u>	COLUMN CENTERLINE	ADA	DOOR ACTUATOR	
W	RADIUS RUBBER BASE ROOF DRAIN ROOM ROUGH OPENING RIGHT OF WAY	<u> </u>	EXISTING COLUMN CENTERLINE	T	TEMPERED GLAZING	
B L CT T	RUBBER REVEAL STORM DRAIN SECTION SHEET	AC	ACCESS CONTROL	SLOPE 4:12	SLOPE ARROW (SLOPE AS INDICATED)	
I ECS FT, SF STL D	SIMILAR SPECIFICATIONS SQUARE FOOT STAINLESS STEEL STANDARD			7.12		
L RUC B G	STANDARD STEEL STRUCTURAL TEMPERED TOP & BOTTOM TONGUE AND GROOVE	WALL FILL PATTER	RNS:	GENERAL NC	TES - DIM. PLANS	
EMP))C	TEMPORARY TOP OF TOP OF CONCRETE		EXISTING WALL ASSEMBLY			
)W)S (P 10	TOP OF WALL TOP OF STRUCTURE TYPICAL UNLESS NOTED OTHERWISE		NON FIRE-RATED WALL ASSEMBLY		1' - 6" (PULL SIDE) MIN. CLEAR	
Y = 4	VERIFY VERIFY IN FIELD WALL ASSEMBLY		NON FIRE-RATED WALL ASSEMBLY			
)	WITH WOOD WATER PROOF		1-HOUR FIRE-RATED WALL	5" PREFERRED	3' - 0" FO 1' - 0" (PUSH SIDE) MIN.	
		······		4" MIN	CLEAR IF DOOR HAS CLOSER AND LATCH	

2-HOUR FIRE-RATED WALL

FIXED OBSTRUCTION, SHALL BE LOCATED AS SHOWN ABOVE. B. OTHER LOCATIONS SHALL BE ON CENTERLINE OF ROOM OR AS SPECIFICALLY DIMENSIONED.

SHEET INDEX

TITLE SHEET GENERAL INFORMATION

CIVIL DEMOLITION NOTES UTILITY DEMOLITION PLAN SITE RESTORATION PLAN

DEMOLITION SLAB AND SIDEWALK PLAN DEMOLITION BUILDING PLAN DEMOLITION ROOF PLAN DETAILS

LEGEND, GENERAL NOTES & SHEET INDEX DEMOLITION SITE PLAN - BELOW GRADE DEMOLITION SITE PLAN - 1ST FLOOR DEMOLITION SITE PLAN - ROOF LEVEL

LEGEND, GENERAL NOTES & SHEET INDEX DEMOLITION SITE PLAN - BELOW GRADE DEMOLITION SITE PLAN - 1ST FLOOR

DEMOLITION SITE PLAN





CLOSER AND LATCH A. DOORS SHOWN ADJACENT TO A FLANKING WALL OR OTHER

DEMOLITION SET	4J WILLARD SWING SCHOOL	4J SCHOOL DISTRICT 2840 LINCOLN STREET EUGENE, OR 97405
GEI	T TITLE: NERAL ORMATI	ON
REVIS #	DESCRP.	DATE
ISSUE	DATE: 09.26	5.2019

G001

GENERAL NOTES

- SURVEY PROVIDED BY BAKER AND ASSOCIATES, DATED JUNE 14, 2019. ELEVATIONS ARE BASED ON CITY OF EUGENE VERTICAL DATUM ESTABLISHED PER BENCH MARK NO. SE0499, A BRASS CAP LOCATED AT THE NW CORNER OF WEST 29TH AVENUE AND LINCOLN AVENUE WITH AN ELEVATION OF 464.67' (NAVD88).
- CONSTRUCTION LAYOUT (ALL ACTUAL LINES AND GRADES) SHALL BE STAKED BY A PROFESSIONAL SURVEYOR, REGISTERED IN THE STATE OF OREGON, BASED ON COORDINATES, DIMENSIONS, BEARINGS, AND ELEVATIONS, AS SHOWN, ON THE PLANS.
- 3. PROJECT CONTROL SHALL BE FIELD VERIFIED AND CHECKED FOR RELATIVE HORIZONTAL POSITION PRIOR TO BEGINNING CONSTRUCTION LAYOUT.
- 4. PROJECT CONTROL SHALL BE FIELD VERIFIED AND CHECKED FOR RELATIVE VERTICAL POSITION BASED ON THE BENCHMARK STATED HEREON, PRIOR TO BEGINNING CONSTRUCTION LAYOUT.
- 5. WHEN DIMENSIONS AND COORDINATE LOCATIONS ARE REPRESENTED DIMENSIONS SHALL HOLD OVER COORDINATE LOCATION. NOTIFY THE CIVIL ENGINEER OF RECORD IMMEDIATELY UPON DISCOVERY OF ANY DISCREPANCIES.
- 6. BUILDING SETBACK DIMENSIONS FROM PROPERTY LINES SHALL HOLD OVER ALL OTHER CALLOUTS. PROPERTY LINES AND ASSOCIATED BUILDING SETBACKS SHALL BE VERIFIED PRIOR TO CONSTRUCTION LAYOUT.
- 7. CONTRACTOR SHALL PRESERVE AND PROTECT FROM DAMAGE ALL EXISTING MONUMENTATION DURING CONSTRUCTION. THE CONTRACTOR IS RESPONSIBLE FOR COORDINATING AND PAYING FOR THE REPLACEMENT OF ANY MONUMENTS DAMAGED OR REMOVED DURING CONSTRUCTION. NEW MONUMENTS SHALL BE REESTABLISHED BY A LICENSED SURVEYOR.
- 8. ALL CONSTRUCTION AND MATERIALS SHALL CONFORM TO THESE PLANS, THE PROJECT SPECIFICATIONS AND THE APPLICABLE REQUIREMENTS OF THE 2018 OREGON STANDARD SPECIFICATIONS FOR CONSTRUCTION, THE 2017 OREGON PLUMBING SPECIALTY CODE AND REQUIREMENTS OF THE CITY OF EUGENE.
- 9. THE COMPLETED INSTALLATION SHALL CONFORM TO ALL APPLICABLE FEDERAL, STATE, AND LOCAL CODES, ORDINANCES AND REGULATIONS. ALL PERMITS, LICENSES AND INSPECTIONS REQUIRED BY THE GOVERNING AUTHORITIES FOR THE EXECUTION AND COMPLETION OF WORK SHALL BE SECURED BY THE CONTRACTOR PRIOR TO COMMENCING CONSTRUCTION.
- 10. ATTENTION: OREGON LAW REQUIRES YOU TO FOLLOW RULES ADOPTED BY THE OREGON UTILITY NOTIFICATION CENTER. THOSE RULES ARE SET FORTH IN OAR 952-001-0010 THROUGH OAR 952-001-0090. YOU MAY OBTAIN COPIES OF THE RULES BY CALLING THE CENTER. (NOTE: THE TELEPHONE NUMBER FOR THE OREGON UTILITY NOTIFICATION CENTER IS (503) 232-1987). EXCAVATORS MUST NOTIFY ALL PERTINENT COMPANIES OR AGENCIES WITH UNDERGROUND UTILITIES IN THE PROJECT AREA AT LEAST 48 BUSINESS-DAY HOURS, BUT NOT MORE THAN 10 BUSINESS DAYS PRIOR TO COMMENCING AN EXCAVATION, SO UTILITIES MAY BE ACCURATELY LOCATED.
- 11. THE LOCATION OF EXISTING UNDERGROUND UTILITIES SHOWN ON THE PLANS ARE FOR INFORMATION ONLY AND ARE NOT GUARANTEED TO BE COMPLETE OR ACCURATE. CONTRACTOR SHALL VERIFY ELEVATIONS, PIPE SIZE, AND MATERIAL TYPES OF ALL UNDERGROUND UTILITIES PRIOR TO COMMENCING WITH CONSTRUCTION AND SHALL BRING ANY DISCREPANCIES TO THE ATTENTION OF KPFF CONSULTING ENGINEERS, 72 HOURS PRIOR TO START OF CONSTRUCTION TO PREVENT GRADE AND ALIGNMENT CONFLICTS.
- 12. THE ENGINEER OR OWNER IS NOT RESPONSIBLE FOR THE SAFETY OF THE CONTRACTOR OR HIS CREW. ALL O.S.H.A. REGULATIONS SHALL BE STRICTLY ADHERED TO IN THE PERFORMANCE OF THE WORK.
- 13. TEMPORARY AND PERMANENT EROSION CONTROL MEASURES SHALL BE IMPLEMENTED. THE CONTRACTOR SHALL ADHERE TO CITY OF EUGENE FOR MINIMUM EROSION CONTROL MEASURES. THE ESC FACILITIES SHOWN IN THESE PLANS ARE THE MINIMUM REQUIREMENTS FOR ANTICIPATED SITE CONDITIONS. DURING THE CONSTRUCTION PERIOD, ESC FACILITIES SHALL BE UPGRADED AS NEEDED FOR UNEXPECTED STORM EVENTS AND TO ENSURE THAT SEDIMENT AND SEDIMENT LADEN WATER DO NOT LEAVE THE SITE.
- 14. THE CONTRACTOR IS RESPONSIBLE FOR MAINTAINING ALL ROADWAYS, KEEPING THEM CLEAN AND FREE OF CONSTRUCTION MATERIALS AND DEBRIS, AND PROVIDING DUST CONTROL AS REQUIRED.
- 15. THE CONTRACTOR SHALL BE RESPONSIBLE FOR COORDINATING AND SCHEDULING ALL WORK WITH THE OWNER.

DEMOLITION NOTES

- 1. THE CITY OF EUGENE DEMOLITION PERMIT REQUIRES THE FOLLOWING INFORMATION, TO BE PROVIDED BY THE
- CONTRACTOR:
 ANTICIPATED TIME FRAME FOR THE DEMOLITION
- DETAILS OF PEDESTRIAN PROTECTION, WHERE REQUIRED. REFER TO OREGON STRUCTURAL SPECIALTY CODE SECTION 3306.
 DESCRIPTION OF HOW THE SITE WILL BE SECURED ACAINST ACCESSIBILITY BY CHILDREN AND OTHER
- DESCRIPTION OF HOW THE SITE WILL BE SECURED AGAINST ACCESSIBILITY BY CHILDREN AND OTHER UNAUTHORIZED PERSONS.
- DESCRIPTION OF HOW WIND SPEED WILL BE MONITORED AT THE SITE DURING DEMOLITION. (NO DEMOLITION OR MOVING OF DEMOLITION DEBRIS MAY TAKE PLACE WHEN WIND SPEEDS EXCEED 25 M.P.H.)
- DESCRIPTION OF HOW DEMOLITION OPERATIONS WILL BE CONDUCTED AND HOW DEBRIS, OBJECTS AND MATERIALS WILL BE WETTED DOWN OR OTHERWISE TREATED TO PREVENT DUST OR OTHER AIRBORNE DEBRIS.
 DESCRIPTION OF THE MEANS AND METHODS FOR PROTECTION OF ANY ADJACENT OR NEIGHBORING
- DESCRIPTION OF THE MEANS AND METHODS FOR PROTECTION OF ANY ADJACENT OR NEIGHBORING STRUCTURES.
- 2. THE CONTRACTOR SHALL BE RESPONSIBLE FOR DEMOLITION AND DISPOSAL OF EXISTING AC, CURBS, SIDEWALKS AND OTHER SITE ELEMENTS WITHIN THE SITE AREA IDENTIFIED IN THE PLANS.
- 3. EXCEPT FOR MATERIALS INDICATED TO BE STOCKPILED OR TO REMAIN ON OWNER'S PROPERTY, CLEARED MATERIALS SHALL BECOME CONTRACTOR'S PROPERTY, REMOVED FROM THE SITE, AND DISPOSED OF PROPERLY.
- 4. ITEMS INDICATED TO BE SALVAGED SHALL BE CAREFULLY REMOVED AND DELIVERED STORED AT THE PROJECT SITE AS DIRECTED BY THE OWNER.
- 5. ALL LANDSCAPING, PAVEMENT, CURBS AND SIDEWALKS, BEYOND THE IDENTIFIED SITE AREA, DAMAGED DURING THE CONSTRUCTION SHALL BE REPLACED TO THEIR ORIGINAL CONDITION OR BETTER.
- 6. CONCRETE SIDEWALKS SHOWN FOR DEMOLITION SHALL BE REMOVED TO THE NEAREST EXISTING CONSTRUCTION JOINT.
- 7. SAWCUT STRAIGHT MATCHLINES TO CREATE A BUTT JOINT BETWEEN THE EXISTING AND NEW PAVEMENT.
- 8. ADJUST ALL UTILITY STRUCTURES TO REMAIN WITHIN THE DEMOLITION AREA TO FINISHED GRADE.
- 9. BEFORE BACKFILLING ANY ENCOUNTERED UTILITIES DURING DEMOLITION, SURVEY LOCATION TO INCLUDE WITH REDLINES OR AS-BUILTS.

SHEET TITLE DM100 DM200

NOTICE TO EXCAVATORS: ATTENTION: OREGON LAW REQUIRES YOU TO FOLLOW RULES ADOPTED BY THE OREGON UTILITY NOTIFICATION CENTER. THOSE RULES ARE SET FORTH IN OAR 952-001-0010 THROUGH OAR 952-001-0090. YOU MAY OBTAIN COPIES OF THE RULES BY CALLING THE CENTER. (NOTE: THE TELEPHONE NUMBER FOR THE OREGON UTILITY NOTIFICATION CENTER IS (503)-232-1987).
POTENTIAL UNDERGROUND FACILITY OWNERS
Dig Safely.
Call the Oregon One-Call Center


1-800-332-2344

SHEET INDEX

SHEET NAME

DM100CIVIL DEMOLITION NOTESDM200UTILITY DEMOLITION PLANDM300SITE RESTORATION PLAN

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big	\sim	a
k 800 w	illamette Stre Eugene, OR O: 541.684. F: 541.684. <u>www.kpff.</u>	97401 4902 4909
DEMOLITION SET	4J WILLARD SWING SCHOOL	4J SCHOOL DISTRICT 2840 LINCOLN ST
CIV	NOLITIC	ON
REVIS #	DESCRP	. DATE 9.26.2019
	DM '	<u> </u>

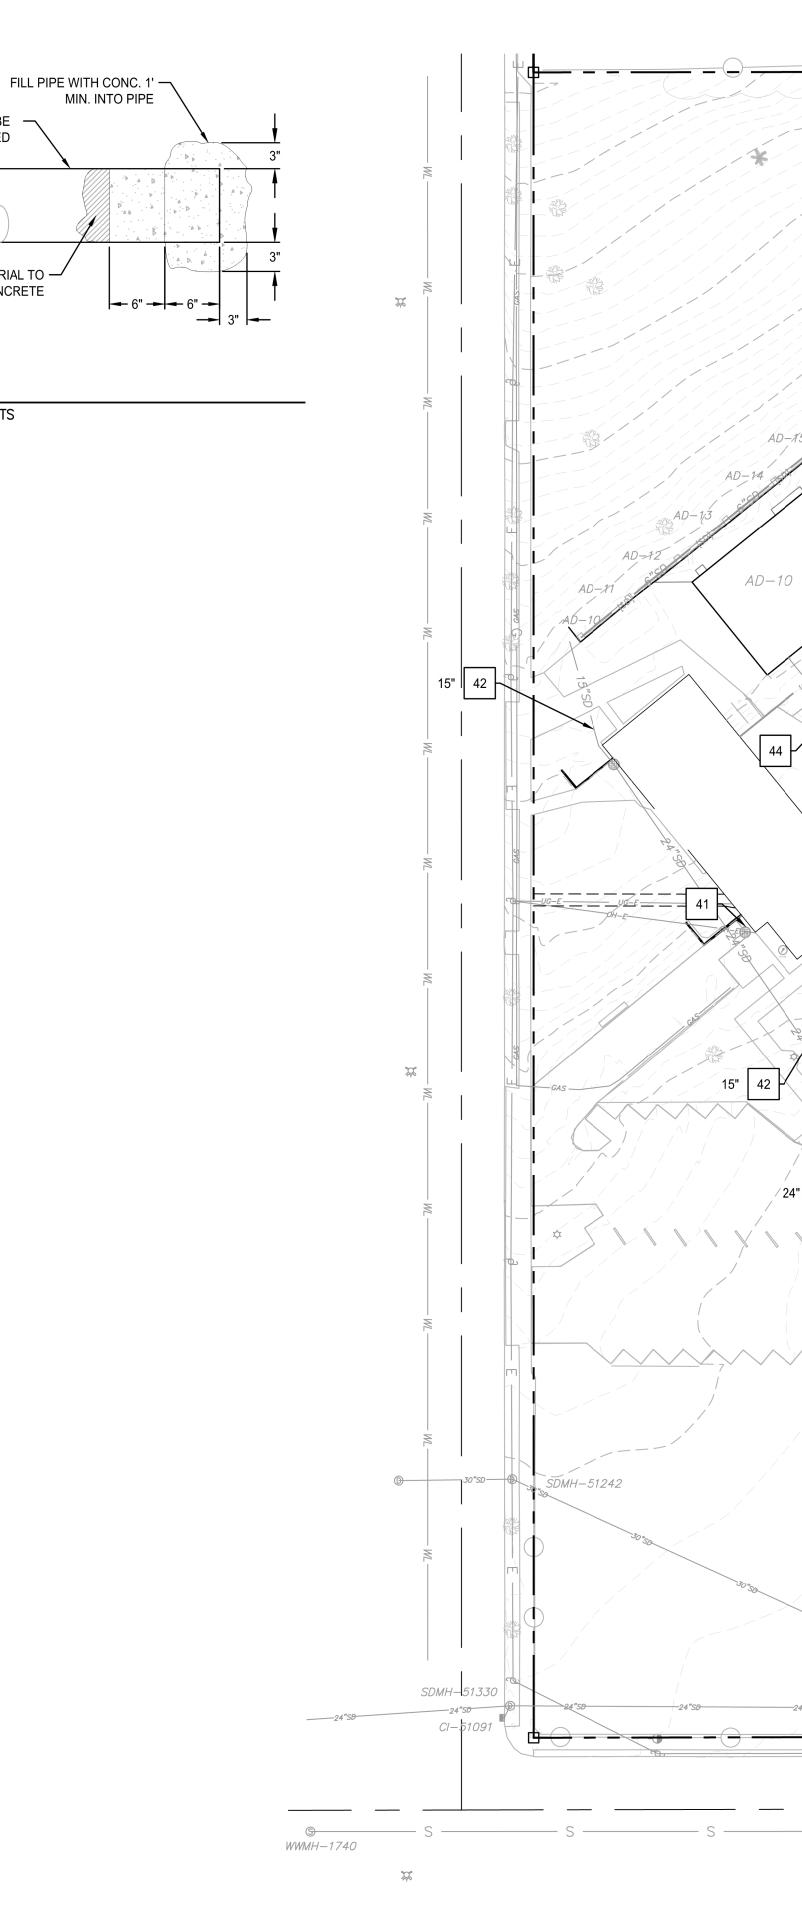

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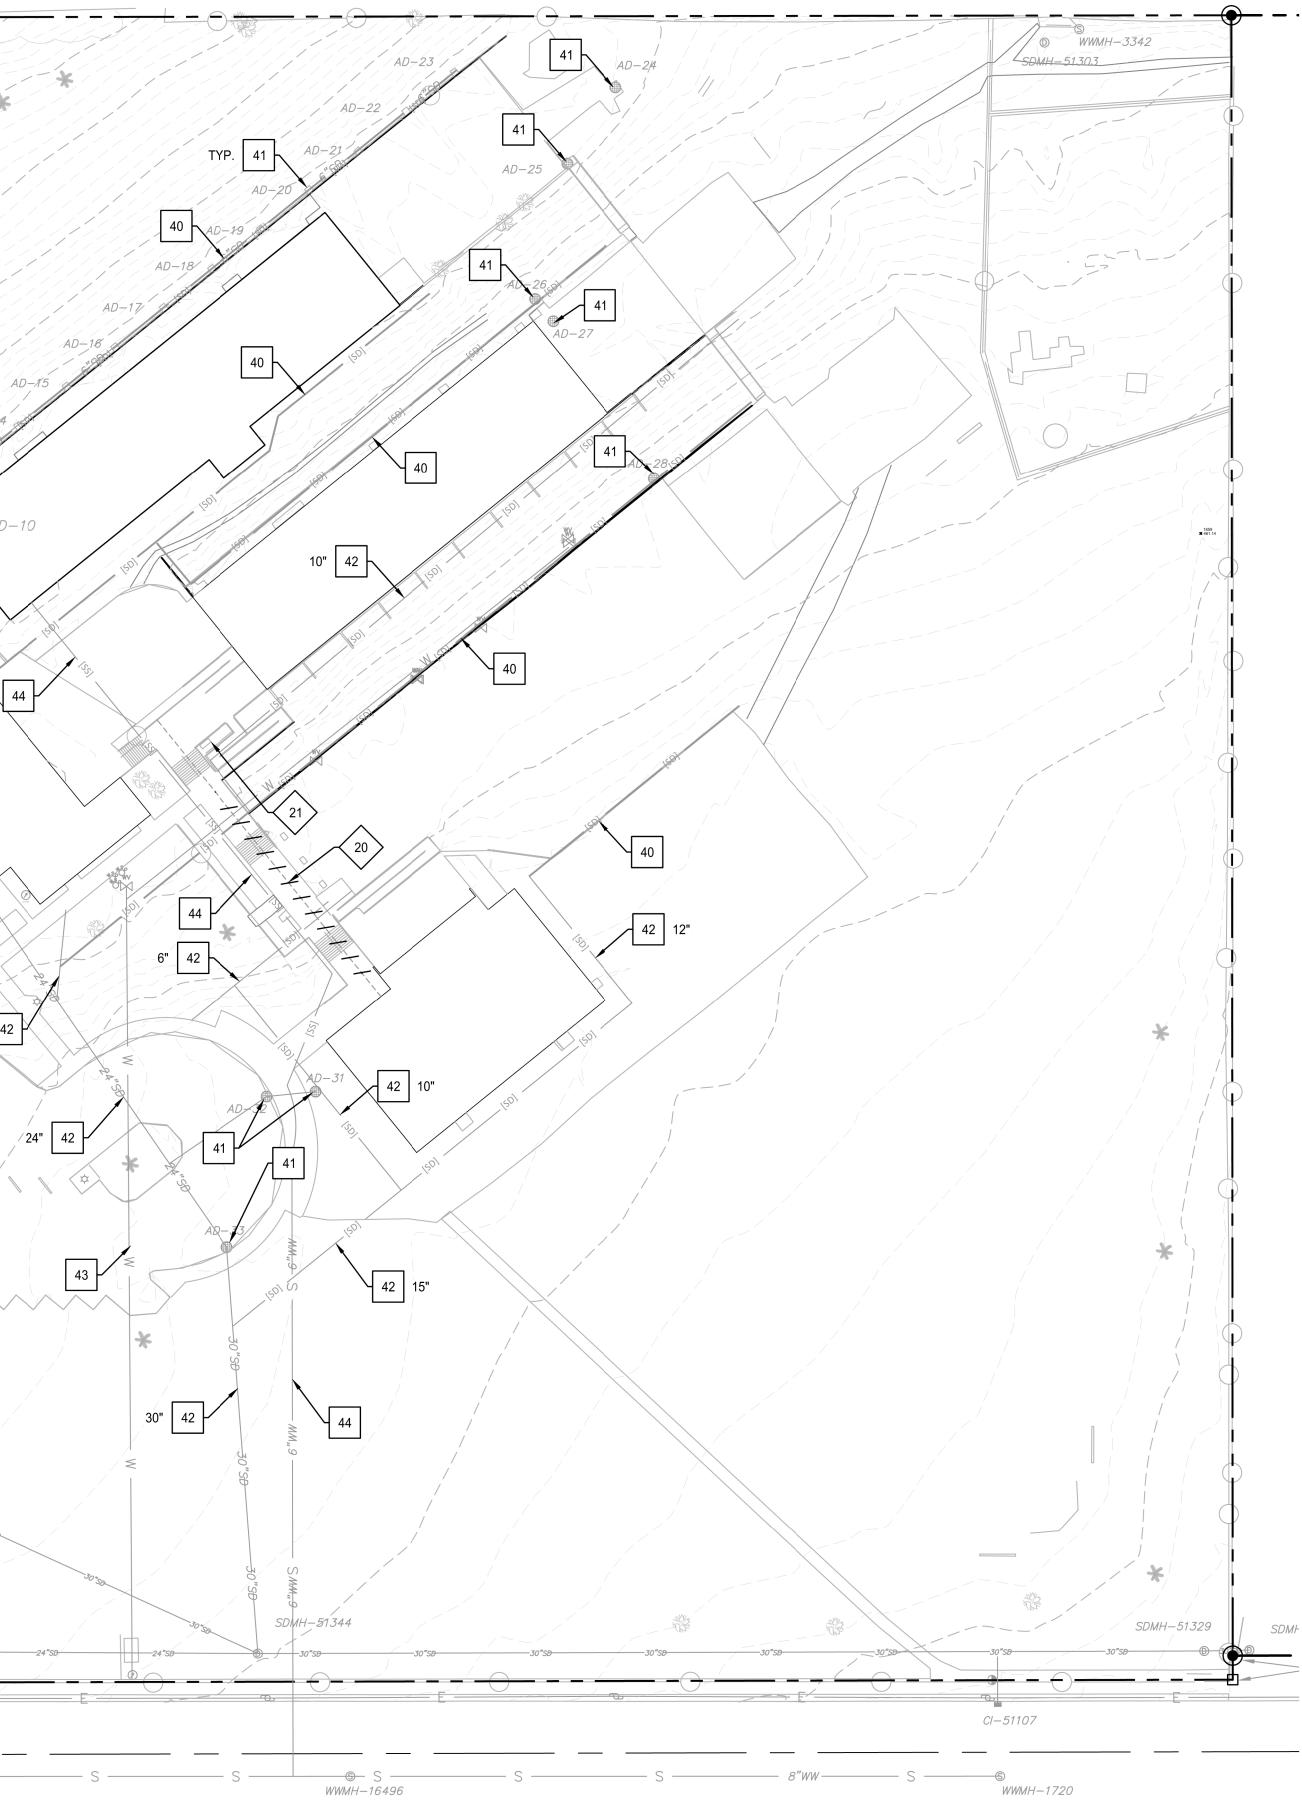
PIPE TO BE ABANDONED

PACKING MATERIAL TO -

CONTAIN CONCRETE

PLUG

SCALE: NTS



X

- 1. CONTRACTOR MAY STAGE WITHIN LIMITS OF DEMOLITION.
- REMOVE ALL SITE COMPONENTS AND RECYCLE COMPONENTS AS 2. REQUIRED IN THE SPECIFICATIONS.
- GENERAL DEMOLITION PERMIT SHALL BE SECURED BY THE 3 CONTRACTOR.
- ALL TRADE LICENSES AND PERMITS NECESSARY FOR THE 4. PROCUREMENT AND COMPLETION OF THE WORK SHALL BE SECURED BY THE CONTRACTOR PRIOR TO COMMENCING DEMOLITION.
- THE CONTRACTOR SHALL PRESERVE AND PROTECT FROM DAMAGE ALL EXISTING RIGHT-OF-WAY SURVEY MONUMENTATION DURING DEMOLITION. THE CONTRACTOR IS RESPONSIBLE FOR COORDINATING AND PAYING FOR THE REPLACEMENT BY A LICENSED SURVEYOR OF ANY DAMAGED OR REMOVED MONUMENTS.
- PROTECT ALL ITEMS ON ADJACENT PROPERTIES AND IN THE RIGHT OF WAY INCLUDING BUT NOT LIMITED TO SIGNAL EQUIPMENT, PARKING METERS, SIDEWALKS, STREET TREES, STREET LIGHTS, CURBS, PAVEMENT AND SIGNS. CONTRACTOR SHALL BE RESPONSIBLE FOR RESTORING ANY DAMAGED ITEMS TO ORIGINAL CONDITION.
- PROTECT STRUCTURES, UTILITIES, SIDEWALKS, AND OTHER 7. FACILITIES IMMEDIATELY ADJACENT TO EXCAVATIONS FROM DAMAGES CAUSED BY SETTLEMENT, LATERAL MOVEMENT, UNDERMINING, WASHOUT AND OTHER HAZARDS.
- 8. SAWCUT STRAIGHT LINES IN SIDEWALK, AS NECESSARY.
- CONTRACTOR IS RESPONSIBLE TO CONTROL DUST AND MUD DURING THE DEMOLITION PERIOD, AND DURING TRANSPORTATION OF DEMOLITION DEBRIS. ALL STREET SURFACES OUTSIDE THE CONSTRUCTION ZONE MUST BE KEPT CLEAN.
- 10. ALL EXPOSED PORTIONS OF UNDERGROUND UTILITIES TO BE ABANDONED SHALL BE PLUGGED PER DETAIL 1/DM200.
- 11. SEE ARCHITECTURAL PLANS FOR BUILDING AND PAVEMENT DEMOLITION.
- 12. ASBESTOS ABATEMENT WORK TO BE PERFORMED BY OWNER PRIOR TO UTILITY AND SITE DEMOLITION.
- 13. CONTRACTOR TO VERIFY UTILITIES THAT WERE NOT SURVEYED PRIOR TO COMMENCING DEMOLITION.

DEMOLITION KEY NOTES $\langle \times \rangle$


- 20 REMOVE HYDRONIC PIPING. CAP HYDRONIC PIPING AT END OF PIPE REMOVAL.
- REMOVE STEAM VAULT. BACKFILL WITH 1 $\frac{1}{2}$ "-0" AGGREGATE. SEE PLUMBING DEMOLITION PLANS FOR STEAM PIPE REMOVAL. 21

| X | PROTECTION KEY NOTES

- 40 PROTECT FRENCH DRAIN / TILE DRAIN SYSTEM.
- 41 PROTECT AREA DRAIN.
- 42 PROTECT STORM DRAIN, SIZE AS NOTED.
- 43 PROTECT WATER.
- 44 PROTECT SANITARY SEWER.

SHEET LEGEND

	PROPERTY LINE
	REMOVE UTILITY LINE
	EXISTING GRADE CONTOUR
[SD]	EXISTING STORM DRAIN NOT SURVEYED. LOCATION SHOWN IS APPROXIMATE.
[SD]	EXISTING FRENCH DRAIN NOT SURVEYED. LOCATION SHOWN IS APPROXIMATE.
[SS]	EXISTING SANITARY PIPE NOT SURVEYED. LOCATION SHOWN IS APPROXIMATE.
[W]	EXISTING WATER PIPING NOT SURVEYED. LOCATION SHOWN IS APPROXIMATE.
	EXISTING HYDRONIC PIPING NOT SURVEYED. LOCATION SHOWN IS APPROXIMATE.

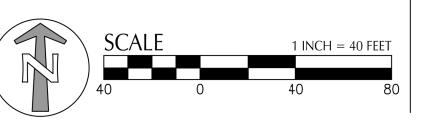







800 Willamette Street, Suite 400 Eugene, OR 97401 O: 541.684.4902 F: 541.684.4909 www.kpff.com


DEMOLITION SET	4J SCHOOL DISTRICT
4.J WILLARD SWING SCHOOL	2840 LINCOLN ST

SHEET TITLE: UTILITY DEMOLITION PLAN

REVISIONS:			
#	DESCRP.	DATE	

ISSUE DATE: 09.26.2019


DM200

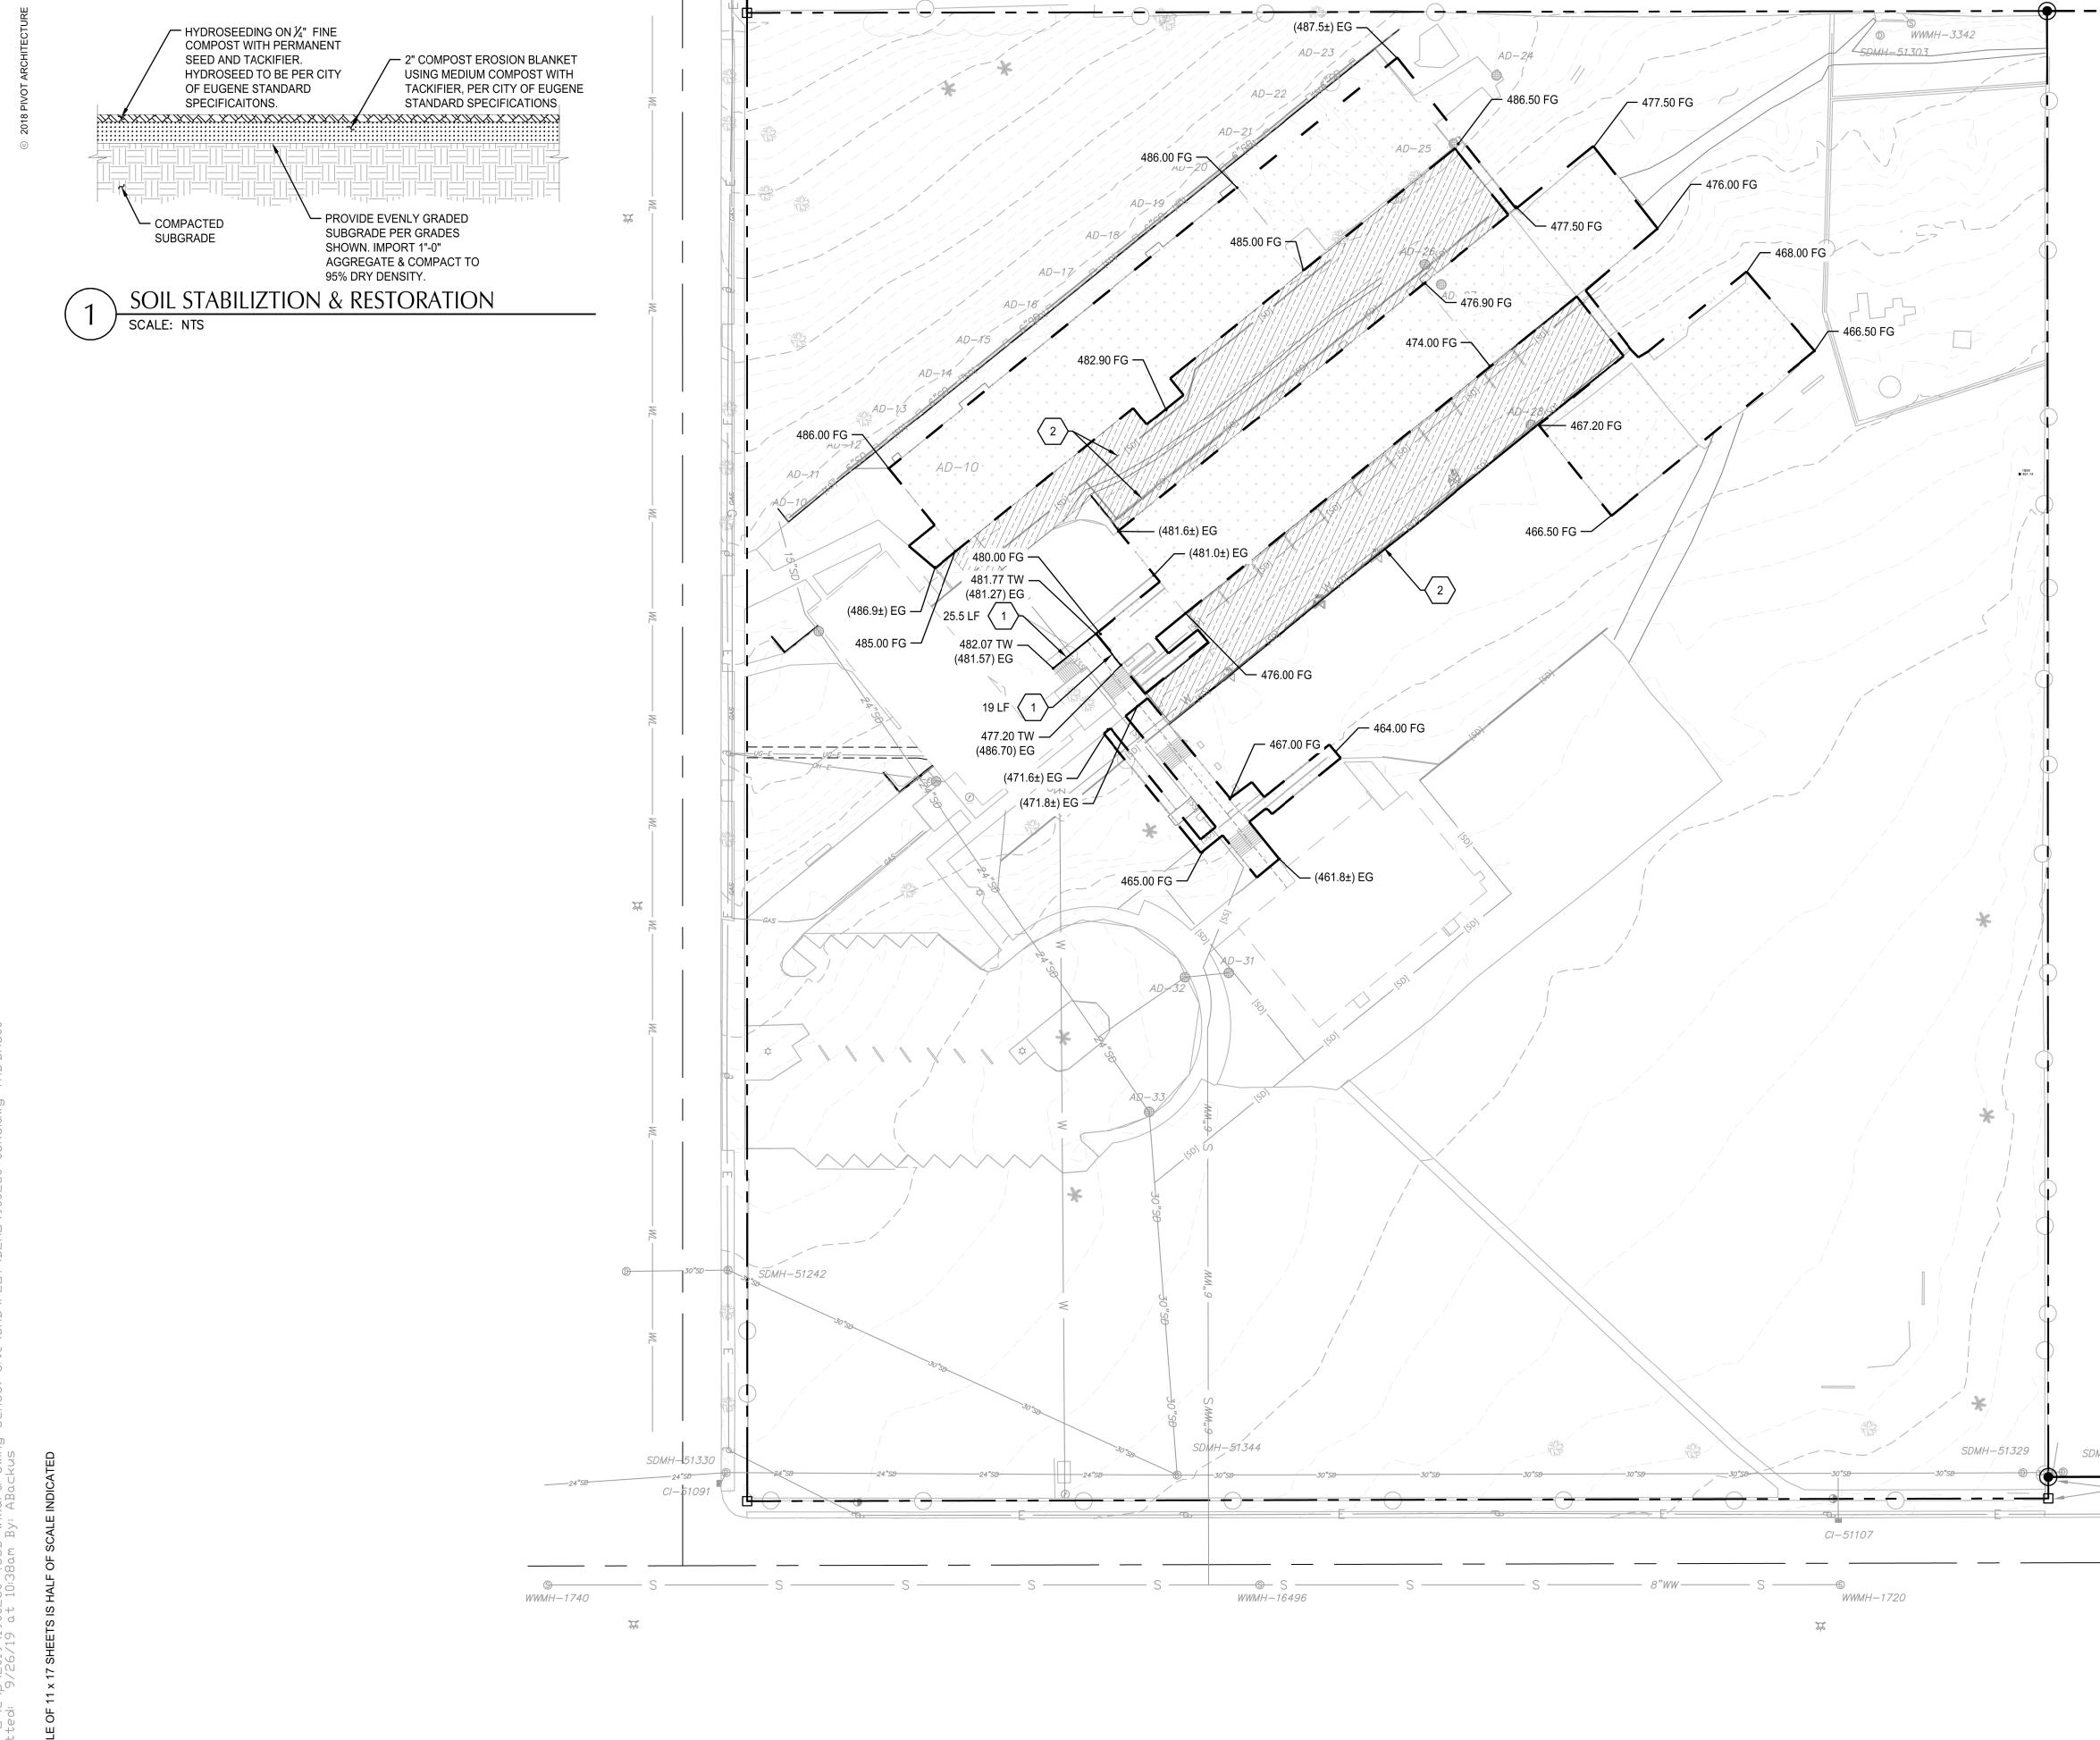



- 2. MATCH EXISTING GRADES AT PAVEMENT TO REMAIN.
- SLOPE TO MATCH EXISTING AT 5:1 MAXIMUM SLOPE IN LANDSCAPE 3. AREAS.
- 4. RESTORE ANY DISTURBED AREAS PER DETAIL 1/DM300.

CALLOUT LEGEND

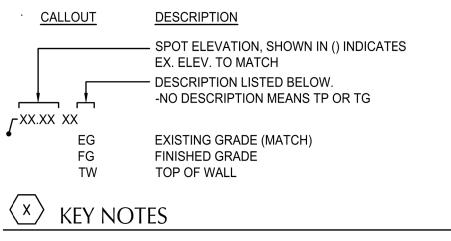


NOTE DESCRIPTION

DETAIL

- 1 INSTALL RETAINING WALL AT EDGE OF PAVEMENT TO REMAIN. SEE ARCHITECTURAL PLANS FOR GUARDRAIL.
- 2 PROTECT EXISTING FRENCH DRAIN AND PERFORATED PIPES TO REMAIN.

SHEET LEGEND

SDMF

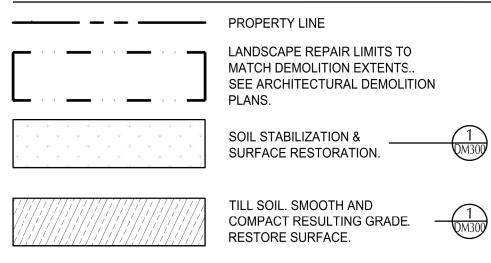







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DEMOLITION SET	4J WILLARD SWING SCHOOL	4J SCHOOL DISTRICT 2840 LINCOLN ST
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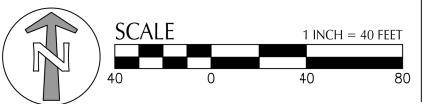
SHEET TITLE:

SITE RESTORATION PLAN

REVISIO	ONS:
#	DESCRP.


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ISSUE DATE: 09.26.2019











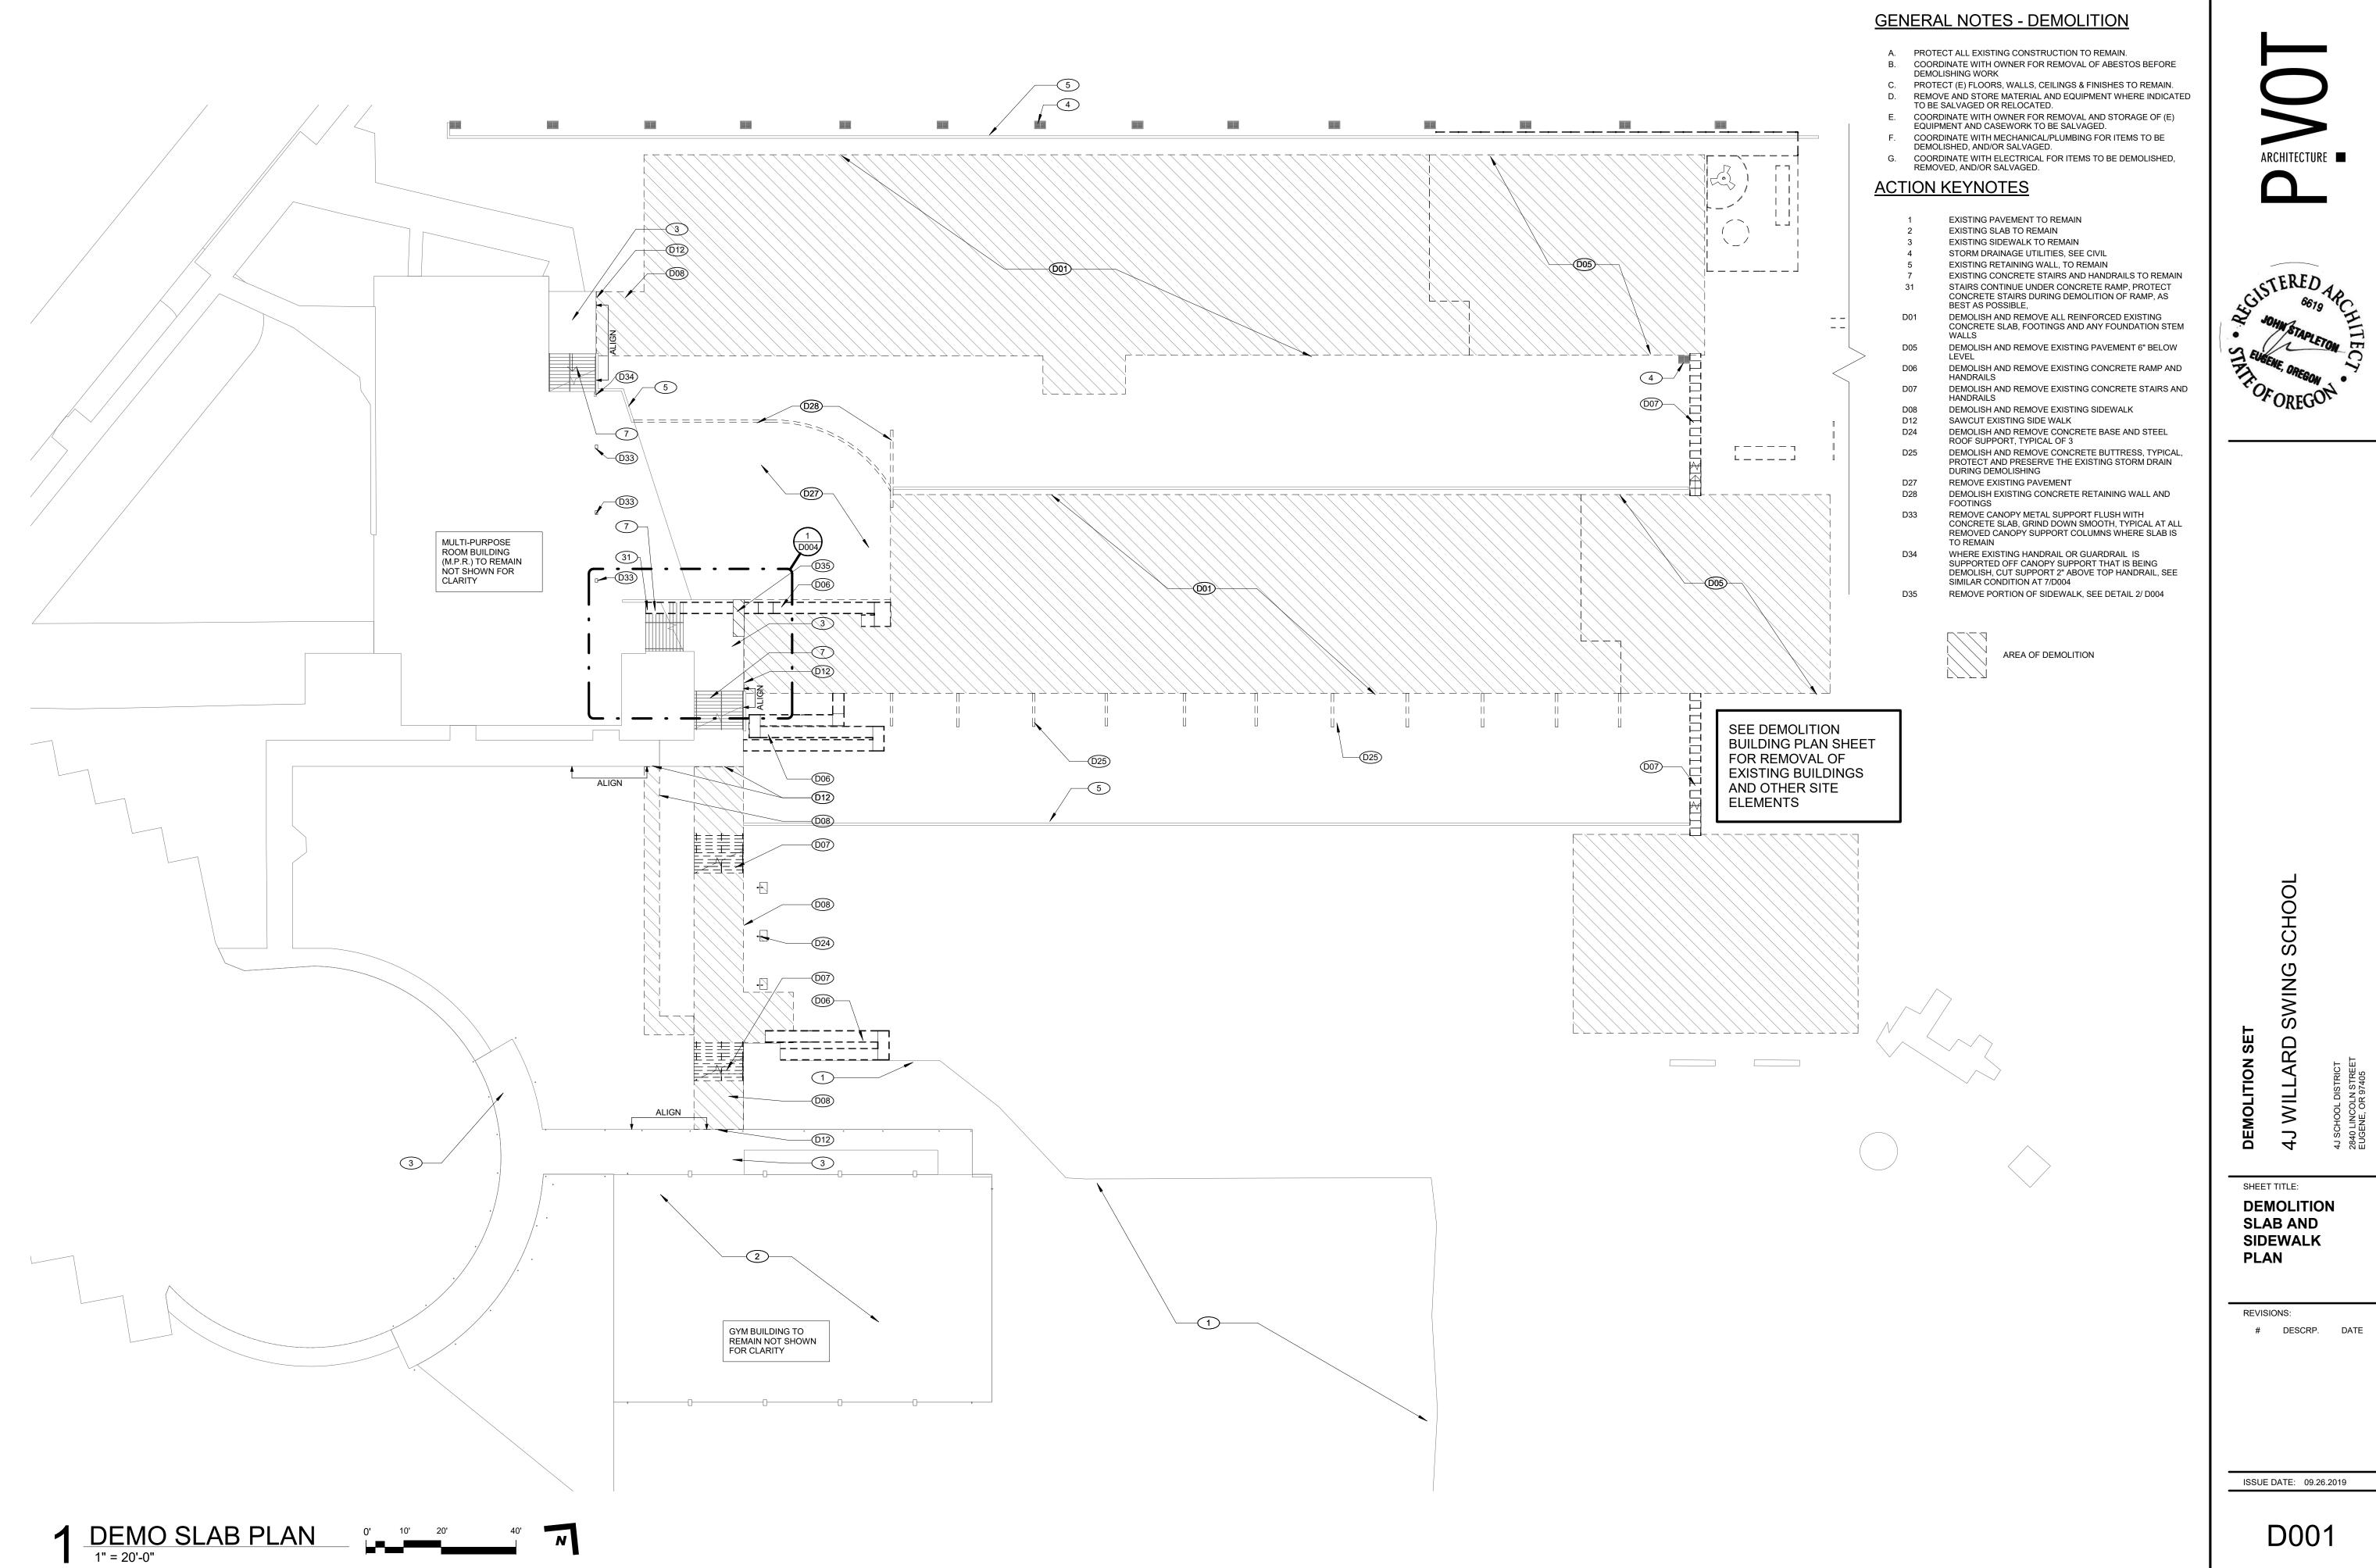

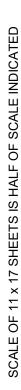


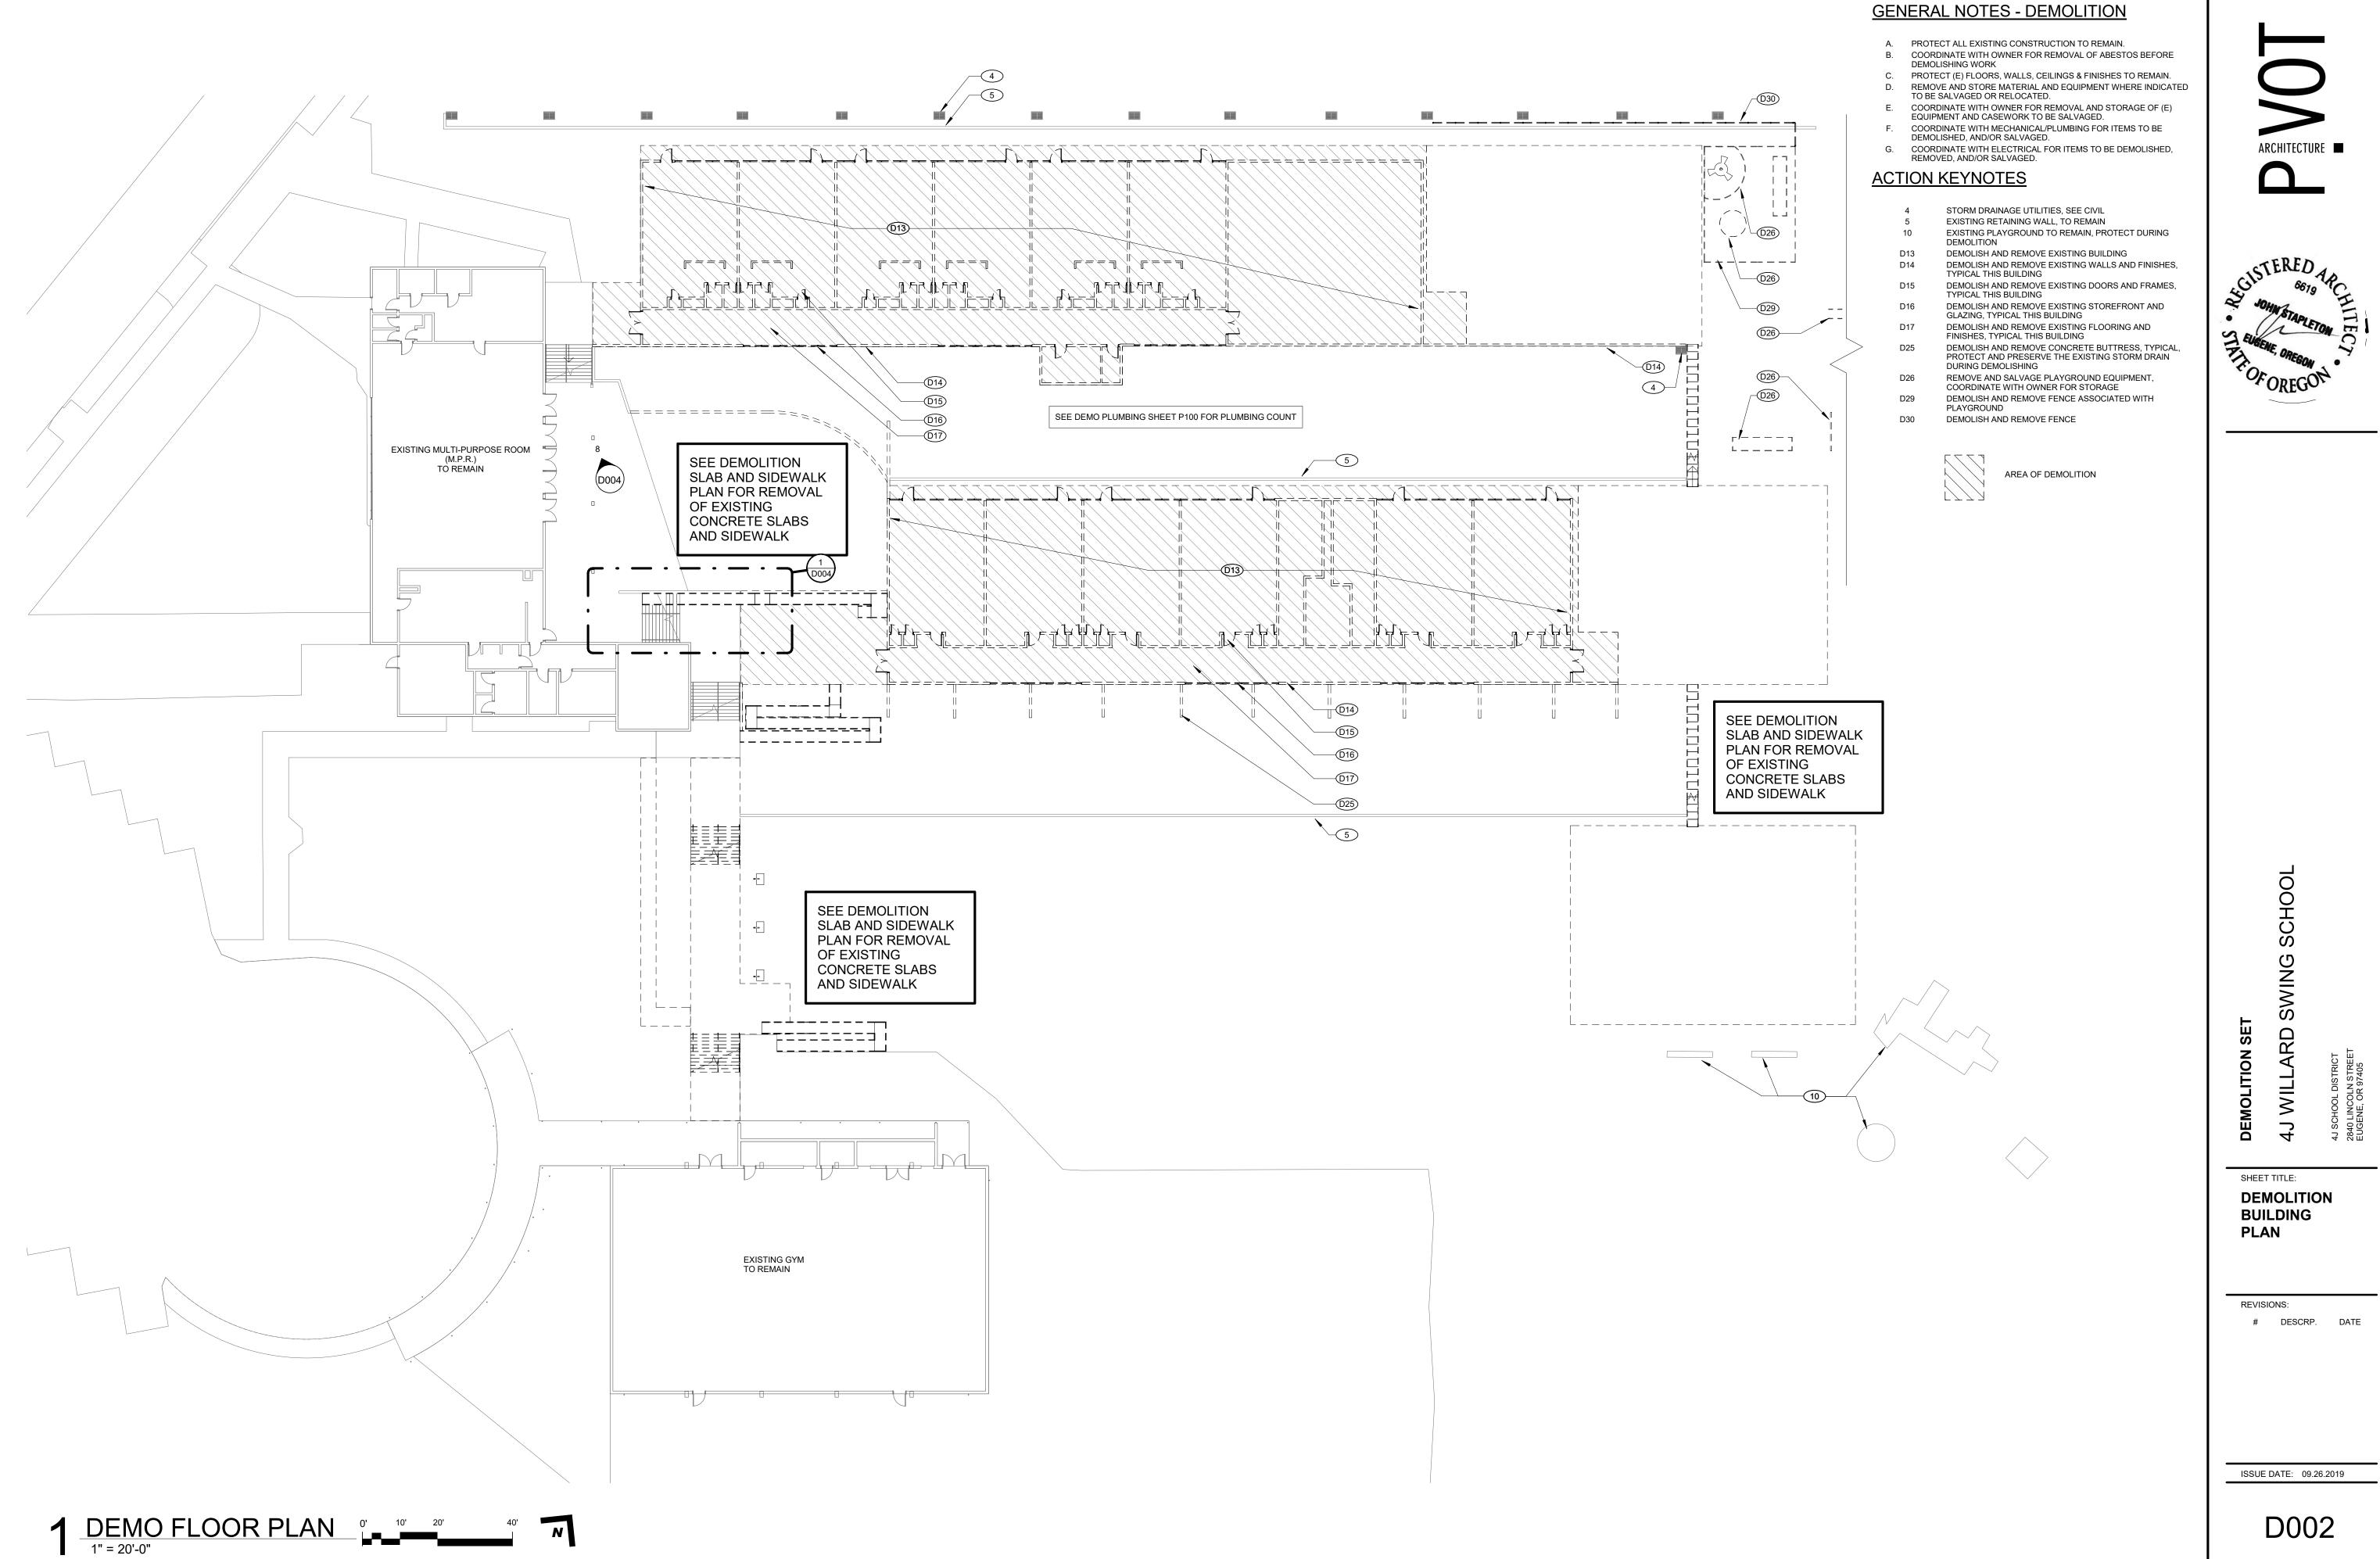


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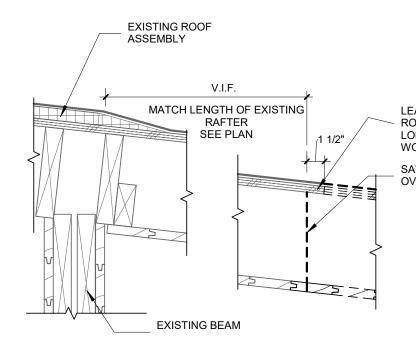




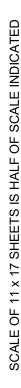


WHERE CONDUIT IS REMOVED FROM - EXISTING BUILDING TO REMAIN, COVER WITH METAL FLASHING AND SEAL.

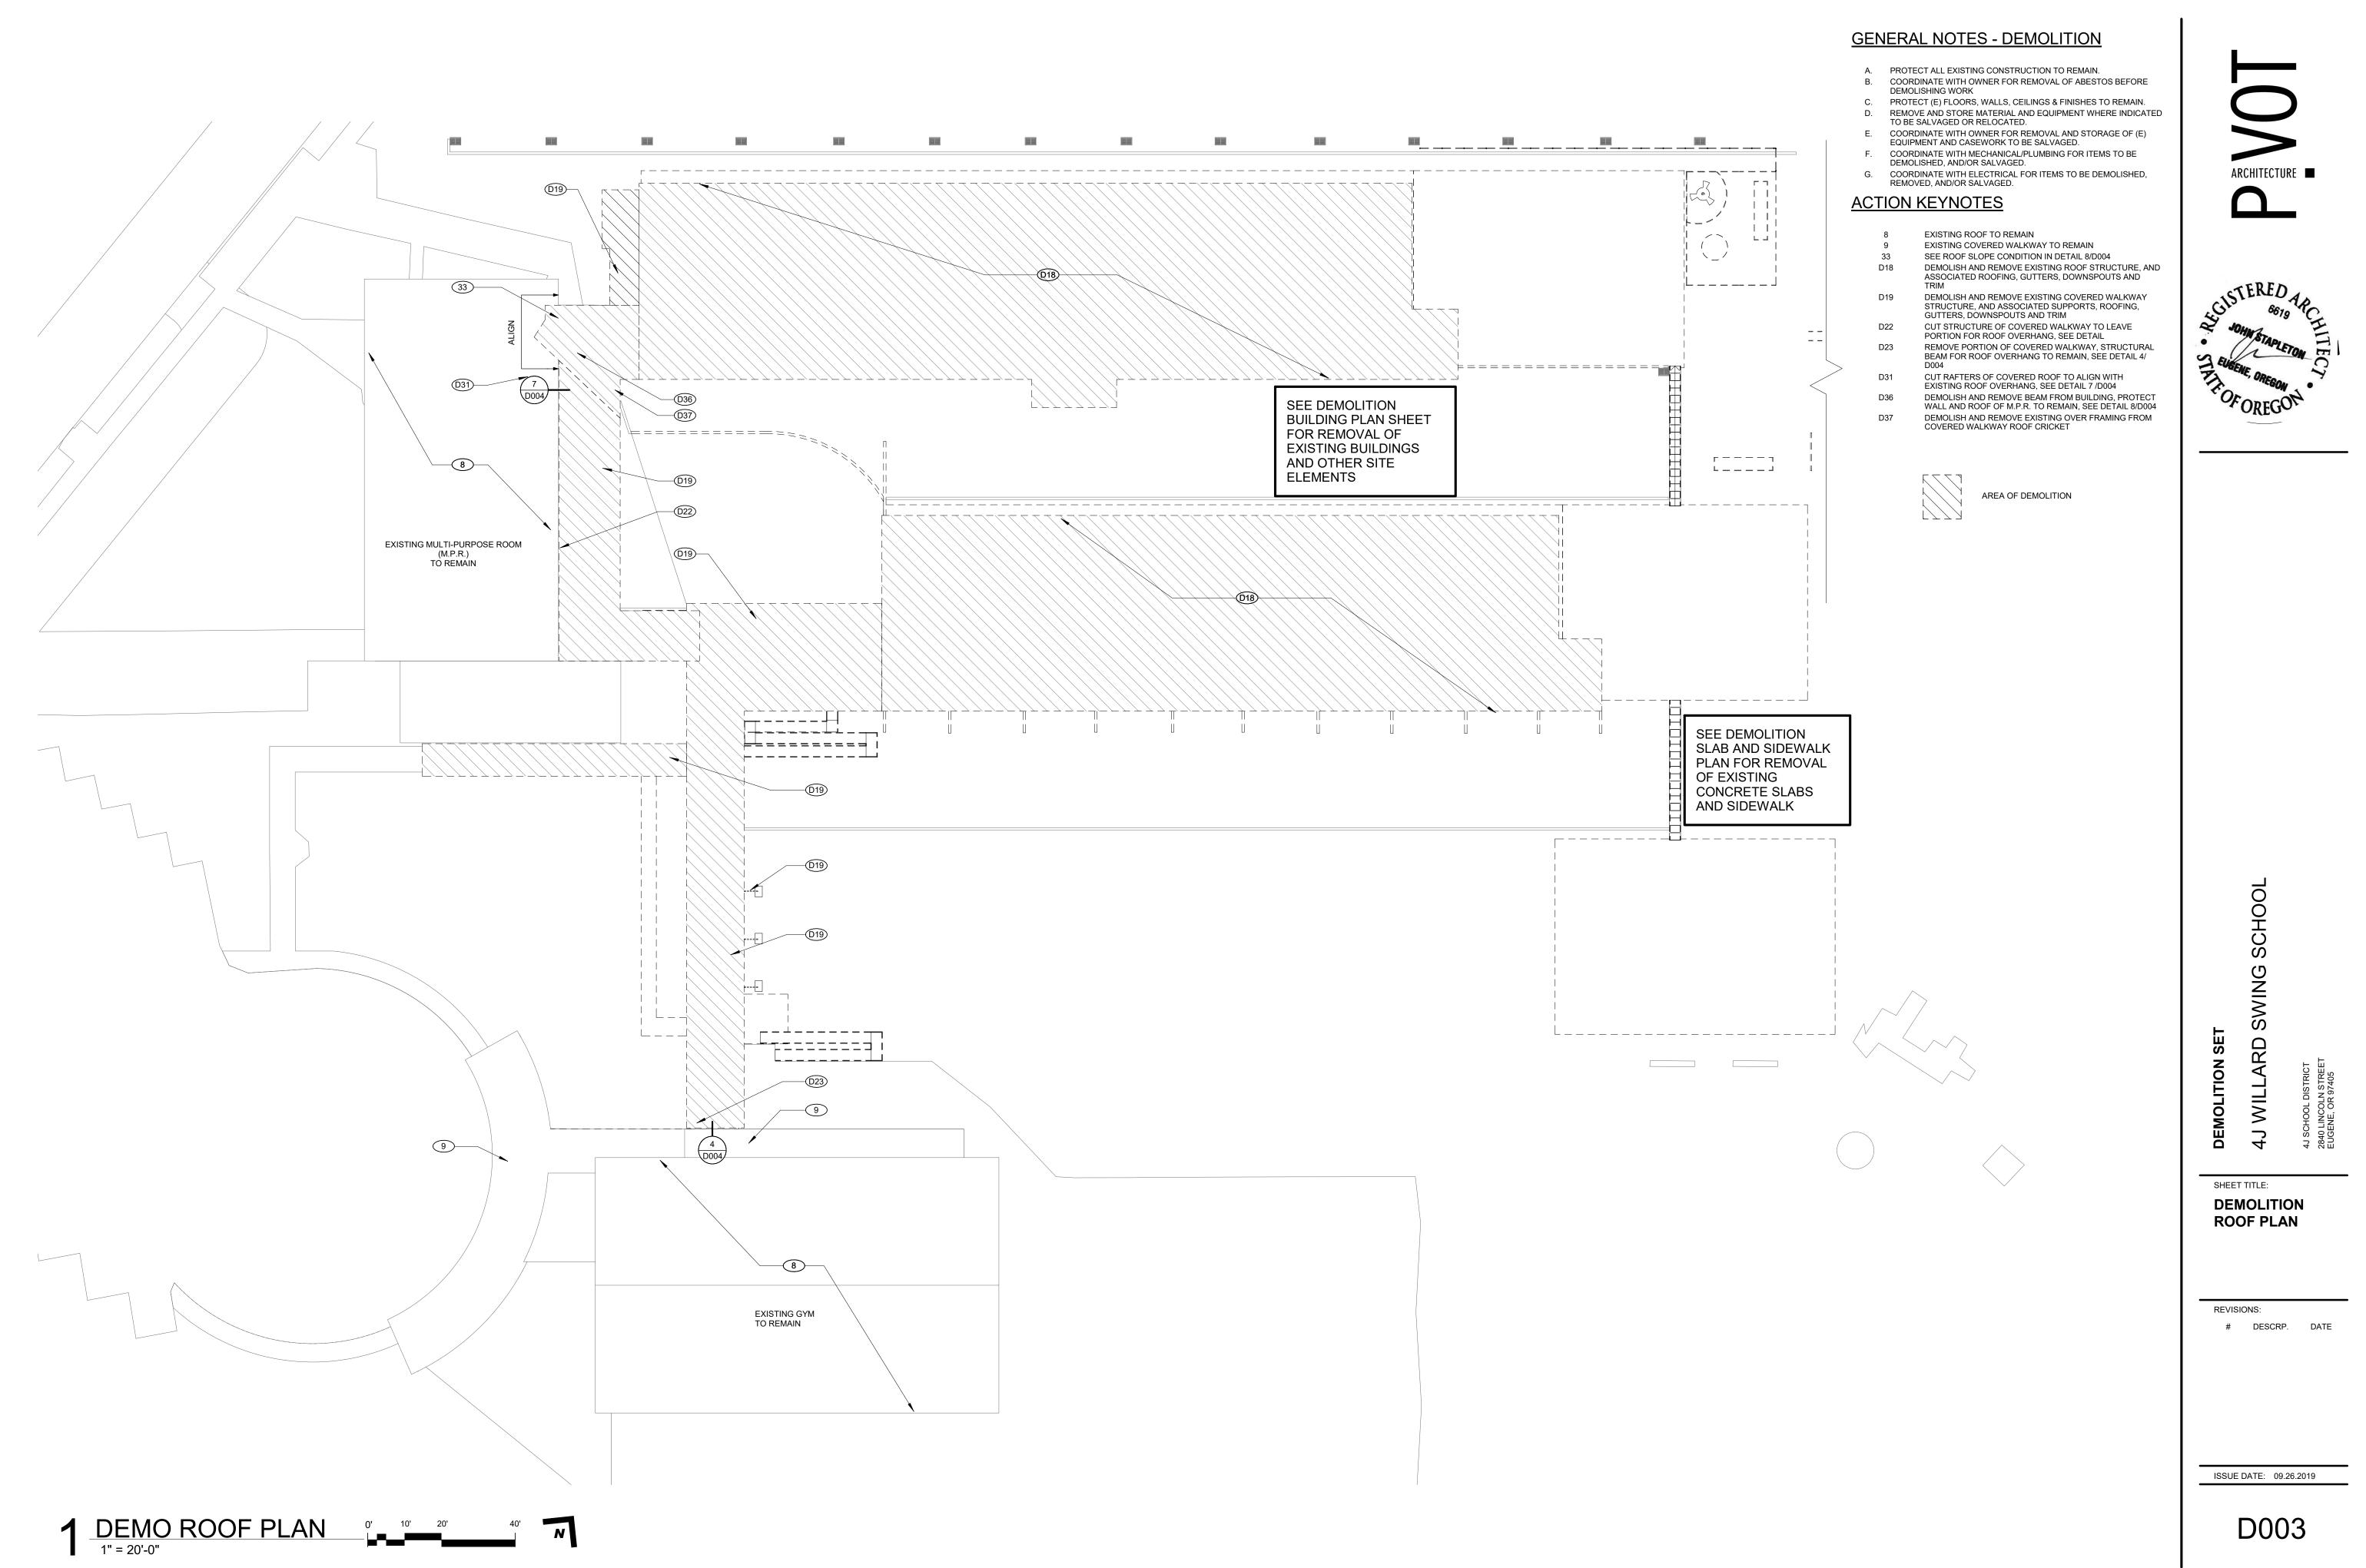






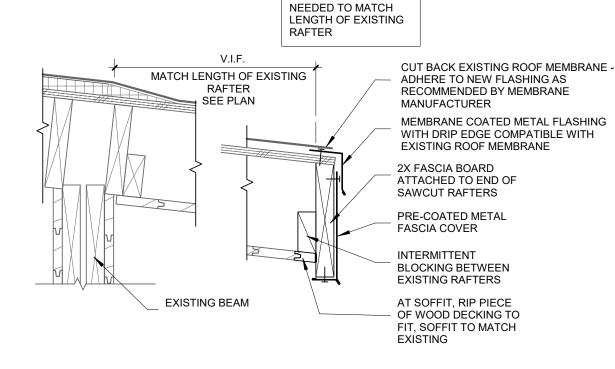

AT OVERFRAMING, ADD FRAMING AS





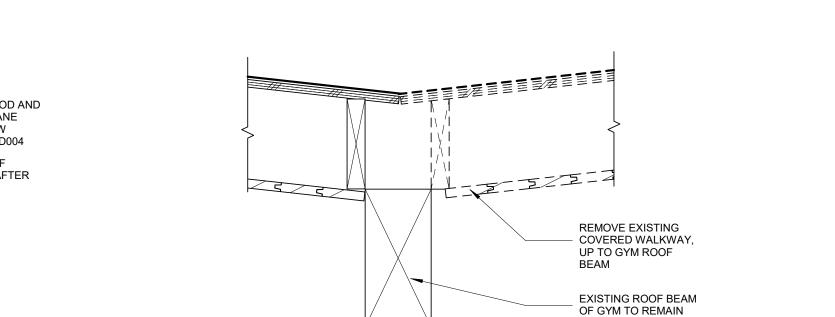


3 ROOF AT GYM - DEMO

ADMIN

1

LEAVE PLYWOOD AND ROOF MEMBRANE LONG FOR NEW WORK, SEE 7/ D004 SAW CUT ROOF OVERHANG RAFTER



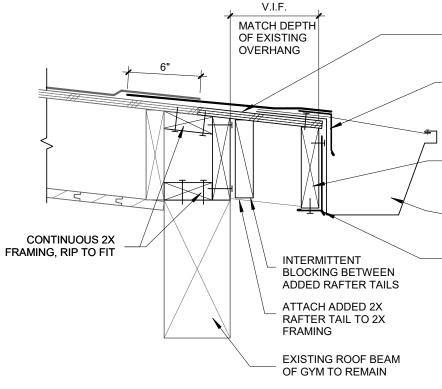

EXTEND ROOF SHEATHING AND MEMBRANE COATED METAL FLASHING WITH DRIP EDGE COMPATIBLE WITH

EXISTING ROOF MEMBRANE

2X FASCIA BOARD

SHEET METAL

AND MATERIAL

FASCIA COVER

GUTTER, MATCH

EXISTING PROFILE

PRE-COATED METAL

ATTACHED TO END OF NEW RAFTER TAILS

MEMBRANE, MATCH EXISTING SLOPE


#4 @ 12" MAX ON CENTER CONTINUOUS



5 GUARDRAIL POST

WHERE EXISTING HANDRAIL OR GUARDRAIL IS SUPPORTED OFF CANOPY SUPPORT THAT IS BEING DEMOLISH, CUT SUPPORT 2" ABOVE TOP HANDRAIL, SEE SIMILAR CONDITION AT 7/D004

WELD CIRCULAR PLATE TO TOP OF EXPOSED PIPE, GRIND TO SMOOTH, PAINT TO MATCH

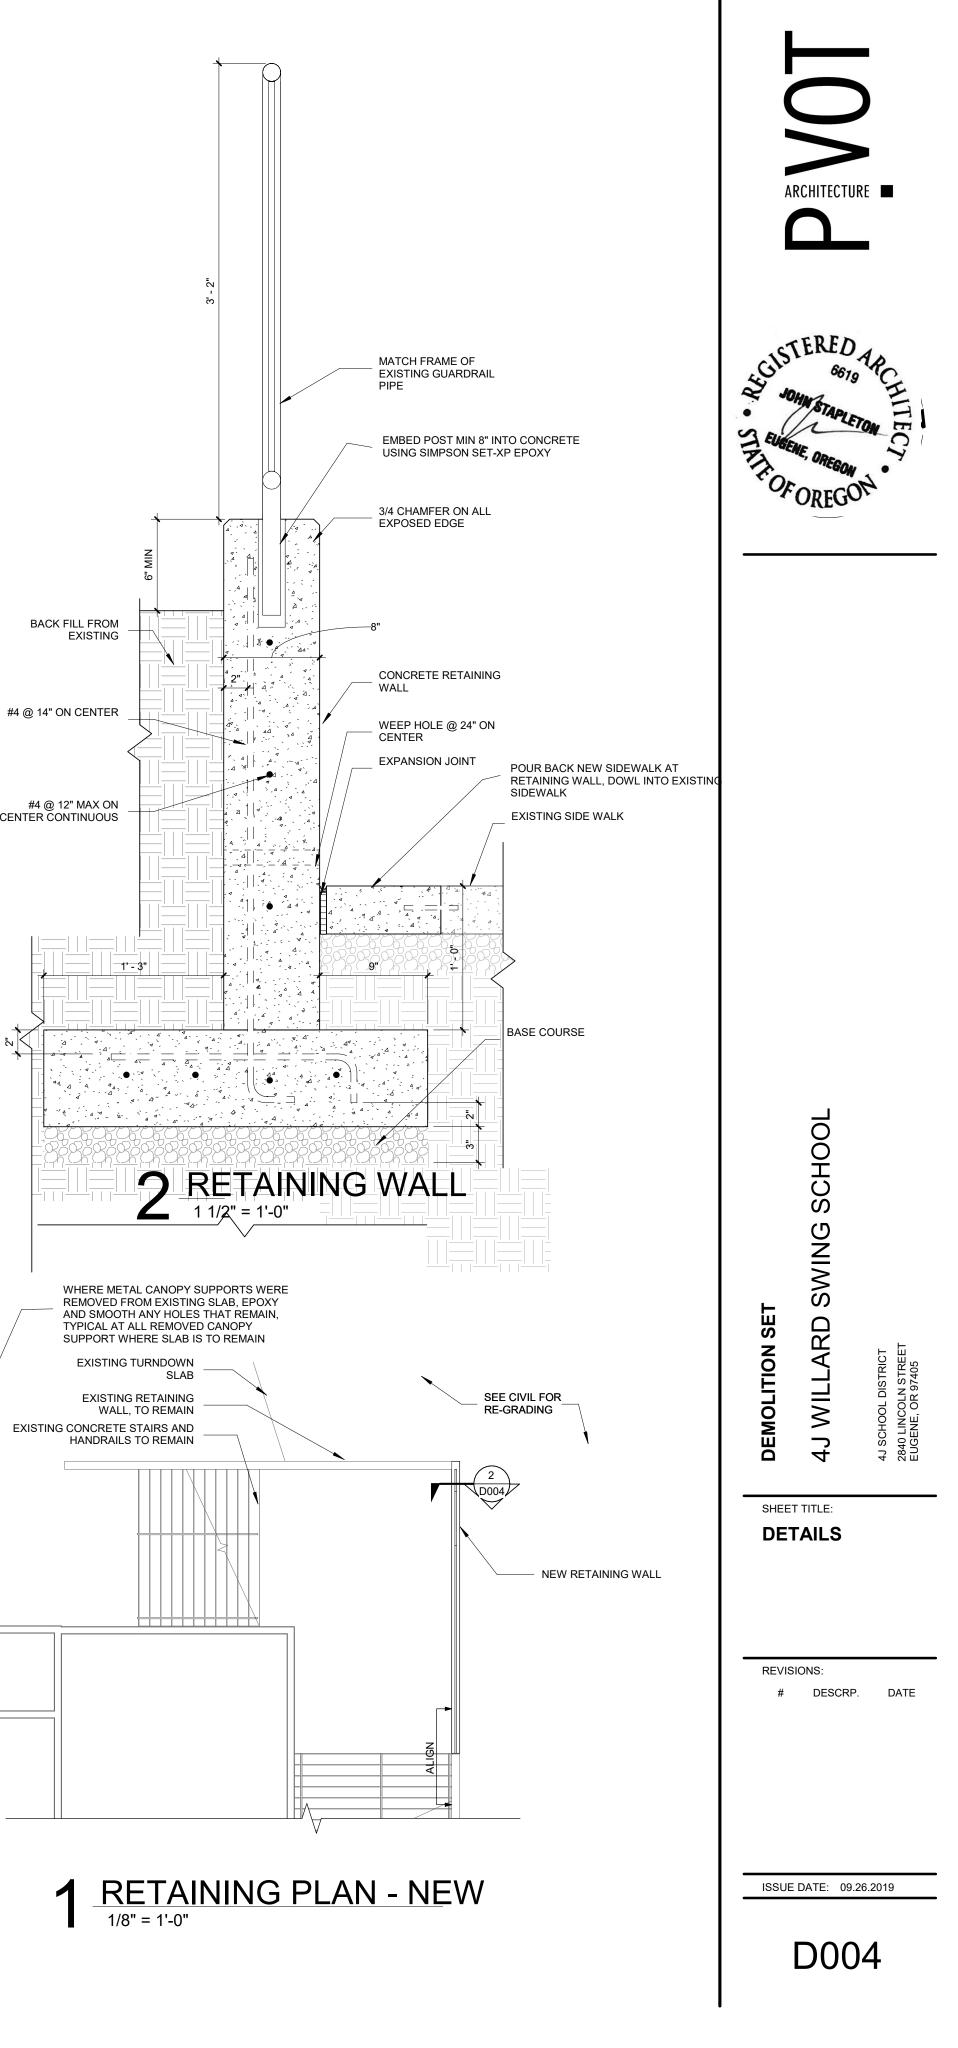

PIPING <u>SYMBOL</u>

<u>HYDRONIC PIPING</u> :	HS HR CD
SITE PIPING (REFERENCE	<u>:)</u> : W
	Ι
$ \xrightarrow{\circ} \xrightarrow{\circ} \xrightarrow{\circ} \xrightarrow{\circ} \xrightarrow{\circ} \xrightarrow{\circ} \xrightarrow{\circ} \xrightarrow{\circ}$	
I I	
O	
ði	DV
}	BV
I	BFV
	CHV
\longrightarrow	GV
	AV
	AV
	AV
X	PRV
 ,	

	ABBREV.	DESCRIPTION	
_	HS HR	HEATING WATER SUPPLY HEATING WATER RETURN	
_	CD	CONDENSATE DRAIN	
	02		
r	<u>):</u>		
<u> </u>	<u>, c)</u> . W	WATER SERVICE	
_	τ	IRRIGATION	
	1		
)		PIPING UP	
)		PIPING DOWN	
		SLOPE OF PIPE IN DECIMALS OF FEET	
]		CAPPED PIPE	Ļ
		PIPE REDUCING FITTING: CONCENTRIC, ECCENTRIC	Ĩ.
		DIRECTION OF FLOW	L,
		UNION	
		PUMP	
	DV	DRAIN VALVE	
	BV	BALL VALVE	
	BFV	BUTTERFLY VALVE	
	CHV	CHECK VALVE	
	GV	GATE VALVE	L
	AV	AUTOMATIC CONTROL VALVE: 2-WAY	
	AV	AUTOMATIC CONTROL VALVE: 3-WAY	
			L_{l}
	AV	AUTOMATIC BUTTERFLY VALVE	
	PRV	PRESSURE REGULATING VALVE	
			Ĺ
		FLEXIBLE PIPE CONNECTION	\int
		WYE STRAINER	<u>v</u>
			7

DUCTWORK	
SYMBOL	DESC
SA	RECT
RA EA SOSA	RECT.
	RECT
	RECT
	RECT.
	OUTS
	ROUN
	ROUN
	TURN STAN
	FLEXI
12"x6"	DUCT
SD-1	DIFFU
↓ 10"x10" <u>200</u>	SIZE - AIR V
RG-1	GRILL SIZE
<u>175</u>	AIR V
EG-1 12"x10"	GRILL SIZE
$\begin{bmatrix} 2 & \frac{175}{1} \\ EG-1 \end{bmatrix}$	AIR V SIDE V
▲ EG-1 8"x4' 100	SIZE AIR V
SD-2 48" - 2 - 10"ø 175	SLOT LENG AIR V
+	INTEF WALL
	MANU
	RECT.
	RECT
	RECT. ELEV/ ROUN
	RECT, ELEV/ ROUN ELEV/
	RECT. ELEV/ ROUN ELEV/ CONC
	RECT. ELEV/ ROUN ELEV/ CONC
	RECT. ELEV/ ROUN ELEV/ CONC ECCE MITEF VANE
	RECT. ELEV/ ROUN ELEV/ CONC ECCE MITEF VANE MITEF BRAN
	RECT. ELEV/ ROUN ELEV/ CONC ECCE MITEF VANE MITEF BRAN 45 DE BRAN

DESCRIPTION
RECTANGULAR SUPPLY AIR DUCT UP RECTANGULAR RETURN AIR DUCT UP RECTANGULAR EXHAUST AIR UP RECTANGULAR OUTSIDE AIR UP
RECTANGULAR SUPPLY AIR DUCT UP RECTANGULAR RETURN AIR DN RECTANGULAR EXHAUST AIR or OUTSIDE AIR DN ROUND DUCTWORK UP
TURN VANE ELBOW STANDARD RADIUS ELBOW
FLEXIBLE DUCT CONNECTION
DUCT SIZE: WIDTH x DEPTH
DIFFUSER TYPE SIZE - BLOW PATTERN (4-WAY IF NONE SHOWN) AIR VOLUME IN CUBIC FEET per MINUTE (CFM) GRILLE TYPE SIZE AIR VOLUME IN CUBIC FEET per MINUTE (CFM) GRILLE TYPE SIZE AIR VOLUME IN CUBIC FEET per MINUTE (CFM)
SIDE WALL DIFFUSER OR GRILLE TYPE SIZE AIR VOLUME IN CUBIC FEET per MINUTE (CFM)
SLOT DIFFUSER TYPE LENGTH - # OF SLOTS - INLET SIZE AIR VOLUME IN CUBIC FEET per MINUTE (CFM)
INTERNALLY LINED OR DOUBLE WALL DUCTWORK
MANUAL VOLUME DAMPER
RECTANGULAR DUCT ANGLED CHANGE IN ELEVATION
ROUND DUCT ANGLED CHANGE IN ELEVATION
CONCENTRIC TRANSITION
ECCENTRIC TRANSITION
MITERED TEE WITH TURNING VANES
MITERED ELBOW WITH BRANCH FITTING
45 DEGREE LATERAL BRANCH, ROUND

45 DEGREE ENTRY BRANCH, ROUND OR RECTANGULAR

CONICAL BRANCH, ROUND

GENERAL			
SYMBOL	ABBREVIATION	DESCRIPTION	
(E)		EXISTING	1. 5
ø OR dia		DIAMETER	C N
€ (2)		NEW TO EXISTING POINT OF CONNECTION	2. F
		NOTE REFERENCE MARKER	E
1 A101 M-521	PLAN OR DETAIL NUMBER SHEET NUMBER	PLAN OR DETAIL REFERENCE MARKER	
	SECTION LETTER	SECTION REFERENCE MARKER W/VIEW DIRECTION	
M-301 AHU	EQUIPMENT TYPE		
	EQUIPMENT NUMBER	EQUIPMENT MARKER	M001
123		ROOM NUMBER	M099 M100
		EXISTING SHOWN LIGHT	M101
		NEW WORK SHOWN BOLD	
		EXISTING TO BE REMOVED	
		AREA OF DEMOLITION	

GENERAL NOTES

- 1. SIZE AND LOCATION OF ALL PIPING AND OTHER MECHANICAL EQUIPMENT IS APPROXIMATE. CONTRACTOR SHALL SITE VERIFY THE LOCATION OF EXISTING PIPING AND EQUIPMENT AND CONSTRUCT WORK FROM FIELD DIMENSIONS. CONTRACTOR SHALL MAKE ADJUSTMENTS NECESSARY TO ACCOMMODATE MINOR DEVIATIONS AT NO COST TO OWNER.
- FINE (LIGHT) LINE WORK INDICATES EXISTING PIPING AND OTHER MECHANICAL EQUIPMENT. BOLD (HEAVY) DASHED LINE WORK INDICATES DEMOLITION SCOPE.

SHEET INDEX - MECHANICAL

M001	LEGEND, GENERAL NOTES & SHEET INDEX
M099	DEMOLITION SITE PLAN - BELOW GRADE
M100	DEMOLITION SITE PLAN - 1ST FLOOR
M101	DEMOLITION SITE PLAN - ROOF LEVEL

ABBREVIATIONS

EWTENTERING WATER TEMPERATUREPHPHASEFLAFULL LOAD AMPSPPHPOUNDS per HOURFPMFEET PER MINUTEPSIPOUNDS per SQUARE INCH GAUGEFTFEETREQ'DREQUIREDFT WCFEET WATER COLUMNRFRETURN FANFUTFUTURERHRELATIVE HUMIDITYGPHGALLONS PER HOURRPMREVOLUTIONS per MINUTEGPMGALLONS PER MINUTESEERSEASONAL ENERGY EFFICIENCY RATIOGYP BD GYPSUM WALL BOARDSFSUPPLY FANHPHORSEPOWERSSSTAINLESS STEELHSPFHEATING SEASONALSTLSTEELPERFORMANCE FACTORTSPTOTAL STATIC PRESSUREHVACHEATING, VENTILATING, & AIR CONDITIONINGVFDVARIABLE FREQUENCY DRIVEHZHERTZ (CYCLES PER SECOND)WBWET BULBIAQINDOOR AIR QUALITYWCWATER COLUMNIEINVERT ELEVATIONWGWATER GAUGE	CONT DB Dba DN DP EAT EER EFF ESP EWT FLA FPM FT FT WC FUT GPH GPH GPH GPH GPH BCH HP HSPF HVAC HZ IAQ	AFF AFS ALT APC BHF BOIL CFN COID B bon D P AT E F F F F F T F C F N COID B bon D P AT E F F F F F T F T F F F F F F F F F F	FS. TOSPDHAUNNAR, TRFPVAM WTHMP PF AC	FEET PER MINUTE FEET FEET WATER COLUMN FUTURE GALLONS PER HOUR GALLONS PER MINUTE GYPSUM WALL BOARD HORSEPOWER HEATING SEASONAL PERFORMANCE FACTOR HEATING, VENTILATING, & AIR CONDITIONING HERTZ (CYCLES PER SECOND) INDOOR AIR QUALITY	IPLV IW LAT LBS LWT Ma MAX MBH MCA MFGR MIN MC NC NC NC NC NC NC NC NC NC NC NC NC NC	INDIRECT WASTE LEAVING AIR TEMPERATURE POUNDS LEAVING WATER TEMPERATURE MILLIAMPERE MAXIMUM THOUSAND BTUs per HOUR MINIMUM CIRCUIT AMPS MANUFACTURER MINIMUM MAX. OVERCURRENT PROTECTION NOISE CRITERIA NORMALLY CLOSED NOT IN CONTRACT NORMALLY OPEN NON-STANDARD PART LOAD VALUE NET POSITIVE SUCTION HEAD OWNER FURNISHED/ CONTRACTOR INSTALLED PRESSURE DROP PHASE POUNDS per HOUR POUNDS per SQUARE INCH GAUGE REQUIRED RETURN FAN RELATIVE HUMIDITY REVOLUTIONS per MINUTE SEASONAL ENERGY EFFICIENCY RATIO SUPPLY FAN STAINLESS STEEL STEEL TOTAL STATIC PRESSURE TYPICAL VARIABLE FREQUENCY DRIVE WET BULB WATER COLUMN	D
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SHEET TITLE: LEGEND, GENERAL NOTES & SHEET INDEX


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M001

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SHEET NOTES:

- DEMOLISH ALL (E) MECHANICAL EQUIPMENT, DUCTWORK, PIPING, FITTINGS, APPURTENANCES, & OTHER MECHANCIAL SYSTEMS INTERIOR TO THE BUILDING & ALL HYDRONIC PIPING PENETRATING THROUGH THE FLOOR SLAB & ROOF LOCATED IN THE BUILDING AREAS SHOWN. DEMOLISH ALL WORK THROUGH SLAB TO A DEPTH OF 2'-0" BELOW GRADE. NOTIFY OWNER'S AUTHORIZED REPRESENTATIVE IF DEMOLITION IS NEEDED BELOW 2'-0" BELOW GRADE.
- 2. (E) CONDITIONS INFORMATION SHOWN ON THIS DRAWING REPRESENTS INFORMATION FROM ORIGINAL DOCUMENTS & ON-SITE OBSERVATIONS OF ACCESSIBLE AREAS, & MAY NOT SHOW THE ENTIRE SCOPE OF DEMOLITION WORK. DIFFERENCES IN ACTUAL LOCATIONS & QUANTITIES OF (E) MECHANICAL EQUIPMENT, DUCTWORK, PIPING, FITTINGS, APPURTENANCES, & OTHER MECHANICAL SYSTEMS FROM THE LOCATIONS & QUANTITIES SHOWN ON DEMOLITION DRAWINGS DOES NOT RELIEVE THE CONTRACTOR OF THE RESPONSIBILITY TO PROVIDE COMPLETE DEMOLITION OF MECHANICAL SYSTEMS AS NOTED ABOVE.





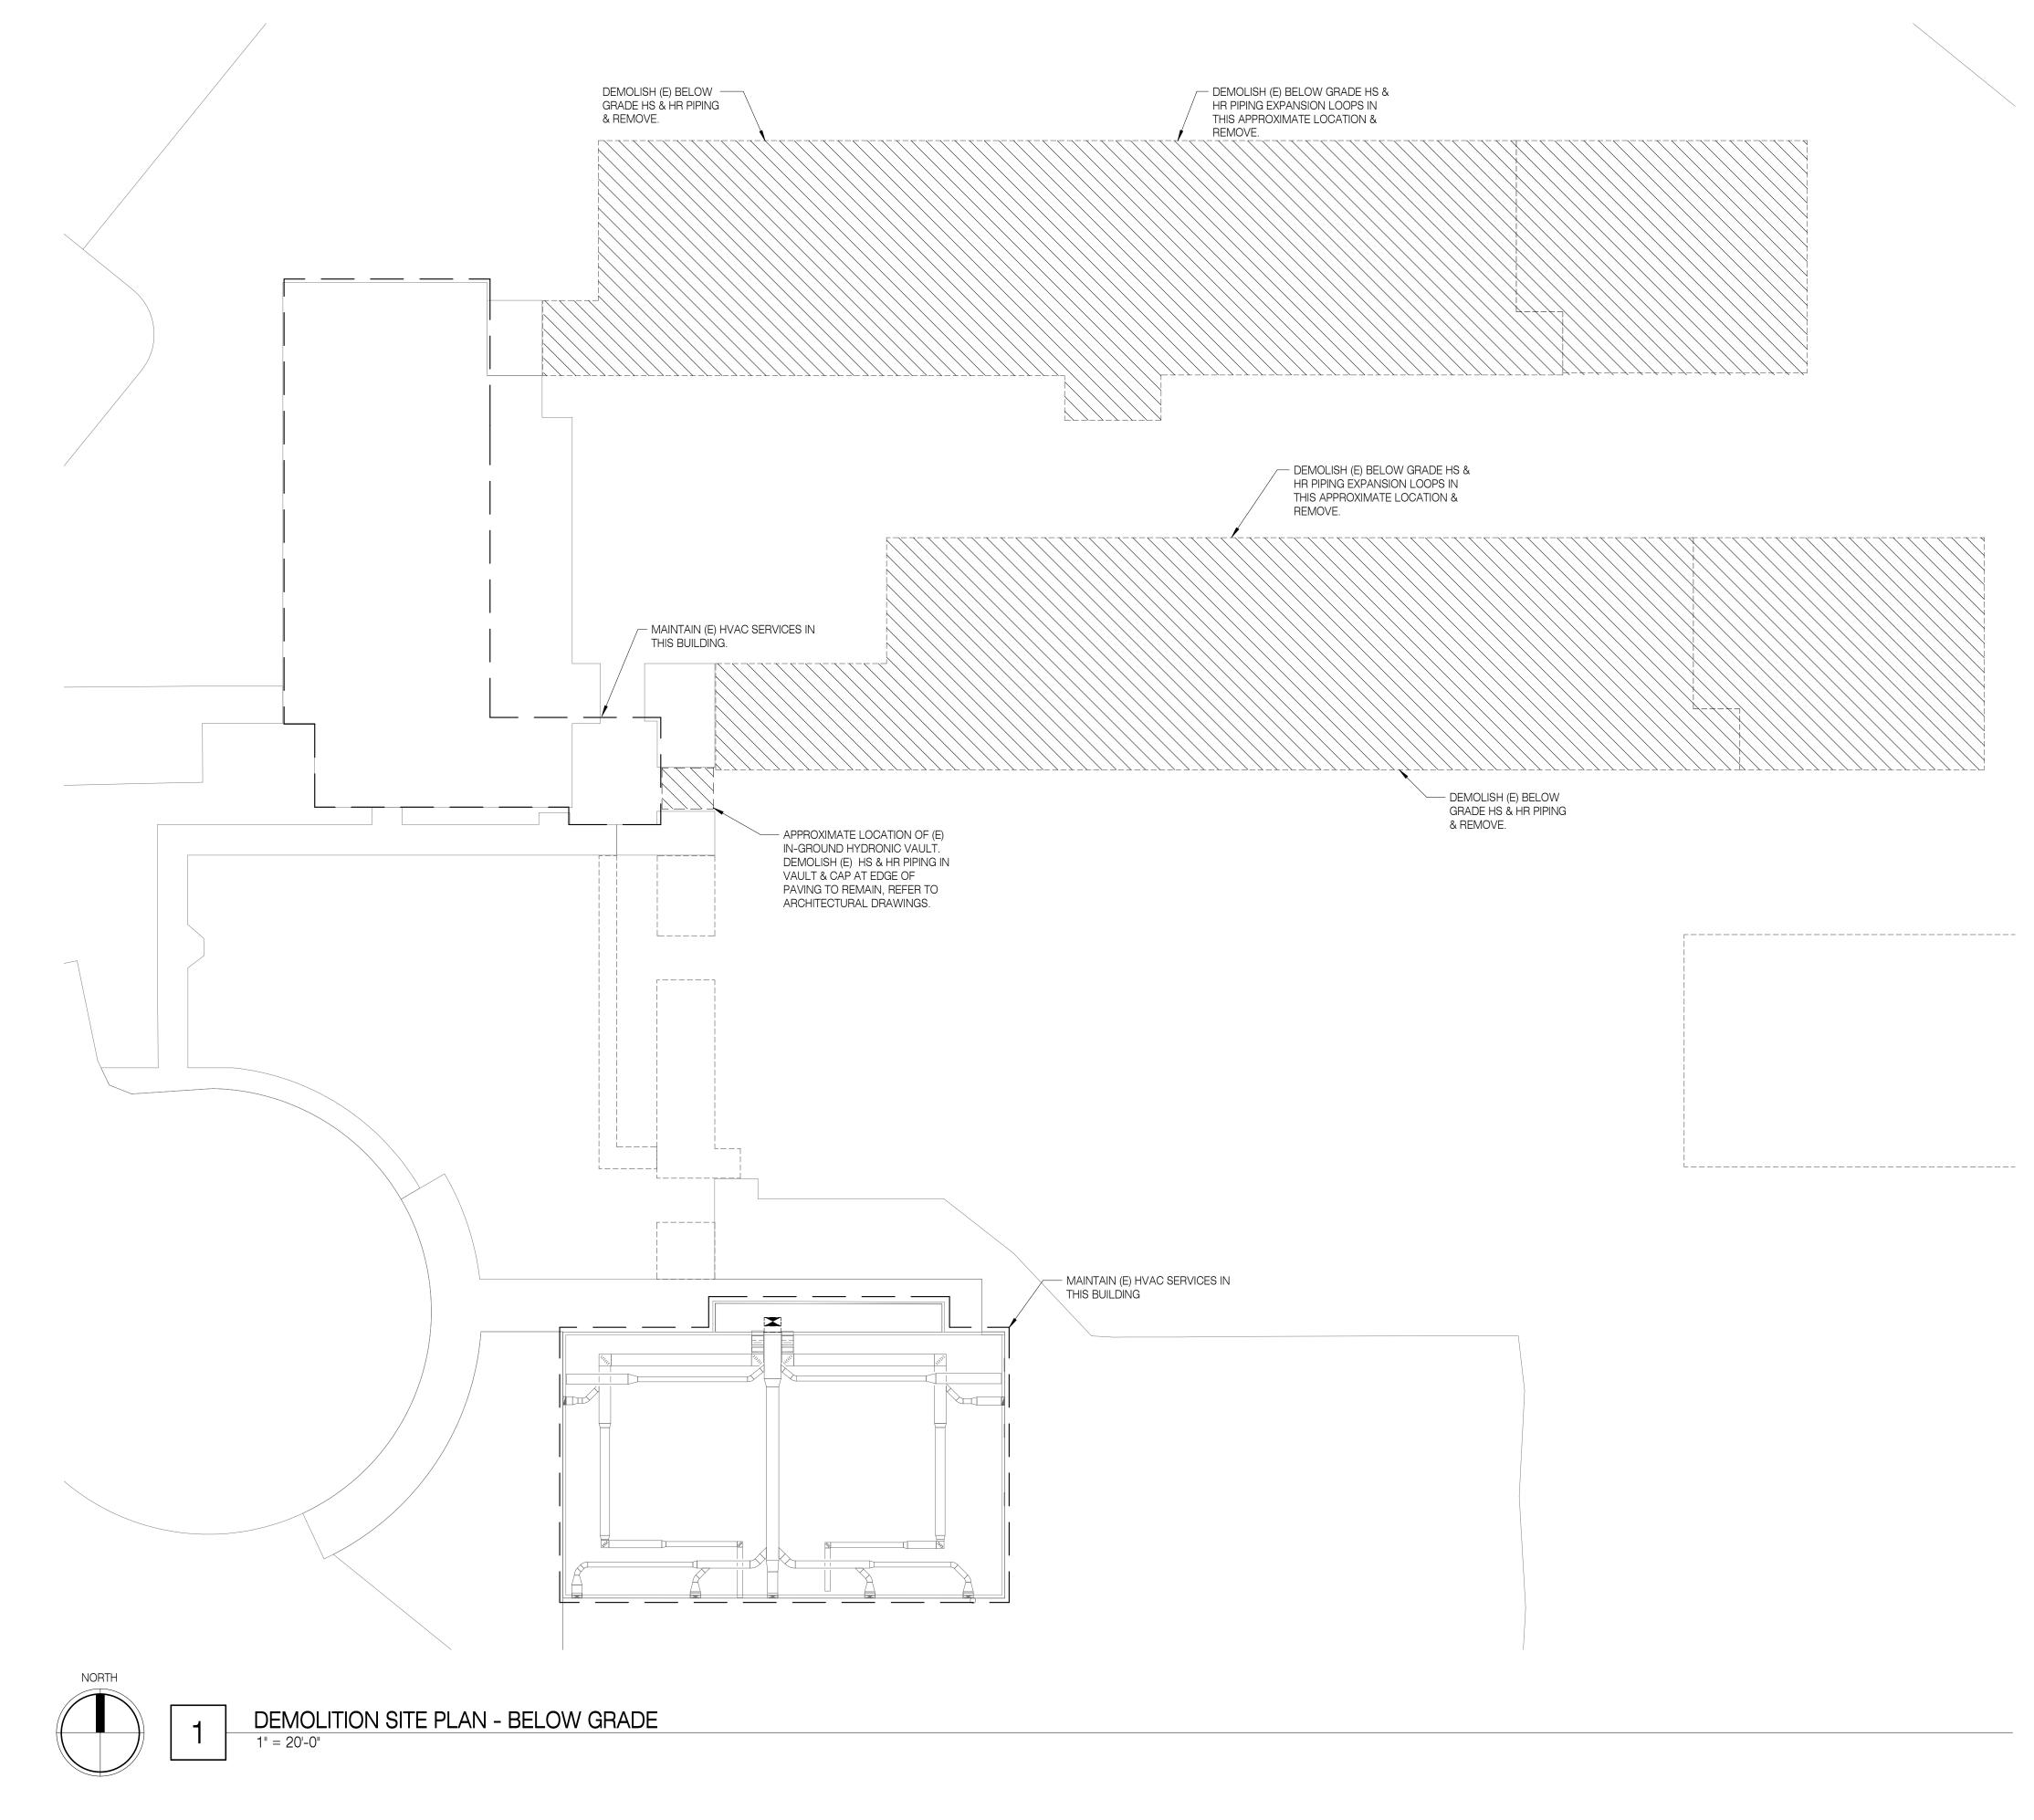




SHEET TITLE: DEMOLITION SITE PLAN -BELOW GRADE


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M099





SHEET NOTES:

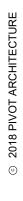- DEMOLISH ALL (E) MECHANICAL EQUIPMENT, DUCTWORK, PIPING, FITTINGS, APPURTENANCES, & OTHER MECHANCIAL SYSTEMS INTERIOR TO THE BUILDING & ALL HYDRONIC PIPING PENETRATING THROUGH THE FLOOR SLAB & ROOF LOCATED IN THE BUILDING AREAS SHOWN. DEMOLISH ALL WORK THROUGH SLAB TO A DEPTH OF 2'-0" BELOW GRADE. NOTIFY OWNER'S AUTHORIZED REPRESENTATIVE IF DEMOLITION IS NEEDED BELOW 2'-0" BELOW GRADE.
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REFERENCE NOTES:

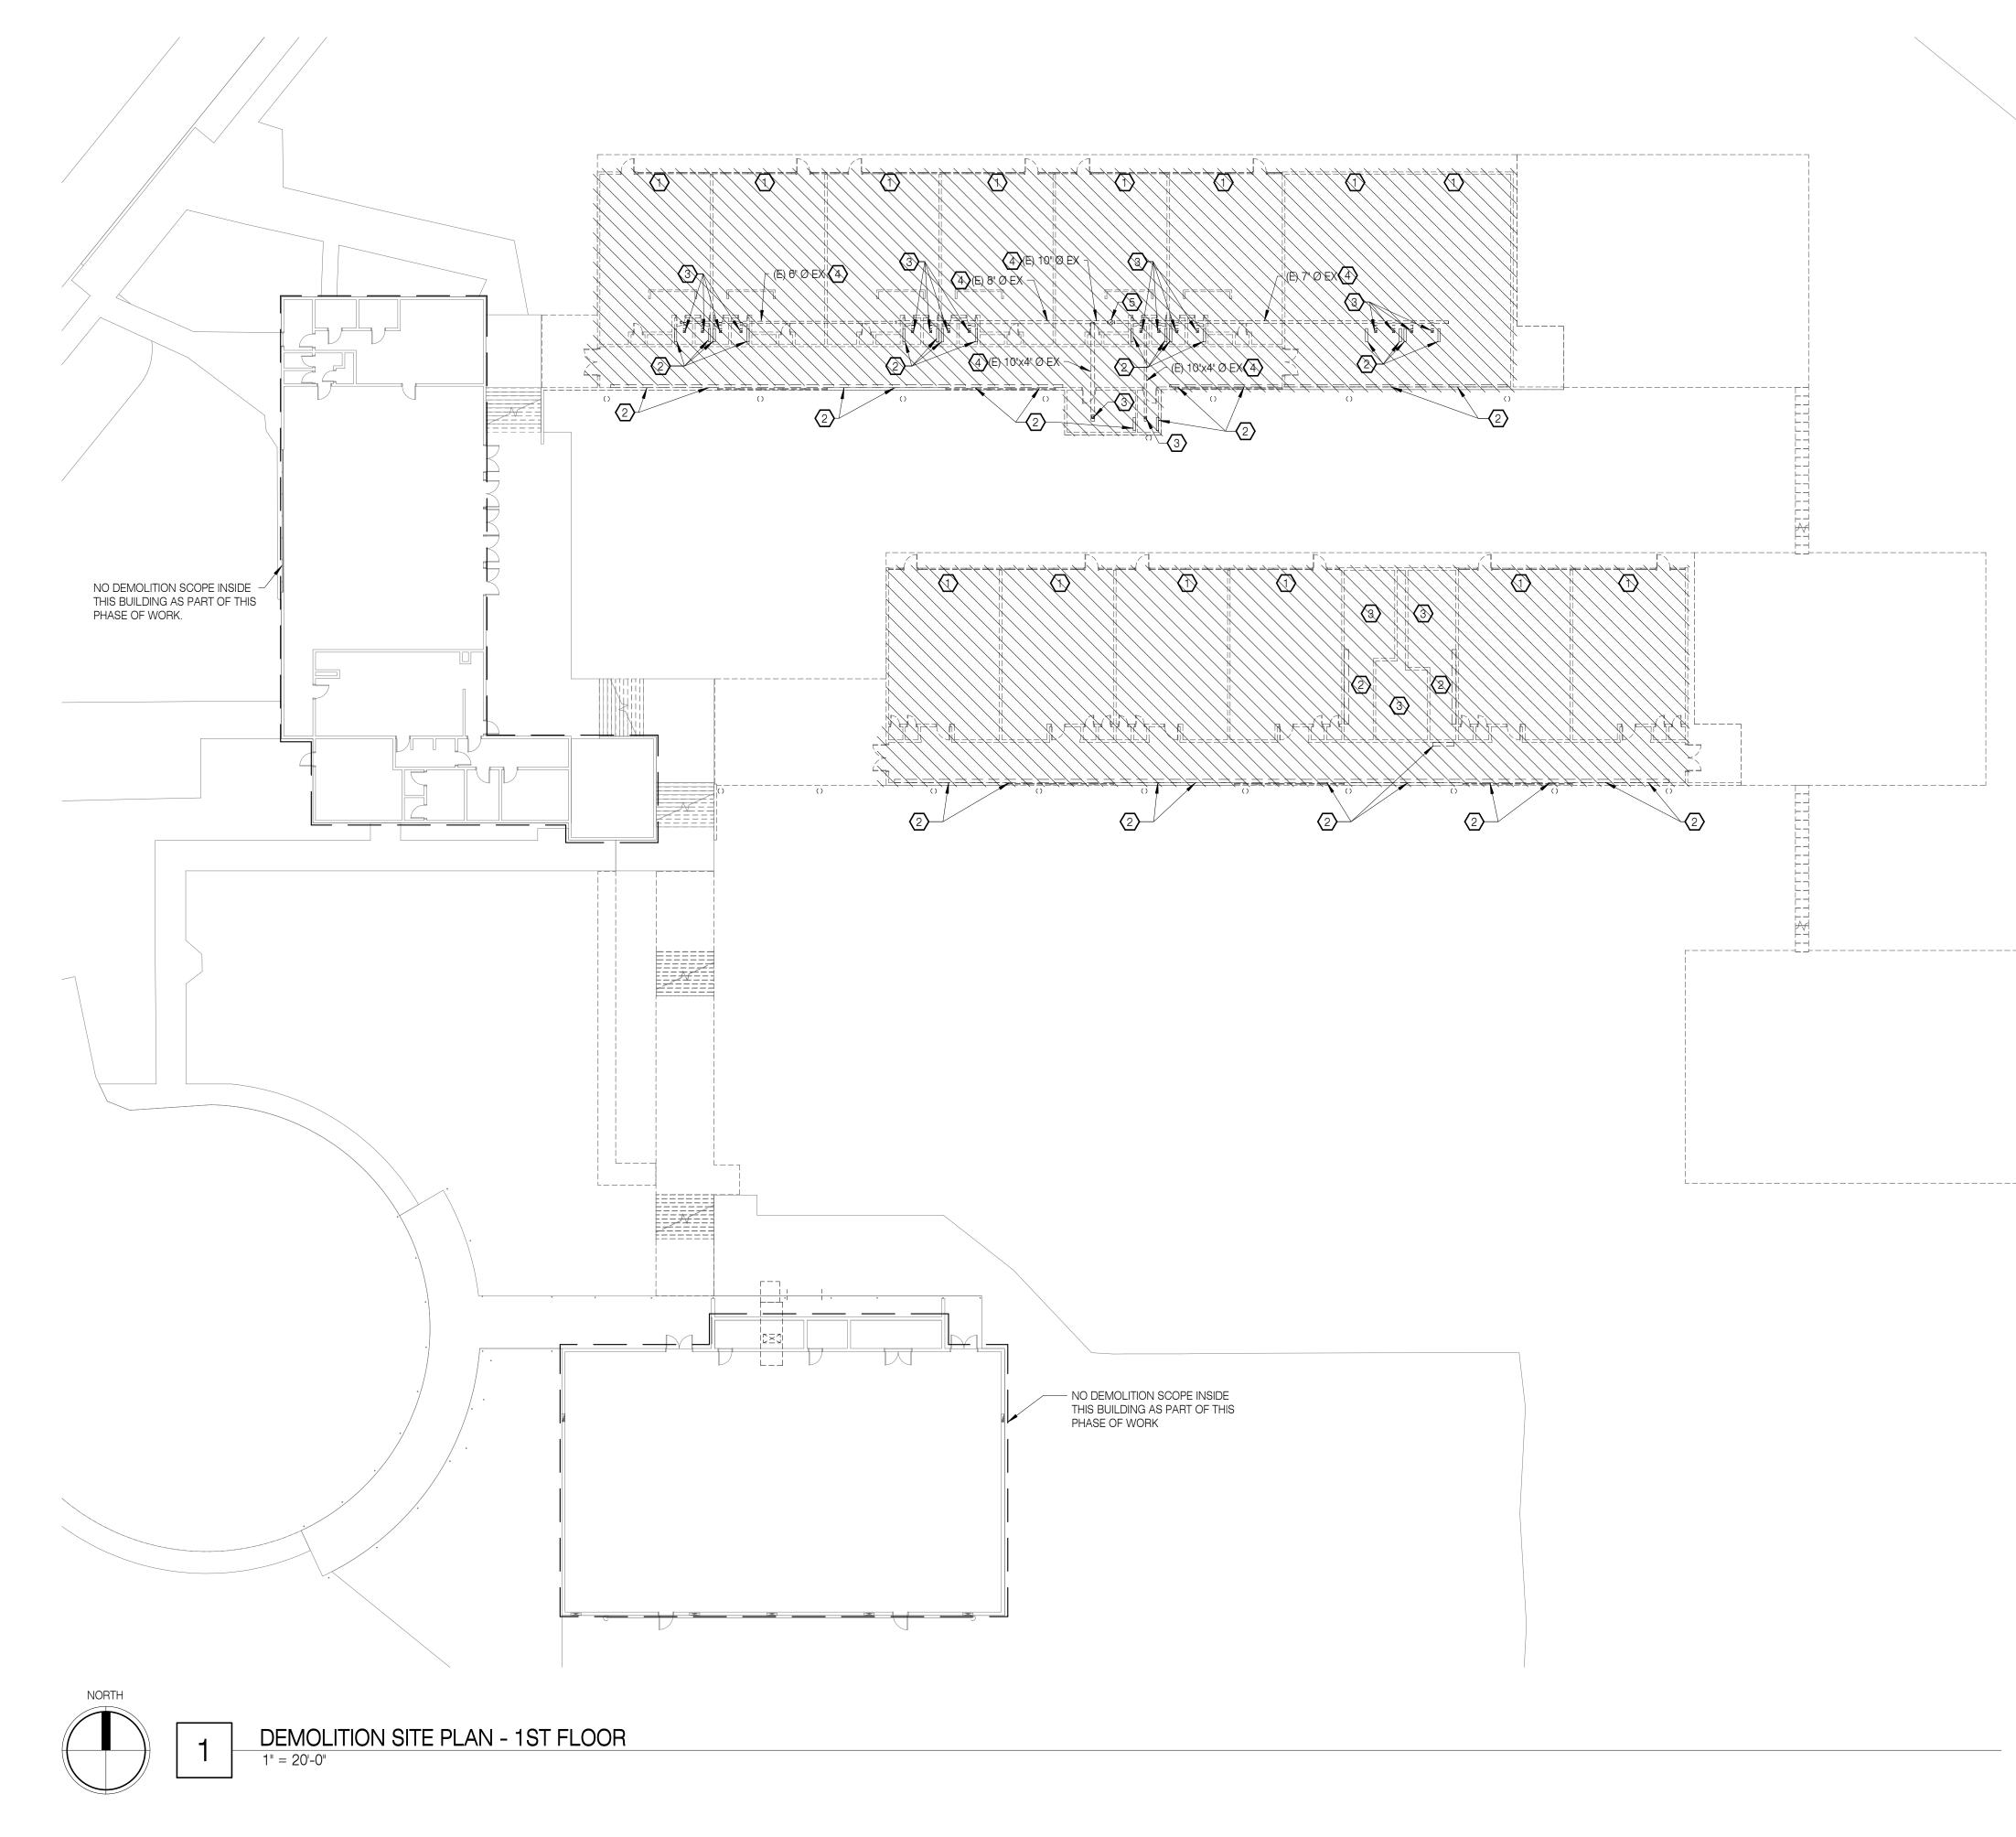- DEMOLISH & REMOVE (E) UNIT VENTILATOR & ASSOCIATED HS & HR PIPING, DUCTWORK, & GRILLE.
- DEMOLISH & REMOVE (E) CONVECTORS & ASSOCIATED HS & HR PIPING.
- DEMOLISH & REMOVE (E) EXHAUST GRILLES IN RESTROOM OR STORAGE ROOM & ASSOCIATED DUCTWORK.
- 4 DEMOLISH & REMOVE (E) DUCTWORK.
- 5 DEMOLISH & REMOVE (E) 14" DIA EXHAUST DUCTWORK UIP THROUGH ROOF & ASSOCIATED EXHAUST FAN.







DEMOLITION SET	WILLARD SWING SCHOO	4J SCHOOL DISTRICT 2840 LINCOLN ST
DEM	4)	4J S 2840
	4	4J S 2840
SHEE DEN	NOLITI	ON 4 8
SHEE DEN SIT		4 Ñ ON 1 -
SHEE DEN SIT	NOLITI E PLAN	4 Ñ ON 1 -
SHEE DEN SIT	NOLITI E PLAN	4 Ñ ON 1 -
SHEE DEN SIT	MOLITI E PLAN FLOO	4 Ñ ON 1 -


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M100



SCALE OF 11 × 17 SHEETS IS HALF OF SCALE INDICATED



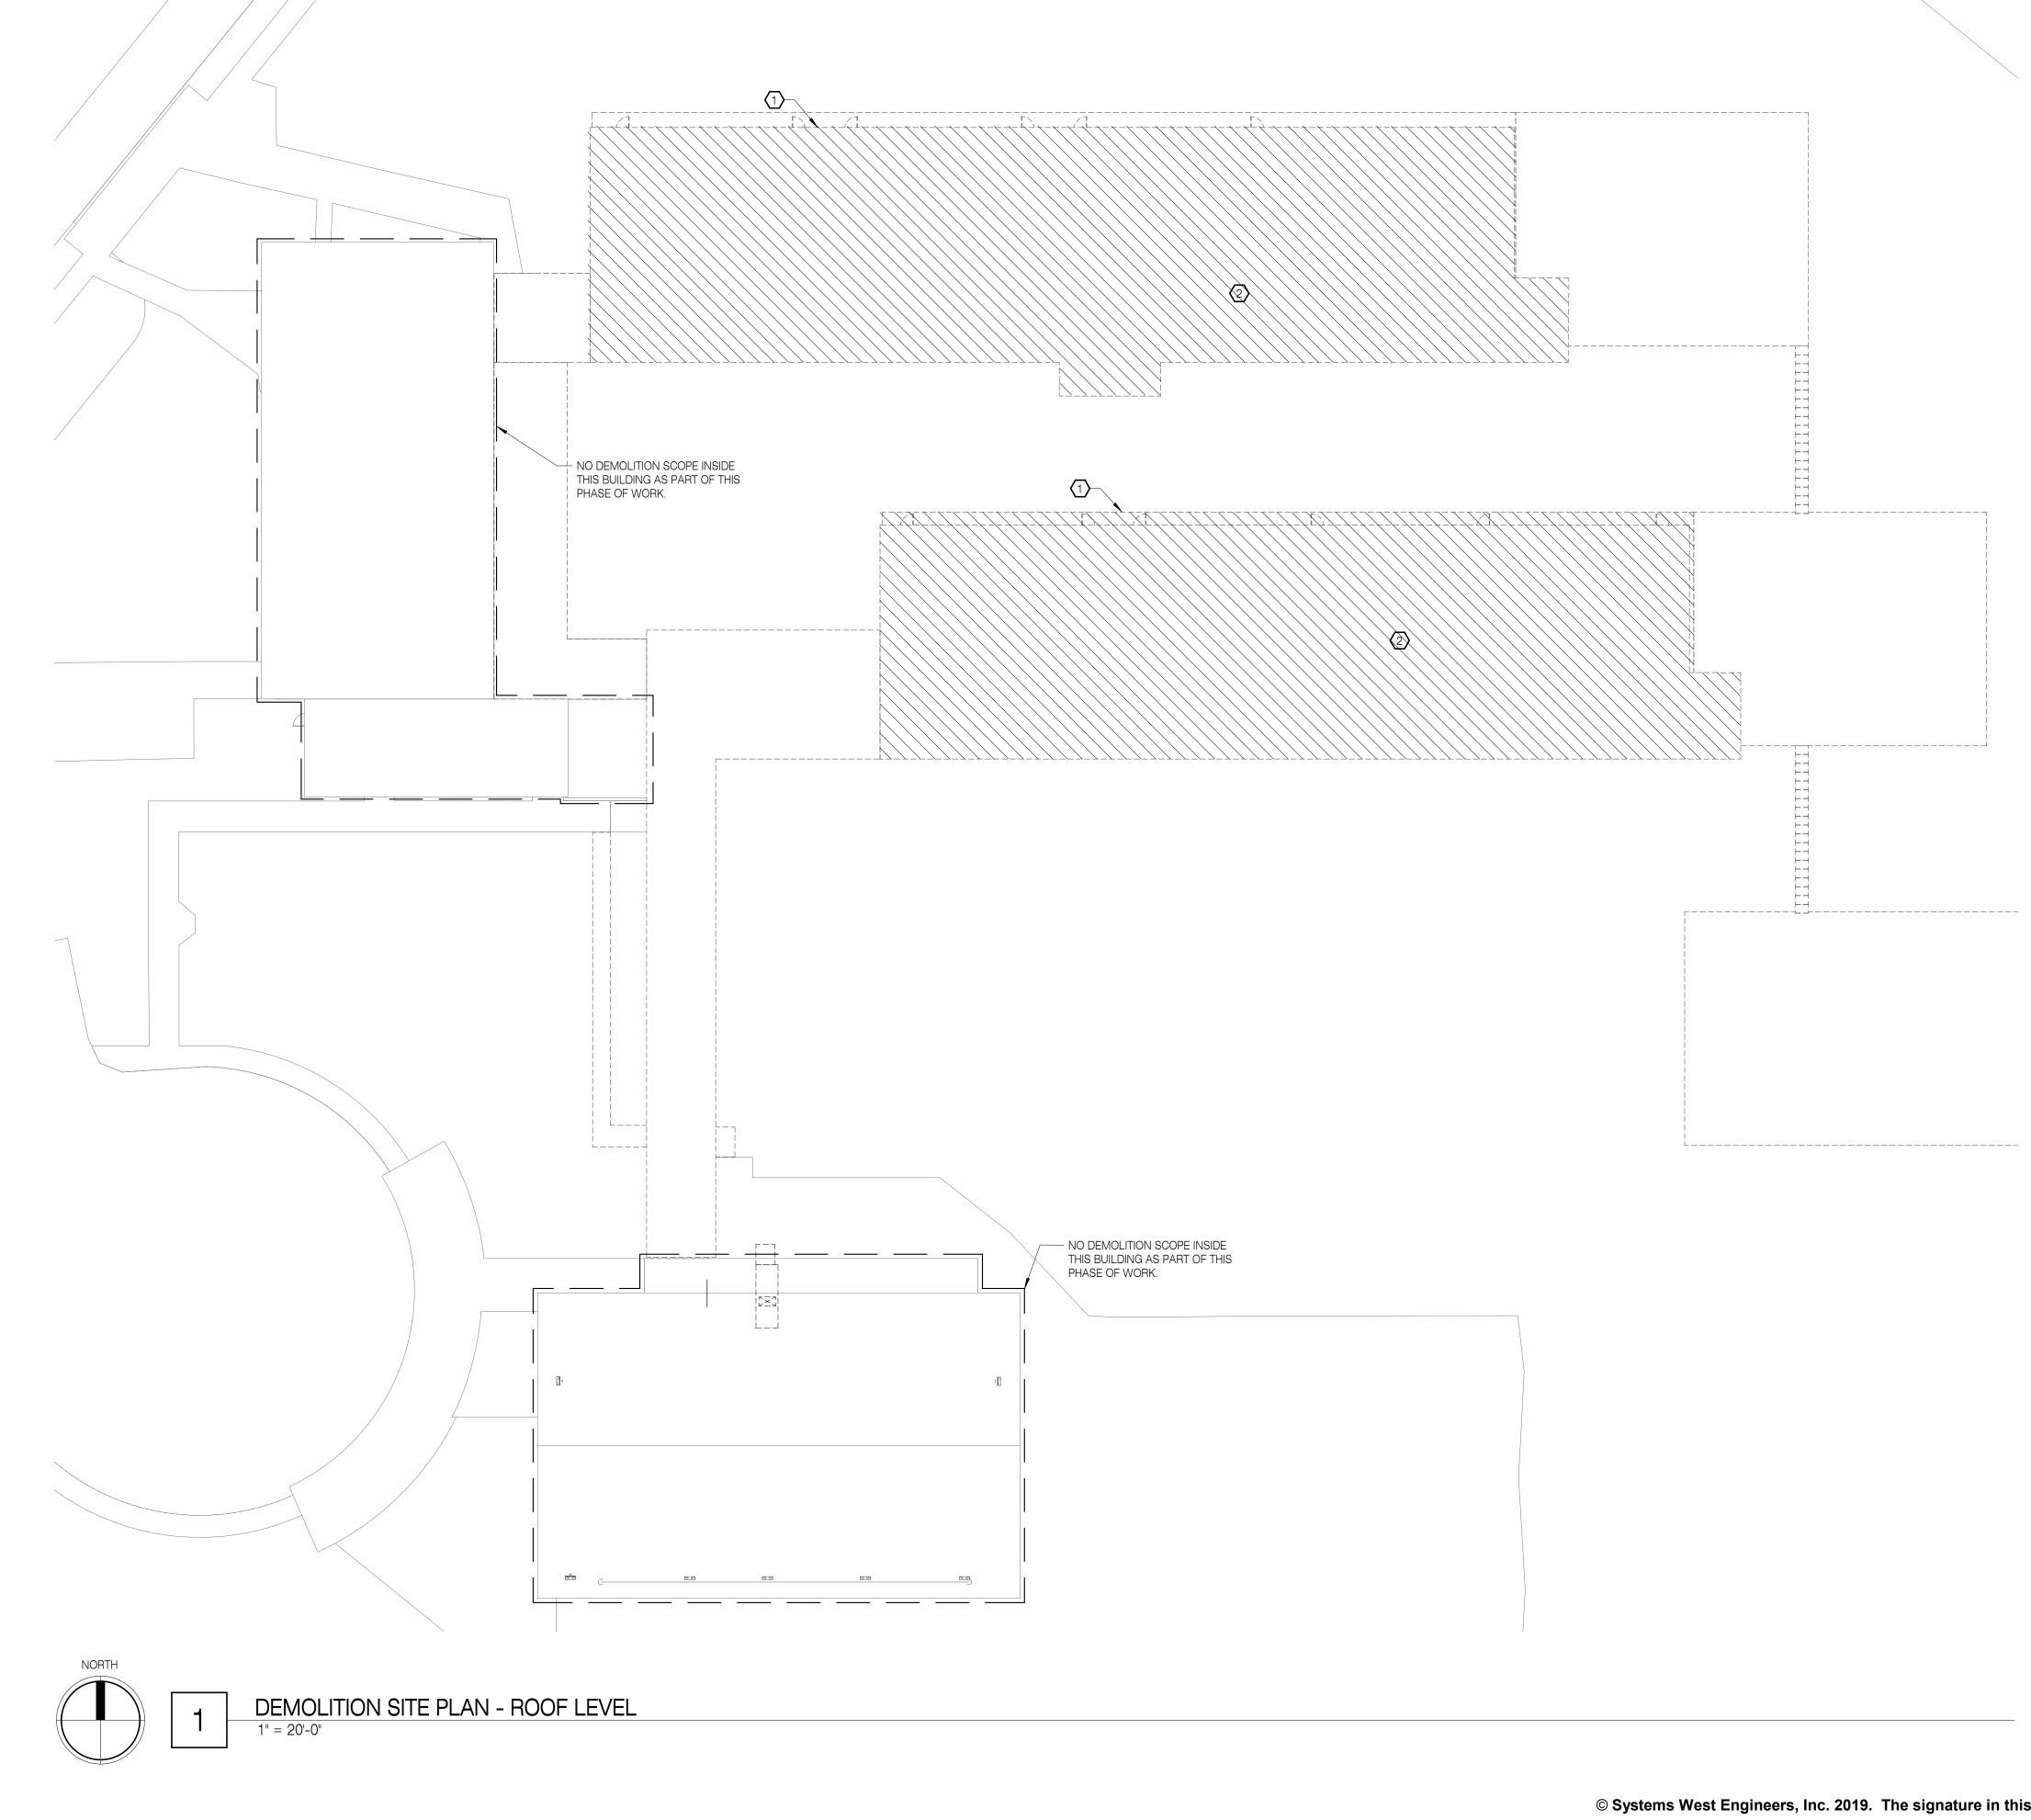

SHEET NOTES:

- 1. DEMOLISH ALL (E) MECHANICAL EQUIPMENT, DUCTWORK, PIPING, FITTINGS, APPURTENANCES, & OTHER MECHANCIAL SYSTEMS INTERIOR TO THE BUILDING & ALL HYDRONIC PIPING PENETRATING THROUGH THE FLOOR SLAB & ROOF LOCATED IN THE BUILDING AREAS SHOWN. DEMOLISH ALL WORK THROUGH SLAB TO A DEPTH OF 2'-0" BELOW GRADE. NOTIFY OWNER'S AUTHORIZED REPRESENTATIVE IF DEMOLITION IS NEEDED BELOW 2'-0" BELOW GRADE.
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REFERENCE NOTES:

DEMOLISH & REMOVE (E) ROOF-MOUNTED GRAVITY VENTILATORS & ASSOCIATED DUCTWORK.

2 DEMOLISH & REMOVE (E) EXHAUST FAN.









DEMOLITION SITE PLAN -ROOF LEVEL

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#	DES

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<u>plumbing legend</u>

SYMBOL
OO
R <u>S=0.01</u>
R RETURN]
) WATER
\longrightarrow
di.
م
IPPLY PRESSURE)
●

SYMBOL	ABBREV.	DESCRIPTION
OO		PIPING UP
		PIPING DOWN
_		SLOPE OF PIPE IN DECIMALS OF FEET CAPPED PIPE
		PIPE REDUCING FITTING: CONCENTRIC, ECCENTRIC
\longrightarrow		DIRECTION OF FLOW
		UNION
——————————————————————————————————————		PUMP
გი	DV	DRAIN VALVE
`	BV	BALL VALVE
I[BFV	BUTTERFLY VALVE
<u>_</u> ^	CHV	CHECK VALVE
	GV	GATE VALVE
	SV	SOLENOID VALVE
¥	PRV	PRESSURE REGULATING VALVE
		FLEXIBLE PIPE CONNECTION
<u> </u>		WYE STRAINER
Q		
		THERMOMETER
Ŷ		PRESSURE GAUGE
_		TEST PLUG
Ø		METER, SELF-CONTAINED
φ	COTG, FCO	CLEANOUT TO GRADE, FLOOR CLEANOUT
	WCO	WALL CLEANOUT
۲	FD	FLOOR DRAIN
	HB	HOSE BIBB (DIAGRAM)
	HB	HOSE BIBB (PLAN)
RP		REDUCED PRESSURE BACKFLOW PREVENTER
DC		DOUBLE CHECK BACKFLOW PREVENTER
		WATER HAMMER ARRESTOR

CALE

GENERAL				BREVIATIONS		
SYMBOL	ABBREVIATION	DESCRIPTION	ACH	AIR CHANGES PER HOUR	IN	INCHES
			AFF	ABOVE FINISHED FLOOR		INCHES WATER COLUMN
(E)		EXISTING	AFS	AUTOMATIC FIRE SPRINKLER	IPLV	INTEGRATED PART LOAD VALUE
ø OR dia		DIAMETER	AL	ALUMINUM	IW	INDIRECT WASTE
Θ		NEW TO EXISTING POINT OF CONNECTION	ALT	ALTERNATE	LAT	LEAVING AIR TEMPERATURE
$\langle 2 \rangle$			APD	AIR PRESSURE DROP	LBS	
$\sqrt{2}$		NOTE REFERENCE MARKER	BAS BHP	BUILDING AUTOMATION SYSTEM BRAKE HORSEPOWER	LWT Ma	LEAVING WATER TEMPERATURE MILLIAMPERE
			BOD	BOTTOM OF DUCT	MAX	MAXIMUM
	PLAN OR DETAIL NUMBER	PLAN OR DETAIL REFERENCE MARKER	BTUH	BRITISH THERMAL UNITS PER HOUR	MBH	THOUSAND BTUs per HOUR
A101 M-521	SHEET NUMBER		CFH	CUBIC FEET per HOUR	MCA	MINIMUM CIRCUIT AMPS
			CFM	CUBIC FEET per MINUTE	MFGR	MANUFACTURER
	SECTION LETTER		CMU	CONCRETE MASONRY UNIT	MIN	MINIMUM
	SHEET NUMBER	SECTION REFERENCE MARKER		CONCRETE	MOP	MAX. OVERCURRENT PROTECTION
M-301	SHEET NUMBER		CONT		NC	NOISE CRITERIA
<u> </u>			DB	DRY BULB	NC	NORMALLY CLOSED
AHU	EQUIPMENT TYPE		Dba DN	DECIBELS ACOUSTIC	NIC NO	
	EQUIPMENT NUMBER	EQUIPMENT MARKER	DN DP	DOWN DIFFERENTIAL PRESSURE	NO NPLV	NORMALLY OPEN NON-STANDARD PART LOAD VALUE
			EAT	ENTERING AIR TEMPERATURE	NPSH	NON-STANDARD FART LOAD VALUE
123		ROOM NUMBER	EER	ENERGY EFFICIENCY RATIO	OFCI	OWNER FURNISHED/
			EFF	EFFICIENCY		CONTRACTOR INSTALLED
		EXISTING SHOWN LIGHT	ESP	EXTERNAL STATIC PRESSURE	PD	PRESSURE DROP
		NEW WORK SHOWN BOLD	EWT	ENTERING WATER TEMPERATURE	PH	PHASE
			FLA	FULL LOAD AMPS	PPH	POUNDS per HOUR
		EXISTING TO BE REMOVED	FPM	FEET PER MINUTE	PSI	POUNDS per SQUARE INCH GAUGE
			FT	FEET FEET WATER COLUMN	REQ'D RF	REQUIRED RETURN FAN
		AREA OF DEMOLITION	FUT	FUTURE	RH	RELATIVE HUMIDITY
			GPH	GALLONS PER HOUR	RPM	REVOLUTIONS per MINUTE
			GPM	GALLONS PER MINUTE	SEER	SEASONAL ENERGY EFFICIENCY RATIO
			GYP B	D GYPSUM WALL BOARD	SF	SUPPLY FAN
			HP	HORSEPOWER	SS	STAINLESS STEEL
			HSPF	HEATING SEASONAL	STL	STEEL
				PERFORMANCE FACTOR	TSP	TOTAL STATIC PRESSURE
			HVAC	1	TYP	
			Ц7	& AIR CONDITIONING	VFD	

ΗZ

IAQ

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GENERAL NOTES

- 1. SIZE AND LOCATION OF ALL PIPING AND OTHER MECHANICAL EQUIPMENT IS APPROXIMATE. CONTRACTOR SHALL SITE VERIFY THE LOCATION OF EXISTING PIPING AND EQUIPMENT AND CONSTRUCT WORK FROM FIELD DIMENSIONS. CONTRACTOR SHALL MAKE ADJUSTMENTS NECESSARY TO ACCOMMODATE MINOR DEVIATIONS AT NO COST TO OWNER.
- 2. FINE (LIGHT) LINE WORK INDICATES EXISTING PIPING AND OTHER MECHANICAL EQUIPMENT. BOLD (HEAVY) DASHED LINE WORK INDICATES DEMOLITION SCOPE.

WB WET BULB WC WATER COLUMN WG WATER GAUGE

HERTZ (CYCLES PER SECOND)

INDOOR AIR QUALITY

INVERT ELEVATION







SHEET INDEX - PLUMBING

P001 P099 P100

LEGEND, GENERAL NOTES & SHEET INDEX DEMOLITION SITE PLAN - BELOW GRADE DEMOLITION SITE PLAN

> SCHO SWING DEMOLITION SET 4J WILLARD £


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SHEET TITLE: LEGEND, GENERAL NOTES & SHEET INDEX

REVISIONS: # DESCRP. DATE

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P001



- 1. DEMOLISH ALL (E) PLUMBING FIXTURES, EQUIPMENT, PIPING, FITTINGS, APPURTENANCES, & OTHER PLUMBING SYSTEMS INTERIOR TO THE BUILDING & ALL PLUMBING PIPING PENETRATING THROUGH THE FLOOR SLAB & ROOF LOCATED IN THE BUILDING AREAS SHOWN. DEMOLISH ALL WORK THROUGH SLAB TO A DEPTH OF 2'-0" BELOW GRADE. NOTIFY OWNER'S AUTHORIZED REPRESENTATIVE IF DEMOLITION IS NEEDED BELOW 2'-0" BELOW GRADE.
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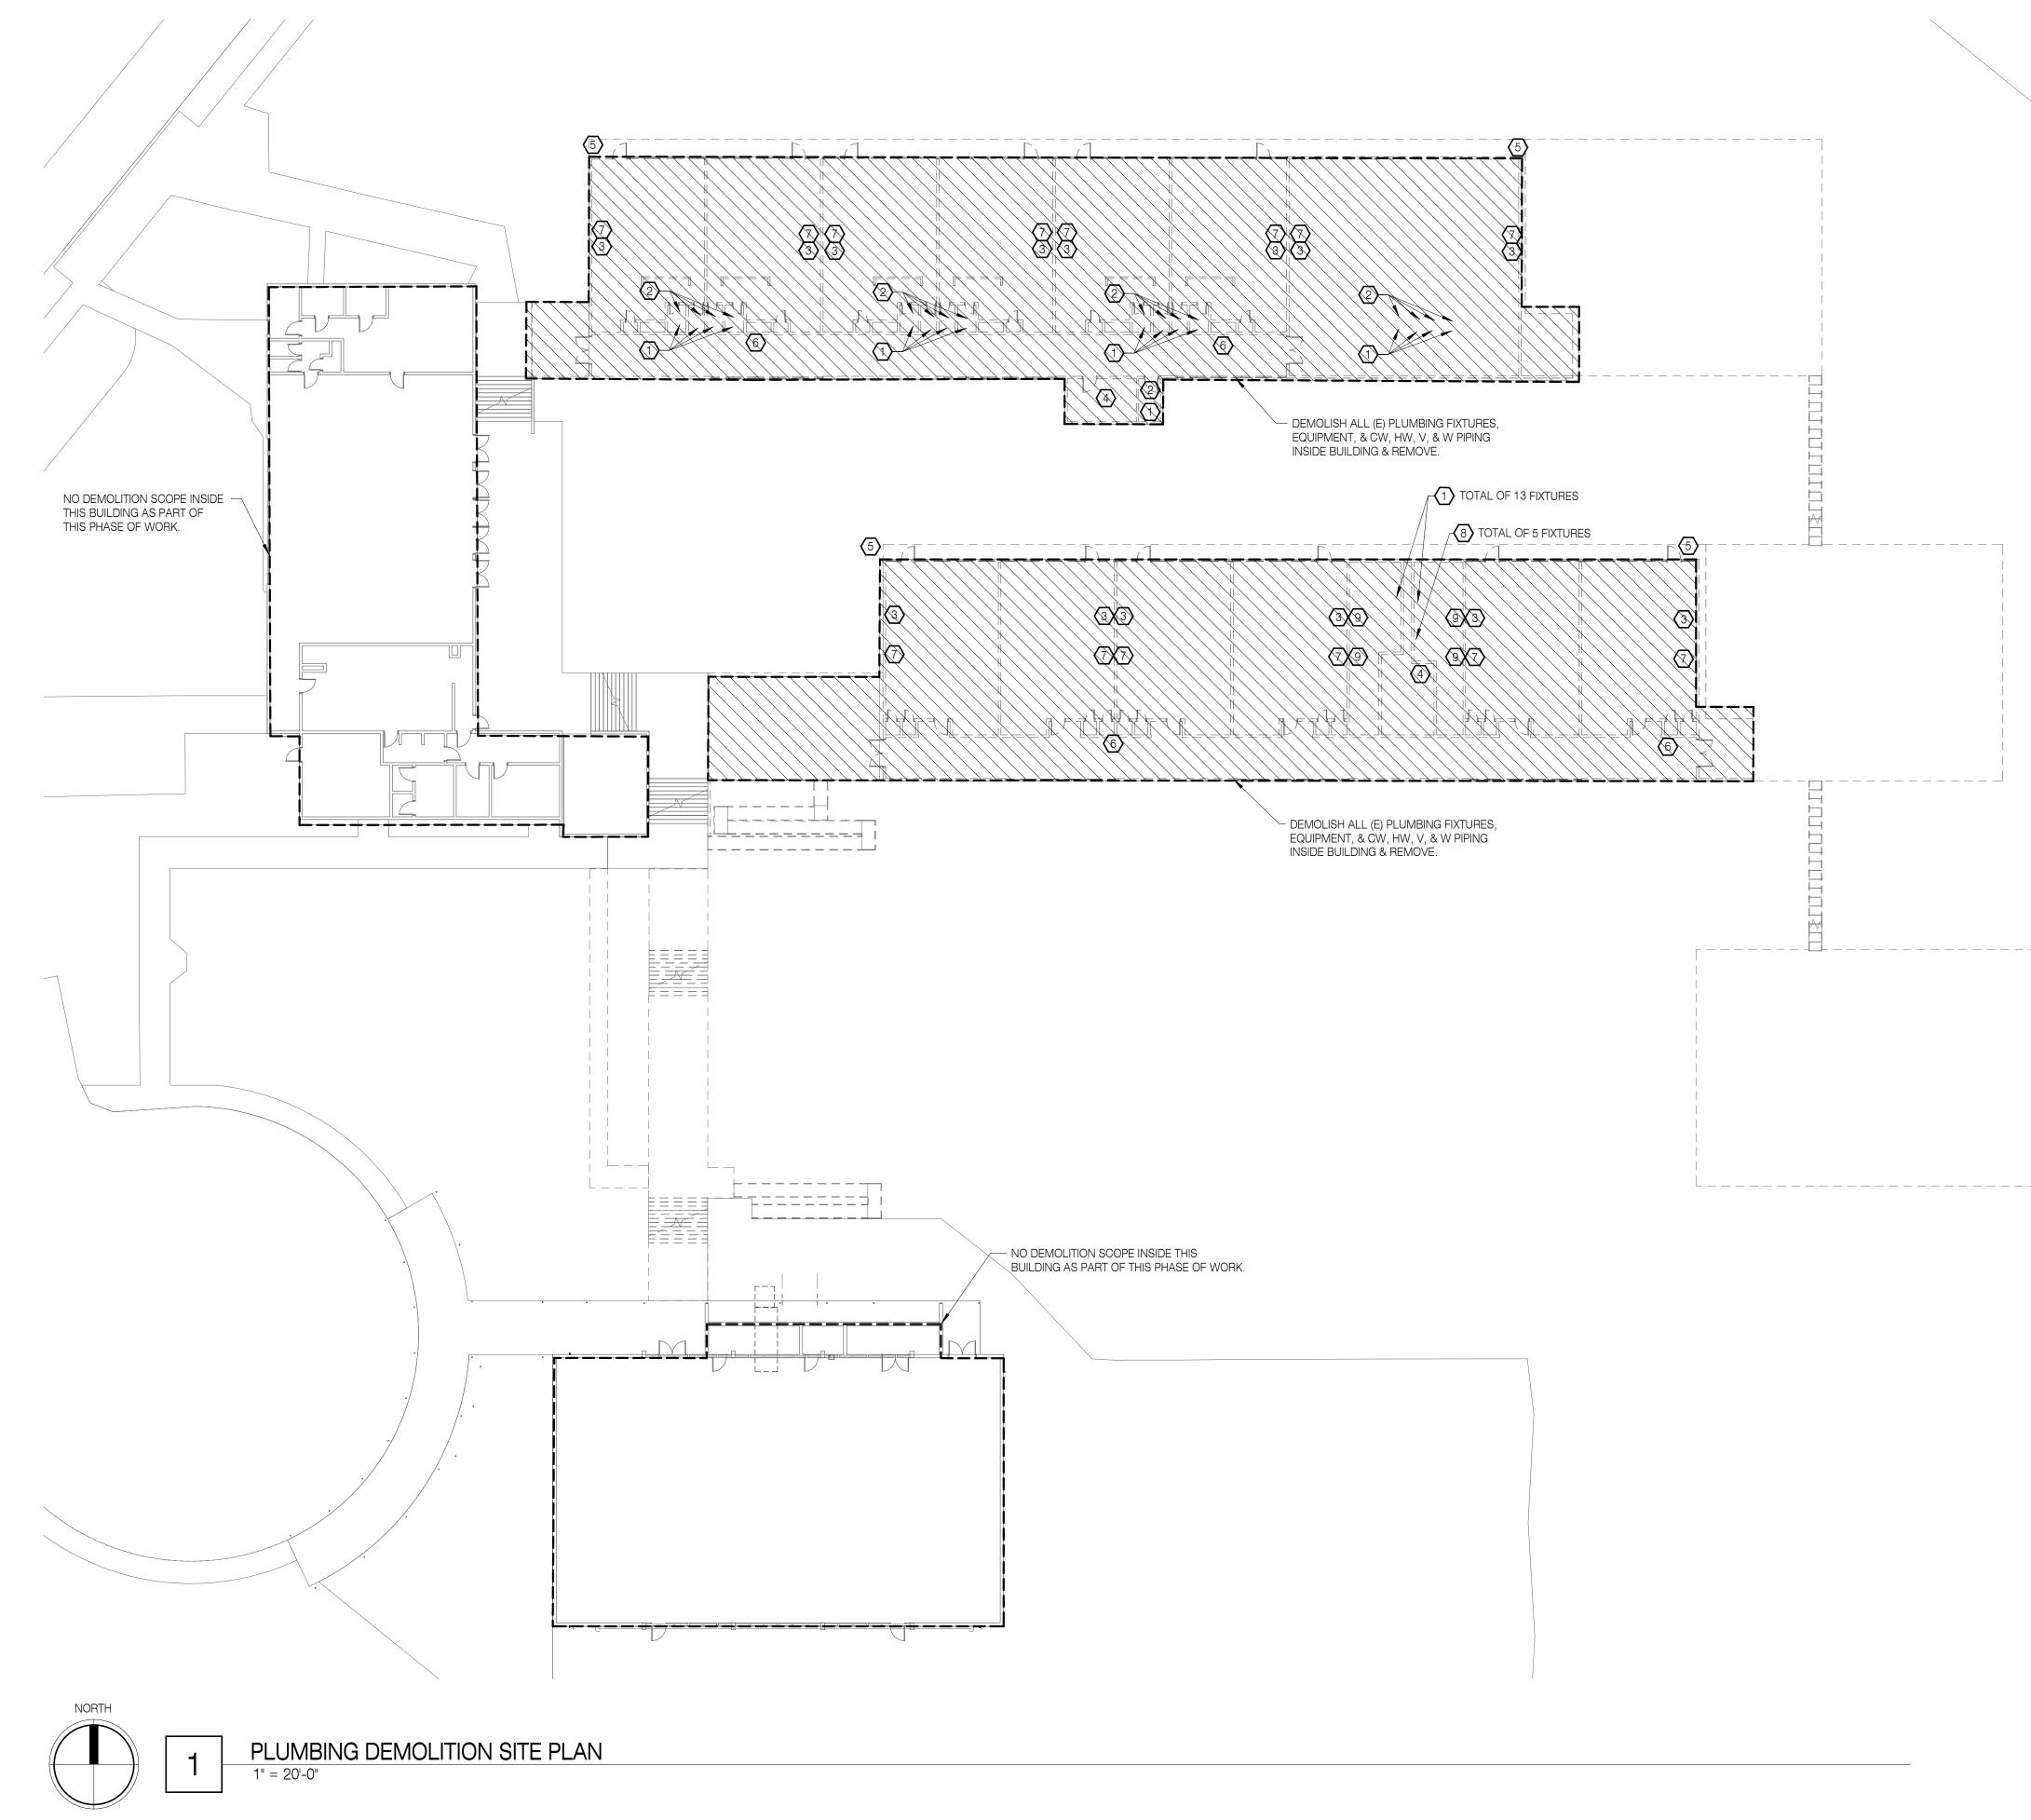
SHEET TITLE: DEMOLITION SITE PLAN -BELOW GRADE
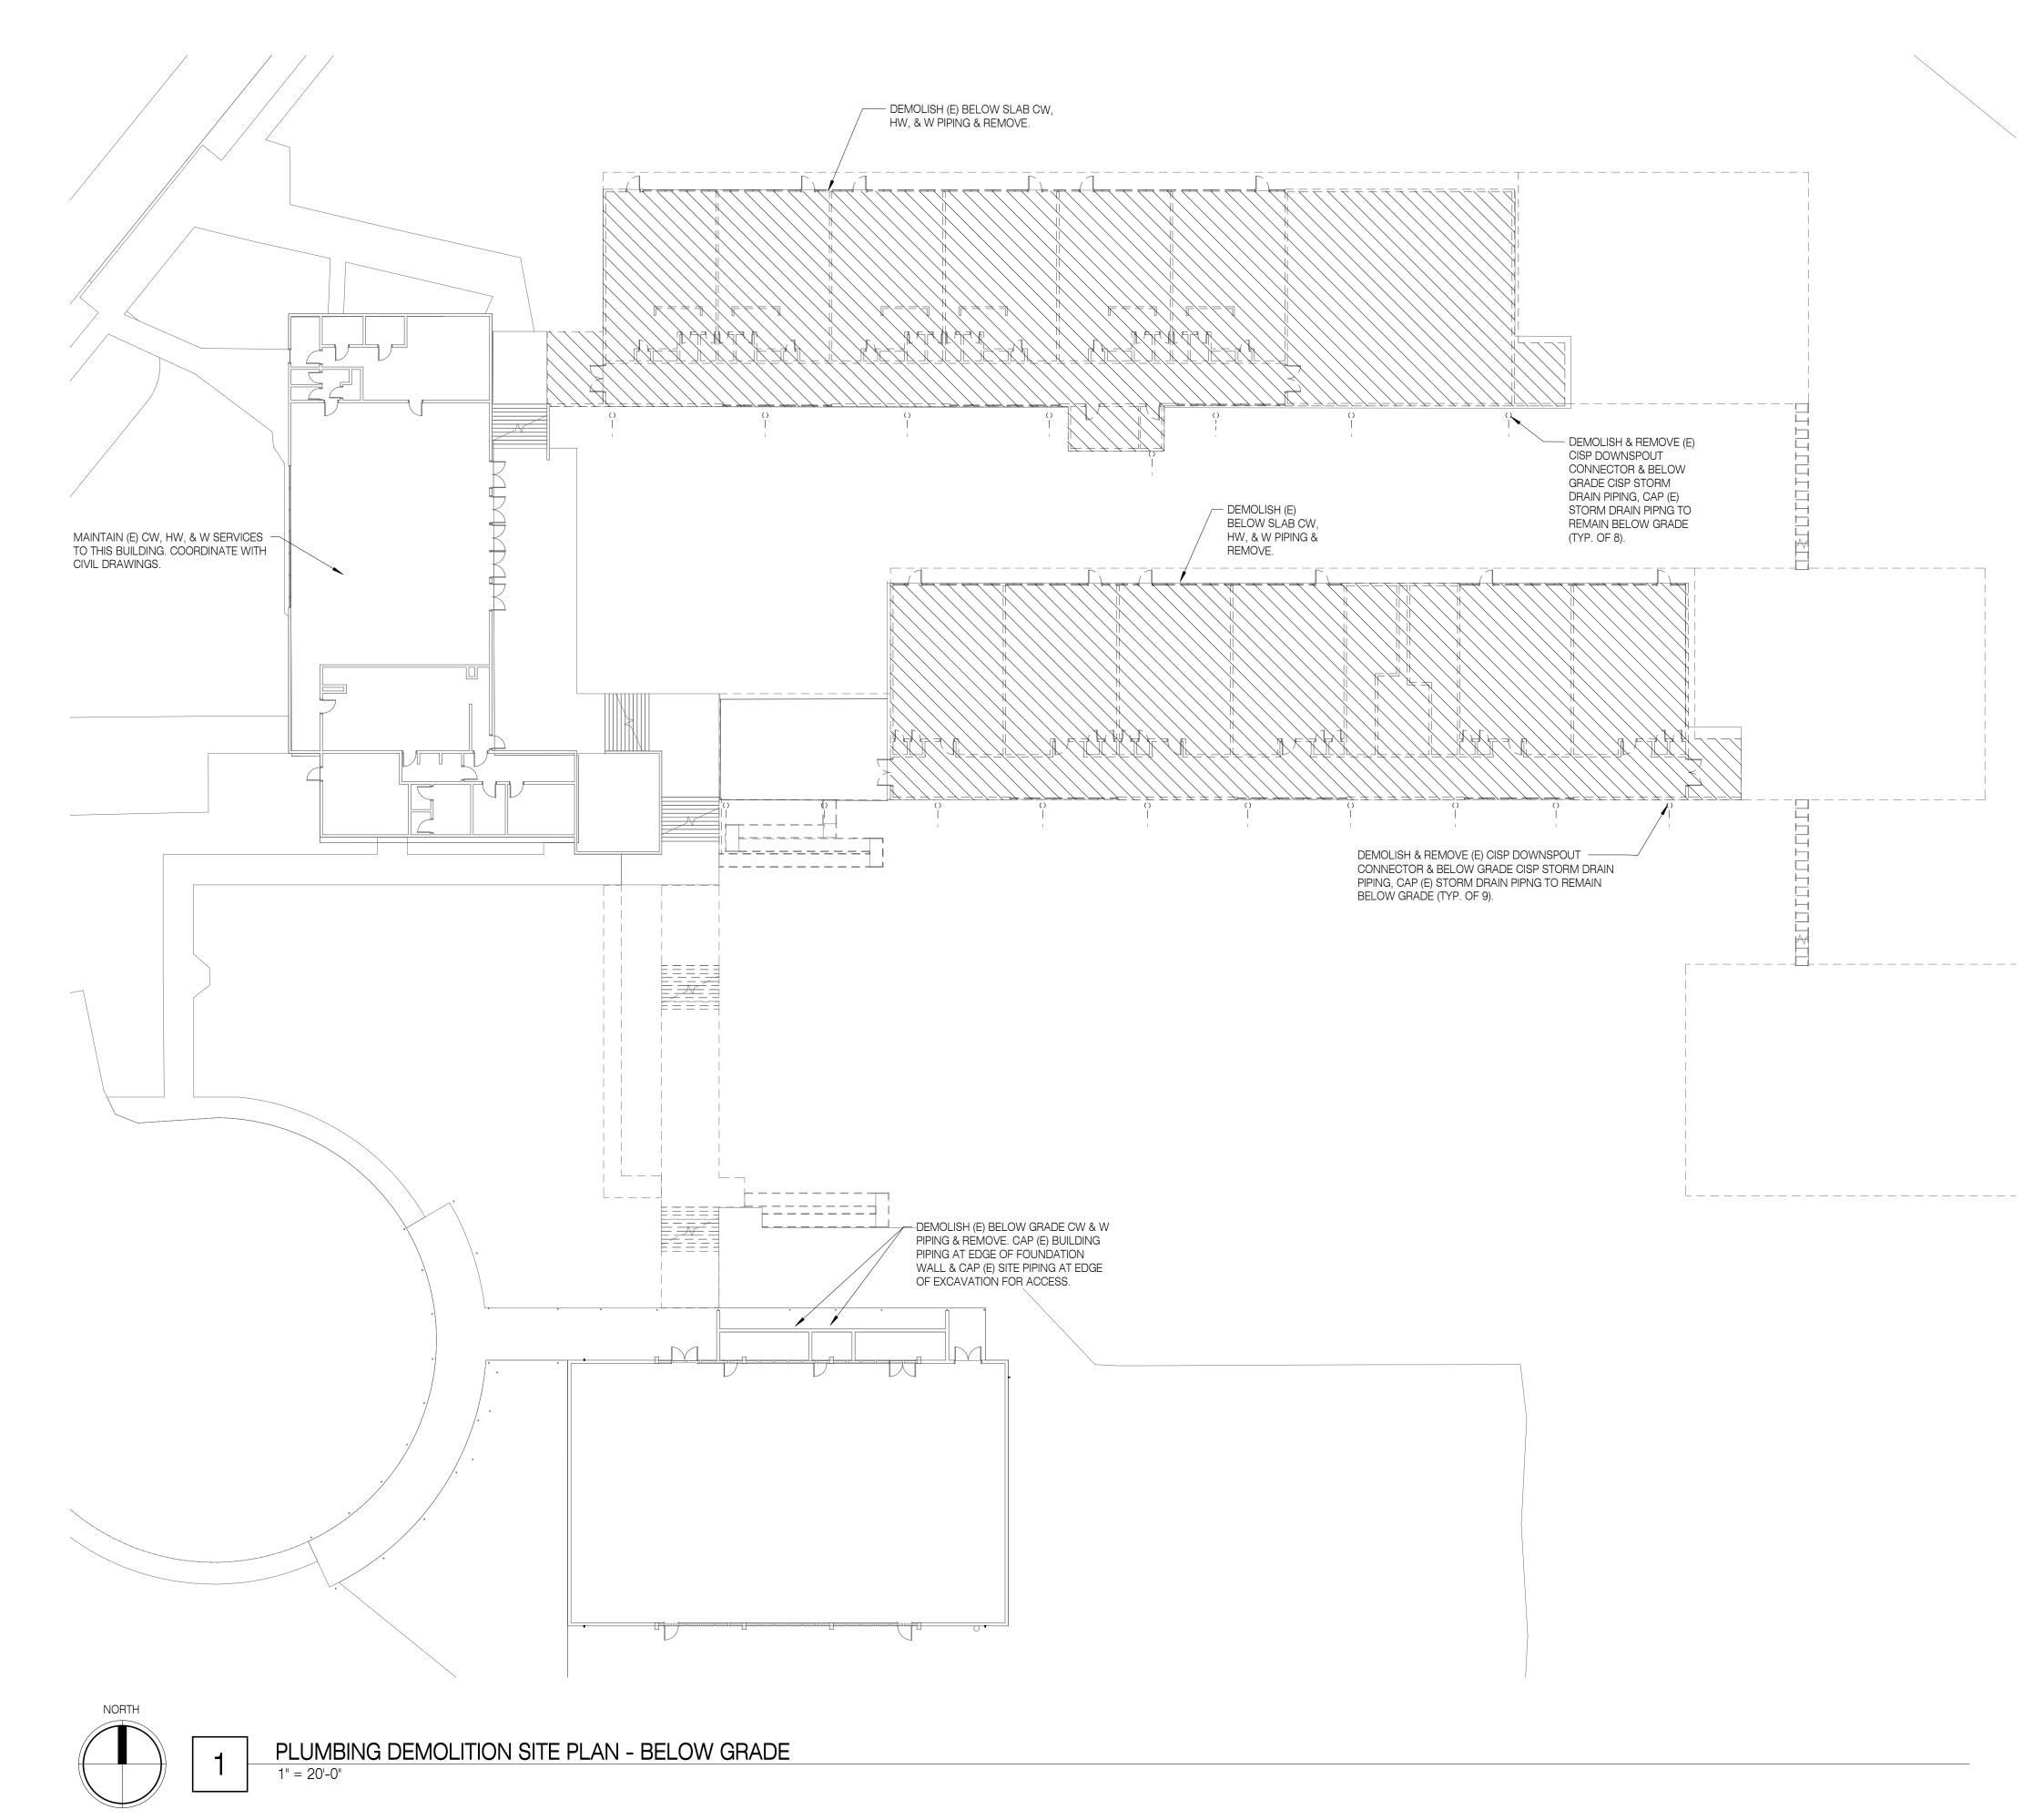
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P099




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- DEMOLISH & REMOVE (E) WC & ASSOCIATED CW, V, & W PIPING. (2) DEMOLISH & REMOVE (E) LAV & ASSOCIATED CW, HW, V, & W PIPING. 3 DEMOLISH & REMOVE (E) CLASSROOM SINK & ASSOCIATED CW, HW, V, & W PIPING. DEMOLISH & REMOVE (E) JANITOR'S SINK & ASSOCIATED CW, HW, V, & W PIPING. 5 DEMOLISH & REMOVE (E) WALL HYDRANT & ASSOCIATED CW PIPING. 6 DEMOLISH & REMOVE (E) FIRE HOSE CABINET & ASSOCIATED CW PIPING.
- DEMOLISH & REMOVE (E) CLASSROOM DRINKING FOUNTAIN & ASSOCIATED CW, W, & V PIPING.
- (8) DEMOLISH & REMOVE (E) UR & ASSOCIATED CW, V, & W PIPING. DEMOLISH & REMOVE (E) MULTI-STATION LAV & ASSOCIATED CW, HW, V, & W PIPING.








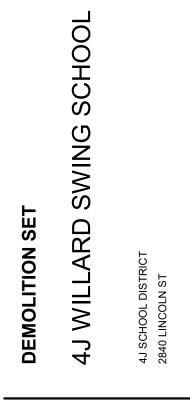

SHEET TITLE:		
DEMOLITION		
SITE PLAN		

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REFERENCE NOTES:

- EXISTING GYM BUILDING TO REMAIN. REMOVE EXISTING FEEDERS TO GYM UP TO DELINEATION LINE. SEE NOTE 6.
- 2 REMOVE ALL LIGHTS AND BRANCH CIRCUITS ROUTED ON WALKWAY. REMOVE ALL FEEDERS AND BRANCH CIRCUITS ROUTED ON ROOF.
- EXISTING ADMIN BUILDING TO REMAIN. ALL FEEDERS TO BUILDING SCHEDULED FOR DEMOLITION ORIGINATE FROM THIS BUILDING. REMOVE ALL ROOF MOUNTED CONDUITS FEEDING BUILDINGS THAT ARE BEING DEMOLISHED. REMOVE CONDUITS AS NOTED BY NOTES 7 AND 8. CONDUITS THAT ARE ROOF MOUNTED AND FEED ADMIN/CAFETIRIA BUILDING SHALL REMAIN UON. REMOVAL OF FEEDER SHALL INCLUDE PULL BOXES AND JUNCTION BOXES.
- 4 LOCATION OF MAIN ELECTRICAL ROOM.
- $\overline{5}$ EXISTING J-BOX ON ROOF TO REMAIN. SEAL ALL OPENINGS.
- (6) REMOVE CONDUITS TO GYM UP TO THIS LOCATION. CABLING SHALL BE REMOVED TO ITS ENTIRETY.
- \bigtriangledown Existing Low voltage conduit to be removed. Conduit continous down face off building into existing telecom room. Remove CONDUIT BACK TO SOURCE.
- $\langle 8 \rangle$ EXISTING POWER CONDUITS TO BE REMOVED.

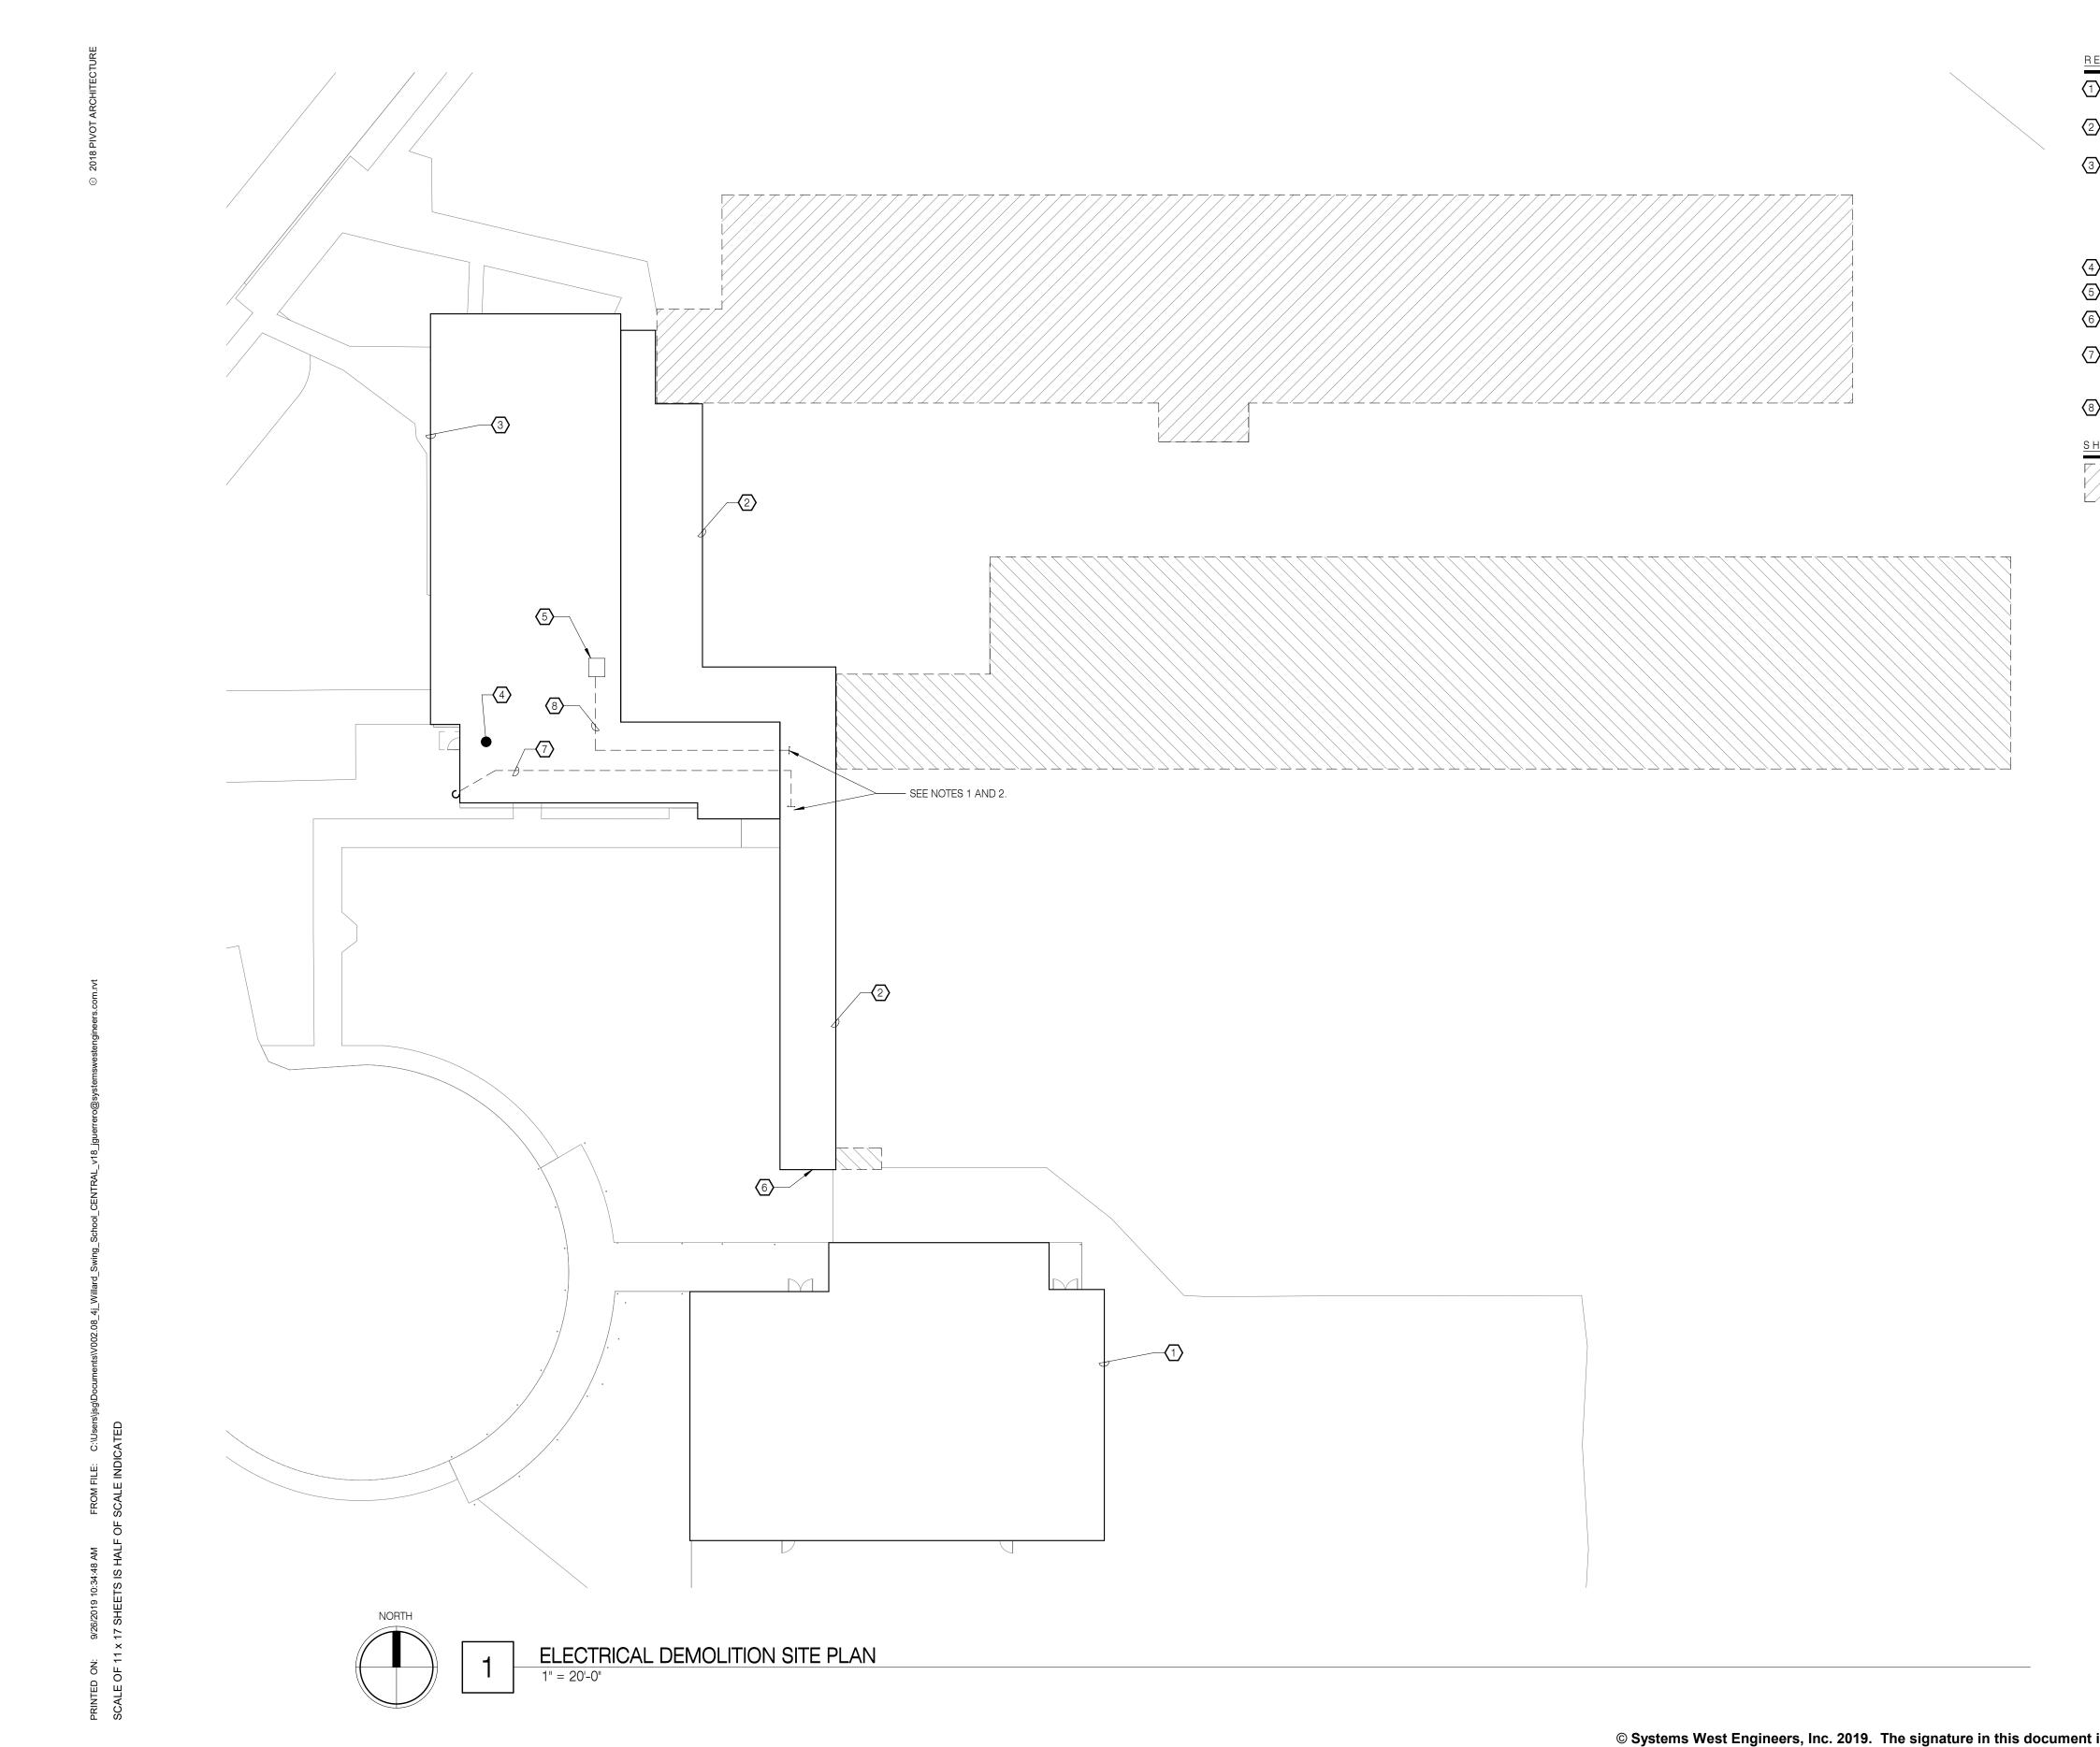SHEET LEGEND:

REMOVE ALL ELECTRICAL, LIGHTING, FIRE ALARM AND ALL LOW VOLTAGE SYSTEMS FROM THESE SPACES. ELECTRICAL DEVICES SHALL INCLUDE PANELBOARDS AND TRANSFORMERS IN HASHED AREA. DEMO ALL WORK THROUGH SLAB AND 2'-0" BELOW GRADE. ALERT OWNER IF DEMOLITION IS NEEDED BELOW THE 2'-0" THRESHOLD.

