

LAMAR LN.

NORWOOD ST.

CARMEL AVE.

EXISTING BACK STOP TO REMAIN


EXISTING STRUCTURES TO REMAIN

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EXISTING STRUCTURES TO REMAIN

AREA OF NEW PROPOSED STRUCTURE
SEE A/12 FOR ELEVATIONS

ARCHITECTURAL SITE PLAN
SCALE: 1" = 30'

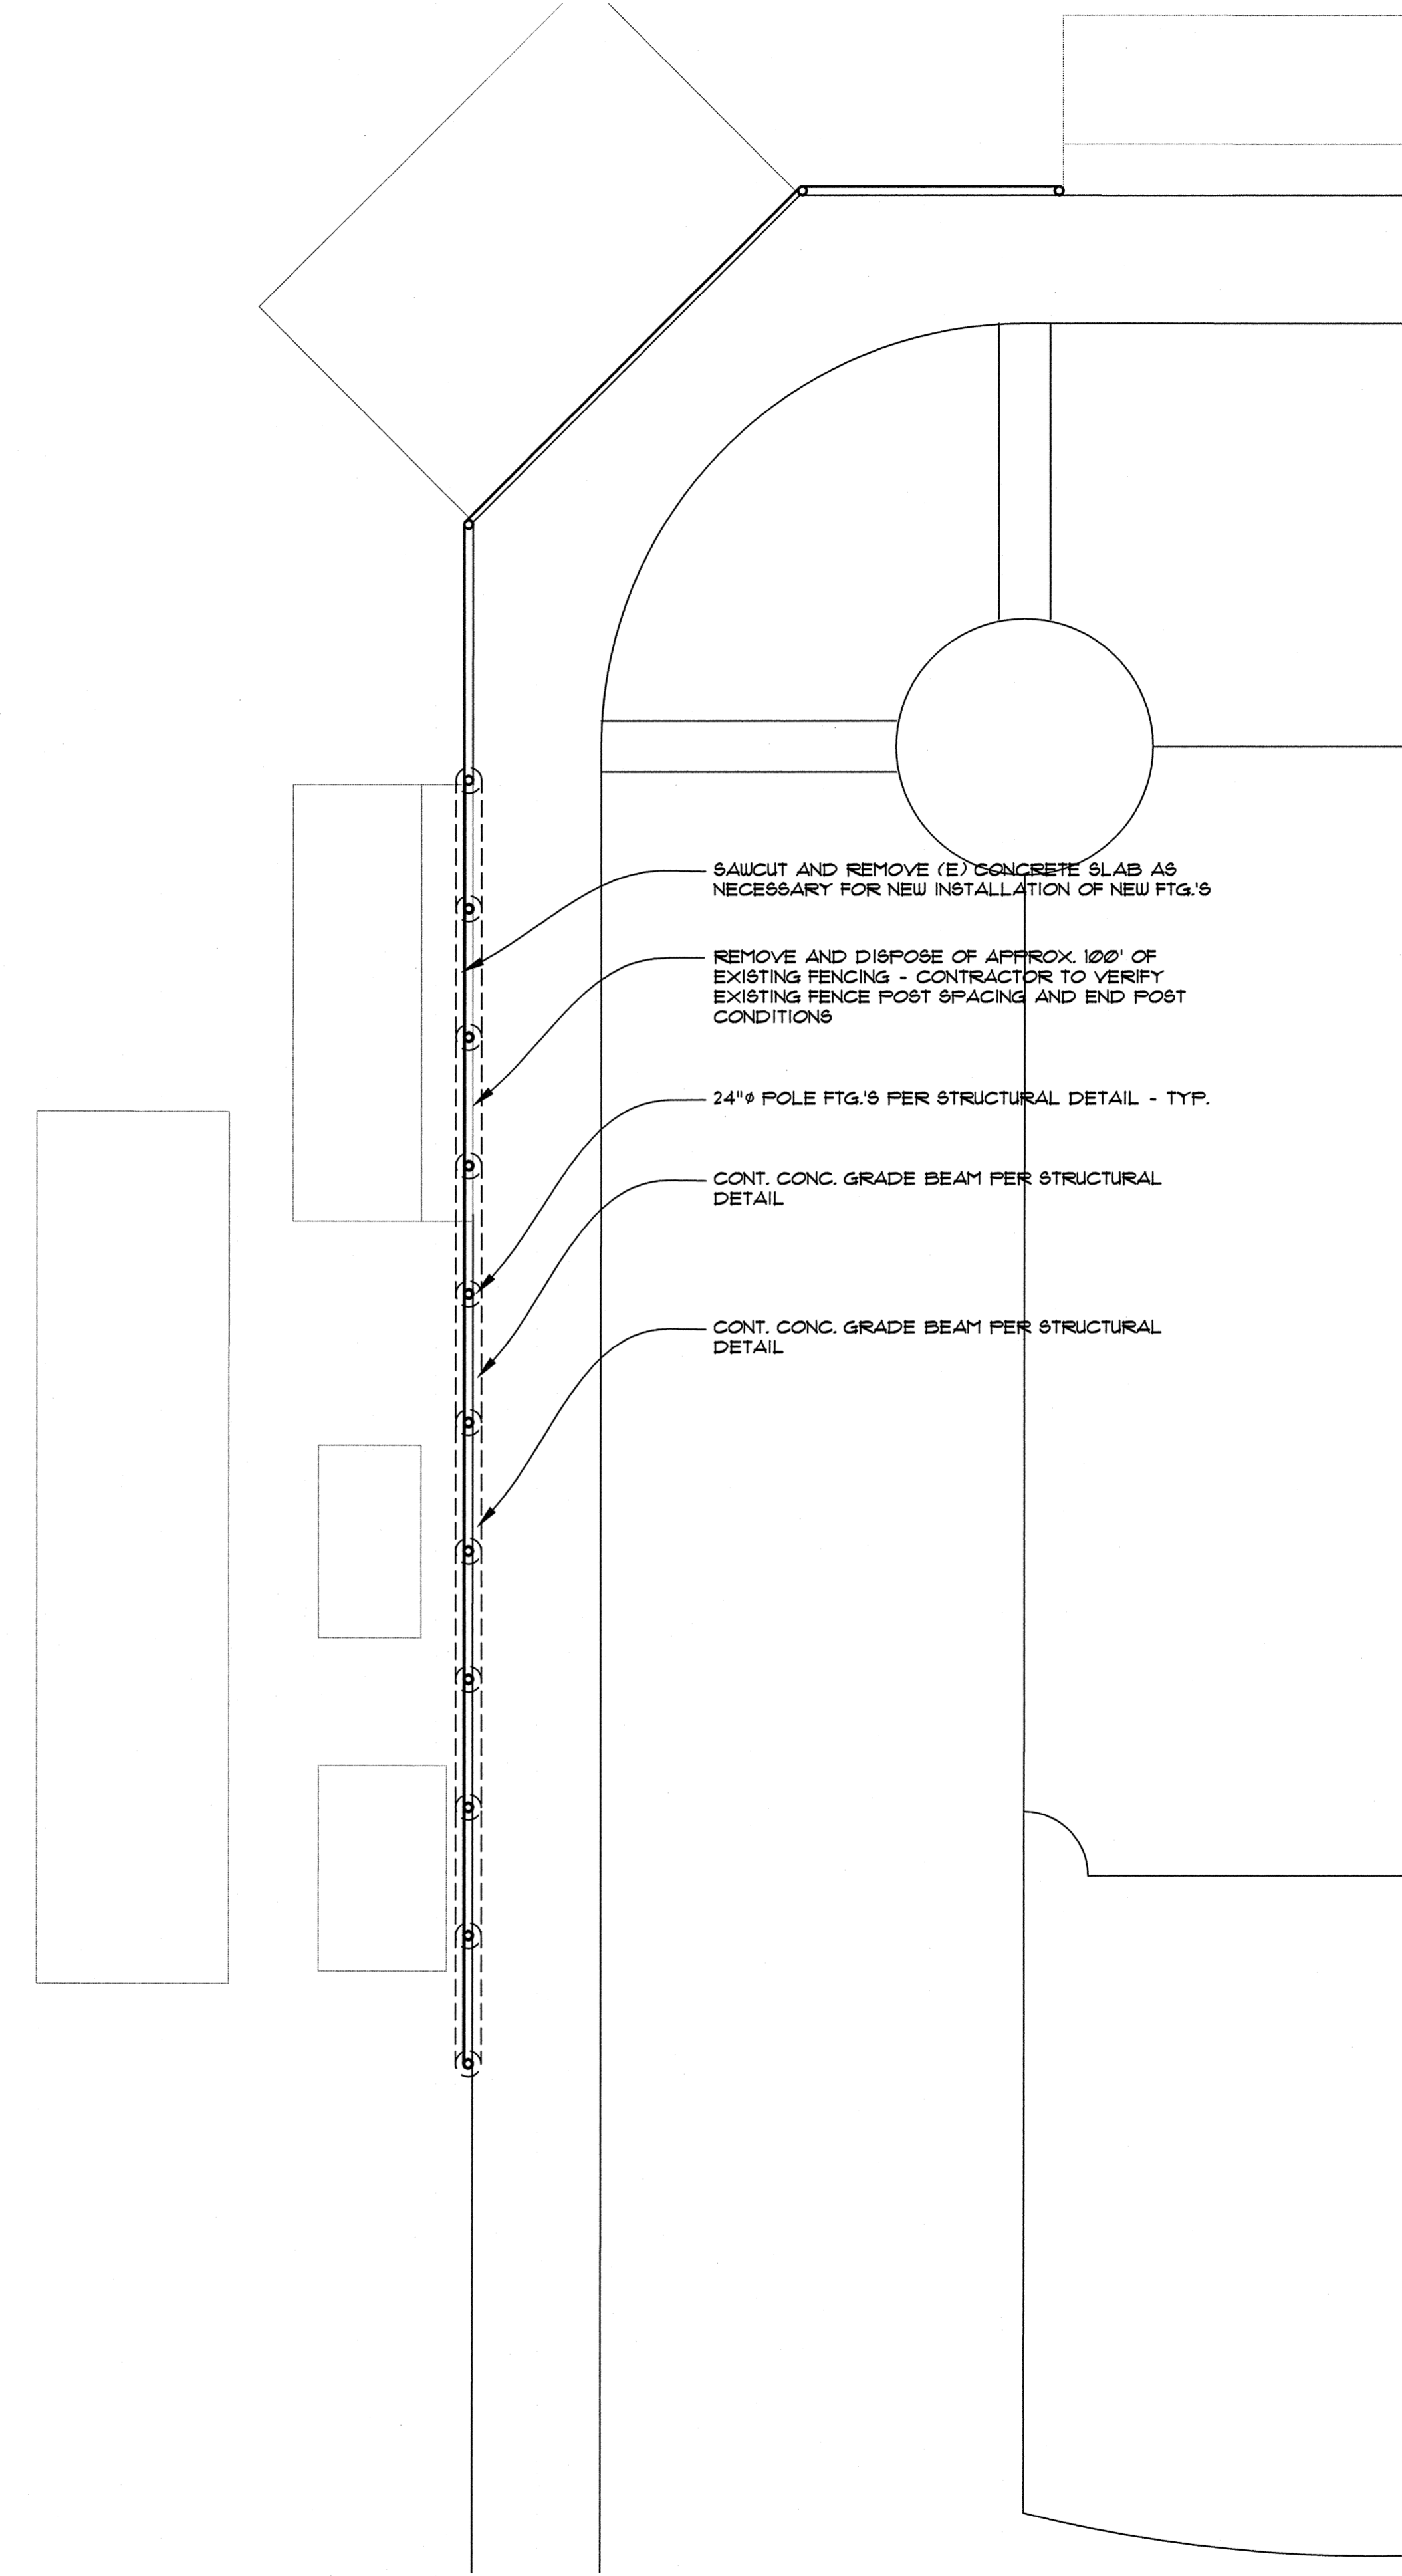

SAWCUT AND REMOVE (E) CONCRETE SLAB AS NECESSARY FOR NEW INSTALLATION OF NEW FTG.'S

REMOVE AND DISPOSE OF APPROX. 100' OF EXISTING FENCING - CONTRACTOR TO VERIFY EXISTING FENCE POST SPACING AND END POST CONDITIONS

24" POLE FTG.'S PER STRUCTURAL DETAIL - TYP.

CONT. CONC. GRADE BEAM PER STRUCTURAL DETAIL

CONT. CONC. GRADE BEAM PER STRUCTURAL DETAIL

ENLARGED SITE PLAN
SCALE: 1" = 10'



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BACK STOP EXTENSION

SHELDON HIGH SCHOOL

2455 WILLAKENZIE ROAD EUGENE OR 97401-4898

ARCHITECTURAL TITLE: SITE PLAN


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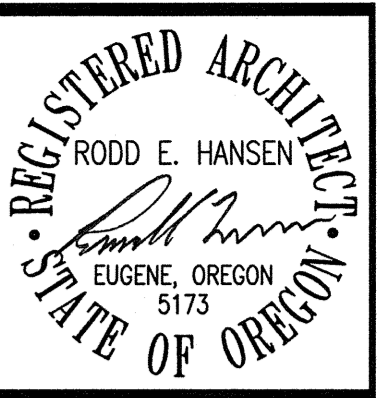
DRAWN BY: RH

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ISSUE DATE: 10-01-2015

SCALE: 1" = 30'-0"



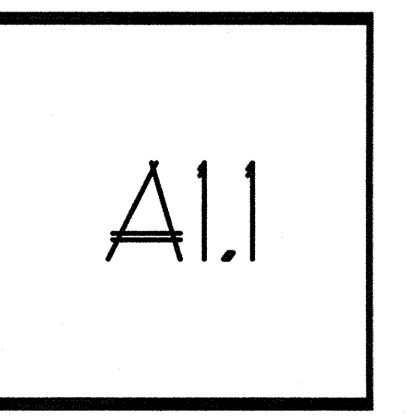


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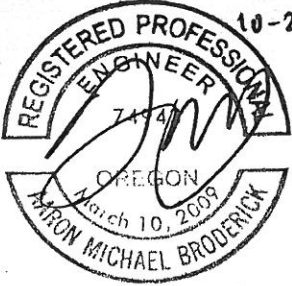
BACK STOP EXTENSION
 SHELDON HIGH SCHOOL
 2455 WILLAKENZIE ROAD EUGENE OR
 97401-4898

ARCHITECTURAL TITLE:	SITE PLAN
JOB#:	1165.11012014
DRAWN BY:	RH
BY:	--
ISSUE DATE:	10-01-2015
SCALE:	1/8" = 1'-0"

A1.2




BACK STOP ELEVATION
 SCALE: 1/8" = 1'-0"

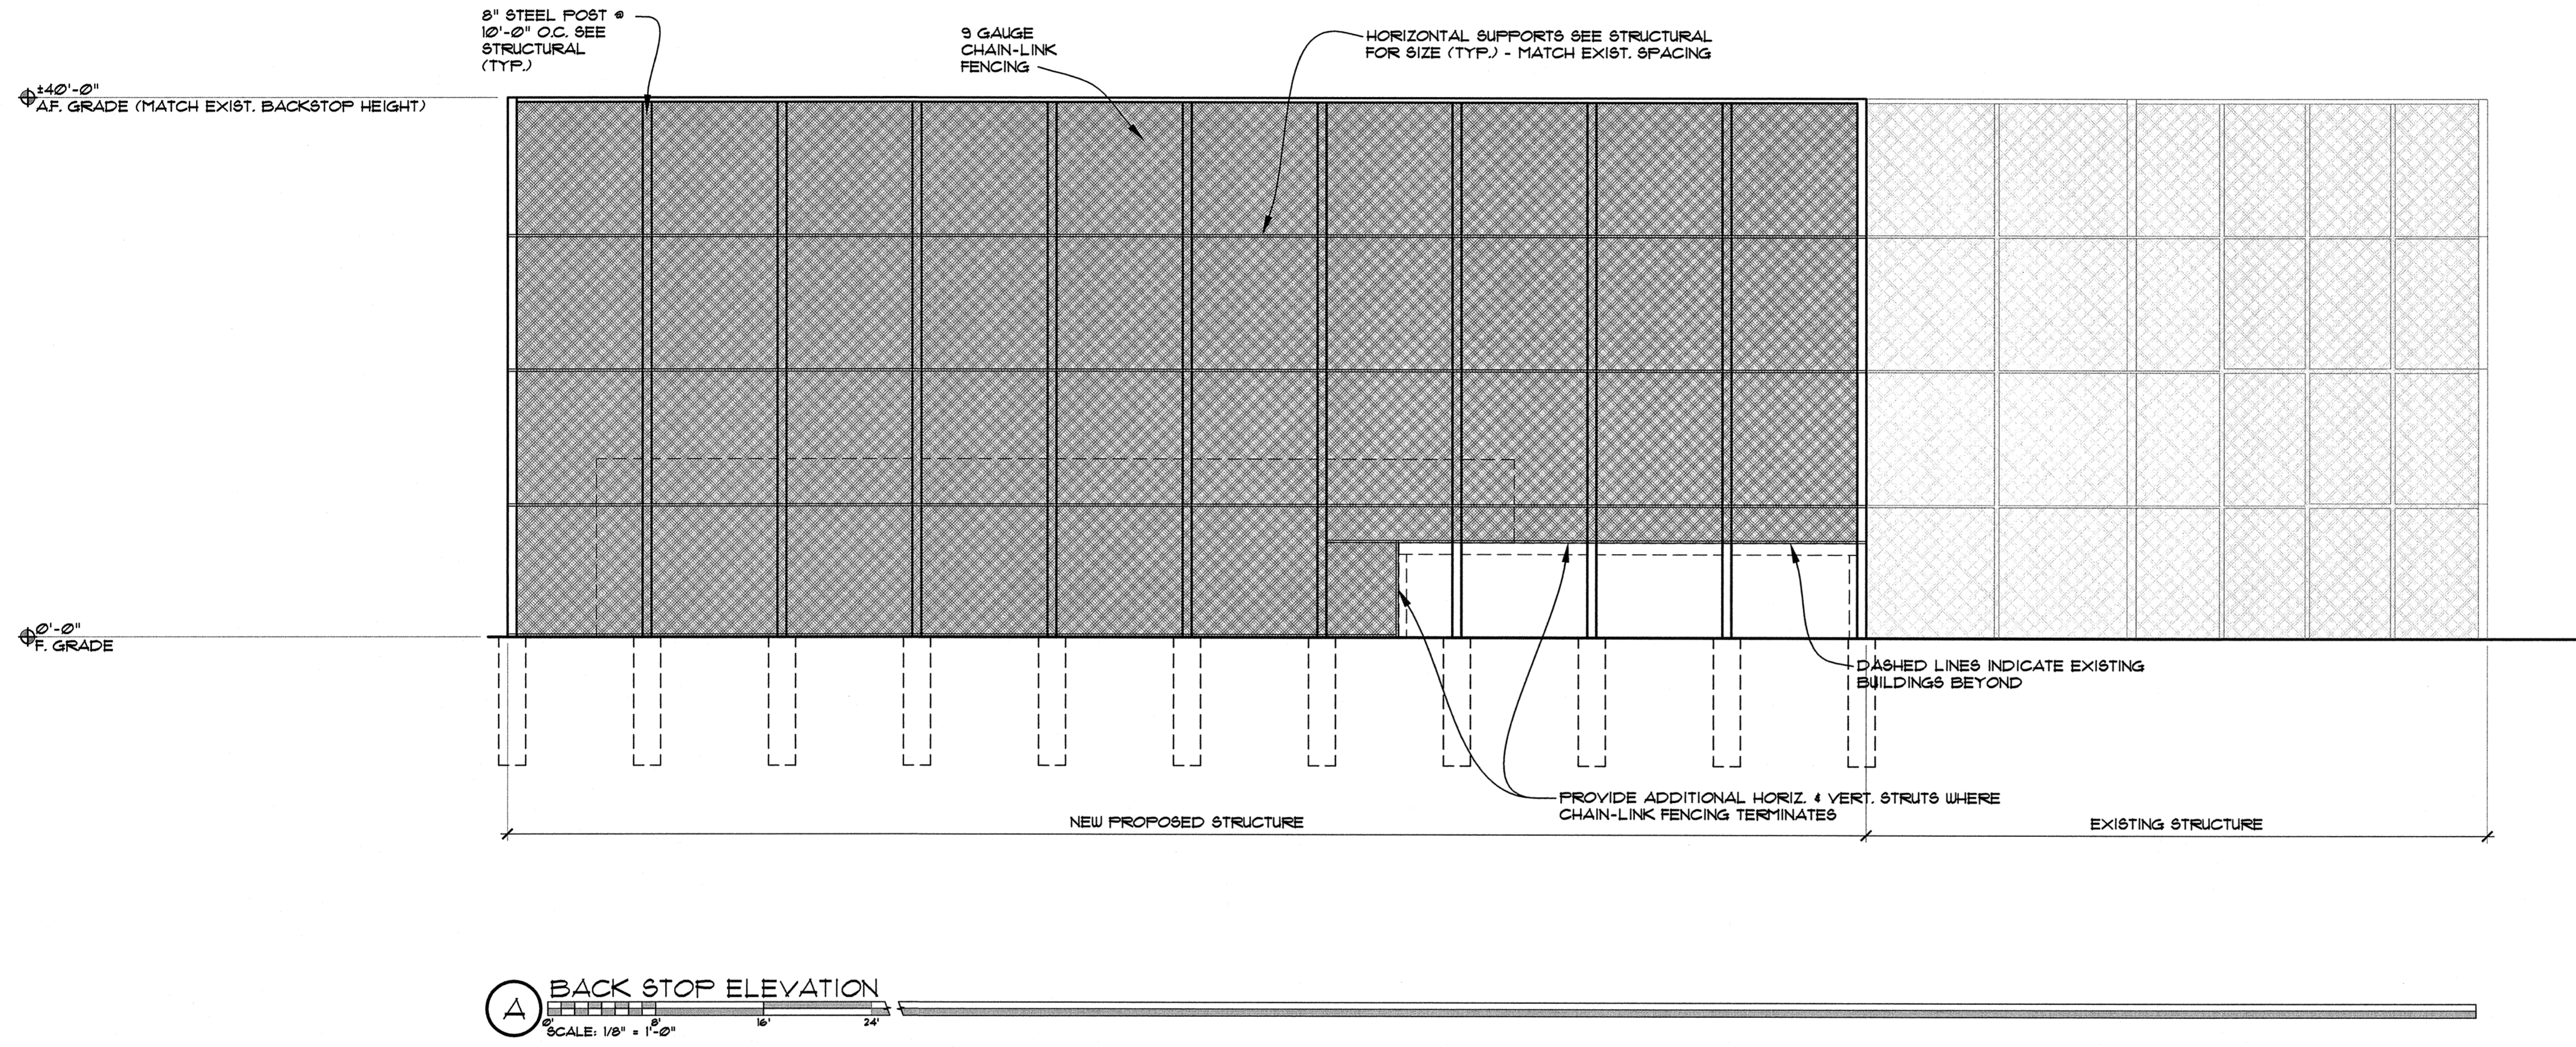

EXPIRES: 12/15

8" Ø XX STRONG PIPE. PROVIDE CAP @ TOP AND VENT HOLE @ BASE - BY CONTRACTOR

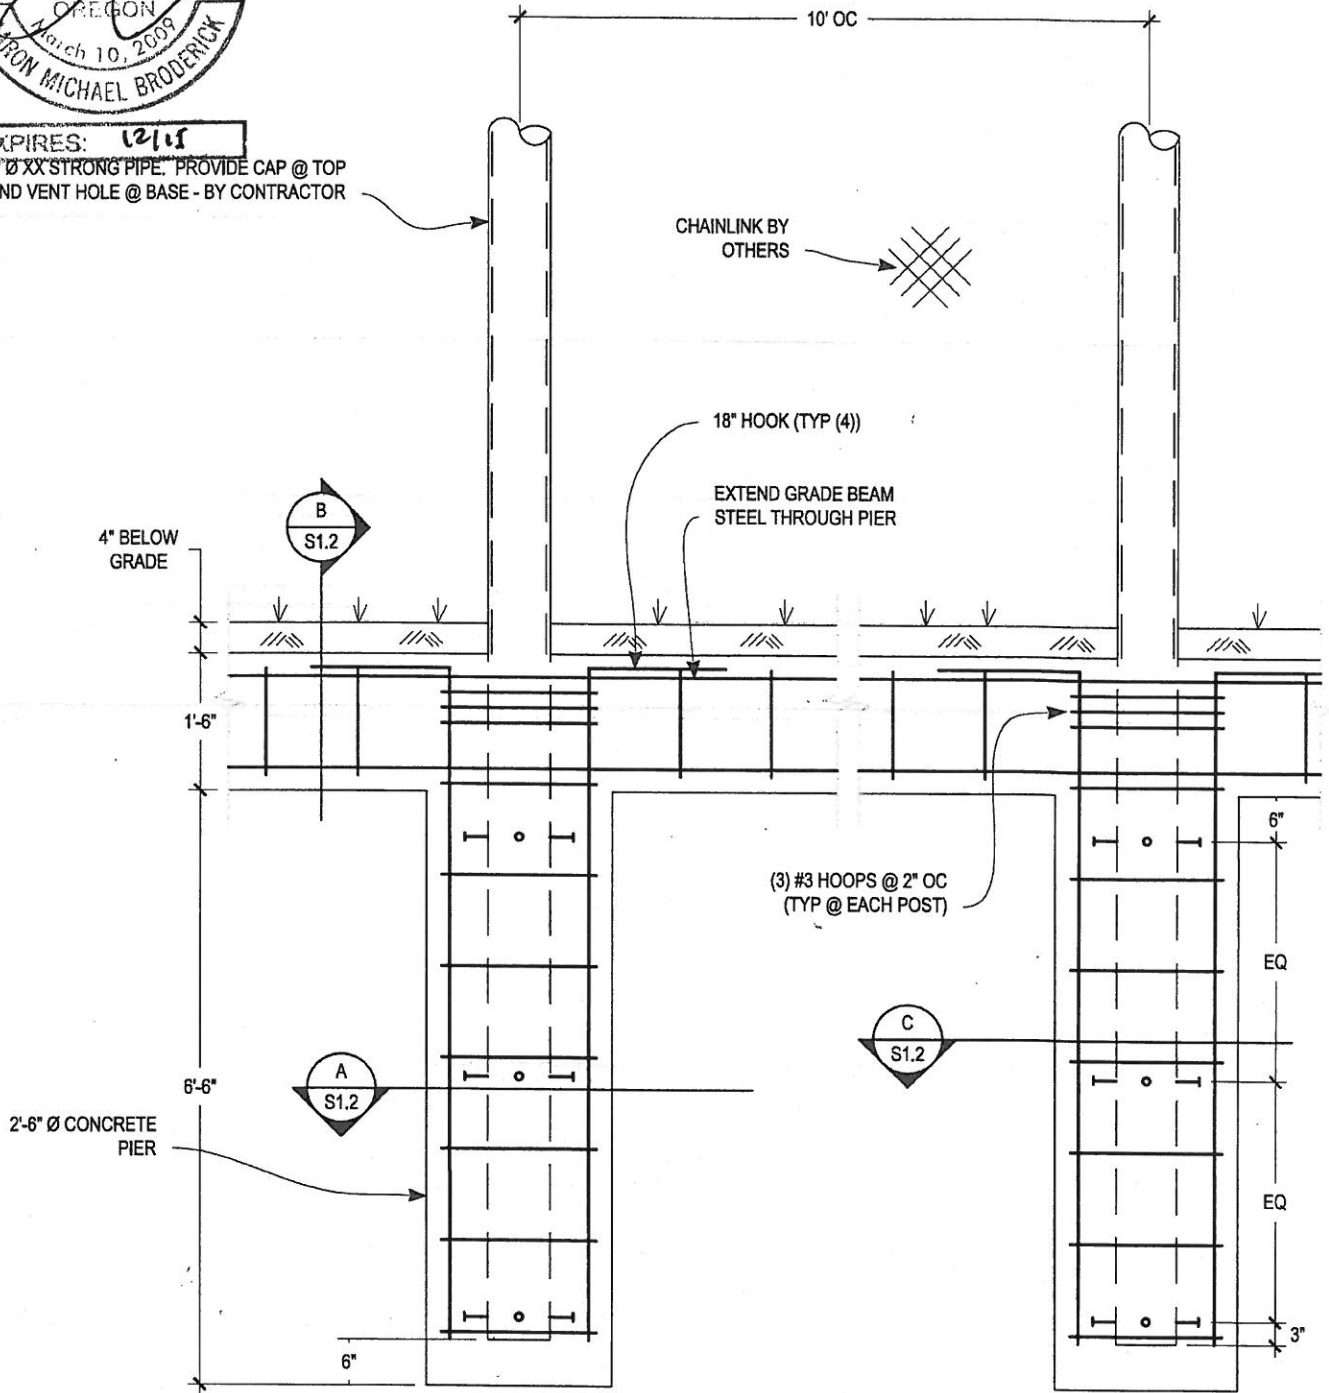

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SHELDON BACKSTOP

Date: 10-01-2015
 Project No.: 15002.06
 Drawn By: FAD
 Checked By: AMB

Project:

Revisions:

BACKSTOP

Sheet title:

Scale:


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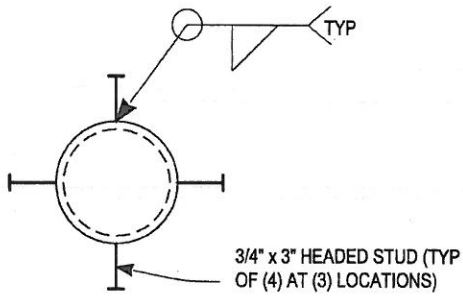


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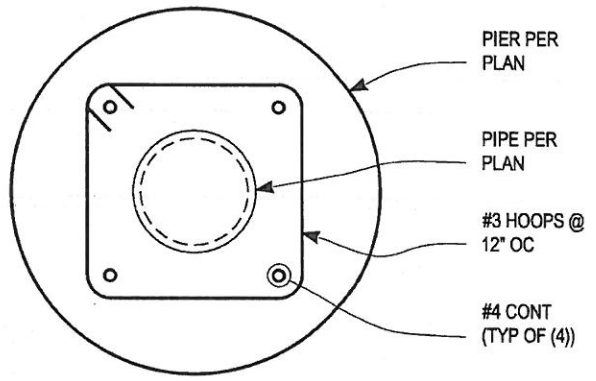
EXPIRES: 12/15



B GRADE BEAM SECTION

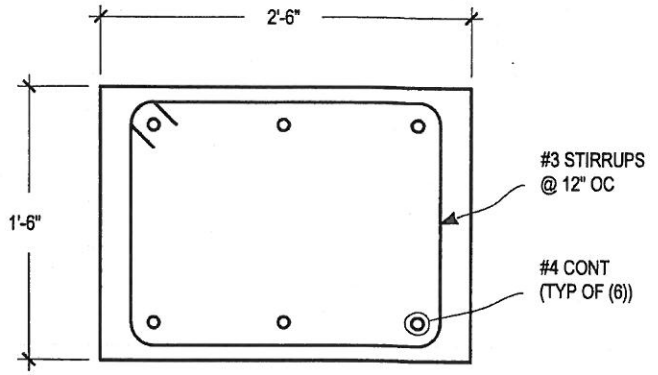

C WELDED STUD PLAN VIEW



A PIER PLAN VIEW

GENERAL NOTES:
 CONCRETE: F'C = 2500 psi
 REINFORCING STEEL: ASTM A615 GR 60 DEFORMED BAR
 WELD: E70xx
 STUD: A108
 PIPE: A53 GR B

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SHELDON BACKSTOP

Project:

Date: 10-01-2015
 Project No.: 15002.06
 Drawn By: FAD
 Checked By: AMB
 Revisions:

DETAILS

Sheet title:

Scale:

Sheet:

S 1.1