



ROBERTSON/SHERWOOD/ARCHITECTS PC

132 EAST BROADWAY, SUITE 540 EUGENE, OREGON 97401 541-342-8077 www.robertsonsherwood.com


MAHLUM ARCHITECTS INC

1231 NW HOYT, SUITE 102 PORTLAND, OREGON 97209 503-224-4032

71 COLUMBIA, FLOOR 4 SEATTLE, WASHINGTON 98104 www.mahlum.com



EUGENE SCHOOL DISTRICT 4J

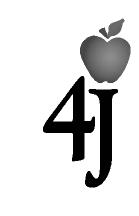

REPLACEMENT ROOSEVELT MIDDLE SCHOOL CIP NUMBER 410.566.001 680 EAST 24TH AVENUE EUGENE, OREGON 97405

REPLACEMENT ROOSEVELT MIDDLE SCHOOL

CONSTRUCTION DOCUMENTS PACKAGE EC FEBRUARY 18, 2015

PACKAGE EC DISCIPLINE

EROSION CONTROL

	MARK	DAT	E	DESCRIPTIO				
	ISSUE D	ATE:	FE	EBRUARY 18, 201				
	ISSUE:		CONSTRUCT	TON DOCUMENT				
	VOLUME	:		PACKAGE E				
	PROJEC	T NO:		2013912.0				
	DRAWN	BY:		L				
	CHECKE	D BY:	D					
	COPYRIGHT I	MAHLUM A	ARCHITECTS, INC. 2014	ORIGINAL SHEET SIZE: 30"				
Α	COVE	R SI	HEET					
	A	ISSUE DA ISSUE: VOLUME PROJEC DRAWN CHECKE COPYRIGHT I	ISSUE DATE: ISSUE: VOLUME: PROJECT NO: DRAWN BY: CHECKED BY: COPYRIGHT MAHLUM A	ISSUE: CONSTRUCT VOLUME: PROJECT NO: DRAWN BY:				

G001 EC

STANDARD EROSION AND SEDIMENT CONTROL PLAN DRAWING NOTES

- HOLD A PRE-CONSTRUCTION MEETING OF PROJECT CONSTRUCTION PERSONNEL THAT INCLUDES THE INSPECTOR TO DISCUSS EROSION AND SEDIMENT CONTROL MEASURES AND CONSTRUCTION LIMITS. (SCHEDULE
- 2. ALL INSPECTIONS MUST BE MADE IN ACCORDANCE WITH DEQ 1200-C PERMIT REQUIREMENTS
- 3. INSPECTION LOGS MUST BE KEPT IN ACCORDANCE WITH DEQ'S 1200-C PERMIT REQUIREMENTS
- 4. RETAIN A COPY OF THE ESCP AND ALL REVISIONS ON SITE AND MAKE IT AVAILABLE ON REQUEST TO DEQ AGENT. OR THE LOCAL MUNICIPALITY. DURING INACTIVE PERIODS OF GREATER THAN SEVEN (7) CONSECUTIVE CALENDAR DAYS. RETAIN THE ESCP AT THE CONSTRUCTION SITE OR AT ANOTHER LOCATION. (SCHEDULE
- ALL PERMIT REGISTRANTS MUST IMPLEMENT THE ESCP. FAILURE TO IMPLEMENT ANY OF THE CONTROL MEASURES OR PRACTICES DESCRIBED IN THE ESCP IS A VIOLATION OF THE PERMIT. (SCHEDULE A 8.A)
- THE ESCP MEASURES SHOWN ON THIS PLAN ARE MINIMUM REQUIREMENTS FOR ANTICIPATED SITE CONDITIONS. DURING THE CONSTRUCTION PERIOD, UPGRADE THESE MEASURES AS NEEDED TO COMPLY WITH ALL APPLICABLE LOCAL, STATE, AND FEDERAL EROSION AND SEDIMENT CONTROL REGULATIONS. (SCHEDULE
- SUBMISSION OF ALL ESCP REVISIONS IS NOT REQUIRED. SUBMITTAL OF THE ESCP REVISIONS IS ONLY UNDER SPECIFIC CONDITIONS. SUBMIT ALL NECESSARY REVISION TO DEQ OR AGENT. (SCHEDULE A.12.C.III)
- 8. PHASE CLEARING AND GRADING TO THE MAXIMUM EXTENT PRACTICAL TO PREVENT EXPOSED INACTIVE AREAS FROM BECOMING A SOURCE OF EROSION. (SCHEDULE A 8.C.II.(1)(D))
- 9. IDENTIFY, MARK, AND PROTECT (BY FENCING OFF OR OTHER MEANS) CRITICAL RIPARIAN AREAS AND VEGETATION INCLUDING IMPORTANT TREES AND ASSOCIATED ROOTING ZONES, AND VEGETATION AREAS TO BE PRESERVED. IDENTIFY VEGETATIVE BUFFER ZONES BETWEEN THE SITE AND SENSITIVE AREAS (E.G., WETLANDS), AND OTHER AREAS TO BE PRESERVED, ESPECIALLY IN PERIMETER AREAS. (SCHEDULE A.8.C.I.(1)
- 10. PRESERVE EXISTING VEGETATION WHEN PRACTICAL AND RE-VEGETATE OPEN AREAS. RE-VEGETATE OPEN AREAS WHEN PRACTICABLE BEFORE AND AFTER GRADING OR CONSTRUCTION. IDENTIFY THE TYPE OF VEGETATIVE SEED MIX USED. (SCHEDULE A.7.B.III(1) AND A.7.B.III(3))
- 11. EROSION AND SEDIMENT CONTROL MEASURES INCLUDING PERIMETER SEDIMENT CONTROL MUST BE IN PLACE BEFORE VEGETATION IS DISTURBED AND MUST REMAIN IN PLACE AND BE MAINTAINED, REPAIRED, AND PROMPTLY IMPLEMENTED FOLLOWING PROCEDURES ESTABLISHED FOR THE DURATION OF CONSTRUCTION, INCLUDING PROTECTION FOR ACTIVE STORM DRAIN INLETS AND CATCH BASINS AND APPROPRIATE NON-STORMWATER POLLUTION CONTROLS.(SCHEDULE A.7.D.I & A.8.C)
- 12. ESTABLISH CONCRETE TRUCK AND OTHER CONCRETE EQUIPMENT WASHOUT AREAS BEFORE BEGINNING CONCRETE WORK. (SCHEDULE A.8.C.I.(6))
- 13. APPLY TEMPORARY AND/OR PERMANENT SOIL STABILIZATION MEASURES IMMEDIATELY ON ALL DISTURBED AREAS AS GRADING PROGRESSES AND FOR ALL ROADWAYS INCLUDING GRAVEL ROADWAYS. (SCHEDULE A.8.C.II.(2))
- 14. ESTABLISH MATERIAL AND WASTE STORAGE AREAS, AND OTHER NON-STORMWATER CONTROLS. (SCHEDULE A.8.C.I.(7))
- 15. PREVENT TRACKING OF SEDIMENT ONTO PUBLIC OR PRIVATE ROADS USING BMPS SUCH AS: GRAVELED (OR PAVED) EXITS AND PARKING AREAS, GRAVEL ALL UNPAVED ROADS LOCATED ONSITE, OR USE AN EXIT TIRE WASH. THESE BMPS MUST BE IN PLACE PRIOR TO LAND-DISTURBING ACTIVITIES. (SCHEDULE A 7.D.II.(1) AND
- 16. WHEN TRUCKING SATURATED SOILS FROM THE SITE, EITHER USE WATER-TIGHT TRUCKS OR DRAIN LOADS ON SITE. (SCHEDULE A.7.D.II.(3))
- 17. USE BMPS TO PREVENT OR MINIMIZE STORMWATER EXPOSURE TO POLLUTANTS FROM SPILLS; VEHICLE AND EQUIPMENT FUELING, MAINTENANCE, AND STORAGE; OTHER CLEANING AND MAINTENANCE ACTIVITIES; AND WASTE HANDLING ACTIVITIES. THESE POLLUTANTS INCLUDE FUEL, HYDRAULIC FLUID, AND OTHER OILS FROM VEHICLES AND MACHINERY, AS WELL AS DEBRIS, LEFTOVER PAINTS, SOLVENTS, AND GLUES FROM CONSTRUCTION OPERATIONS. (SCHEDULE A.7.E.I.(2))

CITY OF EUGENE CSMP GENERAL NOTES

- 1. PRIOR TO ANY GROUND DISTURBANCE ON THE SITE ONE INSPECTION WITH EROSION PREVENTION STAFF IS REQUIRED.
- 2. THE CONSTRUCTION SITE MANAGEMENT PLAN DOES NOT AUTHORIZE CONSTRUCTION ACTIVITIES. GRADING, BUILDING, PEPI, AND OTHER PERMITS MAY BE REQUIRED. ALL OTHER NECESSARY APPROVALS SHALL BE
- 3. ISSUANCE OF AN EROSION PREVENTION PERMIT APPROVES PROTECTION MEASURES, NOT CONSTRUCTION OR GROUND DISTURBING ACTIVITIES. IT DOES NOT RELIEVE THE PERMIT HOLDER AND/OR THE CONTRACTOR FROM OTHER PERMITTING REQUIREMENTS.
- 4. CONSTRUCTION SHALL CONFORM TO THE CURRENT EDITION OF THE CITY AMENDED OREGON STANDARD SPECIFICATIONS FOR CONSTRUCTION AND CITY STANDARD DRAWINGS * (*REQUIRED FOR PUBLIC IMPROVEMENT PROJECTS ONLY).
- 5. EROSION AND SEDIMENT CONTROL MEASURES, AND OTHER NATURAL RESOURCE PROTECTION FENCING AND BARRIERS, SHOWN ON THE CSMP ARE THE MINIMUM REQUIREMENTS FOR ANTICIPATED SITE CONDITIONS. DURING CONSTRUCTION, MEASURES SHALL BE UPGRADED, AS NEEDED OR AS DIRECTED BY THE CITY INSPECTOR.
- 6. IMPLEMENTATION OF THE CSMP, INCLUDING CONSTRUCTION, MAINTENANCE, REPLACEMENT, AND UPGRADING OF EROSION AND SEDIMENT CONTROL MEASURES AND PROTECTION FENCING, IS THE RESPONSIBILITY OF THE PERMIT HOLDER AND/OR THE CONTRACTOR UNTIL ALL CONSTRUCTION IS COMPLETED AND VEGETATION/LANDSCAPING IS ESTABLISHED AND APPROVED.
- 7. BOUNDARIES OF THE CLEARING AND GRADING LIMITS SHOWN ON THIS PLAN SHALL BE CLEARLY FLAGGED IN THE FIELD PRIOR TO CONSTRUCTION. DURING CONSTRUCTION, NO DISTURBANCE BEYOND THE FLAGGED CLEARING AND GRADING LIMITS SHALL BE PERMITTED. THE FLAGGING SHALL BE MAINTAINED BY THE PERMIT HOLDER AND/OR THE CONTRACTOR FOR THE DURATION OF CONSTRUCTION. IN ADDITION, WETLAND AND RIPARIAN AREAS SHALL BE IDENTIFIED AND PROTECTED WITH APPROPRIATE FENCING AS NOTED ON CSMP PRIOR TO CONSTRUCTION AND SHALL NOT BE DISTURBED UNLESS THE PROPER PERMITS ARE OBTAINED.
- 8. EROSION AND SEDIMENT CONTROL MEASURES SHOWN ON THIS CSMP MUST BE CONSTRUCTED IN CONJUNCTION WITH ALL CLEARING AND GRADING ACTIVITIES, IN SUCH A MANNER AS TO ENSURE THAT SEDIMENT AND SEDIMENT LADEN WATER DOES NOT ENTER THE STORMWATER SYSTEM, ROADWAYS, ADJACENT PROPERTY OR VIOLATE APPLICABLE WATER QUALITY STANDARDS. WHEN DESIGNING AND IMPLEMENTING MEASURES, THE PERMIT HOLDER AND/OR THE CONTRACTOR SHALL CONSIDER THE SEASONAL VARIATION OF RAINFALL, TEMPERATURE, AND OTHER CLIMATIC FACTORS RELATIVE TO THE TIMING OF LAND DISTURBANCE ACTIVITIES.
- 9. EROSION AND SEDIMENT CONTROL MEASURES ON ACTIVE SITES SHALL BE INSPECTED AND MAINTAINED DAILY AND WITHIN 24 HOURS AFTER ANY STORM EVENT GREATER THAN 0.5 INCHES OF RAIN PER 24 HOUR PERIOD. ANY REQUIRED REPAIRS OR ADJUSTMENTS SHALL BE MADE IMMEDIATELY. THE EROSION AND SEDIMENT CONTROL MEASURES ON INACTIVE SITES SHALL BE INSPECTED A MINIMUM OF ONCE EVERY MONTH AND/OR WITHIN 48 HOURS FOLLOWING STORM EVENTS. ADDITIONALLY, SITES COVERED UNDER DEPARTMENT OF ENVIRONMENTAL QUALITY (DEQ) PERMITS (1200-C, 1200-C) MUST COMPLY WITH THOSE PERMIT MONITORING AND RECORD-KEEPING REQUIREMENTS.
- 10. DURING THE WET WEATHER SEASON (OCTOBER 15 TO APRIL 30), ALL EXPOSED SOIL AND STOCKPILE AREAS SHALL BE COVERED, OR OTHERWISE PROTECTED BY A FACILITY (OR COMBINATION OF FACILITIES) THAT RESULT IN NO STORMWATER RUNOFF LEAVING THE SITE DURING A 5-YEAR STORM EVENT. FOR DEVELOPMENT SITES OVER 40 ACRES, THE DESIGN STORM SHALL BE A 10-YEAR STORM EVENT CONSISTENT WITH AN APPROVED CSMP.

- 18. IMPLEMENT THE FOLLOWING BMPS WHEN APPLICABLE: WRITTEN SPILL PREVENTION AND RESPONSE PROCEDURES, EMPLOYEE TRAINING ON SPILL PREVENTION AND PROPER DISPOSAL PROCEDURES, SPILL KITS IN ALL VEHICLES, REGULAR MAINTENANCE SCHEDULE FOR VEHICLES AND MACHINERY, MATERIAL DELIVERY AND STORAGE CONTROLS, TRAINING AND SIGNAGE, AND COVERED STORAGE AREAS FOR WASTE AND SUPPLIES. (SCH A 7.E.III.)
- 19. USE WATER, SOIL-BINDING AGENT OR OTHER DUST CONTROL TECHNIQUE AS NEEDED TO AVOID WIND-BLOWN SOIL. (SCHEDULE A 7.B.II)
- 20. THE APPLICATION RATE OF FERTILIZERS USED TO REESTABLISH VEGETATION MUST FOLLOW MANUFACTURER'S RECOMMENDATIONS TO MINIMIZE NUTRIENT RELEASES TO SURFACE WATERS. EXERCISE CAUTION WHEN USING TIME-RELEASE FERTILIZERS WITHIN ANY WATERWAY RIPARIAN ZONE. (SCHEDULE A.9.B.III)
- 21. IF A STORMWATER TREATMENT SYSTEM (FOR EXAMPLE, ELECTRO-COAGULATION, FLOCCULATION, FILTRATION, ETC.) FOR SEDIMENT OR OTHER POLLUTANT REMOVAL IS EMPLOYED, SUBMIT AN OPERATION AND MAINTENANCE PLAN (INCLUDING SYSTEM SCHEMATIC, LOCATION OF SYSTEM, LOCATION OF INLET, LOCATION OF DISCHARGE, DISCHARGE DISPERSION DEVICE DESIGN, AND A SAMPLING PLAN AND FREQUENCY) BEFORE OPERATING THE TREATMENT SYSTEM. OBTAIN PLAN APPROVAL BEFORE OPERATING THE TREATMENT SYSTEM OPERATE AND MAINTAIN THE TREATMENT SYSTEM ACCORDING TO MANUFACTURER'S SPECIFICATIONS. (SCHEDULE A.9.D)
- 22. TEMPORARILY STABILIZE SOILS AT THE END OF THE SHIFT BEFORE HOLIDAYS AND WEEKENDS, IF NEEDED. THE REGISTRANT IS RESPONSIBLE FOR ENSURING THAT SOILS ARE STABLE DURING RAIN EVENTS AT ALL TIMES OF THE YEAR. (SCHEDULE A 7.B)
- 23. AT THE END OF EACH WORKDAY SOIL STOCKPILES MUST BE STABILIZED OR COVERED, OR OTHER BMPS MUST BE IMPLEMENTED TO PREVENT DISCHARGES TO SURFACE WATERS OR CONVEYANCE SYSTEMS LEADING TO SURFACE WATERS. (SCHEDULE A 7.E.II.(2))
- 24. CONSTRUCTION ACTIVITIES MUST AVOID OR MINIMIZE EXCAVATION AND CREATION OF BARE GROUND DURING WET WEATHER. (SCHEDULE A.7.A.I)
- 25. SEDIMENT FENCE: REMOVE TRAPPED SEDIMENT BEFORE IT REACHES ONE THIRD OF THE ABOVE GROUND FENCE HEIGHT AND BEFORE FENCE REMOVAL. (SCHEDULE A.9.C.I)
- 26. OTHER SEDIMENT BARRIERS (SUCH AS BIOBAGS): REMOVE SEDIMENT BEFORE IT REACHES TWO INCHES DEPTH

ABOVE GROUND HEIGHT. AND BEFORE BMP REMOVAL. (SCHEDULE A.9.C.II)

MORE. (SCHEDULE A.7.F.I)

- 27. CATCH BASINS: CLEAN BEFORE RETENTION CAPACITY HAS BEEN REDUCED BY FIFTY PERCENT. SEDIMENT BASINS AND SEDIMENT TRAPS: REMOVE TRAPPED SEDIMENTS BEFORE DESIGN CAPACITY HAS BEEN REDUCED BY FIFTY PERCENT AND AT COMPLETION OF PROJECT. (SCHEDULE A.9.C.III & IV)
- 28. WITHIN 24 HOURS, SIGNIFICANT SEDIMENT THAT HAS LEFT THE CONSTRUCTION SITE, MUST BE REMEDIATED. INVESTIGATE THE CAUSE OF THE SEDIMENT RELEASE AND IMPLEMENT STEPS TO PREVENT A RECURRENCE OF THE DISCHARGE WITHIN THE SAME 24 HOURS. ANY IN-STREAM CLEAN UP OF SEDIMENT SHALL BE PERFORMED ACCORDING TO THE OREGON DIVISION OF STATE LANDS REQUIRED TIMEFRAME. (SCHEDULE
- A.9.B.I) 29. THE INTENTIONAL WASHING OF SEDIMENT INTO STORM SEWERS OR DRAINAGE WAYS MUST NOT OCCUR. VACUUMING OR DRY SWEEPING AND MATERIAL PICKUP MUST BE USED TO CLEANUP RELEASED SEDIMENTS.
- (SCHEDULE A.9.B.II) 30. THE ENTIRE SITE MUST BE TEMPORARILY STABILIZED USING VEGETATION OR A HEAVY MULCH LAYER, TEMPORARY SEEDING, OR OTHER METHOD SHOULD ALL CONSTRUCTION ACTIVITIES CEASE FOR 30 DAYS OR
- 31. PROVIDE TEMPORARY STABILIZATION FOR THAT PORTION OF THE SITE WHERE CONSTRUCTION ACTIVITIES CEASE FOR 14 DAYS OR MORE WITH A COVERING OF BLOWN STRAW AND A TACKIFIER, LOOSE STRAW, OR AN ADEQUATE COVERING OF COMPOST MULCH UNTIL WORK RESUMES ON THAT PORTION OF THE SITE. (SCHEDULE A.7.F.II)
- 32. PROVIDE PERMANENT EROSION CONTROL MEASURES ON ALL EXPOSED AREAS. DO NOT REMOVE TEMPORARY SEDIMENT CONTROL PRACTICES UNTIL PERMANENT VEGETATION OR OTHER COVER OF EXPOSED AREAS IS ESTABLISHED. HOWEVER, DO REMOVE ALL TEMPORARY EROSION CONTROL MEASURES AS EXPOSED AREAS BECOME STABILIZED, UNLESS DOING SO CONFLICTS WITH LOCAL REQUIREMENTS. PROPERLY DISPOSE OF CONSTRUCTION MATERIALS AND WASTE, INCLUDING SEDIMENT RETAINED BY TEMPORARY BMPS. (SCHEDULE A.7.B.III(2) AND A.8.C.III)
- 11. ALL ADJACENT PROPERTIES, WATER FEATURES, AND RELATED NATURAL RESOURCES ARE TO BE KEPT FREE OF DEPOSITS OR DISCHARGES OF SOIL, SEDIMENT OR CONSTRUCTION-RELATED MATERIAL FROM THE CONSTRUCTION SITE.
- 12. ALL EROSION AND SEDIMENT CONTROL MEASURES SHALL BE PROTECTED FROM DAMAGE AT ALL TIMES. EROSION CONTROL MEASURES SHALL REMAIN IN PLACE UNTIL VEGETATION HAS BEEN ESTABLISHED AND THE SITE IS PERMANENTLY STABILIZED. ANY MEASURES THAT ARE DAMAGED OR DESTROYED SHALL BE REPAIRED OR REPLACED IMMEDIATELY.
- 13. STABILIZE ALL DISTURBED AREAS WITHIN 50 FEET OF WATERWAYS, WETLANDS OR OTHER SENSITIVE AREAS WITHIN 7 DAYS OF EXPOSURE.
- 14. STREETS ADJACENT TO CONSTRUCTION ENTRANCES AND ALONG HAUL ROUTES SHALL BE SWEPT AS NEEDED OR WHEN DIRECTED BY THE CITY INSPECTOR TO ENSURE PUBLIC RIGHTS-OF-WAY ARE KEPT CLEAN AND FREE OF DEBRIS.
- 15. WHEN TRUCKING SATURATED SOILS TO OR FROM THE SITE, EITHER WATER-TIGHT TRUCKS SHALL BE USED OR LOADS SHALL BE DRAINED PRIOR TO TRANSPORT UNTIL DRIPPING HAS BEEN REDUCED TO NO MORE THAN ONE GALLON PER HOUR. SEDIMENT LADEN WATER WILL NOT BE ALLOWED TO ENTER THE STORMWATER SYSTEM.
- 16. EXTRACTED GROUND WATER FROM EXCAVATED TRENCHES SHALL BE DISPOSED OF IN A SUITABLE MANNER WITHOUT DISCHARGING SEDIMENT TO ADJACENT PROPERTIES, THE CITY'S STORMWATER SYSTEM, WATER FEATURES, OR RELATED NATURAL RESOURCES. DEWATERING SYSTEMS SHALL BE DESIGNED AND OPERATED SO AS TO PREVENT REMOVAL OF THE NATURAL SOILS AND SO THAT THE GROUNDWATER LEVEL OUTSIDE THE EXCAVATION IS NOT REDUCED TO THE EXTENT THAT WOULD DAMAGE OR ENDANGER ADJACENT STRUCTURES OR PROPERTY. APPROVAL OF THE DEWATERING SYSTEM DOES NOT GUARANTEE THAT IT WILL MEET THE OUTCOMES OR BE ACCEPTABLE FOR USE IN ALL SITUATIONS. MODIFICATIONS TO THE SYSTEM WILL BE REQUIRED IF THE OUTCOMES CANNOT BE MET. AT NO TIME WILL SEDIMENT LADEN WATER BE ALLOWED TO LEAVE THE CONSTRUCTION SITE.
- 17. A SUPPLY OF MATERIALS NECESSARY TO MEET THE OUTCOMES AND IMPLEMENT THE CSMP OR OTHER EROSION PRACTICES UNDER ALL WEATHER CONDITIONS SHALL BE MAINTAINED AT ALL TIMES ON THE CONSTRUCTION SITE.
- 18. NO HAZARDOUS SUBSTANCES, SUCH AS PAINTS, THINNERS, FUELS AND OTHER CHEMICALS SHALL BE RELEASED ONTO THE SITE, ADJACENT PROPERTIES, OR INTO WATER FEATURES, THE CITY'S STORMWATER SYSTEM, OR RELATED NATURAL RESOURCES.
- 19. NO DISCHARGE INTO THE CITY'S STORMWATER SYSTEM OR RELATED NATURAL RESOURCES OF CONSTRUCTION RELATED CONTAMINANTS RESULTING FROM ACTIVITIES SUCH AS. BUT NOT LIMITED TO. CONCRETE SAWING. CLEANING OR WASHING OF EQUIPMENT, TOOLS, OR VEHICLES, SHALL OCCUR.
- 20. ALL WORK PERFORMED BY UTILITY COMPANIES FOR THIS PROJECT, INCLUDING PLACEMENT OF APPROPRIATE EROSION AND SEDIMENT CONTROL MEASURES, FINISHED GRADING, SEEDING, MULCHING AND CLEAN UP IS GOVERNED BY THE CONDITIONS AND REQUIREMENTS OF THIS CSMP. COMPLIANCE WITH THESE REQUIREMENTS IS THE RESPONSIBILITY OF THE PERMIT HOLDER.

NARRATIVE DESCRIPTIONS

EXISTING SITE CONDITIONS

EXISTING SCHOOL BUILDING, TENNIS COURTS AND RECREATIONAL FIELDS

DEVELOPED CONDITIONS PROPOSED SCHOOL BUILDING, PARKING LOT,

RECREATIONAL FIELDS NATURE OF CONSTRUCTION ACTIVITY

- AND ESTIMATED TIME TABLE * SITE CLEARING AND GRUBBING (APRIL 2015) * MASS GRADING (APRIL 2015-MAY 2015) * UTILITY INSTALLATION (MAY 2015 - SEPTEMBER
- * SITE PAVING (JUNE 2016 SEPTEMBER 2016) * LANDSCAPING (JUNE 2016 - SEPTEMBER 2016) * FINAL STABILIZATION (SEPTEMBER 2016)

ATTENTION EXCAVATORS

CIVIL ENGINEER

KPFF CONSULTING ENGINEERS

1201 OAK STREET, SUITE 100

ACTIVE PERIOD

E-MAIL: matt.keenan@kpffcivilpdx.com

INSPECTION FREQUENCY

SITE CONDITION

IN ANTICIPATION OF SITE INACCESSIBILITY.

INACTIVE PERIODS GREATER THAN SEVEN

(14) CONSECUTIVE CALENDAR DAYS.

4. PERIODS DURING WHICH THE SITE IS

PREVENTION PERMIT REQUIREMENTS.

CONTACT: MATT KEENAN, PE

EUGENE, OREGON 97401

PHONE: 541-684-4902

OREGON LAW REQUIRES YOU TO FOLLOW RULES ADOPTED BY THE OREGON UTILITY NOTIFICATION

AT LEAST TWO BUSINESS DAYS, BEFORE COMMENCING AN EXCAVATION. CALL 503-246-6699.

CENTER. THOSE RULES ARE SET FORTH IN OAR 952-001-0010 THROUGH OAR 952-001-0090. YOU

MAY OBTAIN COPIES OF THESE RULES FROM THE CENTER BY CALLING 503-232-1987. IF YOU HAVE

ANY QUESTIONS ABOUT THE RULES, YOU MAY CONTACT THE CENTER. YOU MUST NOTIFY THE CENTER

* BUILDING CONSTRUCTION (MAY 2015 - AUGUST

TOTAL SITE AREA = 590,149 SF = 13.55 ACRES

TOTAL DISTURBED AREA = 300.500 SF = 6.90 ACRES

SITE SOIL CLASSIFICATION:

THE PROJECT COVERS A LARGE AREA CONSISTING OF ONE SOIL TYPE THAT IS CLASSIFIED AS HYDROLOGIC SOIL GROUP D. THE EROSION POTENTIAL FOR THE SOIL TYPE IS MODERATE TO MODERATELY HIGH.

MINIMUM FREQUENCY

DAILY WHEN STORMWATER RUNOFF, INCLUDING

REGARDLESS OF WETHER STORMWATER RUNOFF

CONTROL MEASURES ARE IN WORKING ORDER.

ANY NECESSARY MAINTENANCE AND REPAIR

MUST BE MADE PRIOR TO LEAVING THE SITE.

IF PRACTICAL, INSPECTIONS MUST OCCUR DAILY

RUNOFF FROM SNOWMELT, IS OCCURRING.

AT LEAST ONCE EVERY TWO WEEKS.

IS OCCURING

ONCE EVERY TWO WEEKS.

POINT OR DOWNSTREAM LOCATION.

PRIOR TO THE SITE BECOMING INACTIVE OR | ONCE TO ENSURE THAT EROSION AND SEDIMENT

INACCESSIBLE DUE TO INCLEMENT WEATHER. AT A RELEVANT AND ACCESSIBLE DISCHARGE

HOLD A PRE—CON MEETING OF PROJECT CONSTRUCTION PERSONNEL THAT INCLUDES THE EC

INSPECTION LOGS MUST BE KEPT IN ACCORDANCE WITH THE 1200—C PERMIT REQUIREMENTS

CHANGES TO THE APPROVED ESCP SHALL BE SUBMITTED TO THE CITY OF EUGENE. PUBLIC

WORKS, AS DESIGNATED AGENTS FOR DEQ, IN THE FORM OF AN ACTION PLAN AND MAP.

ALL INSPECTIONS MUST BE MADE IN ACCORDANCE WITH THE 1200—C EUGENE EROSION

<u>RECEIVING WATER BODIES:</u> WILLAMETTE RIVER



SOUTH SIDE OF E. 24TH AVE BETWEEN HILYARD ST. AND AMAZON PARKWAY,

PROPERTY DESCRIPTION

TAX LOT 0100 (LANE COUNTY) LOCATED IN SECTION 5, TOWNSHIP 18 SOUTH, RANGE

FLOOD NOTE

THE PROJECT SITE IS WITHIN FLOOD ZONE X, WHICH IS THE AREA DETERMINED TO BE OUTSIDE OF THE 500-YEAR FLOODPLAIN, AND FLOOD ZONE AE FLOODWAY, WHICH IS DETERMINED TO BE INSIDE THE 100-YEAR FLOODPLAIN, PER FEMA FLOOD ZONE MAP

PERMITEE'S SITE INSPECTOR

COMPANY/AGENCY PHONE: E-MAIL: DESCRIPTION OF EXPERIENCE:

SHEET INDEX

EC-101 EROSION & SEDIMENT CONTROL COVER SHEET & NOTES EC-102 EROSION & SEDIMENT CONTROL BMP MATRIX & NOTES EC-201 EROSION & SEDIMENT CONTROL PLAN-PHASE 1 EC-202 EROSION & SEDIMENT CONTROL PLAN-PHASE 2 EC-301 EROSION & SEDIMENT CONTROL DETAILS EC-302

PROIECT LOCATION

EUGENE, OREGON LATITUDE = 44° 1'57.90" N, LONGITUDE = 123° 5'2.57" W

3 WEST, WILLAMETTE MERIDIAN, LANE COUNTY, OREGON.

41039C1137 F. NO DEVELOPMENT WILL OCCUR WITHIN THE FLOOD ZONE AE FLOODWAY.

EROSION & SEDIMENT CONTROL DETAILS



ROBERTSON/SHERWOOD/ARCHITECTS PC 132 EAST BROADWAY, SUITE 540 EUGENE, OREGON 97401 541-342-8077

MAHLUM ARCHITECTS INC

www.robertsonsherwood.com

1231 NW HOYT, SUITE 102 PORTLAND, OREGON 97209

503-224-4032

71 COLUMBIA, FLOOR 4 SEATTLE, WASHINGTON 98104 206-441-4151 www.mahlum.com





EUGENE SCHOOL DISTRICT 4J



REPLACEMENT ROOSEVELT MIDDLE SCHOOL CIP NUMBER 410.566.001 680 EAST 24TH AVENUE EUGENE, OREGON 97405 CIP NUMBER 410.566.001

MARK DATE DESCRIPTION FEBRUARY 18, 2015 CONSTRUCTION DOCUMENTS **VOLUME:** PACKAGE EC 2013912.00 PROJECT NO: AB, AF DRAWN BY:

EROSION & SEDIMENT CONTROL COVER SHEET & NOTES

COPYRIGHT MAHLUM ARCHITECTS, INC. 2014 ORIGINAL SHEET SIZE: 30"x42"

EC-101

CHECKED BY:

BMP MATRIX FOR CONSTRUCTION PHASES

REFER TO DEQ GUIDANCE MANUAL FOR A COMPREHENSIVE LIST OF AVAILABLE BMP'S

BMP's	Year:	Year: 2015										.	Г	2016		1			
	Month:	4	5	6	7	8	9	10	11	12	1	2	3	4	5	6	7	8	9
Before Construction																			
Identify & Protect critical areas vegetation to be preserved		Χ																	
Pre-construction meeting		Х																	
Stabilize entrances, roads, & parking areas		Х																	
Install perimeter controls and inlet protection		Χ																	
Establish concrete wash		Χ																	
Establish non-stormwater controls																			
Construct primary runoff control measures																			
During Construction																			
Temporary Seeding and Planting			Х	Х	Х	Х	Х												
Permanent Seeding and Planting																Х	Х	Х	Х
Compost socks		Х	Х	Х	Х	Х	Х	Х	Х	Х	Х	Х	Х	Х	Х	Х	Х	Х	Х
Sediment fencing		Х	Х	Х	Х	Х	Х	Х	Х	Х	Х	Х	Х	Х	Х	Х	Х	Х	Х
Straw Wattles (loose compaction rice straw)		Х	Х	Х	Х	Х	Х	Х	Х	Х	Х	Х	Х	Х	Х	Х	Х	Х	Х
Storm drain inlet protection		Х	Х	Х	Х	Х	Х	Х	Х	Х	Х	Х	Х	Х	Х	Х	Х	Х	Х
Dewatering (treatment location, schematic, and sampling plan required)																			
Paving operations controls		Х	Х	Х	Х	Х	Х	Х	Х	Х	Х	Х	Х	Х	Х	Х	Х	Х	Х
Concrete truck washout		Χ	Х	Х	Х	Х	Х	Х	Х	Х	Х	Х	Х	Х	Х	Х	Х	Х	Х
Plastic Sheeting								Х	Х	Х	Х	Х	Х	Х	Х				
Stockpile sediment fencing		Χ	Х	Х	Х	Х	Х	Х	Х	Х	Х	Х	Х	Х	Х	Х	Х	Х	Х
Stabilized soils at end of shift & before weekends & holidays		Х	Х	Х	Х	Х	Х	Х	Х	Х	Х	Х	Х	Х	Х	Х	Х	Х	Х
Trucking saturated soils off site must be water-tight or loads drained on site		Х	Х	Х	Х	Х	Х	Х	Х	Х	Х	Х	Х	Х	Х	Х	Х	Х	Х
Re-vegetate areas as construction completed		Х	Х	Х	Х	Х	Х	Х	Х	Х	Х	Х	Х	Х	Х	Х	Х	Х	Х
No illicit connection		Х	Х	Х	Х	Х	Х	Х	Х	Х	Х	Х	Х	Х	Х	Х	Х	Х	Х
No illegal discharge		Х	Х	Х	Х	Х	Х	Х	Х	Х	Х	Х	Х	Х	Х	Х	Х	Х	Х
Final Stabilization																			
Proved permanent erosion prevention measures																			Х
Remove sediment, waste, and construction materials																			Х
Remove temporary control measures																			Х



ROBERTSON/SHERWOOD/ARCHITECTS PC

132 EAST BROADWAY, SUITE 540

132 EAST BROADWAY, SUITE 540 EUGENE, OREGON 97401 541-342-8077 www.robertsonsherwood.com

MAHLUM ARCHITECTS INC

1231 NW HOYT, SUITE 102 PORTLAND, OREGON 97209 503-224-4032

71 COLUMBIA, FLOOR 4 SEATTLE, WASHINGTON 98104 206-441-4151 www.mahlum.com





EUGENE SCHOOL DISTRICT 4J



REPLACEMENT ROOSEVELT MIDDLE SCHOOL CIP NUMBER 410.566.001 680 EAST 24TH AVENUE EUGENE, OREGON 97405 CIP NUMBER 410.566.001

ISSUE DATE: FEBRUARY 18, 2015

ISSUE: CONSTRUCTION DOCUMENTS

VOLUME: PACKAGE EC

PROJECT NO: 2013912.00

DRAWN BY: AB, AF

CHECKED BY: MK


COPYRIGHT MAHLUM ARCHITECTS, INC. 2014 ORIGINAL SHEET SIZE: 30°x42"

DESCRIPTION

MARK DATE

EROSION & SEDIMENT CONTROL BMP MATRIX & NOTES

EC-102

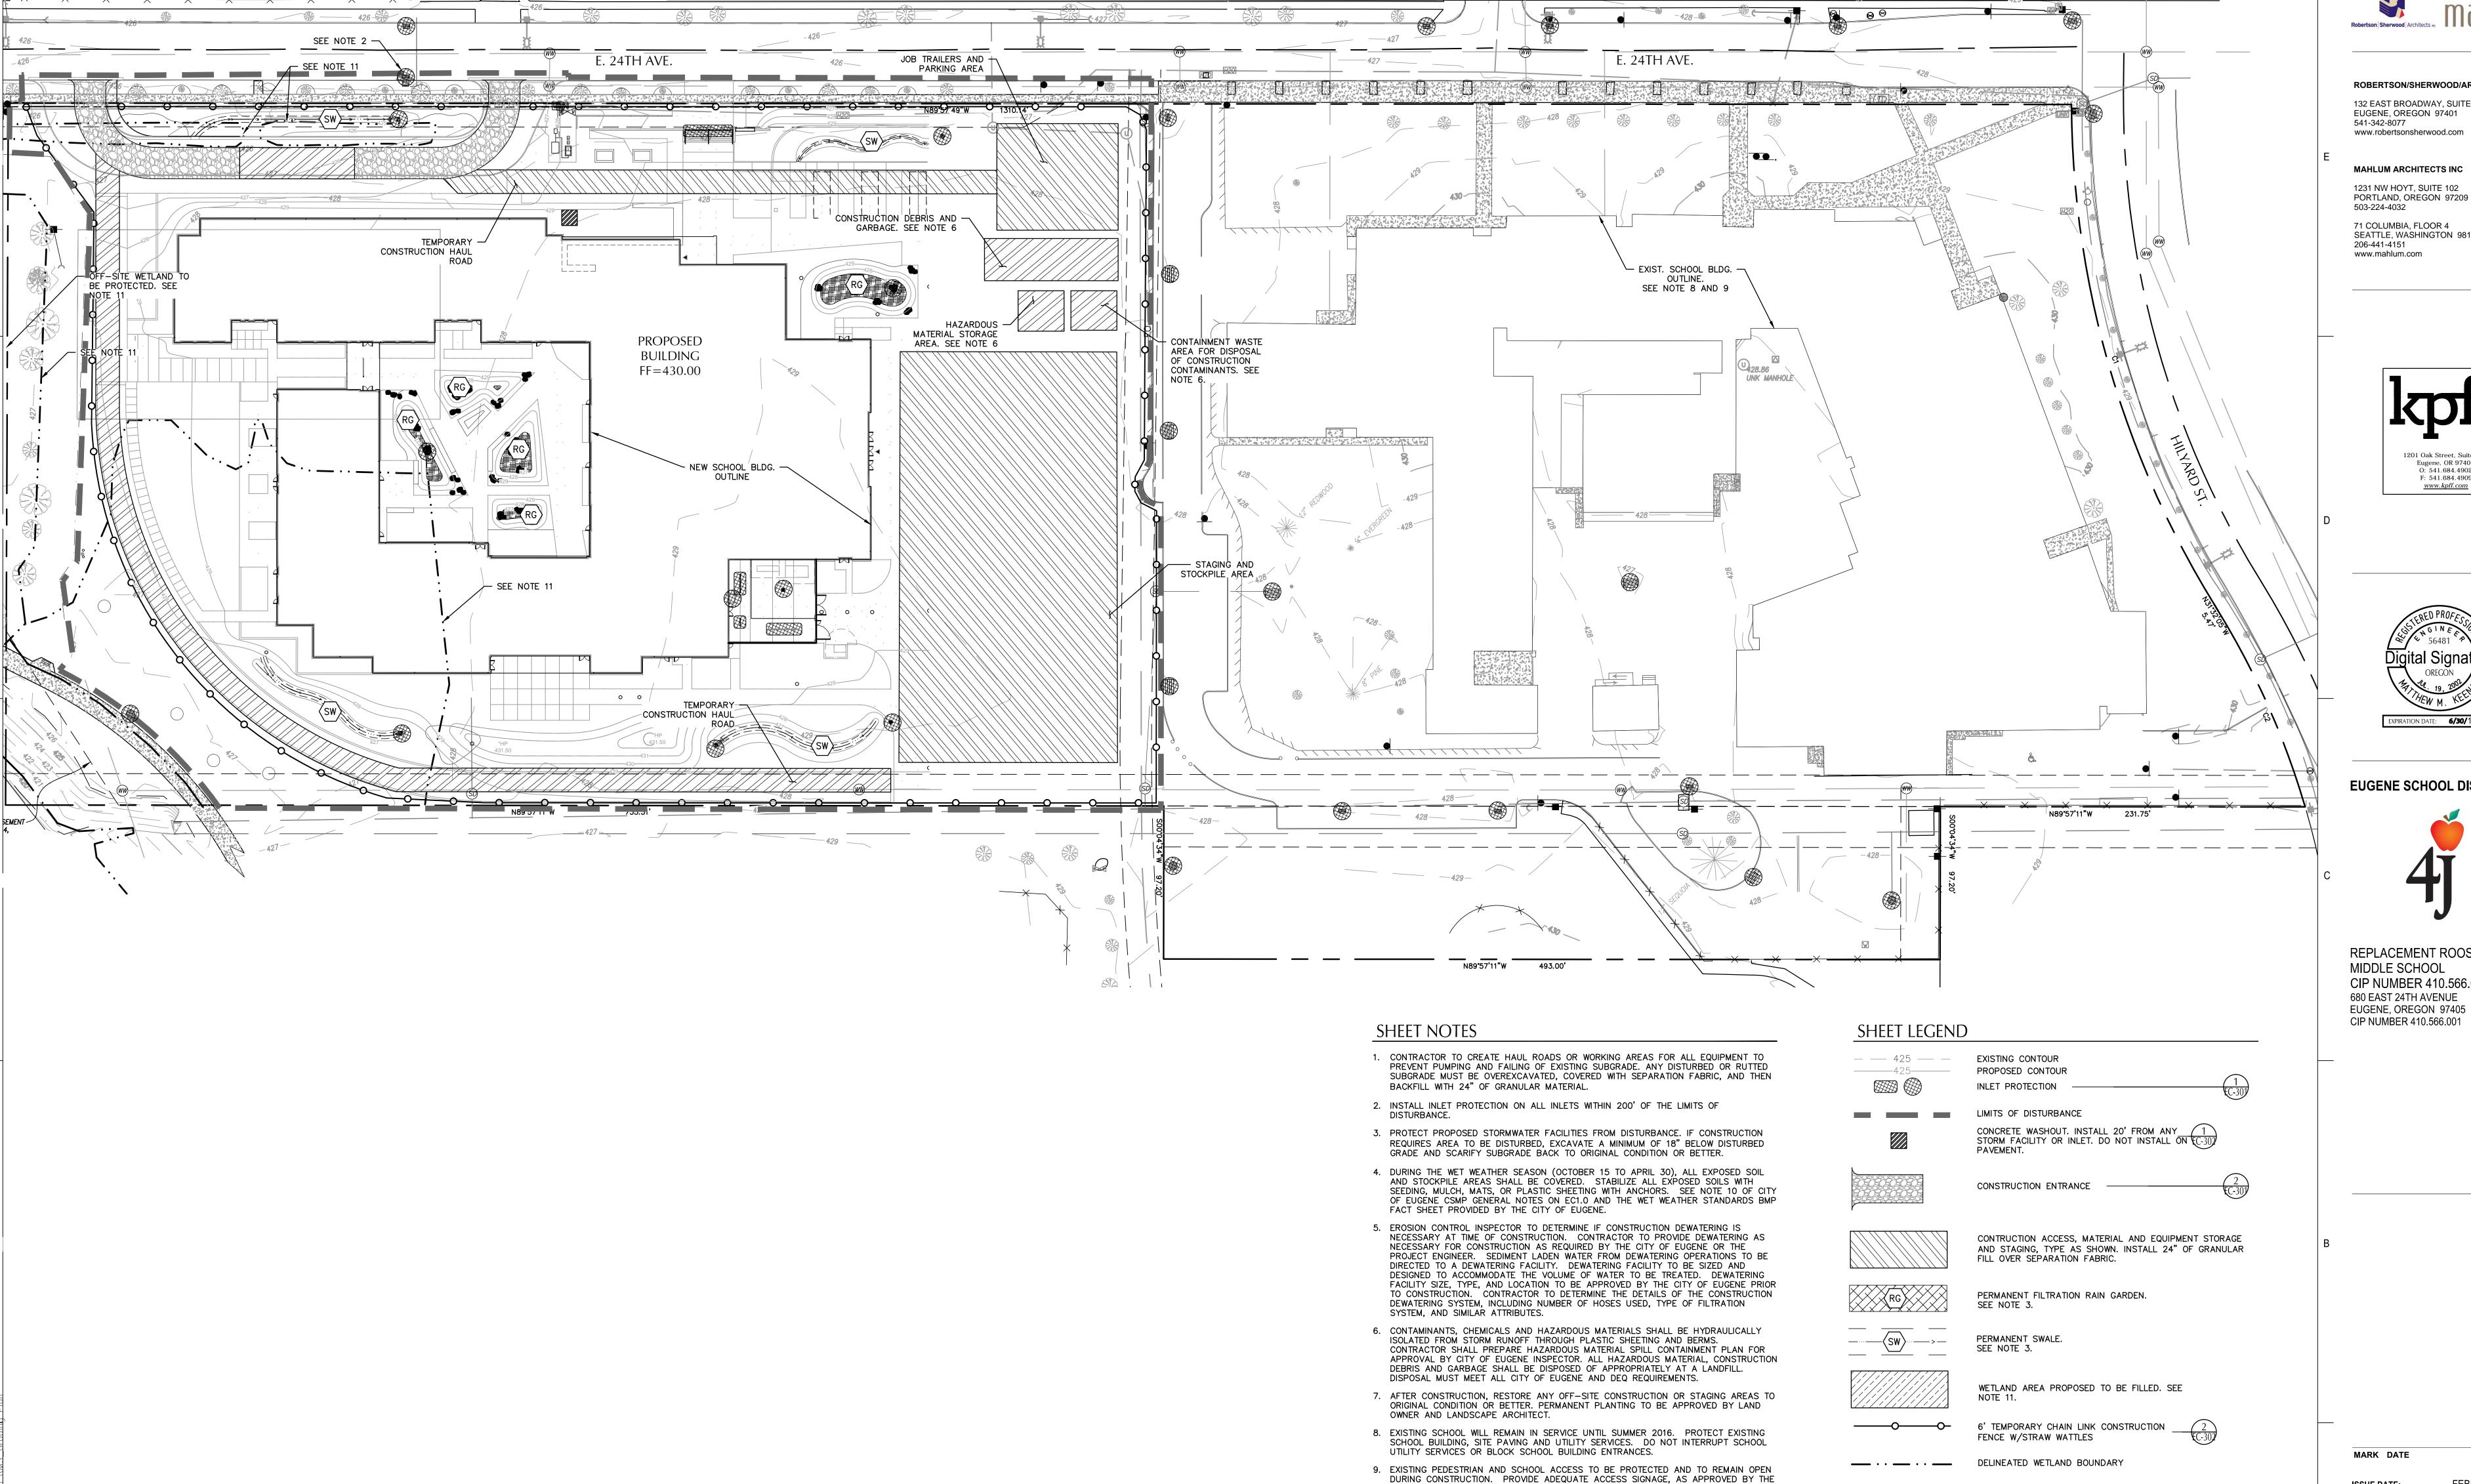

10. SEE GRADING PLAN FOR PROPOSED CONTOURS AND GRADING.

12. SEE SITE DEMOLITION PLAN FOR TREE REMOVAL & PROTECTION.

PROTECTION AND FILL.

11. SOME DELINEATED WETLANDS TO BE FILLED. SEE JPA PERMIT FOR WETLAND




ROBERTSON/SHERWOOD/ARCHITECTS PC 132 EAST BROADWAY, SUITE 540 EUGENE, OREGON 97401

541-342-8077 www.robertsonsherwood.com

MAHLUM ARCHITECTS INC 1231 NW HOYT, SUITE 102

71 COLUMBIA, FLOOR 4 SEATTLE, WASHINGTON 98104 206-441-4151

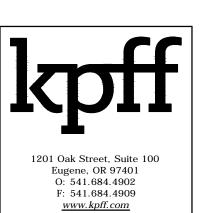



EUGENE SCHOOL DISTRICT 4J





REPLACEMENT ROOSEVELT MIDDLE SCHOOL CIP NUMBER 410.566.001 680 EAST 24TH AVENUE EUGENE, OREGON 97405 CIP NUMBER 410.566.001

MARK DATE DESCRIPTION FEBRUARY 18, 2015 CONSTRUCTION DOCUMENTS PACKAGE EC **VOLUME:** 2013912.00 PROJECT NO: AB, AF DRAWN BY:

EROSION & SEDIMENT CONTROL PLAN -PHASE 1

CHECKED BY:

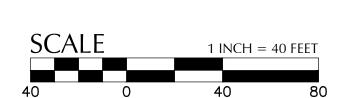

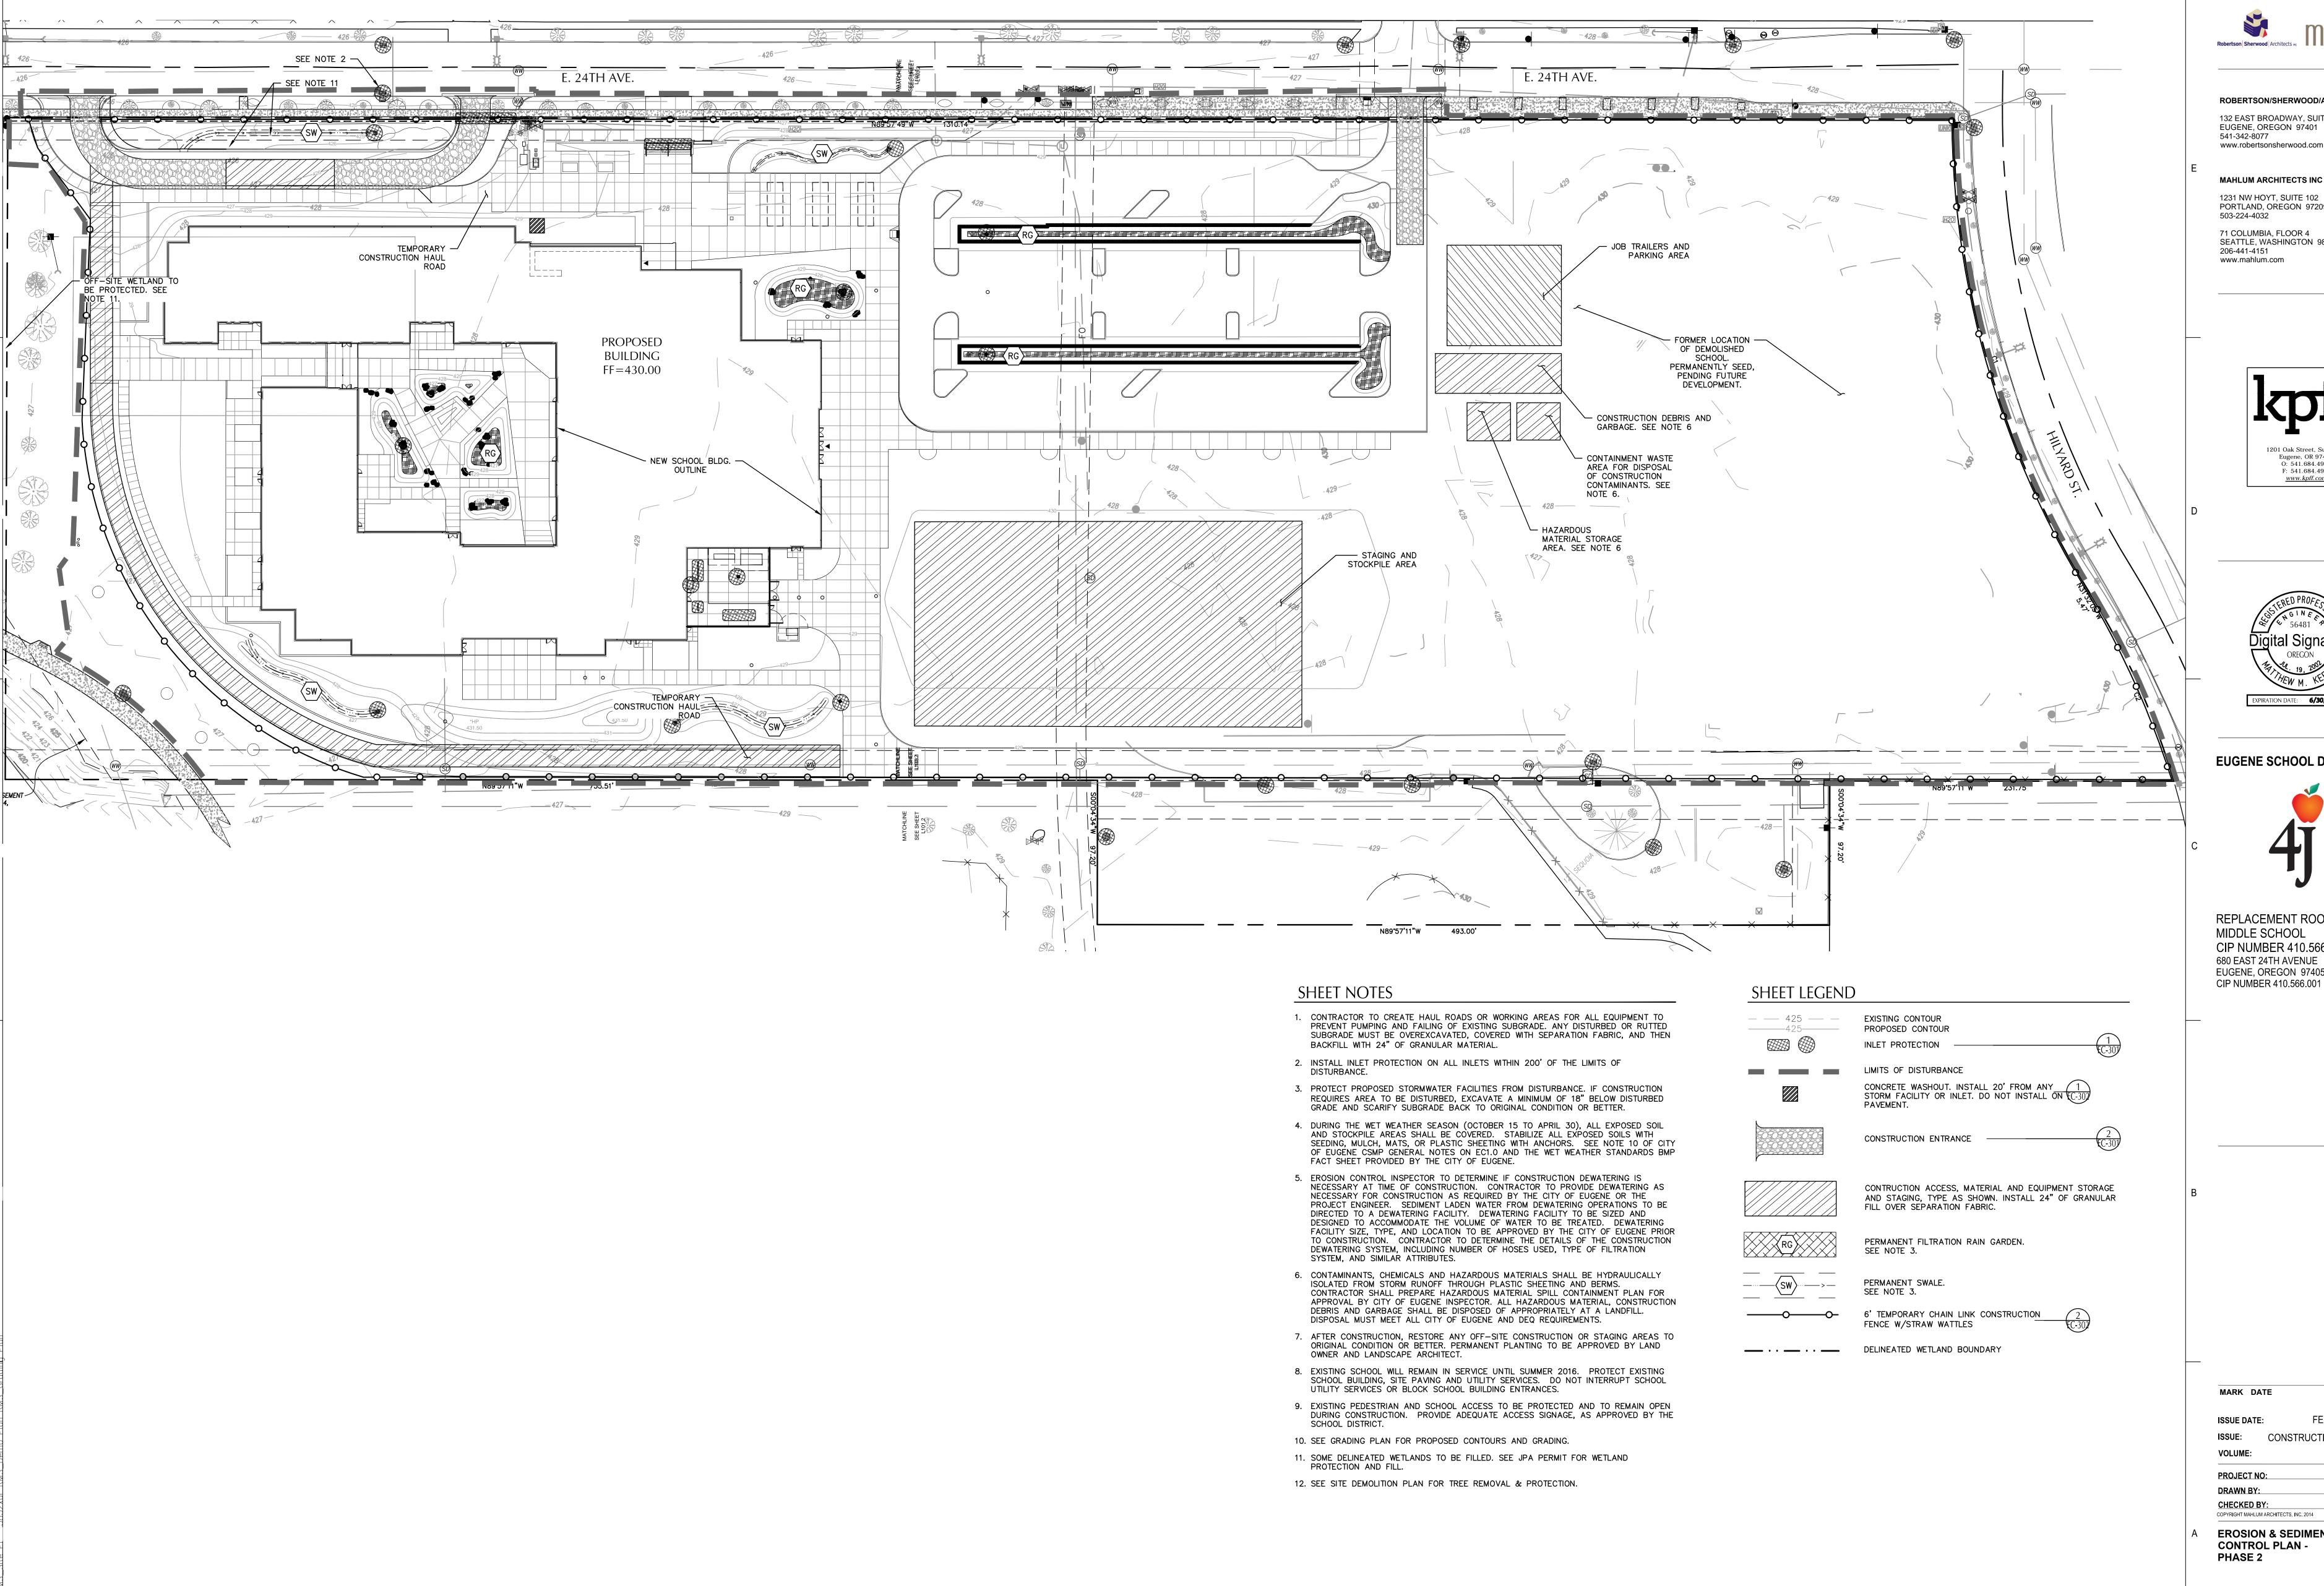


ROBERTSON/SHERWOOD/ARCHITECTS PC 132 EAST BROADWAY, SUITE 540 EUGENE, OREGON 97401

www.robertsonsherwood.com

1231 NW HOYT, SUITE 102 PORTLAND, OREGON 97209

71 COLUMBIA, FLOOR 4 SEATTLE, WASHINGTON 98104 206-441-4151

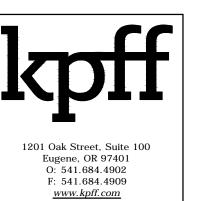



EUGENE SCHOOL DISTRICT 4J




REPLACEMENT ROOSEVELT MIDDLE SCHOOL CIP NUMBER 410.566.001 680 EAST 24TH AVENUE EUGENE, OREGON 97405 CIP NUMBER 410.566.001

MARK DATE DESCRIPTION FEBRUARY 18, 2015

CONSTRUCTION DOCUMENTS


PACKAGE EC **VOLUME:** 2013912.00 PROJECT NO: AB, AF DRAWN BY: CHECKED BY:

EROSION & SEDIMENT CONTROL PLAN -PHASE 2

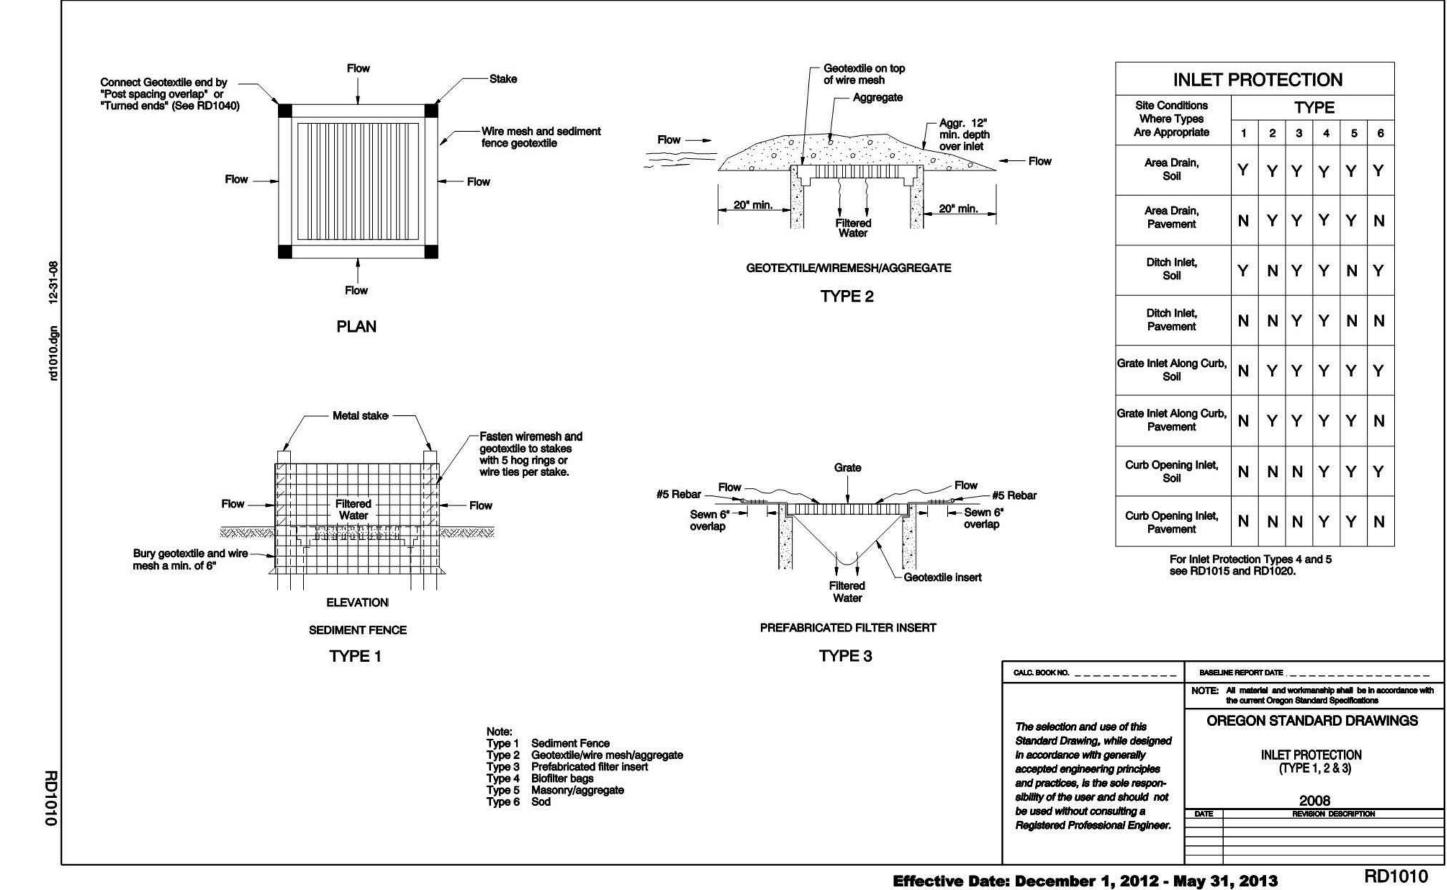

1 INLET SEDIMENT PROTECTION

SCALE: NTS

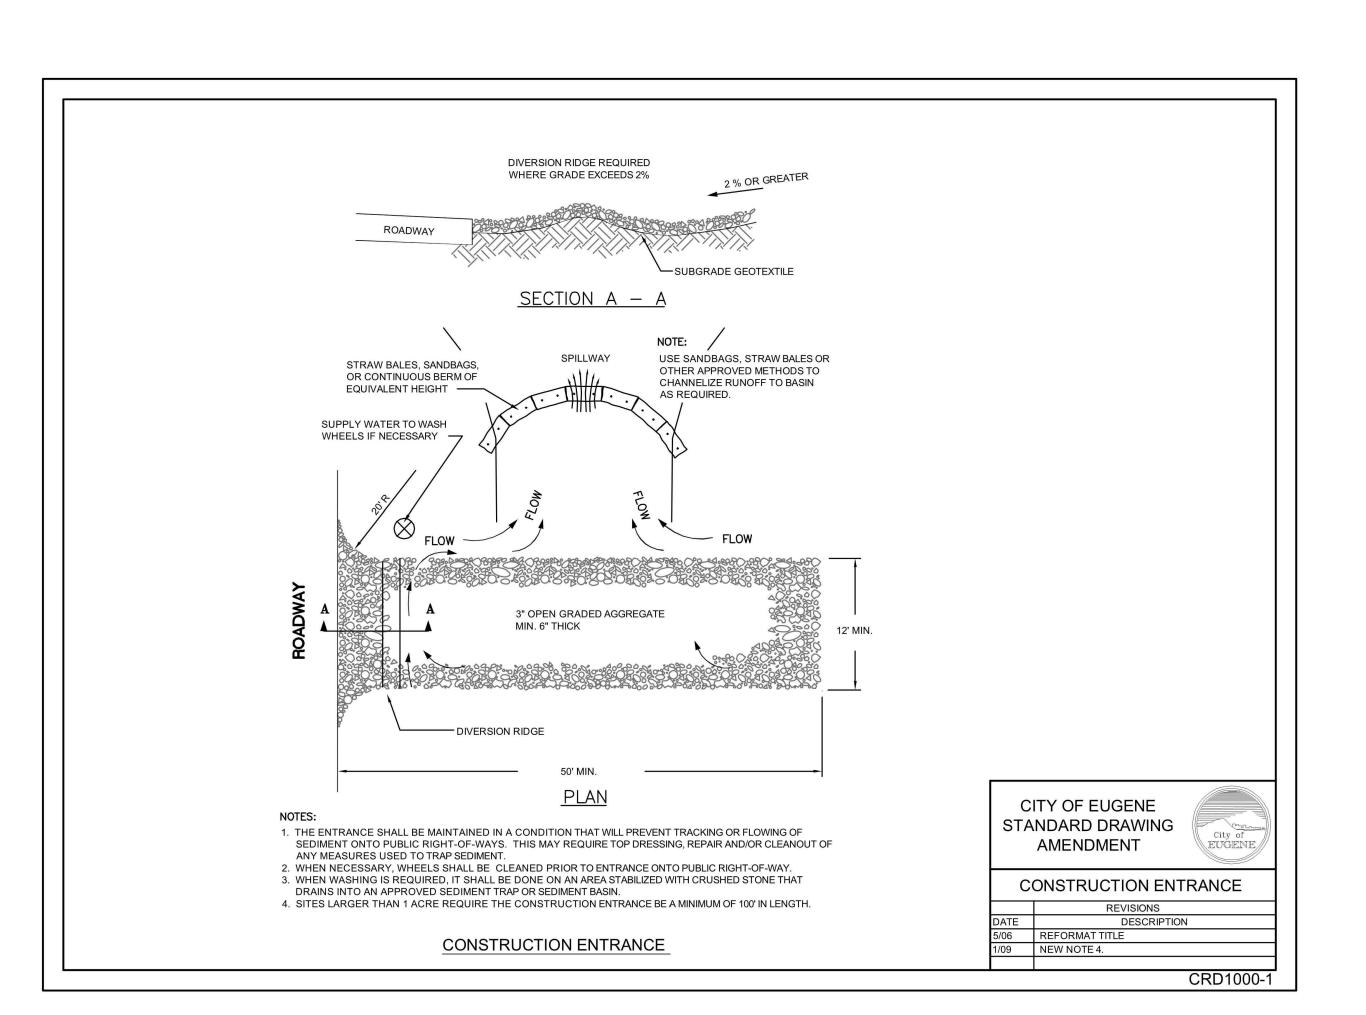

2 CONSTRUCTION ENTRANCE
SCALE: NTS



ROBERTSON/SHERWOOD/ARCHITECTS PC

132 EAST BROADWAY, SUITE 540 EUGENE, OREGON 97401 541-342-8077 www.robertsonsherwood.com

MAHLUM ARCHITECTS INC 1231 NW HOYT, SUITE 102 PORTLAND, OREGON 97209

503-224-4032
71 COLUMBIA, FLOOR 4
SEATTLE, WASHINGTON 98104
206-441-4151
www.mahlum.com





EUGENE SCHOOL DISTRICT 4J



REPLACEMENT ROOSEVELT MIDDLE SCHOOL CIP NUMBER 410.566.001 680 EAST 24TH AVENUE EUGENE, OREGON 97405 CIP NUMBER 410.566.001

MARK DATE DESCRIPTION

ISSUE DATE: FEBRUARY 18, 2015

VOLUME: PACKAGE EC

PROJECT NO: 2013912.00


DRAWN BY: AB, AF

CHECKED BY: MK


COPYRIGHT MAHLUM ARCHITECTS, INC. 2014 ORIGINAL SHEET SIZE: 30"x42"

EROSION & SEDIMENT CONTROL DETAILS

EC-301

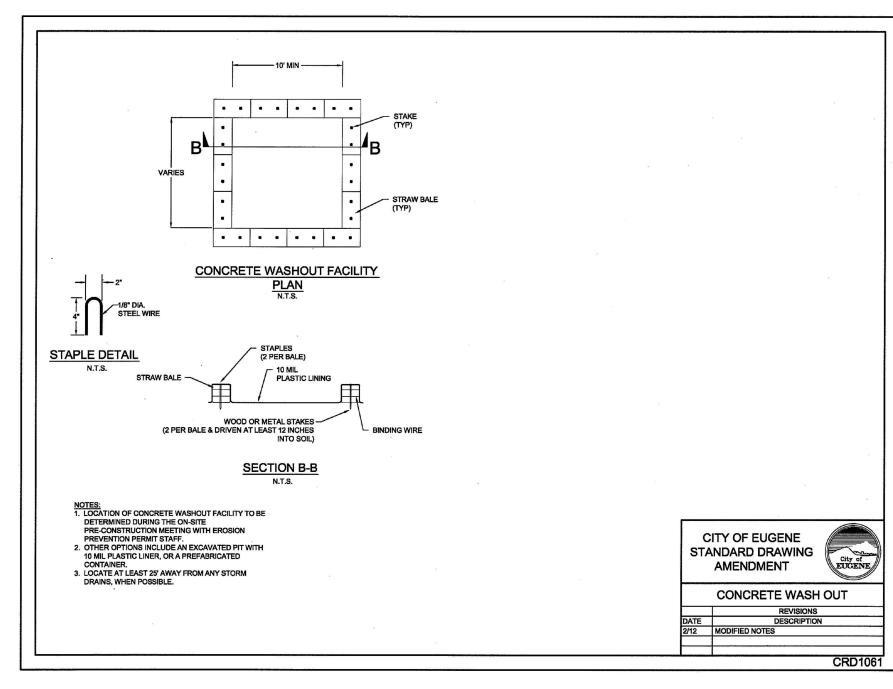

CONCRETE WASH OUT
SCALE: NTS

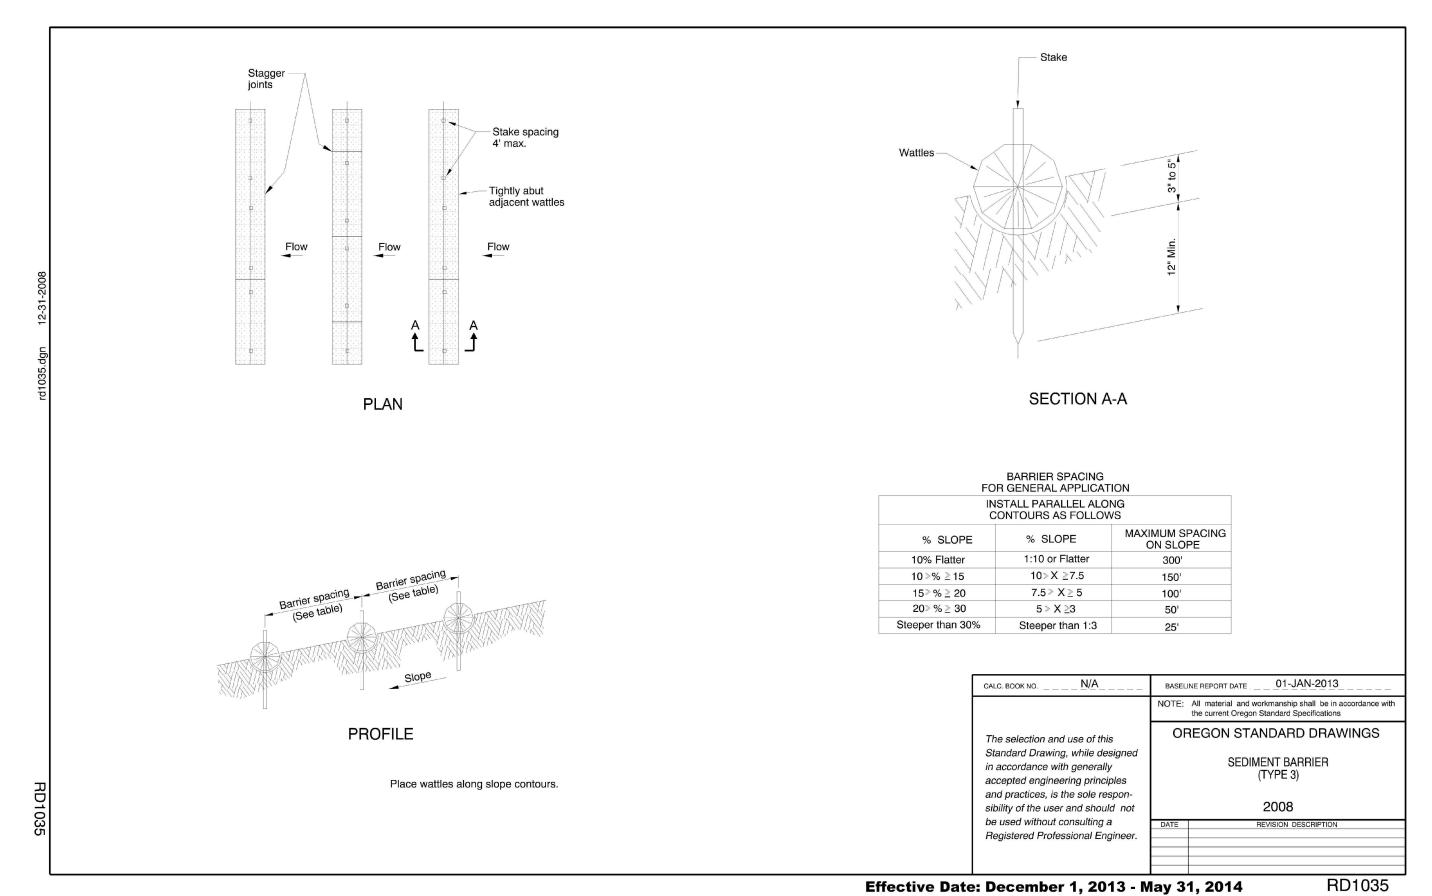

2 SEDIMENT BARRIER - STRAW WATTLES
SCALE: NTS




ROBERTSON/SHERWOOD/ARCHITECTS PC 132 EAST BROADWAY, SUITE 540 EUGENE, OREGON 97401 541-342-8077

MAHLUM ARCHITECTS INC

www.robertsonsherwood.com

1231 NW HOYT, SUITE 102 PORTLAND, OREGON 97209 503-224-4032

71 COLUMBIA, FLOOR 4 SEATTLE, WASHINGTON 98104 206-441-4151 www.mahlum.com

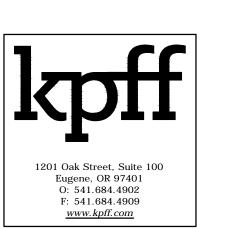



EUGENE SCHOOL DISTRICT 4J



REPLACEMENT ROOSEVELT MIDDLE SCHOOL CIP NUMBER 410.566.001 680 EAST 24TH AVENUE EUGENE, OREGON 97405 CIP NUMBER 410.566.001

MARK DATE DESCRIPTION

FEBRUARY 18, 2015 ISSUE: CONSTRUCTION DOCUMENTS PACKAGE EC VOLUME: 2013912.00 PROJECT NO:

AB, AF

DRAWN BY: **CHECKED BY:** COPYRIGHT MAHLUM ARCHITECTS, INC. 2014 ORIGINAL SHEET SIZE: 30"x42"

EROSION & SEDIMENT CONTROL DETAILS

EC-302